

CITY OF FORT LAUDERDALE ENGINEERING DIVISION APPLICATION TO INSTALL AT GRADE COMMUNICATIONS SERVICE FACILITIES

PERMIT NO. CC13-05

District 3

(3)

| App | olica | nt Nan | ne and Job Nu | ımber <u>Crown Ca</u> | stle NG East | LLC SF | L 61_2 | | |
|--------------------|--|--|--|---------------------------------|------------------|-----------|-----------------------|--------------------------|--------------------------|
| Job | Add | dress a | and Location_ | 539 NW 17th Ave | enue | | | | |
| Des | scrip | tion of | Work Install | ing cabinet and | utility pole wi | ithin rig | ht-of-way. | | |
| Ant | icipa | ated sta | art and end da | ites of work 6/2 | 14 - 45 days | | | | |
| X | | This permit application is for an exemption from the requirement to install communications service facilities below grade, in accordance with Section 25-100.1.B.3 of the City of Fort Lauderdale Code of Ordinances (Code). A letter by a qualified expert(s) is attached. Crown Castle is requesting the following waivers (check all applicable subsections and attach supporting documentation): | | | | | | | |
| | □ (Siz | | ☐ C.2 (Height) | ☐ C.3 (Front Yard) | ☐ C.4 (Corner | Yard) | ☐ C.6 (Separation) | □C.7 (Exist. Facility | C.12 (Collector) |
| X X X X X X | requirements in Section 25-100.1 of the Code Notice of the pending application has been provided to all property owners abutting public rights-of-way within one hundred fifty (150) feet of the proposed site and to the relevant homeowner association, in accordance with Section 25-100.1.E.5 of the Code. The proposed site will be maintained by Crown Castle in accordance with the approved Graffiti Mitigation Plan dated | | | | | | | | |
| | an rect. | | ized represen | tative of Crown | Castle, I ce | ertify ur | nder oath that | the forgoing state | ements are true and |
| | | | Hernandez of Authorized | Crown Castle A | | Signatu | ure of Authorize | d Crown Castle A | gent |
| Swi | orn t | NO. | subscribed be | No. | tary Public, | day of | | | 4 23.16 |
| (Se | a) | 8 8 | Angel Prieto My Commission EE Expires 08/23/2016 | or Florida 5 | | | | (Do no | t write below this line) |
| Cor | псер | otual ap | oproval date | by | | | | , Subject to the | e following conditions: |
| 1) | A d | etailed | d visual mitig | ation plan is re | quired | | | | |
| Fin | al P | ermit | approval dat | eby | | - | Final Inspect | ion date | _by |
| | | | eering Permits g work at (954 | s Division 24 hou) 828-5649 | ırs | | | | |



CLIENT:

CROWN CASTLE SFL61 2

ADDRESS:

CLIENT SITE ID#:

539 NW 17TH AVENUE FORT LAUDERDALE, FLORIDA 33311

SITE TYPE:

DIRECTIONS

NEW CROWN CASTLE 40' CONCRETE POLE

| PRO | PFRTY | INFORMATION |
|-----|-------|-------------|
| | | |

SITE COORDINATES:

JURISDICTION:

PROPERTY OWNER: ADDRESS:

26.128999 -80.165199*

CROWN CASTLE

MIAMI, FL 33166

8555 NW 64TH STREET

CITY OF FORT LAUDERDALE

PROJECT TEAM

PROJECT MANAGEMENT FIRM: CROWN CASTLE ADDRESS: CROWN 64TH STREET MIAMI, FL 33166

FLORIDA COA#:

CONTACT:

PHONE:

AW SOLUTIONS, INC. 300 CROWN OAK CENTRE DR. LONGWOOD, FL 32750 SHANE HAFNER 407.260.0231 EXT. 120

DESIGN CRITERIA;

1. FLORIDA BUILDING CODE 2010 AND ASCE 7-10. WIND LOAD PER ASCE 7-10. ULTIMATE WIND SPEED: 170 MPH.

26983

- BUILDING RISK CATEGORY: II. WIND EXPOSURE: C.
- A. EQUIPMENT WEIGHT PER MANUFACTURER DATA.
- SEISMIC LOAD DOES NOT GOVERN THIS DESIGN.

SHEET SHEET DESCRIPTION T1 TITLE SHEET **INDEX**

| T1 | TITLE SHEET | 3 |
|------|---------------------------|---|
| C1 | SITE PLAN | 3 |
| C1.1 | LANDSCAPE MITIGATION PLAN | 3 |
| C2 | ELEVATION | 3 |
| C3 | DETAILS | 1 |
| C4 | DETAILS | 1 |
| SP1 | SPECIFICATIONS | 1 |
| SP2 | SPECIFICATIONS | 1 |

| <u>APPROVALS</u> | DATE: |
|------------------|-------|
| PROJECT MANAGER: | - |
| CARRIER: | |
| UTILITY: | - |



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300 CROWN OAK CENTRE DRIVE LONGWOOD, FL 32750 TEL: 407.260.0231 FAX: 407.260.0749 FL COA#: 26983

| DIV | tinit Di. | E-11 | CHLORED | D 1. | UD |
|-----|-----------|-------------|-----------|------|----|
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| | | | ···· | | |
| 3 | 05/01/14 | CHANGE P | OLE TYPE | | |
| 2 | 07/26/13 | | | | |
| 1 | 05/03/13 | REVISED F | ER COMM | ENTS | |
| 0 | 10/30/12 | ISSUED FO | OR PERMIT | | |
| REV | DATE | DESCRIPTION | ON | | |



SFL61_2

539 NW 17TH AVENUE

FORT LAUDERDALE, FL 33311

SHEET TITLE:

TITLE SHEET

SHEET NUMBER:


NW 13th St HW 12th Ct NW 1255 NE 128 를 NW 12th St 를 ₹ NW 11th PL NETTH St NE 11 th St MW 11th St > Mt Olive Gardens NW 10th FI Apartments NW 6th Ct RW 6t5 Ct MW Toda FI NW 6th Ct. (B38) E Sunrise Blvd W Sunrise Blvd (838) (838) W Sunrise Blvd (838) W Sunrise Blvd (838) (1) lvd (838) IN GU PL NW 9th PI NW 9th PI Playground 著 글 g NW em st & (3) MW 9th 51 NW 8th Pl NW 6th Ct NOW BUILST True Pentecostal Ray's A Church of God MW 785 PI NW 5th St NW 6th St NE7th St INW 7th St 🕺 the 6th Pl NW 6th Ct 1 NW 6th St Pizza & Chipotle NW 6th St ican-American search Library Cultural Center NW 6th St NW 50 CI (5) Feldman Park NW 5th Ct 3 **NODE 61 2** NW 5th St NW 5th St MW 5th St Basketball uderdale demorial Gardens NW 4th St NW 2rd Ct NW 3rd St NW 2nd St Fort Lauderdale City Manager NW 2nd St (IA) NW 1st St : NW 1st St ₹ (842) (847) W Broward Blvd 121 31 W Broward Blvd (842) W Broward Blvd (842) ward Blvd SW 1st St Fort Lauderdale V lat St Himmarshee St SW 2nd St Fort Lauderdale Broward Fort Lauderdale Downtown Helistop SW 2nd St Middle St SW 2nd Ct nd Ct ard St SITE#: ire Ci n St Sunget Map SW 4th St Amtrak Las Olas Wal Station-FTL SW 4th Ct (1) SW 5th St SW Sth Ct gW 5th Cr SW 5th PI 1 SW Stu P SE 6th Ct SE 7th St (5) Athletic Field **DRIVING** GENERAL VICINITY MAP SPECIFIC LOCATION MAP

FROM MIAMI, TAKE I-95 NORTH TO EXIT 29A, MERGE ONTO FL-838 EAST/WEST SUNRISE BLVD., TURN RIGHT ONTO NW 17TH AVENUE, TURN RIGHT ONTO NW 7TH PLACE, TAKE LEFT ONTO NW 18TH AVENUE, DESTINATION WILL BE ON RIGHT



SERVICE ALERT CALL TOLL FREE 1-800-432-4770 48 HOURS BEFORE

> 15-0160 Page 2 of 7

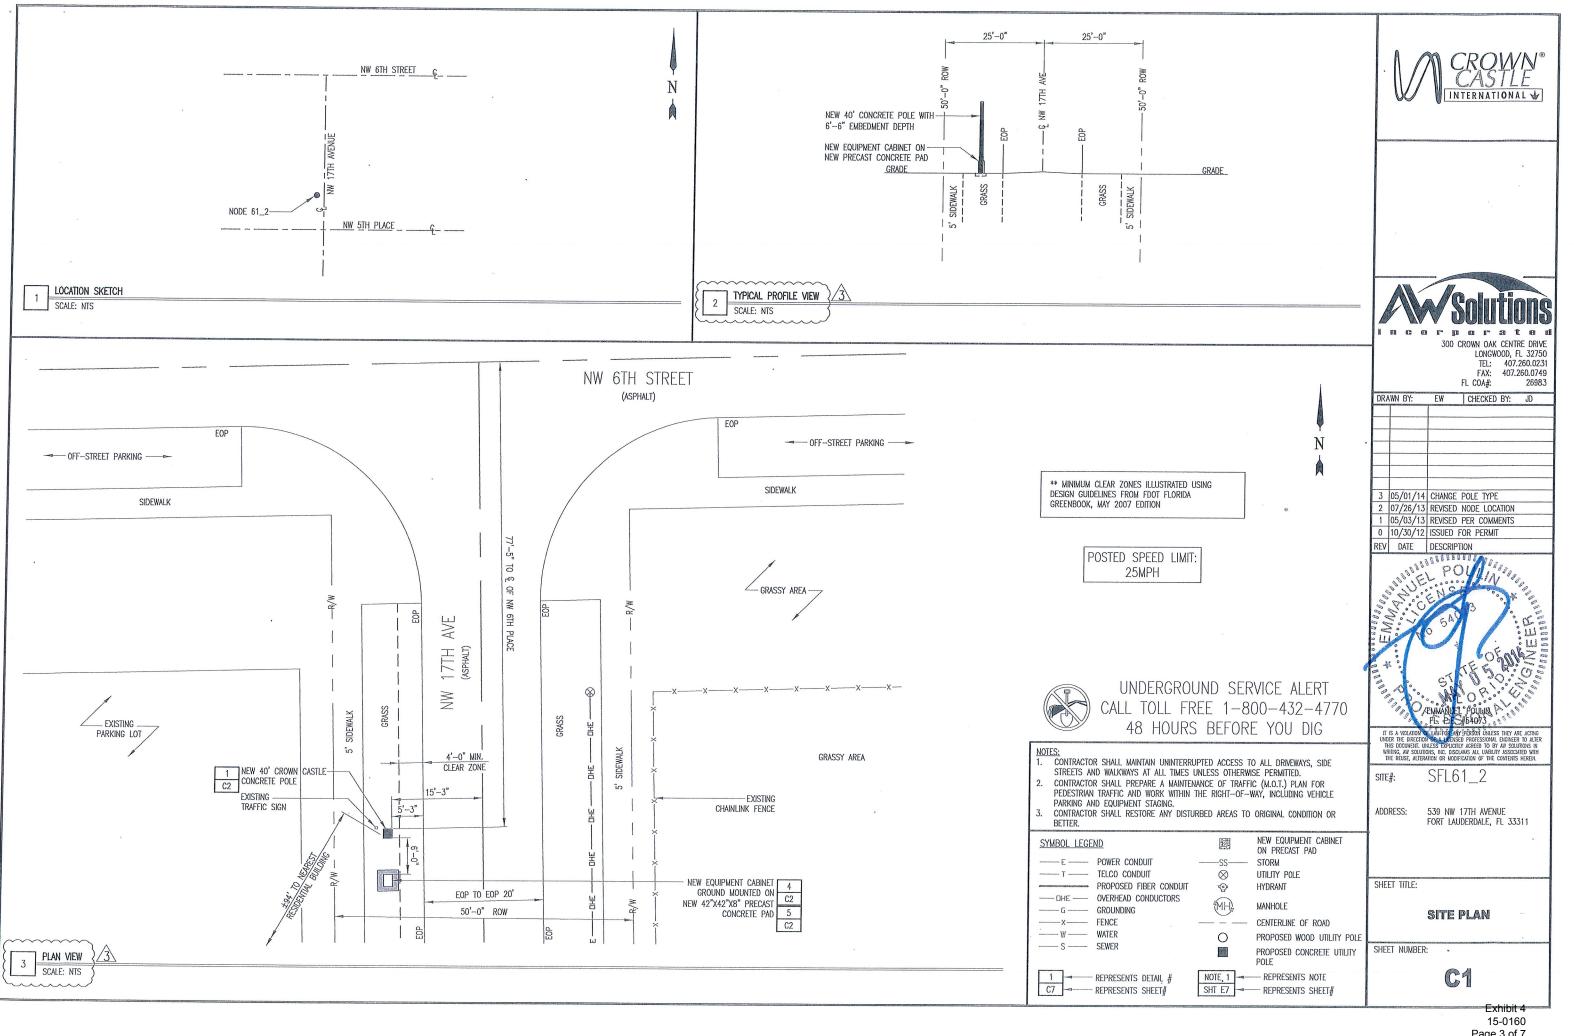



Page 3 of 7

- LANDSCAPE NOTES:

 1. ALL PLANT MATERIAL SHALL CONFORM TO THE STANDARDS FOR FLORIDA NO. 1 OR BETTER, AS GIVEN IN "GRADES AND STANDARDS FOR NURSERY PLANTS" PART I, 1963, AND PART 11, STATE OF FLORIDA, DEPARTMENT OF AGRICULTURE, TALLAHASSEE, FLORIDA.
- 2. IT SHALL BE THE RESPONSIBILITY OF THE LANDSCAPE CONTRACTOR TO VERIFY LOCATION OF ALL UNDERGROUND UTILITIES PRIOR TO BEGINNING WORK.
- ALL PLANT BEDS TO RECEIVE 10" OF 50/50 MIX. 50% SAND, 50% MUCK.

 IT SHALL BE THE RESPONSIBILITY OF THE LANDSACPE CONTRACTOR TO PROVIDE A SMOOTH UNIFORM GRADE PRIOR TO INSTALLING SOD.
- ALL MULCH TO BE 'FLORAMULCH' MELALEUCA MULCH.
- ALL TREES TO BE STAKED IN THE FIELD WITH APPROVED NURSERY STANDARD METHODS.
- 7. TREES/PALMS SHALL BE INSTALLED A MIN. OF 3' FROM UNDERGROUND UTILITIES.

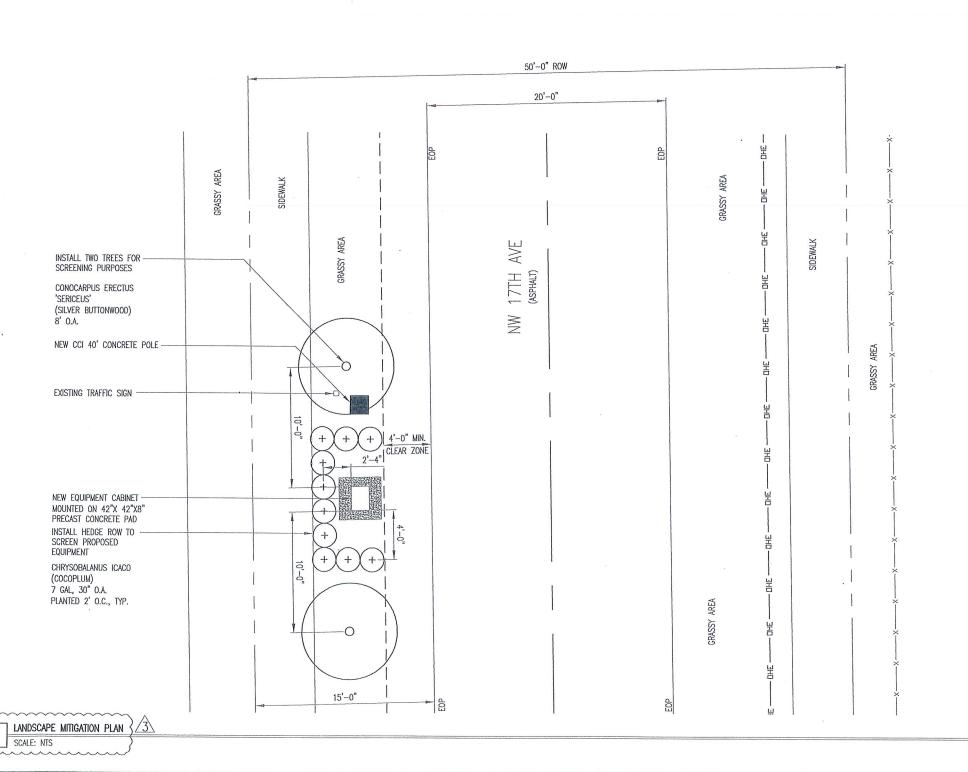

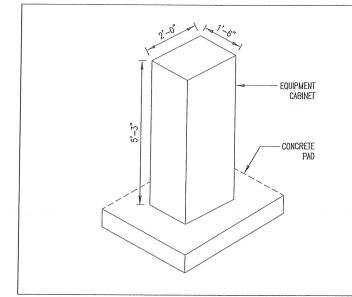

UNDERGROUND SERVICE ALERT CALL TOLL FREE 1-800-432-4770 48 HOURS BEFORE YOU DIG

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NOTE, 1

CONTRACTOR SHALL MAINTAIN UNINTERRUPTED ACCESS TO ALL DRIVEWAYS, SIDE STREETS AND WALKWAYS AT ALL TIMES UNLESS OTHERWISE PERMITTED.

CONTRACTOR SHALL PREPARE A MAINTENANCE OF TRAFFIC (M.O.T.) PLAN FOR

PARKING AND EQUIPMENT STAGING.

-- PROPOSED FIBER CONDUIT

- REPRESENTS DETAIL #

- REPRESENTS SHEET#

SYMBOL LEGEND

---- E ---- POWER CONDUIT

TELCO CONDUIT

----- G ----- GROUNDING

----x----FENCE

----- W ----- WATER

----- S ----- SEWER

---- DHE ---- OVERHEAD CONDUCTORS

PEDESTRIAN TRAFFIC AND WORK WITHIN THE RIGHT-OF-WAY, INCLUDING VEHICLE

CONTRACTOR SHALL RESTORE ANY DISTURBED AREAS TO ORIGINAL CONDITION OR





300 CROWN OAK CENTRE DRIVE LONGWOOD, FL 32750 TEL: 407.260.0231 FAX: 407.260.0749 FL COA#: 26983

3 05/01/14 CHANGE POLE TYPE 2 07/26/13 REVISED NODE LOCATION 1 05/03/13 REVISED PER COMMENTS 0 10/30/12 ISSUED FOR PERMIT

DRAWN BY: EW CHECKED BY: JD



IT IS A VIOLATION OF LAW FOR ANY PERSON UNLESS THEY ARE ACTING UNDER THE DIRECTION OF A JEPISED PROFESSIONAL ENGINEER TO ALTER HIS DOCUMENT, UNLESS DEVIDENTLY AGREED TO BY ANY SOLUTIONS IN WASTING, AW SOLUTIONS, INC. DISCLAIMS ALL LIABILITY ASSOCIATION WITH THE REIDER, ALTERATION OR MODIFICATION OF THE CONTENTS HEREIN.

SFL61_2 SITE#:

ADDRESS: 539 NW 17TH AVENUE FORT LAUDERDALE, FL 33311

SHEET TITLE:

NEW EQUIPMENT CABINET

ON PRECAST PAD

STORM

UTILITY POLE

HYDRANT

MANHOLE

POLE


---- REPRESENTS NOTE SHT E7 REPRESENTS SHEET#

LANDSCAPE MITIGATION PLAN CENTERLINE OF ROAD PROPOSED WOOD UTILITY POLE


SHEET NUMBER: PROPOSED CONCRETE UTILITY

C1.1

15-0160 Page 4 of 7

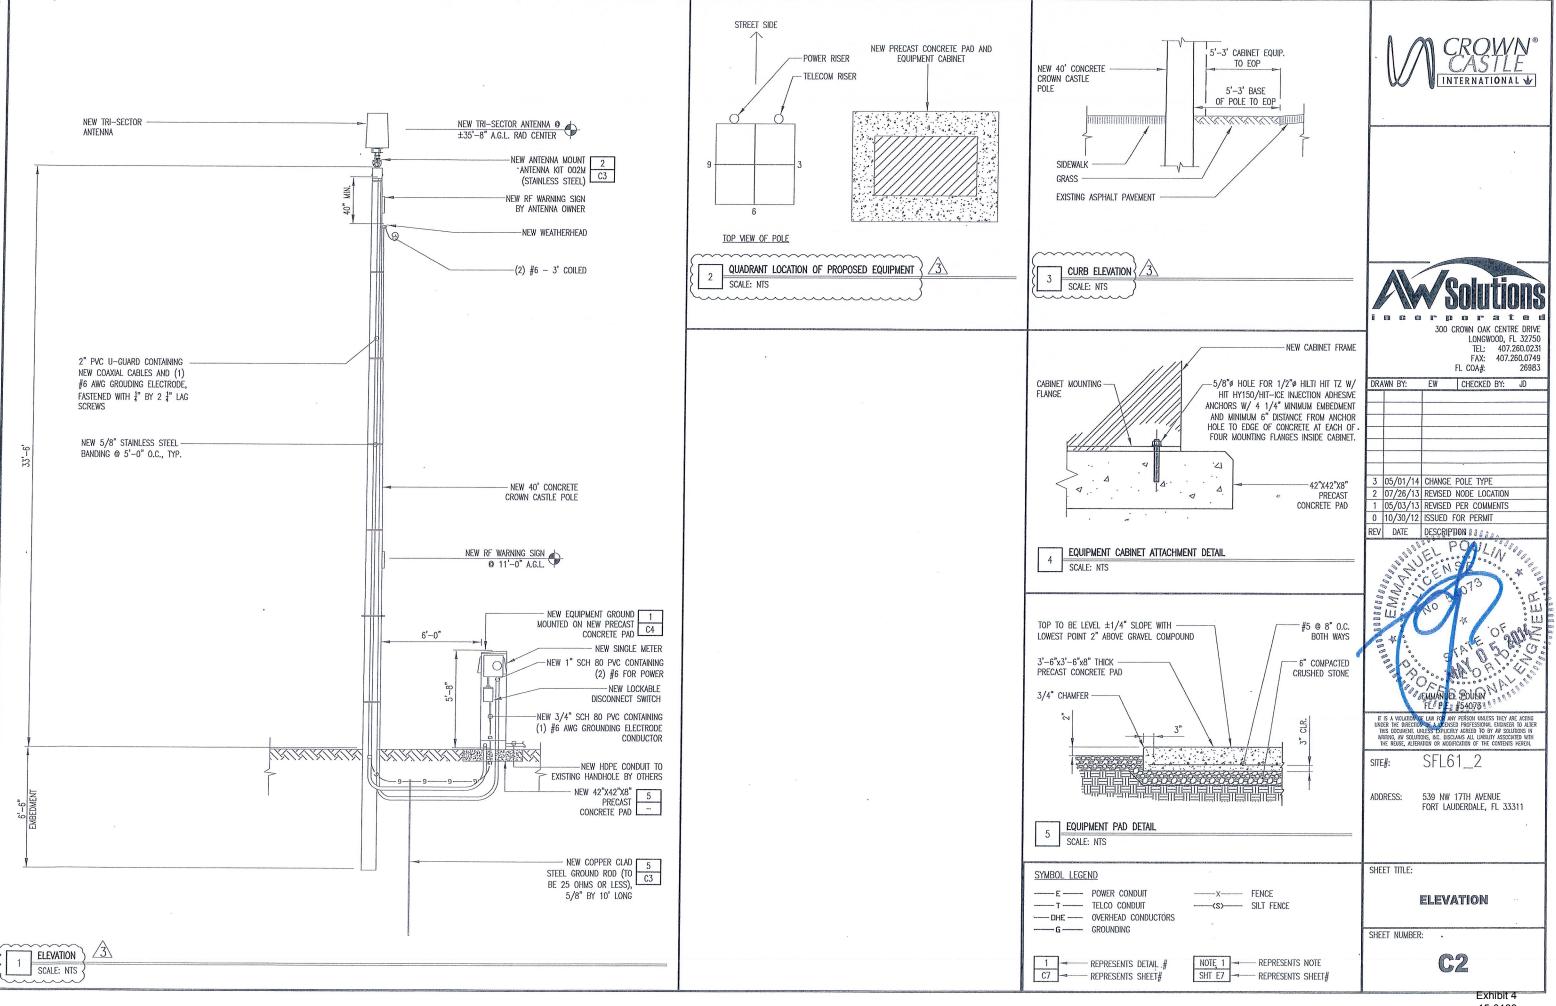


15-0160 Page 5 of 7

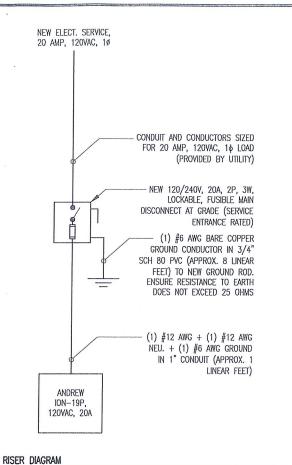

SCALE: NTS

- SHORT CIRCUIT CURRENT RATING OF FUSIBLE MAIN DISCONNECT: 100kA PER FLORIDA BUILDING CODE 2010: FEEDER CONDUCTORS ARE SIZED FOR A
- MAXIMUM VOLTAGE DROP OF 2% AT DESIGN LOAD OF 20A. PER FLORIDA BUILDING CODE 2010: BRANCH CIRCUIT CONDUCTORS ARE SIZED
- FOR A MAXIMUM VOLTAGE DROP OF 3% AT DESIGN LOAD. HOWEVER, THIS DESIGN CONTAINS NO BRANCH CIRCUITS.
- ALL CONDUCTORS ARE TO BE COPPER WIRE WITH INSULATION TYPE XHHW.
 ALL ABOVE GRADE CONDUIT IS TO BE UV RESISTANT SCHEDULE 80 PVC. ALL BELOW GRADE CONDUIT IS TO BE SCHEDULE 40 PVC.

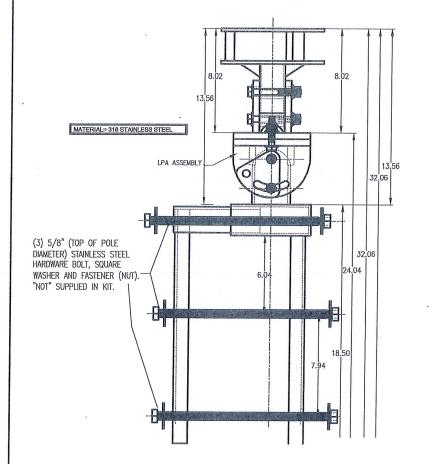

ANTENNA MOUNTING KIT (002M)

SCALE: NTS

KOTHREIT SCALA DIVISION

Kathrein's dual band antennas are ready for 3/G applications, covering all existing wireless bands as well as all spectrum under consideration for future systems, AMPS, PCS and 3G/UMTS.


- Wide band operation.
- Exceptional intermodulation characteristics.
- · High strength liberglass radome.
- * Internal diplexers allow the +45° polarization (upper and lower bands) to be combined on one connector and the 45° polarization (upper and lower bands) to be combined on a second connector for each antenna.

General specifications:

See reverse for order information.

| Frequency range | 806-960 MHz | | | | |
|--------------------------------------|--|--|--|--|--|
| madento) tenda | 1710–2170 MHz | | | | |
| VSWR | <1.5:1 | | | | |
| Impedance | 50 ohms | | | | |
| Intermodulation (2x20w) | M3: <-150 dBc | | | | |
| Polarization | +45° upper and lower band -45° upper and lower band | | | | |
| Connector | 6 x 7-16 DIN female | | | | |
| lsolation intrasystem intersystem | >30 dB >40 dB (806-960 // 1710-2170 MHz) | | | | |
| Radome color | Brown, gray or dark gray (custom colors available at additional cost) | | | | |
| Weight | 50 lb (22.7 kg) | | | | |
| Heighi | 24 inches (609 mm) | | | | |
| Redome diameter | 16 inches (407 mm) | | | | |
| Sauivalent flat plate area | 1.6 ft² (0.148 m²) | | | | |
| Wind survival rating* | 100 mgh (160 kph) | | | | |
| Shipping dimensions | 32 x 20 x 19 inches (813 x 508 x 483 mm) | | | | |
| Shipping weight | 52 lb (23.5 kg) | | | | |
| Mounting | Designed to be mounted on top of a vilility pole using a costom mounting bracker surplied by the customer. | | | | |



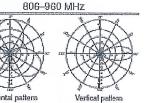

67 1W 4-11 W 1811 14-

±45°-polarization ±45°-polarization 1710-2170 MHz



| tical patterns -polarization | | | |
|---------------------------------|---|----------|----------------------|
| 1920-2170 MHz | | | |
| (5.6 tib) | 1 | 05/03/13 | REVISED PER COMMENTS |
| >25 dB (co-pdar) | | | ISSUED FOR DEDUIT |

10/30/12 ISSUED FOR PERMIT REV DATE DESCRIPTION

WEGPOULD NP

INTERNATIONAL 🍲

300 CROWN OAK CENTRE DRIVE

FL COA#:

DRAWN BY: EW CHECKED BY: JD

LONGWOOD, FL 32750

TEL: 407.260.0231 FAX: 407.260.0749

26983

SFL61_2

539 NW 17TH AVENUE

FORT LAUDERDALE, FL 33311

SHEET TITLE:

DETAILS


SHEET NUMBER:

C3

Specifications: 806-866 MHz 824-694 MHz \$80-960 MHz 1710-1680 MHz 1850-1990 MHz Gain 11.1 四 114郎 11.8 dEi 12.5 dBi 13.9 dBi Front-to-back ratio (160° ± 90°) >23 dB (ca-polar) >23 dB (co-polar) >25 dB (co-polar) >20 dB (total power) >20 dB (total power) >22 dB (total power >25 dB (co-polar) >25 dB (co-polar) >25 dB (co-polar) >22 dB (colal power) >22 dB (colal power) >22 dB (colal power) Maximum input power 250 waits (at 50°C) 250 waits (at 50°C) 250 waits (at 50°C) 200 waits (at 50°C) 200 waits (at 50°C) 200 waits (at 50°C) +45° and -45° polerization 67° (helf-power) 66° (helf-power) 64° (helf-power) fromzontel bearnwidth 66° (half-power) 60° (half-power) 60° (half-power) +45° and -45° polarization vertical beamwidth 34° (half-power) 93° (half-power) 90° (hali-power) 20" (half-power) (8º (half-power) 17.5º (half-power) Cross polar ratio Main direction 25 d8 (typical) >10 d8 25 dB (typical) >10 dB


ANTENNA SPECIFICATIONS

SCALE: NTS

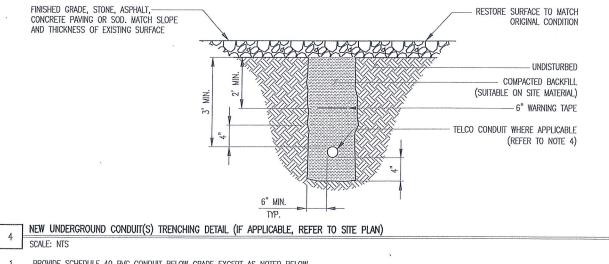


PROVIDE SCHEDULE 40 PVC CONDUIT BELOW GRADE EXCEPT AS NOTED BELOW. PROVIDE SCHEDULE 80 PVC CONDUIT AND ELBOWS AT STUB UP LOCATIONS (i.e. SERVICE POLE, BTS EQUIPMENT, ETC.). INSTALL UTILITY PULLBOXES PER NEC.

SEPARATION DIMENSION TO BE VERIFIED WITH LOCAL UTILITY CO. REQUIREMENTS. CONDUIT/TUBING CONTAINING FIBER OPTIC CABLING TO BE FILLED WITH GEL TO PREVENT WATER PENETRATION, COMMONLY REFERRED TO AS "ICKY PICK."

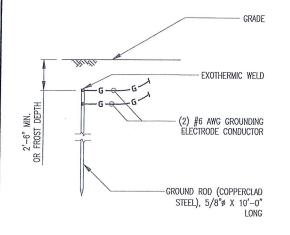

GROUND ROD DETAIL SCALE: NTS

GROUND ROD TO BE DRIVEN 10' VERTICALLY.

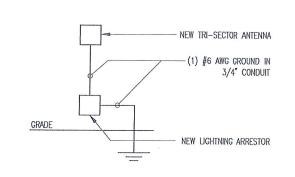


ANTENNA GROUNDING SCHEMATIC

SCALE: NTS

15-0160

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SHROUD KIT LOSH-BBU-1 GROUND MOUNT

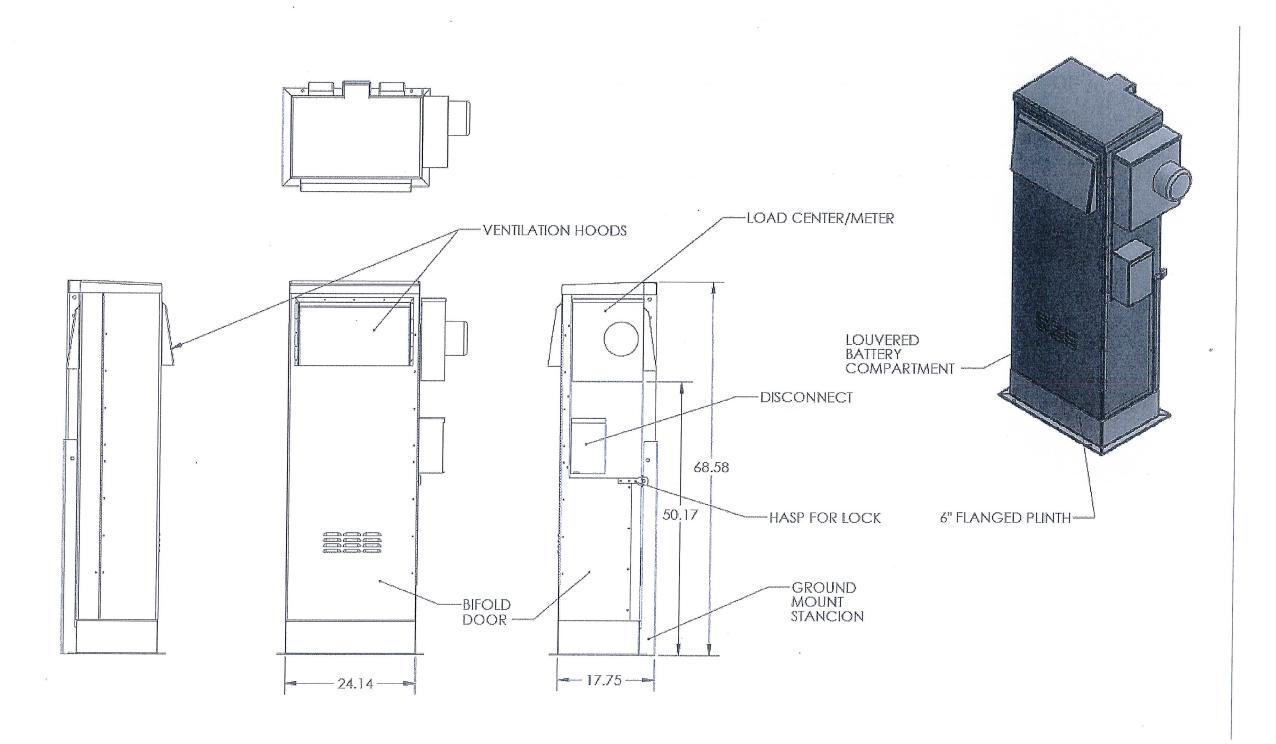



300 CROWN OAK CENTRE DRIVE LONGWOOD, FL 32750 TEL: 407.260.0231 FAX: 407.260.0749 FL COA#: 26983

| DR | AWN BY: | EW | CHECKED | BY: | JD |
|----|------------|-----------|-----------|------|----|
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1 05/03/13 REVISED PER COMMENTS
0 10/30/12 ISSUED FOR PERMIT
REV DATE DESCRIPTION



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SITE#: SFL61_2

ADDRESS: 539 NW 17TH AVENUE FORT LAUDERDALE, FL 33311

SHEET TITLE:

DETAILS

SHEET NUMBER: -

C4

Exhibit 4

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