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BCC Engineering LLC
6401 SW 87th Avenue, Suite 200
Miami, FL 33173

ISSUE/REVISION

06/24/2025	PHASE 2 BID DOCUMENTS
I/R DATE	DESCRIPTION

PROJECT NUMBER

P12633

SHEET TITLE

GRADING AND DRAINAGE PLAN

SHEET NUMBER

C105

LEGEND

3.25	PROPOSED ELEVATION
5.30	MEG
5.30	TOC
5.30	TOW
5.30	MEG BOW
1.0%	SLOPE ARROW
GB	GRADE BREAK
—	PROP. SWALE
—	PROP. SWALE CENTERLINE
—	PROP. BUILDING
—	EXISTING OVERHEAD ELECTRIC TO REMAIN
—	EXISTING POTABLE WATER LINE TO REMAIN
—	EXISTING STORM LINE TO REMAIN
—	EXISTING STORM STRUCTURE TO REMAIN
—	EXISTING SANITARY SEWER TO REMAIN
—	EXISTING IRRIGATION LINE TO REMAIN
—	EXISTING BURIED ELECTRIC TO REMAIN
—	EXISTING BURIED TELEPHONE TO REMAIN
—	EXISTING BURIED COMMUNICATION TO REMAIN
—	EXISTING BURIED GAS TO REMAIN

NOTES:

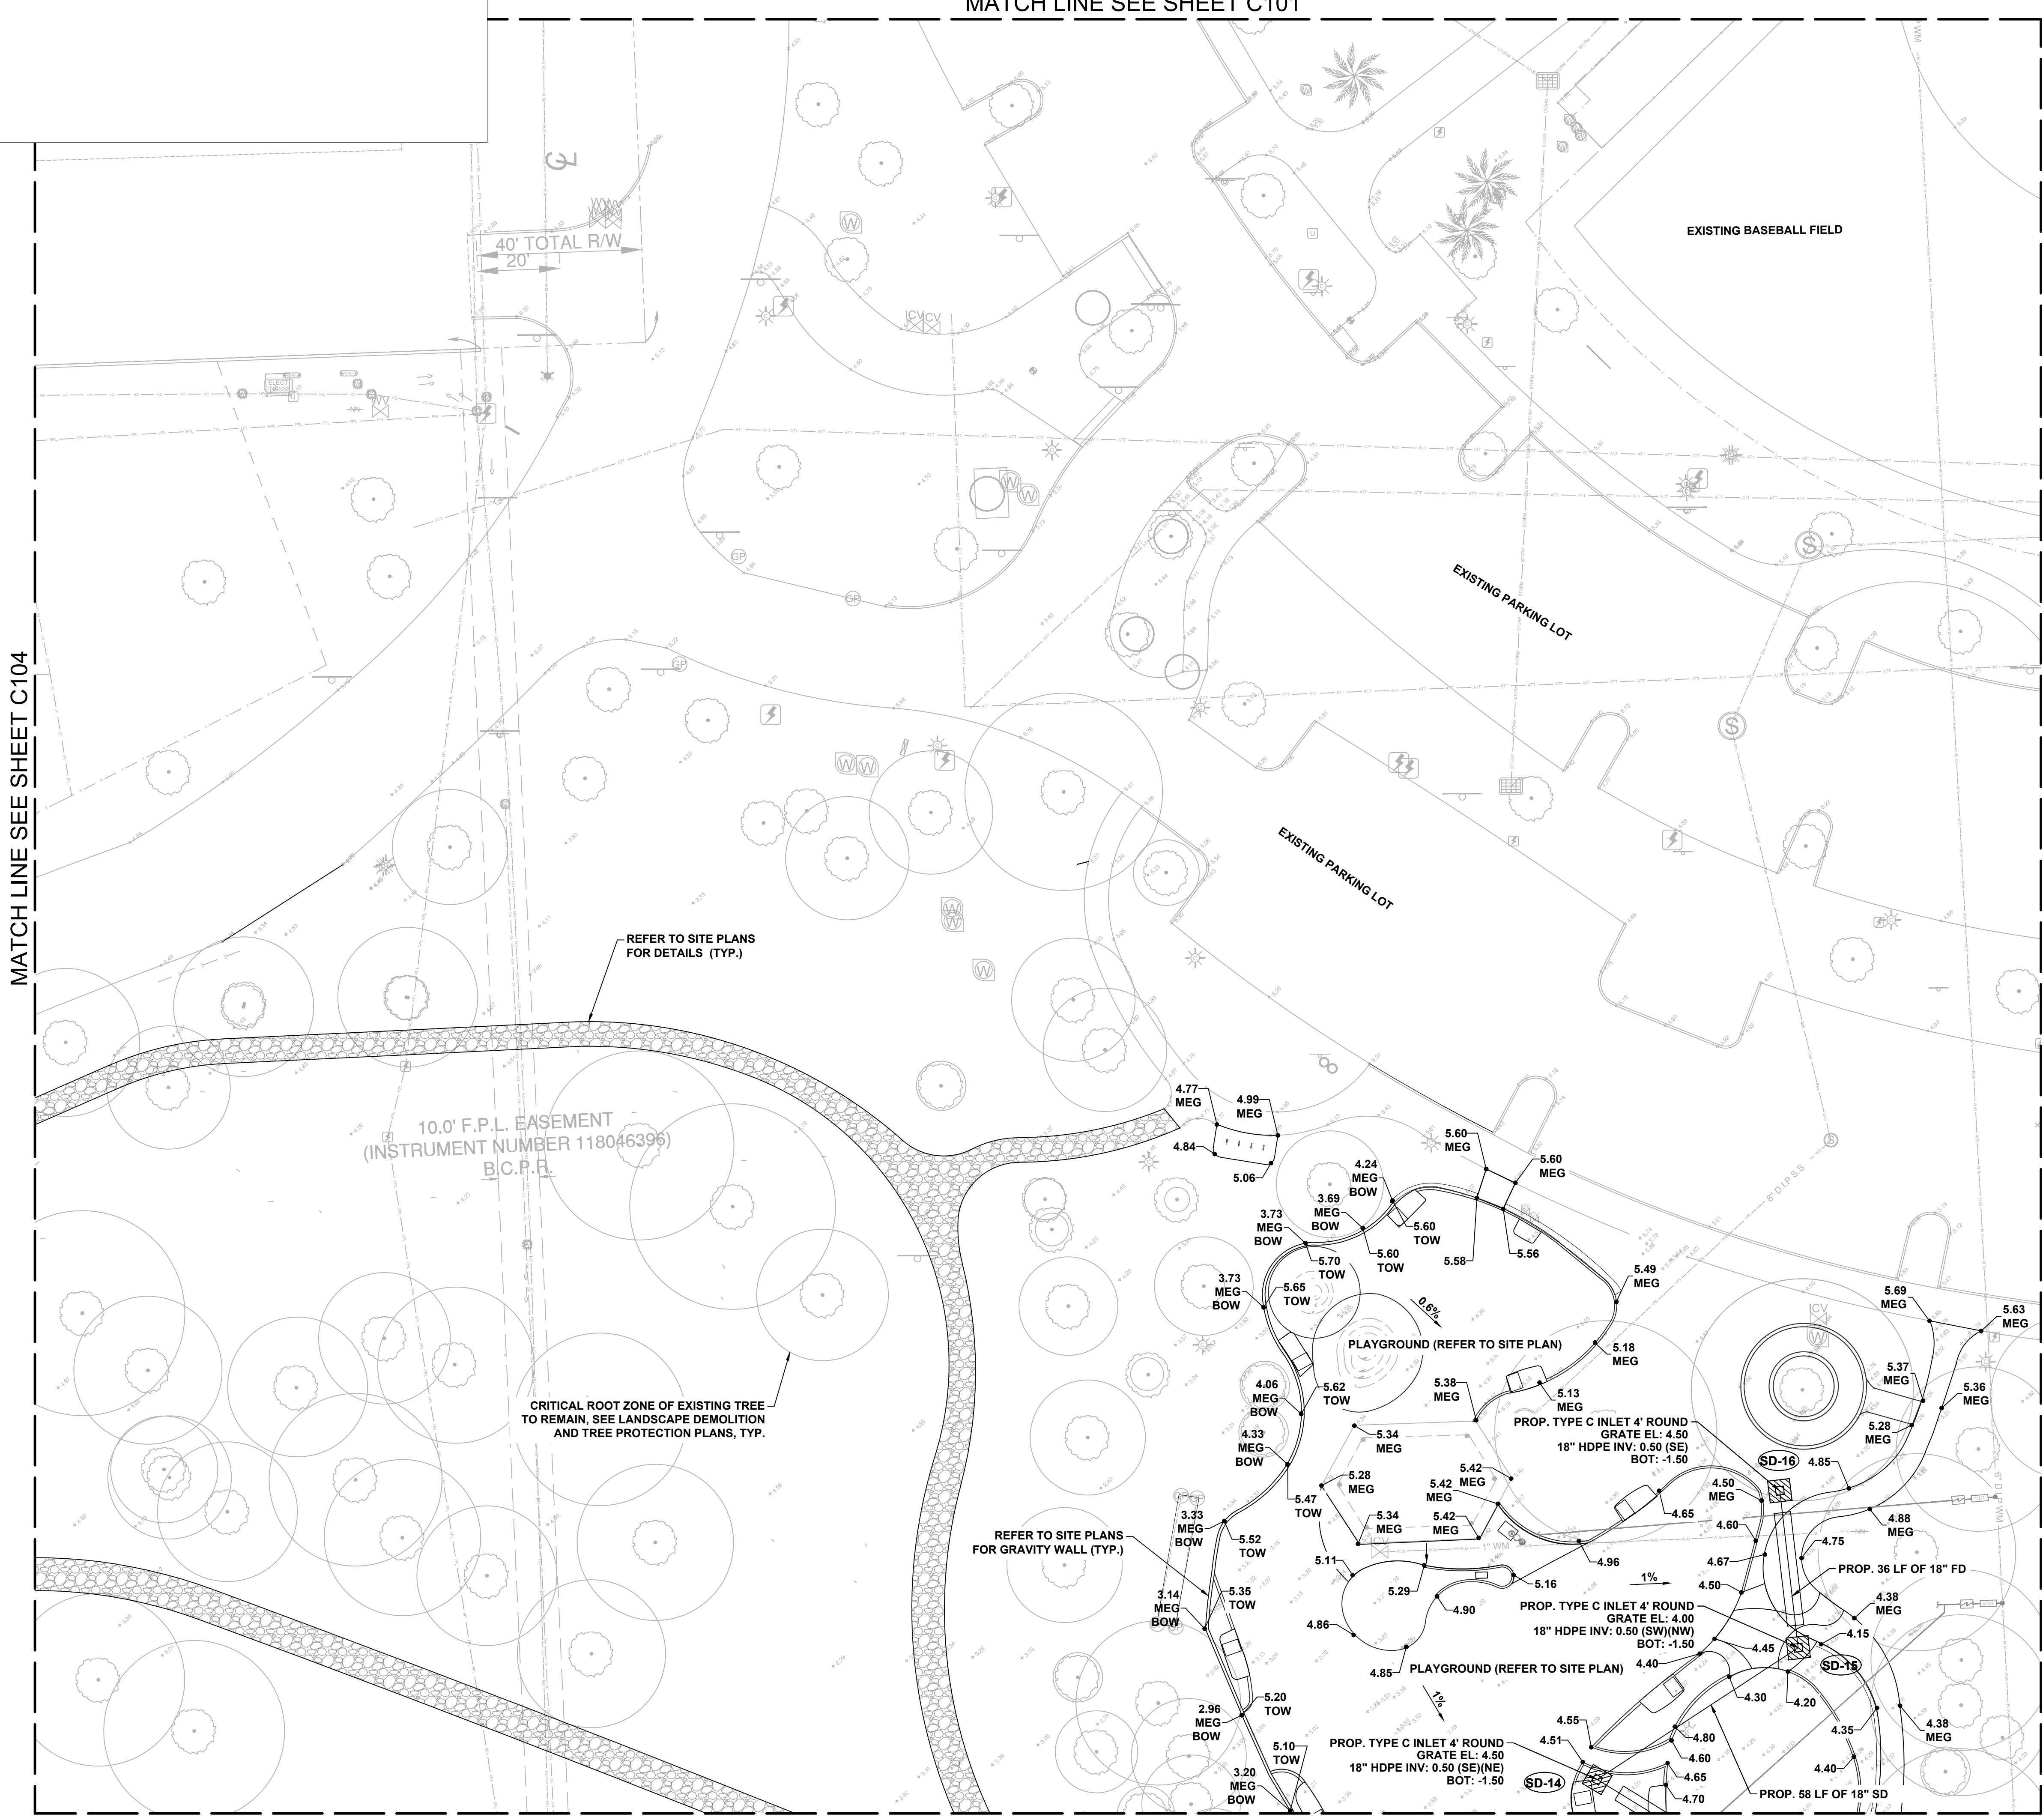
1. PROPOSED SIDEWALK SHALL NOT EXCEED 2% CROSS-SLOPE AND 5% LONGITUDINAL SLOPE.
2. PROPOSED GRASS TO HARMONIZE SIDEWALK IMPROVEMENTS SHALL NOT EXCEED 25% SLOPE.
3. PROVIDE POSITIVE DRAINAGE AT SAFETY SURFACING MAXIMUM CROSS-SLOPE SHALL NOT EXCEED 2%.
4. THE CONTRACTOR SHALL VERIFY EXISTING GRADES AND STRUCTURE INFORMATION FOR ACCURACY PRIOR TO THE START OF GRADING. NOTIFY THE OWNER'S REPRESENTATIVE IMMEDIATELY SHOULD CONFLICTS ARISE. REDIRECT WORK TO AVOID DELAY.
5. THE CONTRACTOR SHALL VERIFY THE LOCATIONS OF ALL EXISTING UTILITIES, STRUCTURES AND SERVICES BEFORE COMMENCING THE WORK. THE LOCATIONS OF UTILITIES, STRUCTURES AND SERVICES SHOWN IN THE CONTRACT DOCUMENTS SHALL BE DEEMED TO BE APPROXIMATE ONLY. ALL DISCREPANCIES WITH WHAT IS SHOWN AND THE ACTUAL FIELD CONDITIONS SHALL BE REPORTED TO THE OWNER'S REPRESENTATIVE. CONTRACTOR SHALL RECORD ALL UTILITY MARKINGS ON A SEPARATE SET OF DRAWINGS. THIS SET OF EXISTING UTILITY DRAWINGS SHALL BE KEPT ON-SITE FOR REFERENCE FOR THE DURATION OF THE PROJECT.
6. PROPOSED GRADES SHALL MEET EXISTING GRADES WITH A SMOOTH AND CONTINUOUS TRANSITION SO AS TO AVOID TRAPPING WATER. CONTRACTOR SHALL NOTIFY OWNER'S REPRESENTATIVE IF Puddling IS SUSPECTED AND REDIRECT WORK SO AS TO AVOID DELAY WHILE AWAITING RESPONSE.
7. REMOVE ALL VEGETATION, ORGANIC MATERIAL, BUILDING MATERIAL, DEMOLITION DEBRIS, AND ALL OTHER DELETERIOUS SUBSTANCES FROM THE AREA OF THE FILL. REMOVE ALL DEBRIS FROM THE SITE AND LEGALLY DISPOSE OFFSITE.
8. ALL PROPOSED ELEVATIONS REFERENCE THE NORTH AMERICAN VERTICAL DATUM OF 1988 (NAVD88).
9. REFER LANDSCAPE DEMOLITION AND TREE PROTECTION PLANS FOR TREE PROTECTION.
10. SEE G101 KEY PLAN FOR NOT IN CONTRACT (NIC) LIMIT OF WORK.
11. ALL DRAINAGE IMPROVEMENTS ARE TO BE BUILT UNDER THIS CONTRACT, INCLUDING DRAINAGE IMPROVEMENTS SHOWN WITHIN NIC HATCHED AREAS.

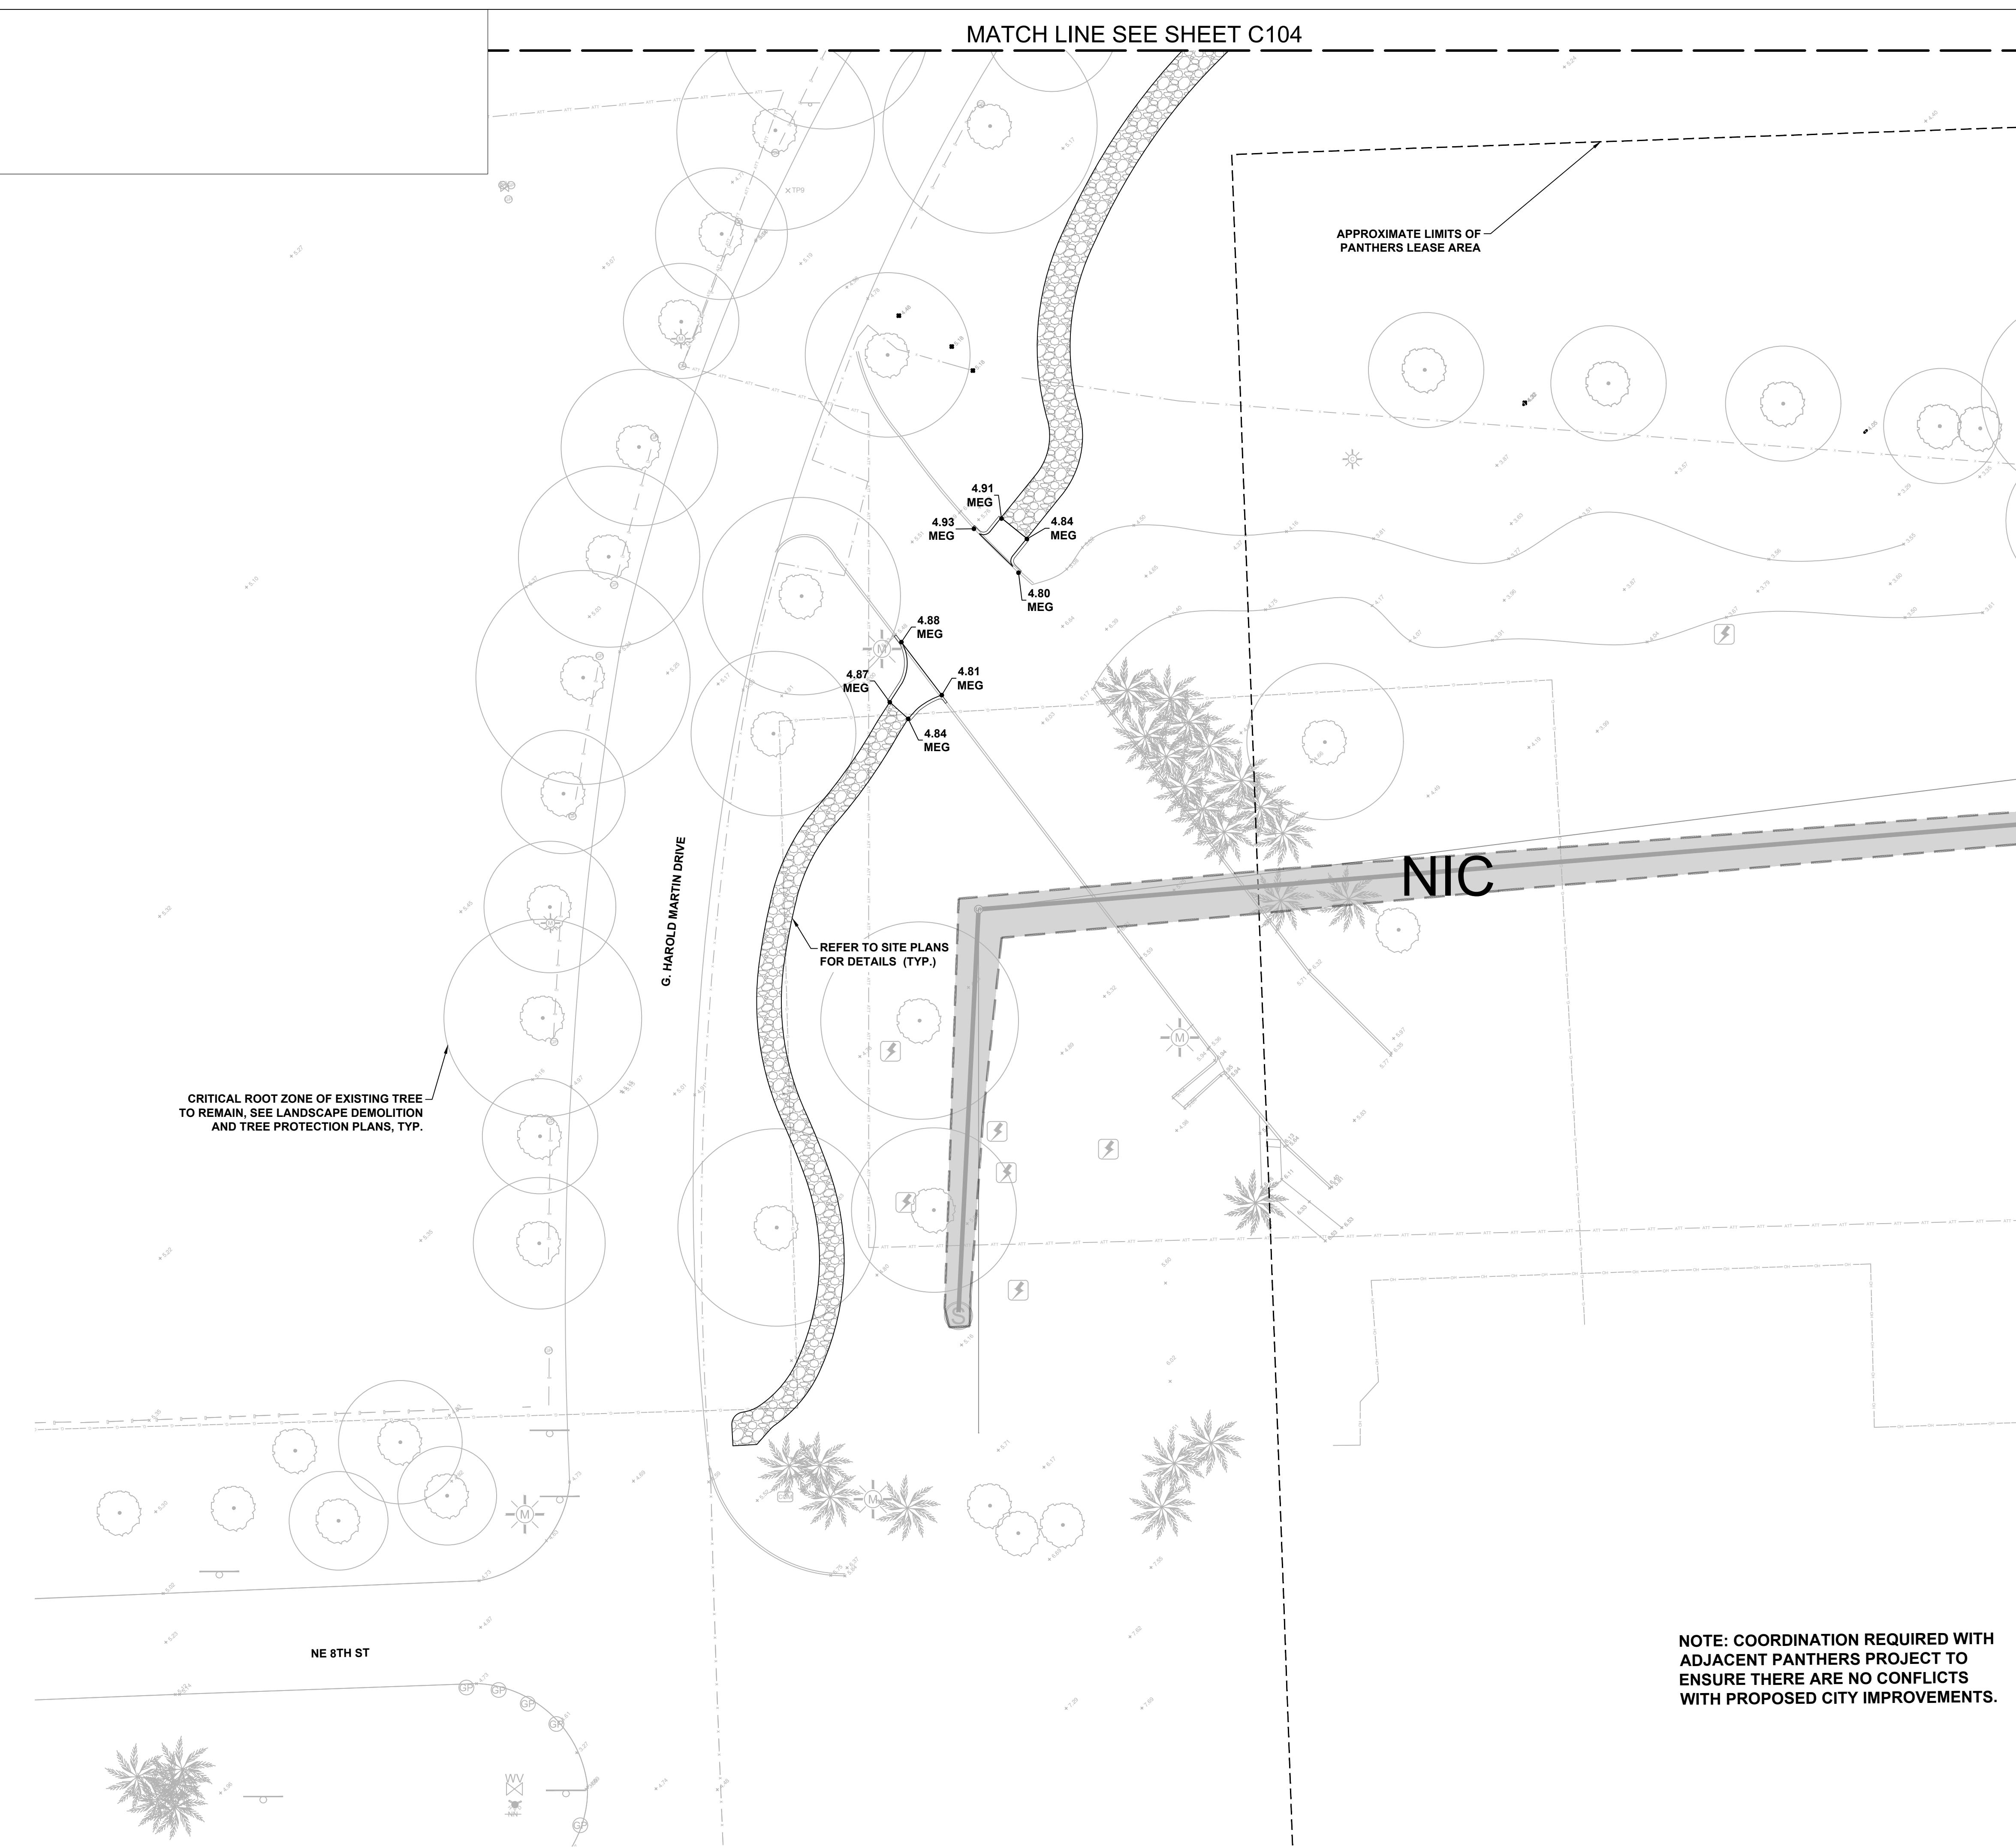
COORDINATE WITH AECOM ON LATEST ISSUE OF DRAWINGS BEFORE COMMENCEMENT OF CONSTRUCTION
NOTICE: THE OFFICIAL RECORD OF THIS SHEET IS THE ELECTRONIC FILE SIGNED AND SEALED UNDER RULE 61G15-23.004, F.A.C.

MATCH LINE SEE SHEET C101

MATCH LINE SEE SHEET C101

Project Management Initials: _____ Checked: _____ Approved: _____ ANSI D 24" x 36"





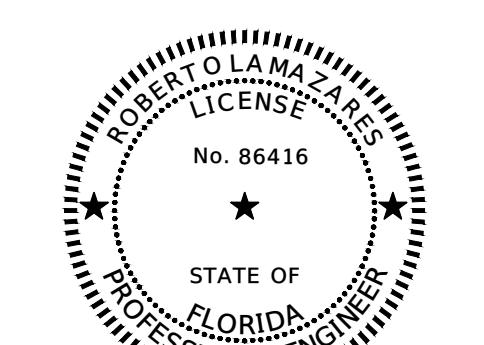
LEGEND

3.25 PROPOSED ELEVATION
5.30 MEG MATCH EXISTING GRADES
5.30 TOC TOP OF CURB
5.30 TOW TOP OF WALL
5.30 MEG BOW MATCH EXISTING GRADES BOTTOM OF WALL
1.0% SLOPE ARROW
GB GRADE BREAK
PROP. SWALE
PROP. SWALE CENTERLINE
PROP. BUILDING
EXISTING OVERHEAD ELECTRIC TO REMAIN
EXISTING POTABLE WATER LINE TO REMAIN
EXISTING STORM LINE TO REMAIN
EXISTING STORM STRUCTURE TO REMAIN
EXISTING SANITARY SEWER TO REMAIN
EXISTING IRRIGATION LINE TO REMAIN
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EXISTING BURIED COMMUNICATION TO REMAIN
EXISTING BURIED GAS TO REMAIN

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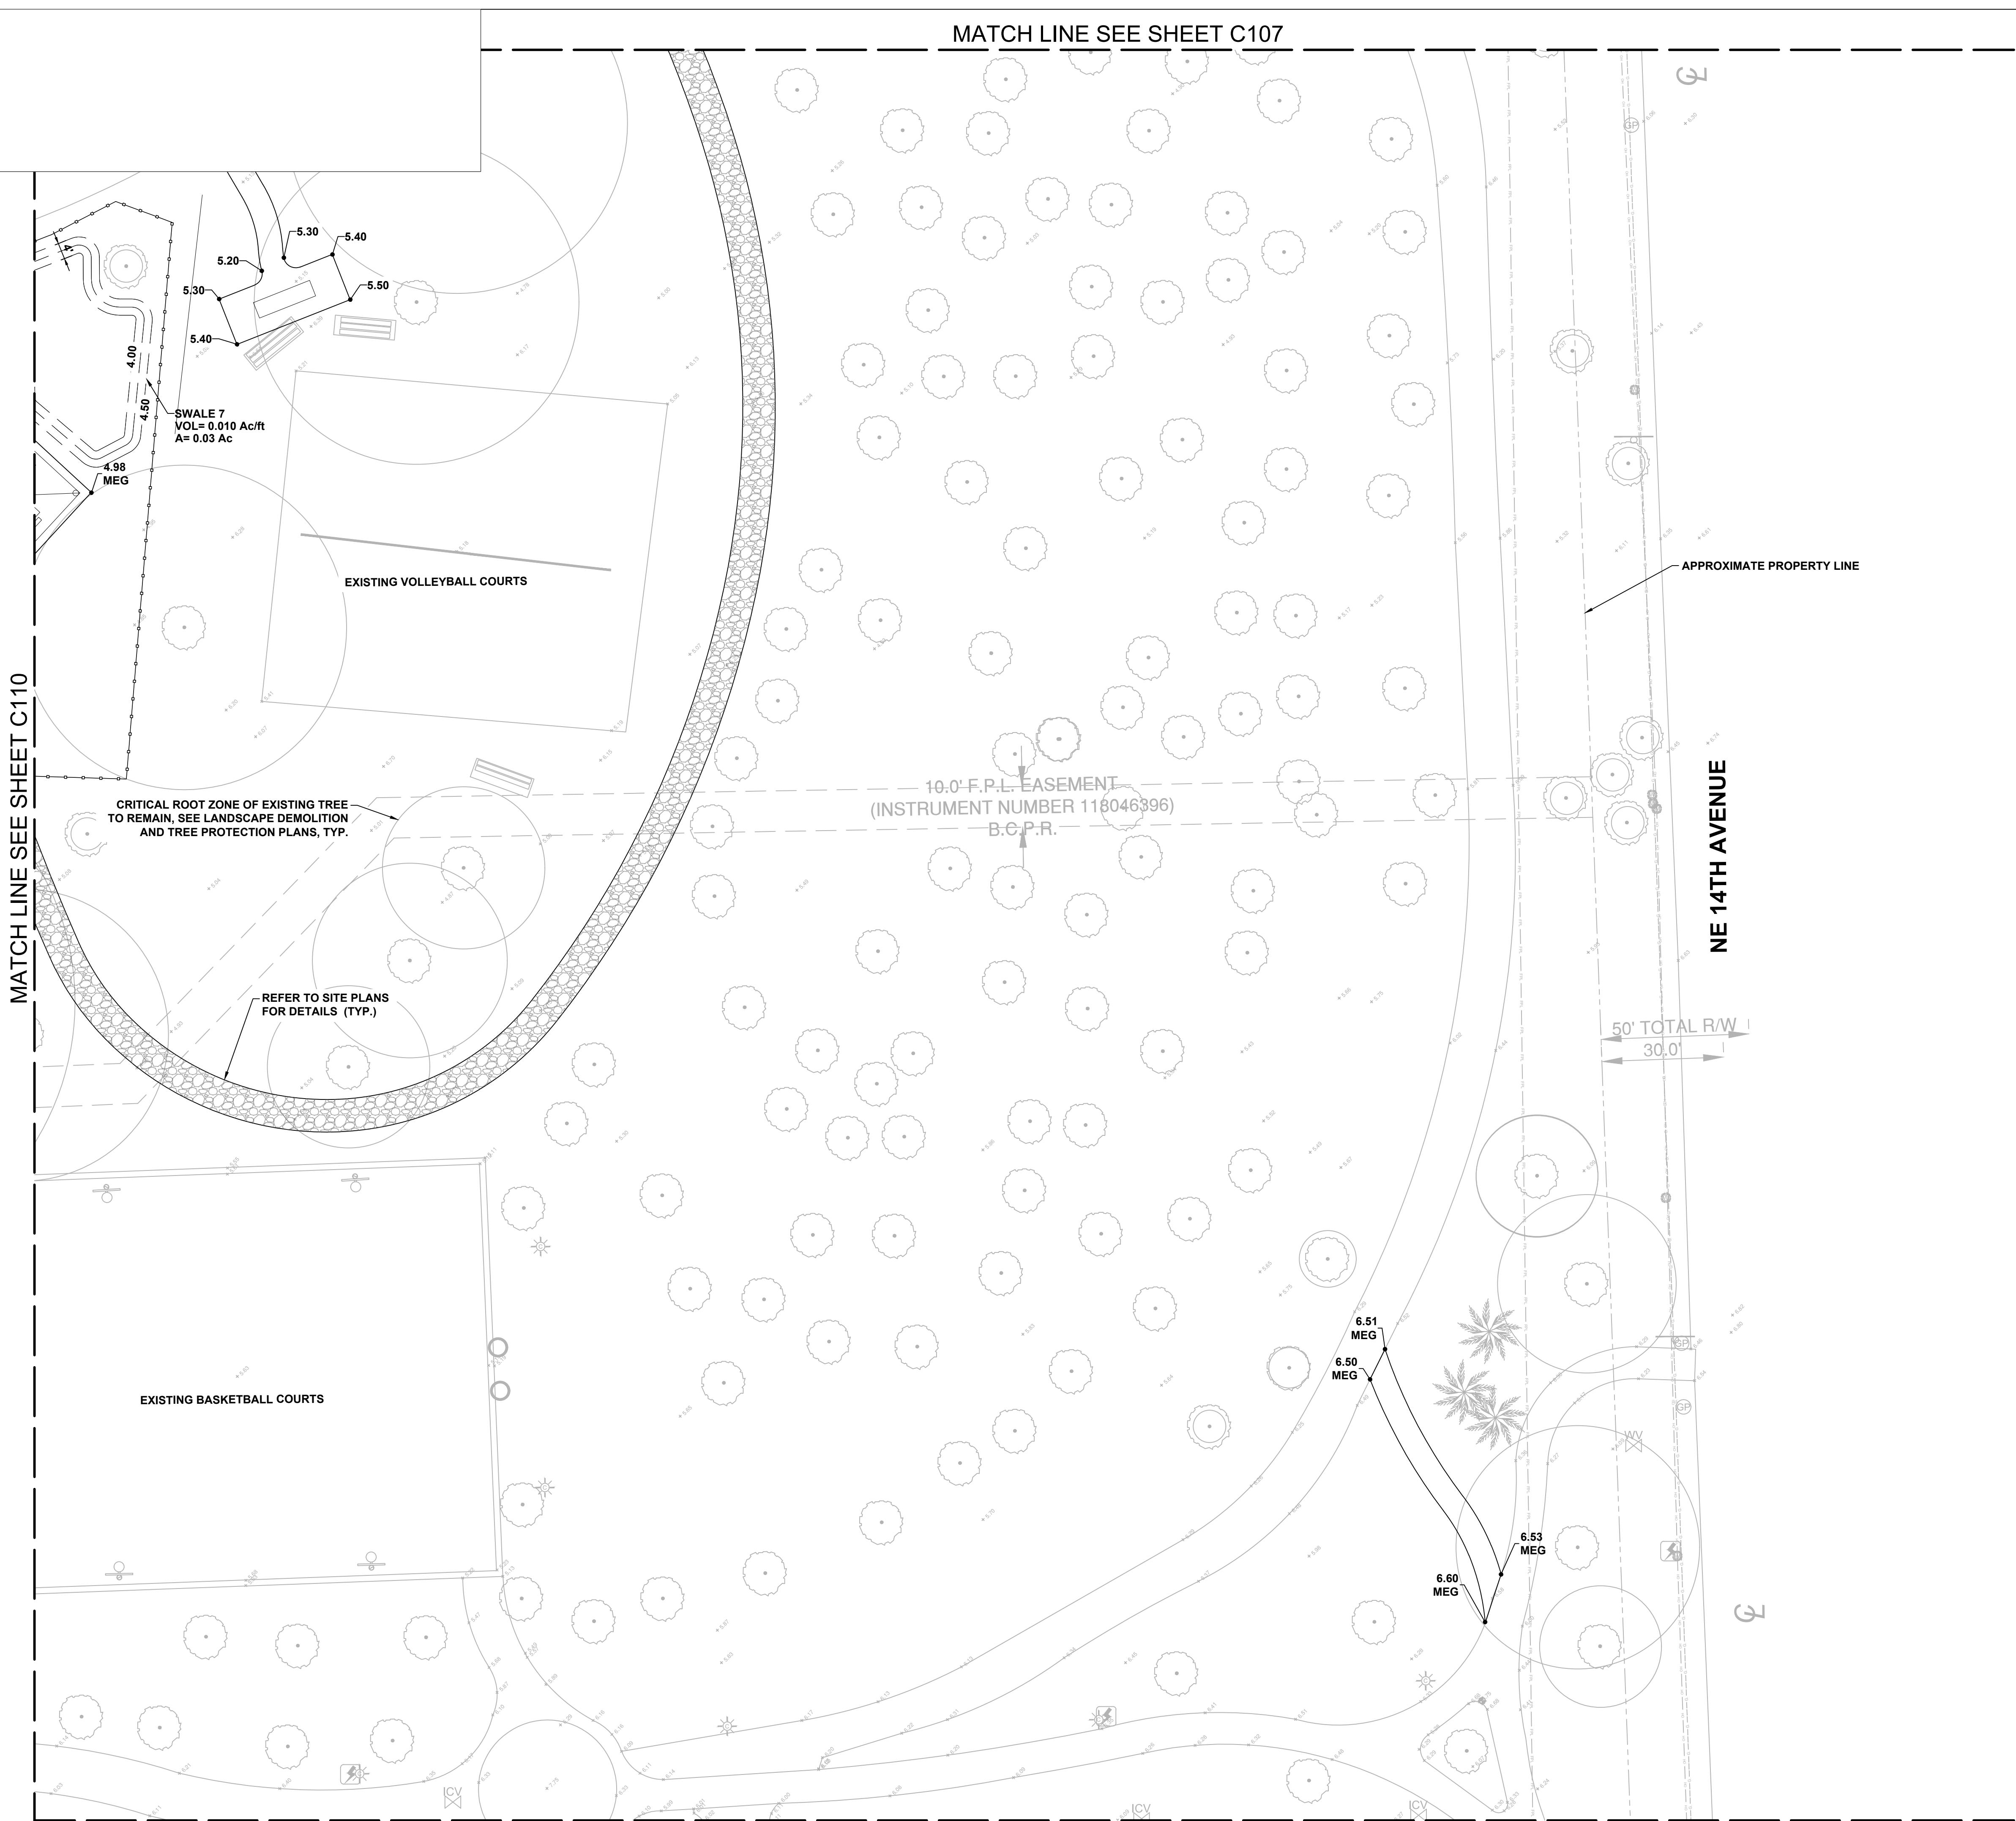
SHEET TITLE
GRADING AND DRAINAGE PLAN

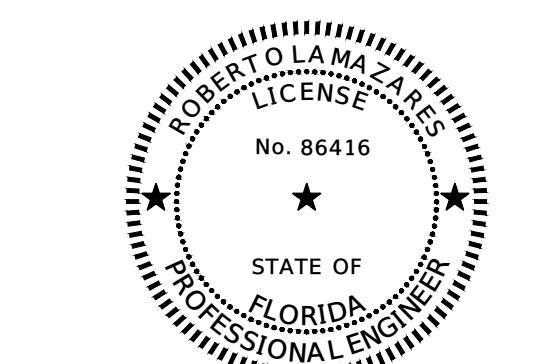
SHEET NUMBER
C111

COORDINATE WITH AECOM ON LATEST ISSUE OF DRAWINGS BEFORE COMMENCEMENT OF CONSTRUCTION
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MATCH LINE SEE SHEET C107

Project Management Initials: _____ Designer: _____ Checked: _____ Approved: _____ ANSI D 24" x 36"





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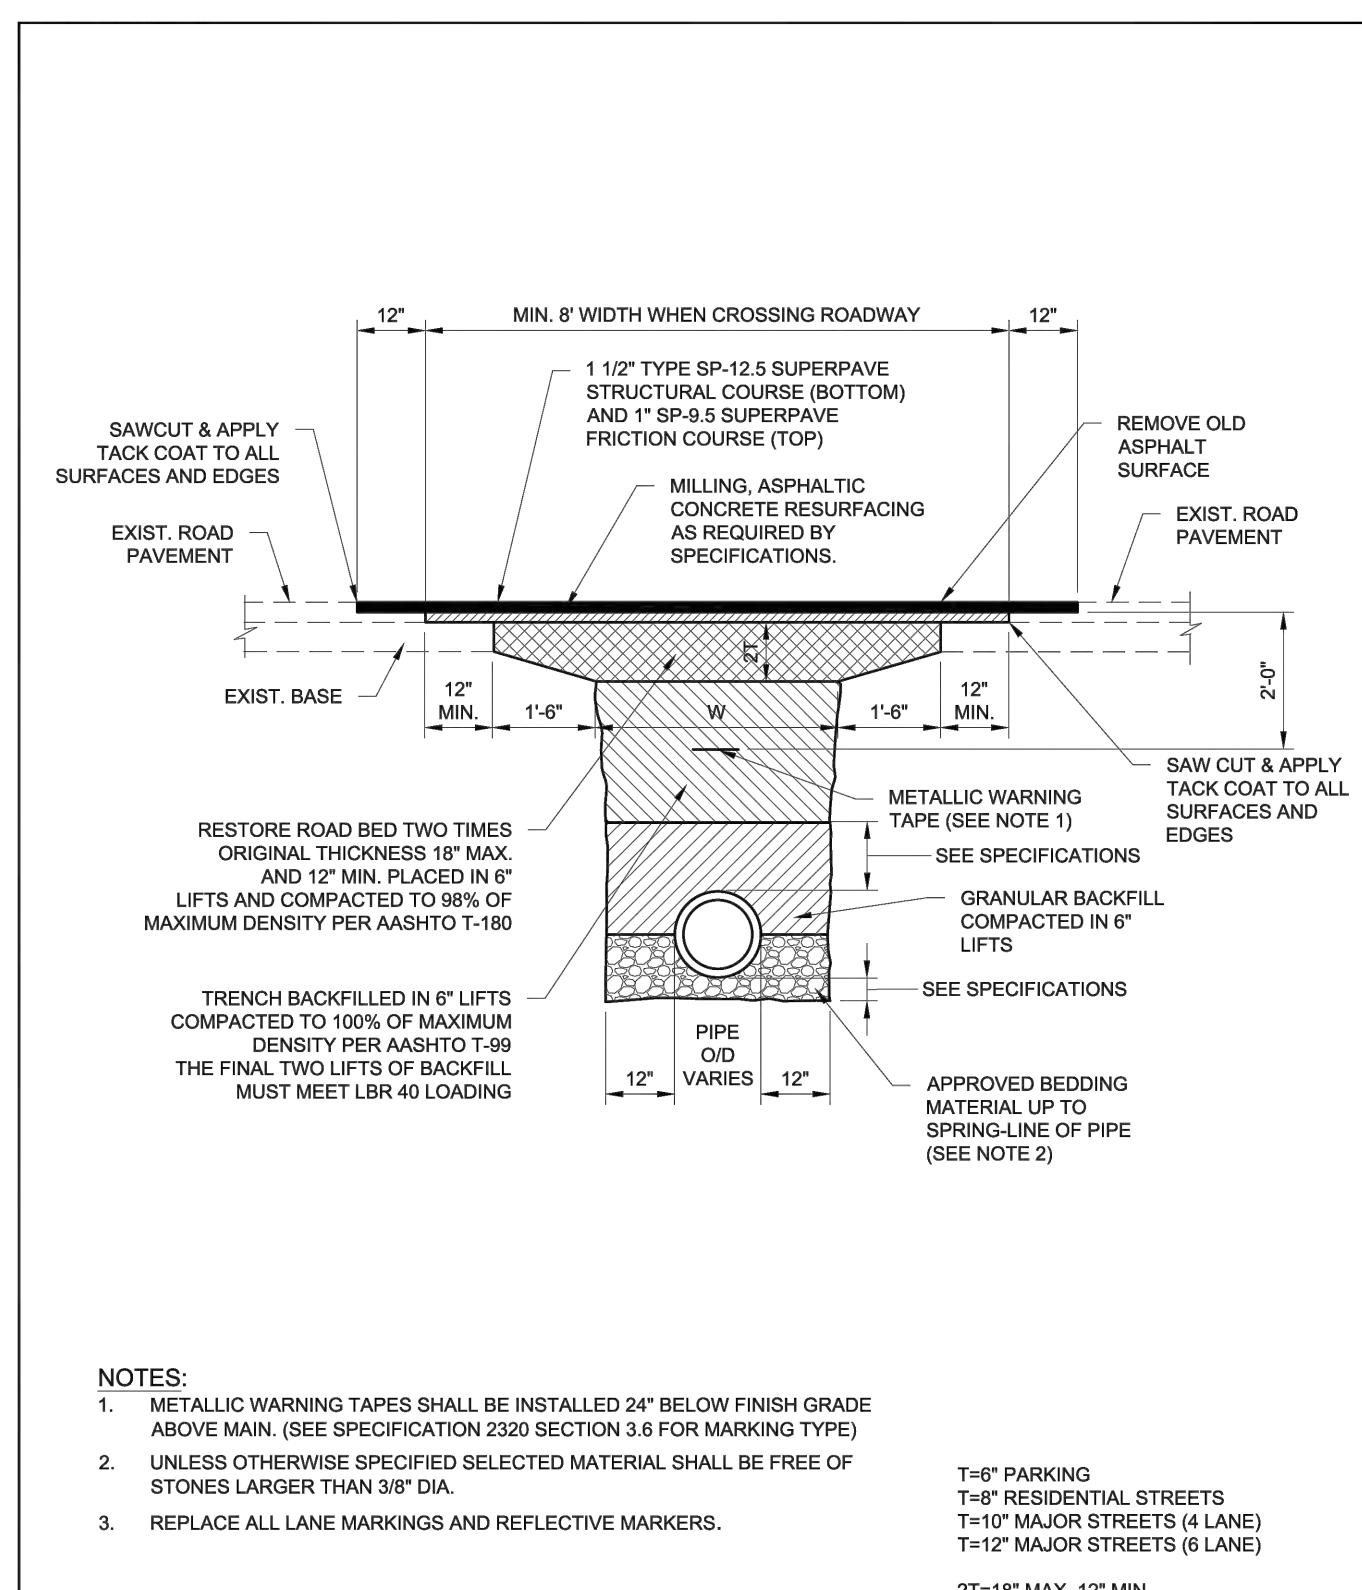
ISSUE/REVISION	DATE	DESCRIPTION
06/24/2025	PHASE 2 BID DOCUMENTS	

PROJECT NUMBER
P12633

SHEET TITLE
GRADING AND DRAINAGE DETAILS

SHEET NUMBER
C120

COORDINATE WITH AECOM ON LATEST ISSUE OF DRAWINGS BEFORE COMMENCEMENT OF CONSTRUCTION
NOTICE: THE OFFICIAL RECORD OF THIS SHEET IS THE ELECTRONIC FILE SIGNED AND SEALED UNDER RULE 61G15-23.004, F.A.C.

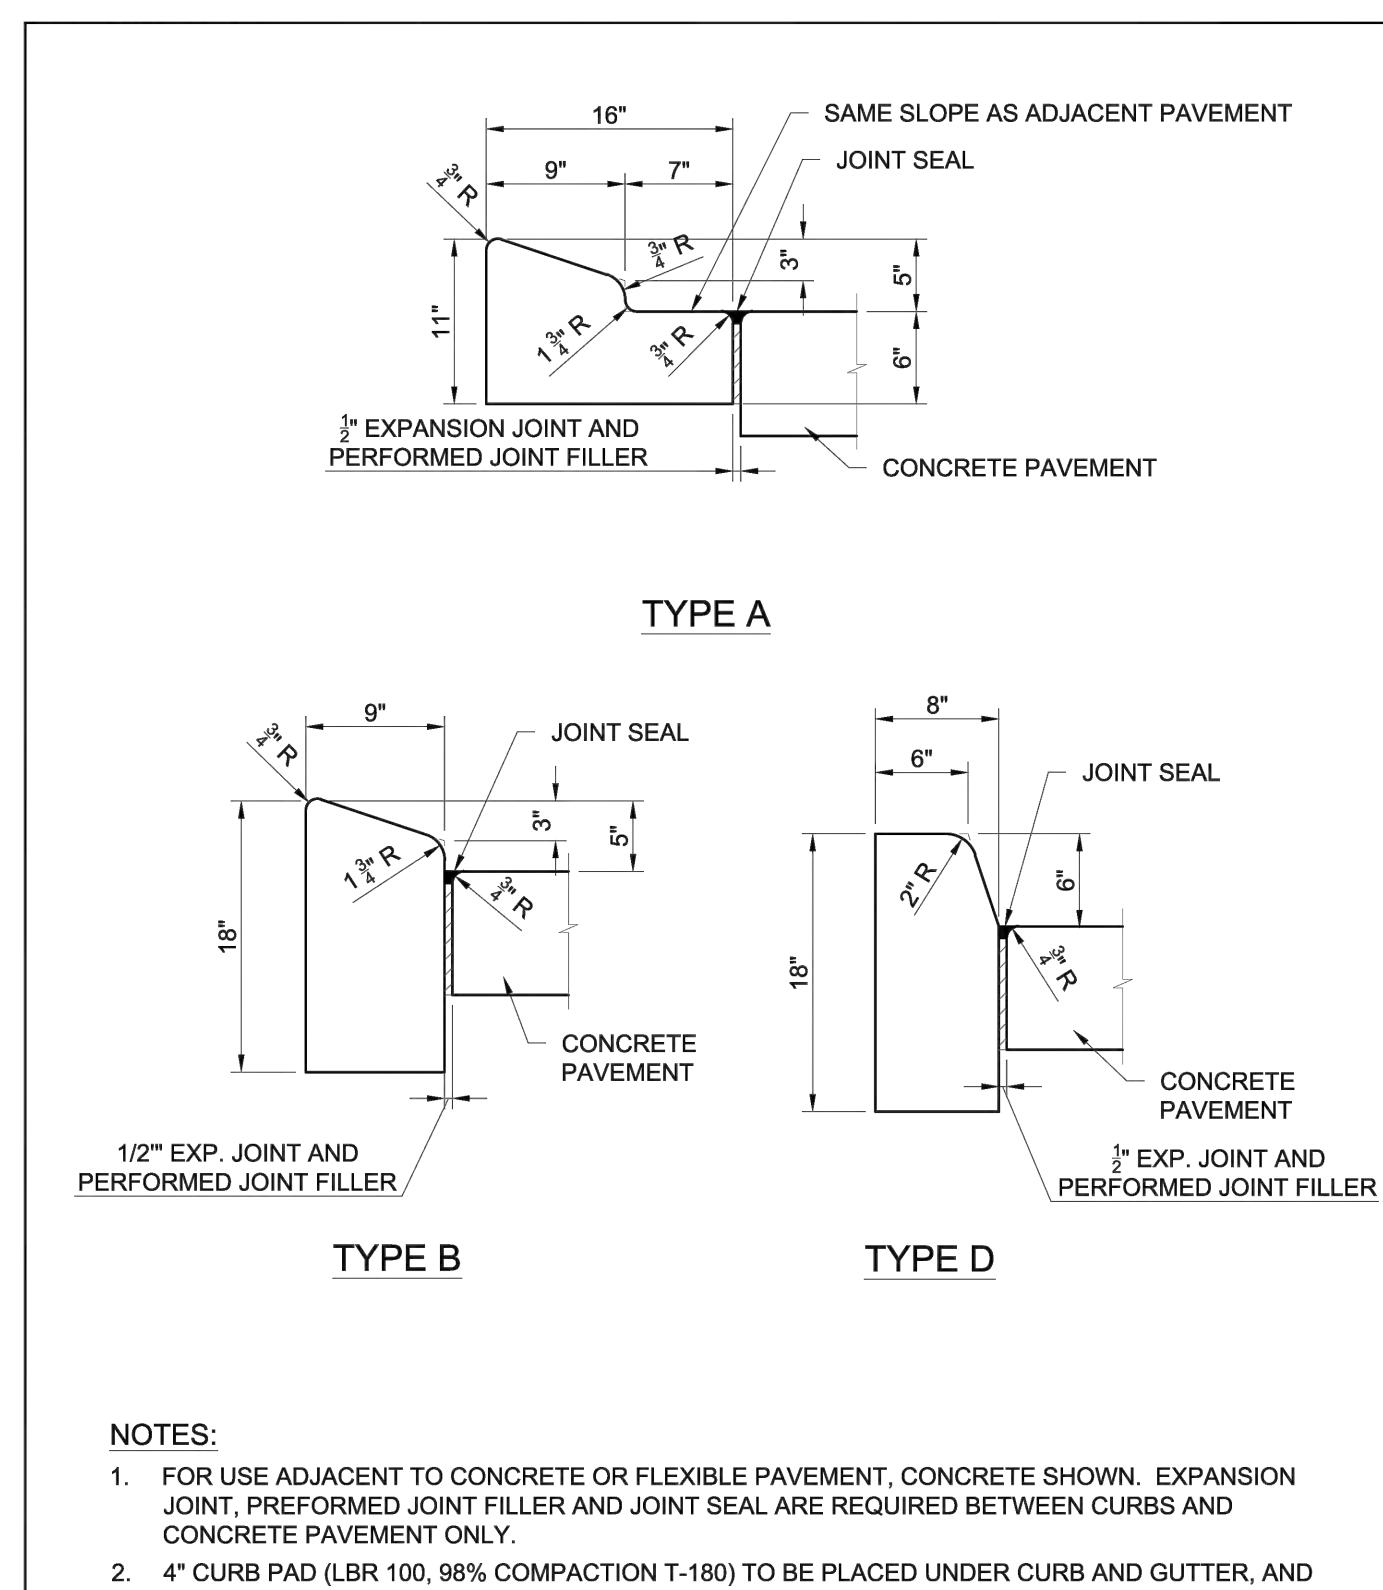


CITY OF FORT LAUDERDALE
PUBLIC WORKS DEPARTMENT
ENGINEERING DETAILS
100 North Andrews Avenue, Fort Lauderdale, Florida 33301

TYPICAL TRENCH AND PAVEMENT
RESTORATION FOR TRANSVERSE PIPE CROSSING
SHEET 1

ROAD 001

2017/03/11

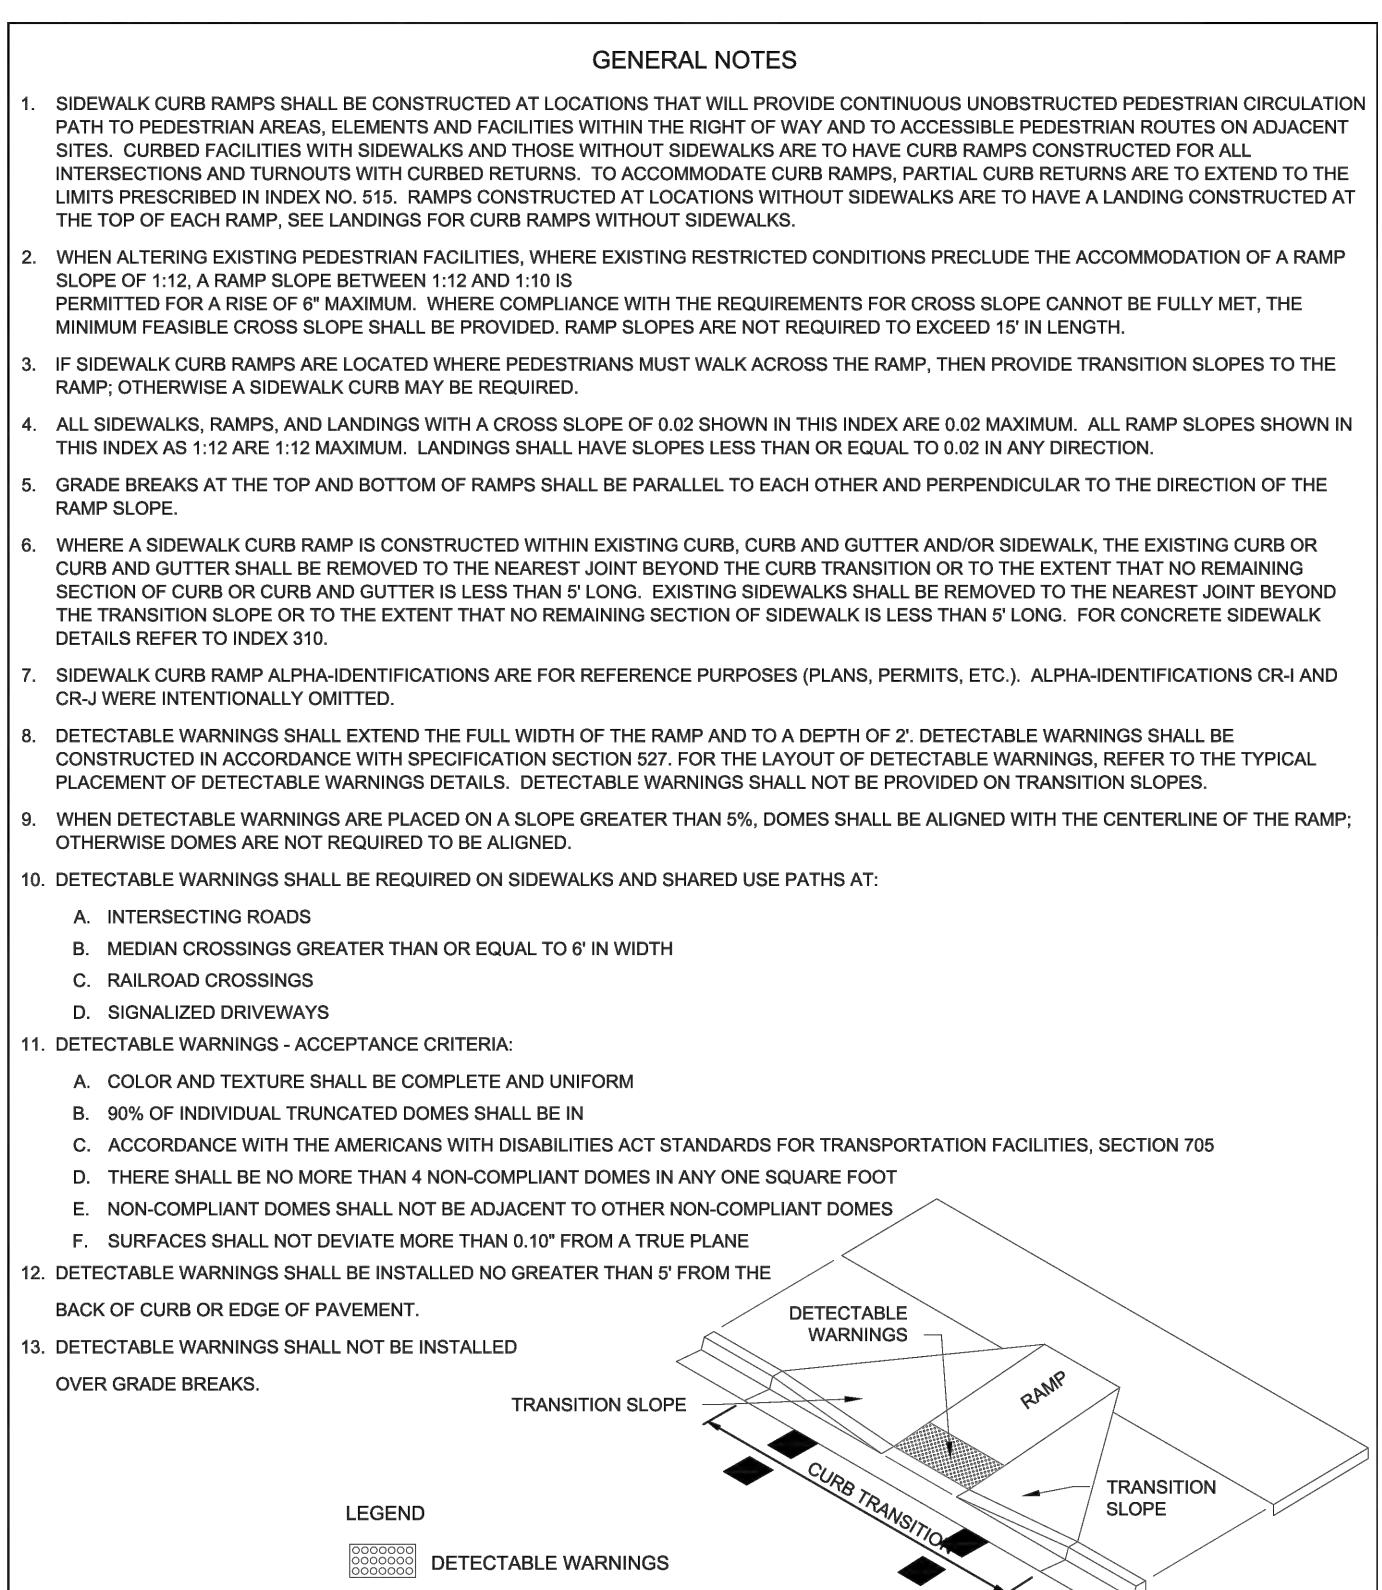


CITY OF FORT LAUDERDALE
PUBLIC WORKS DEPARTMENT
ENGINEERING DETAILS
100 North Andrews Avenue, Fort Lauderdale, Florida 33301

CONCRETE CURB AND GUTTER
TYPE A, TYPE B, AND TYPE D
SHEET 3

ROAD 007

2017/03/11

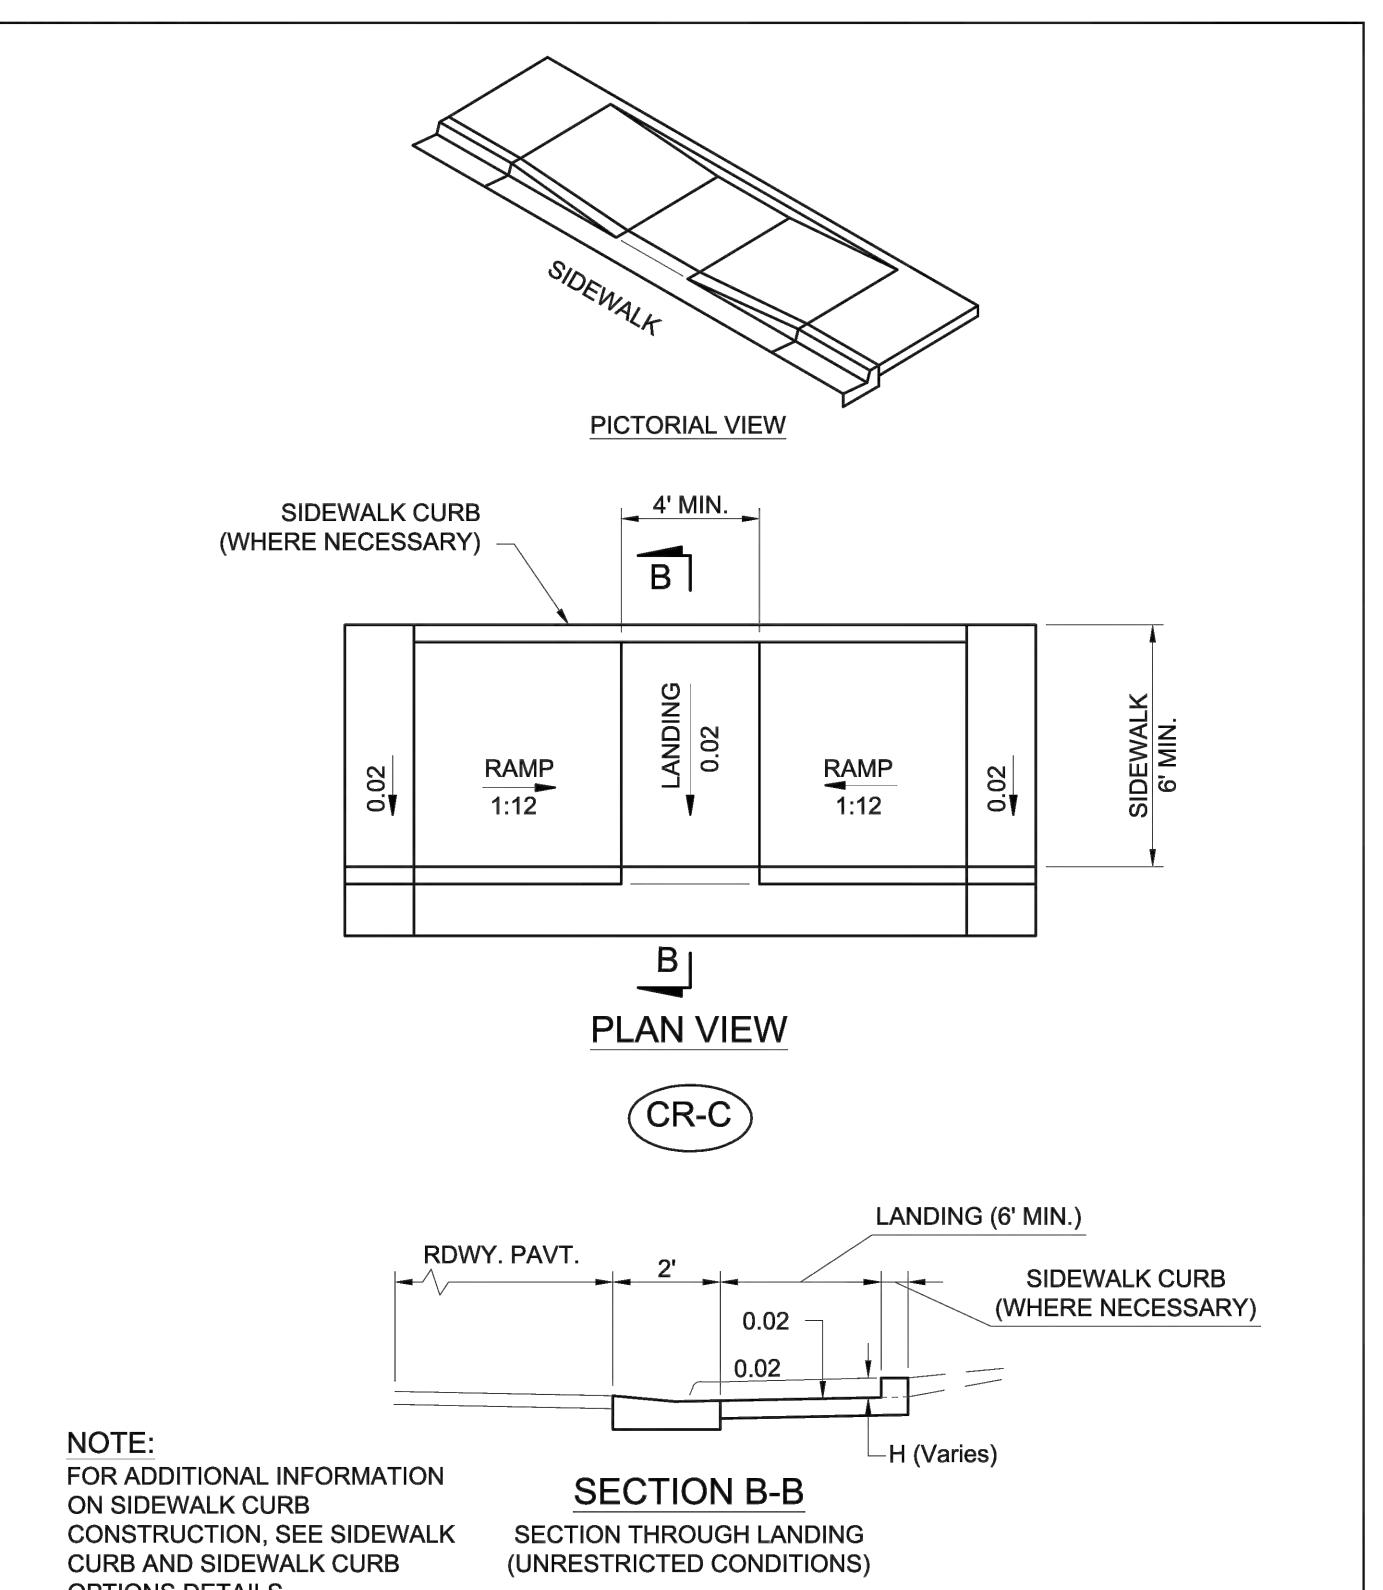


CITY OF FORT LAUDERDALE
PUBLIC WORKS DEPARTMENT
ENGINEERING DETAILS
100 North Andrews Avenue, Fort Lauderdale, Florida 33301

DETECTABLE WARNINGS AND SIDEWALK CURB RAMPS
SHEET 3

ROAD 013

2017/03/11

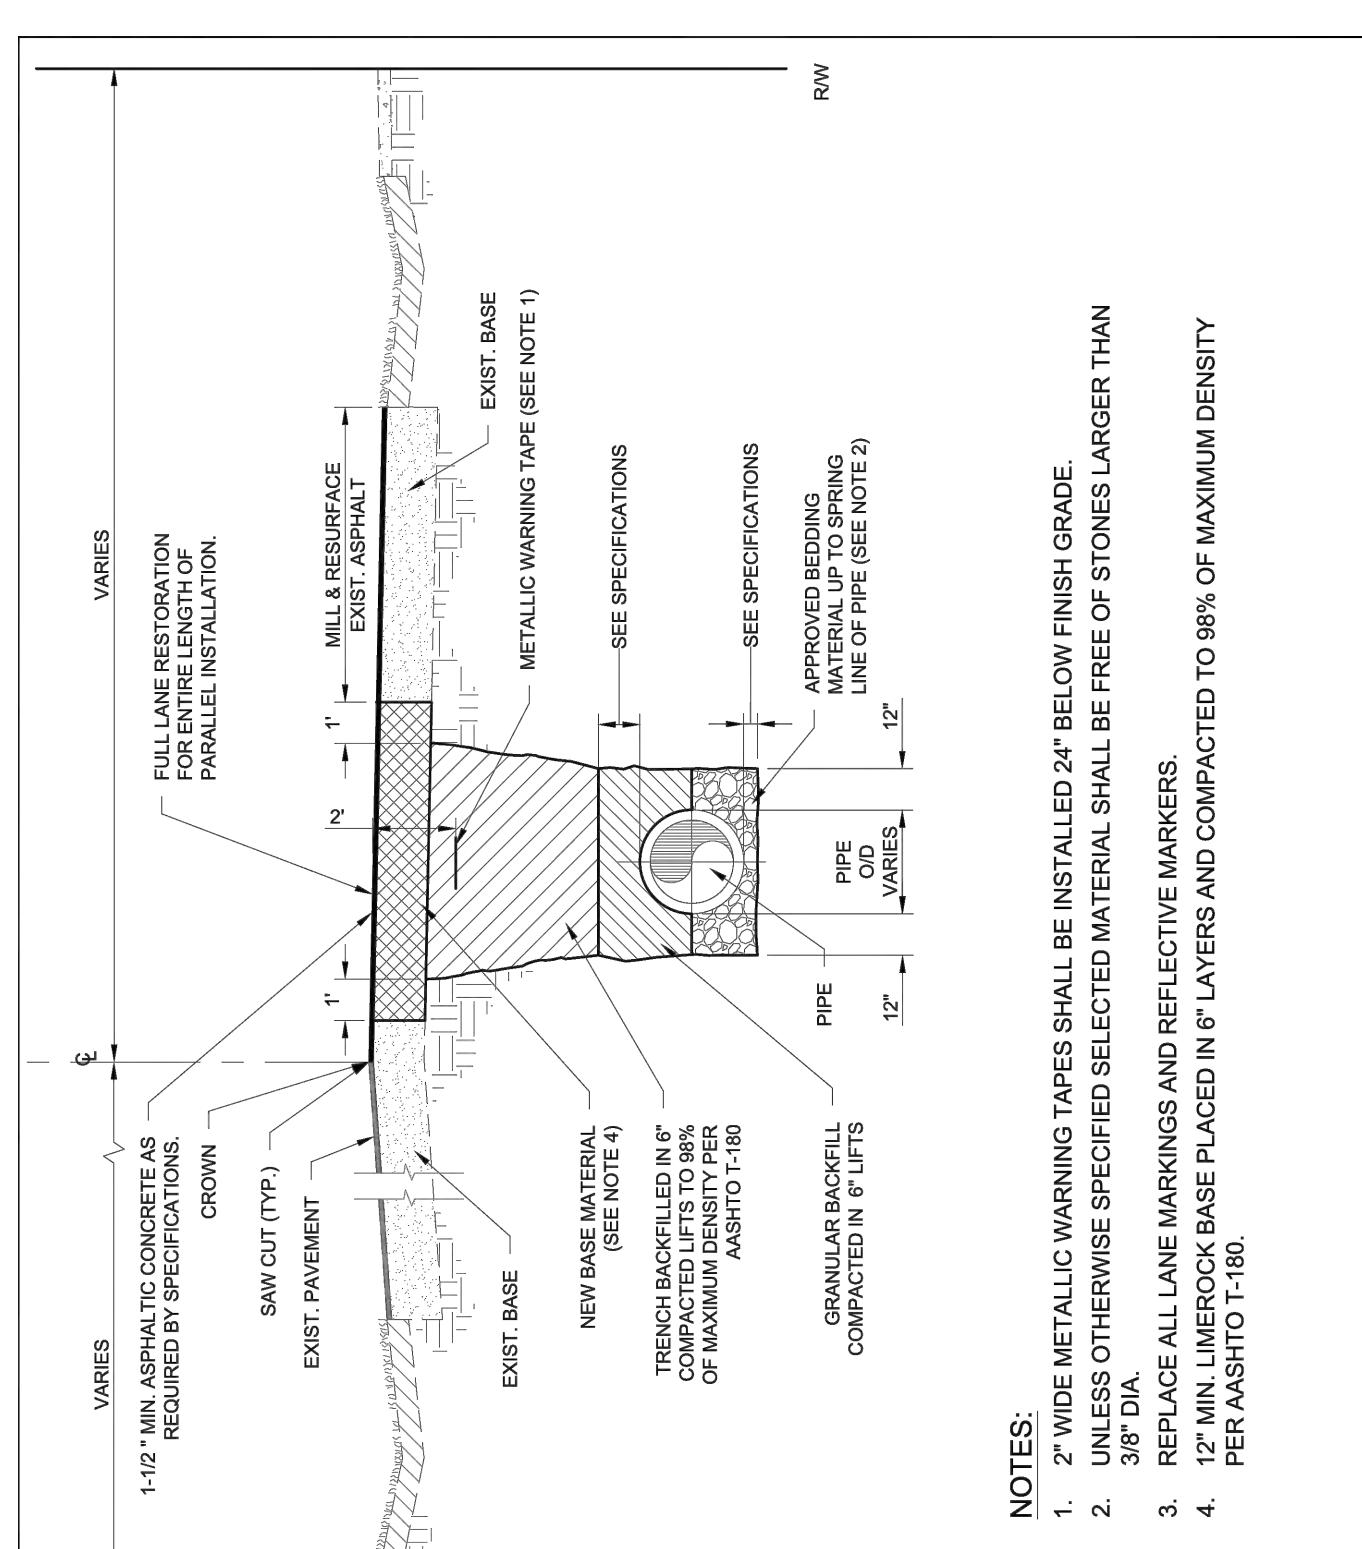


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SIDEWALK CURB RAMPS
SHEET 3

ROAD 016

2017/03/11

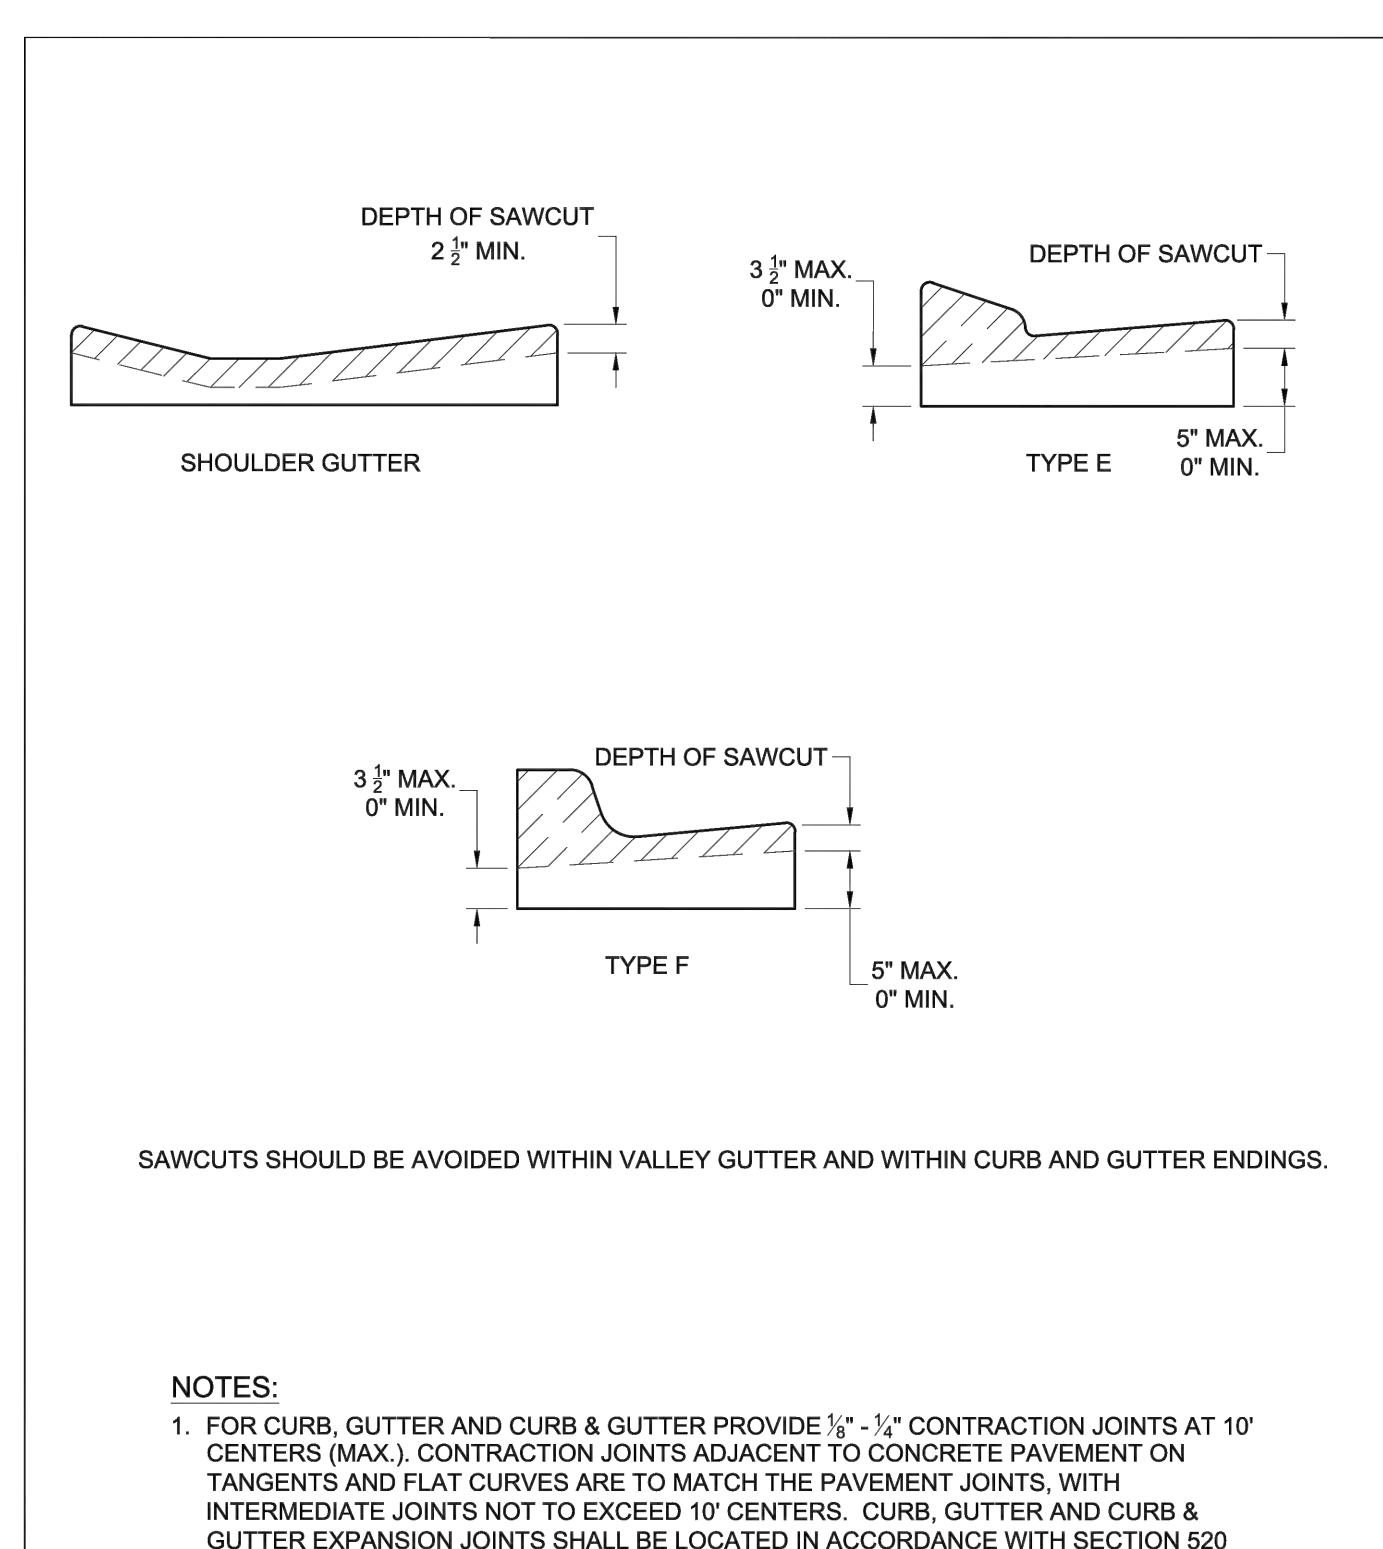


CITY OF FORT LAUDERDALE
PUBLIC WORKS DEPARTMENT
ENGINEERING DETAILS
100 North Andrews Avenue, Fort Lauderdale, Florida 33301

TYPICAL ROAD SECTION, TYPICAL TRENCH AND TRENCH
RESTORATION FOR PARALLEL PIPE TRENCH
SHEET 2

ROAD 002

2017/03/11

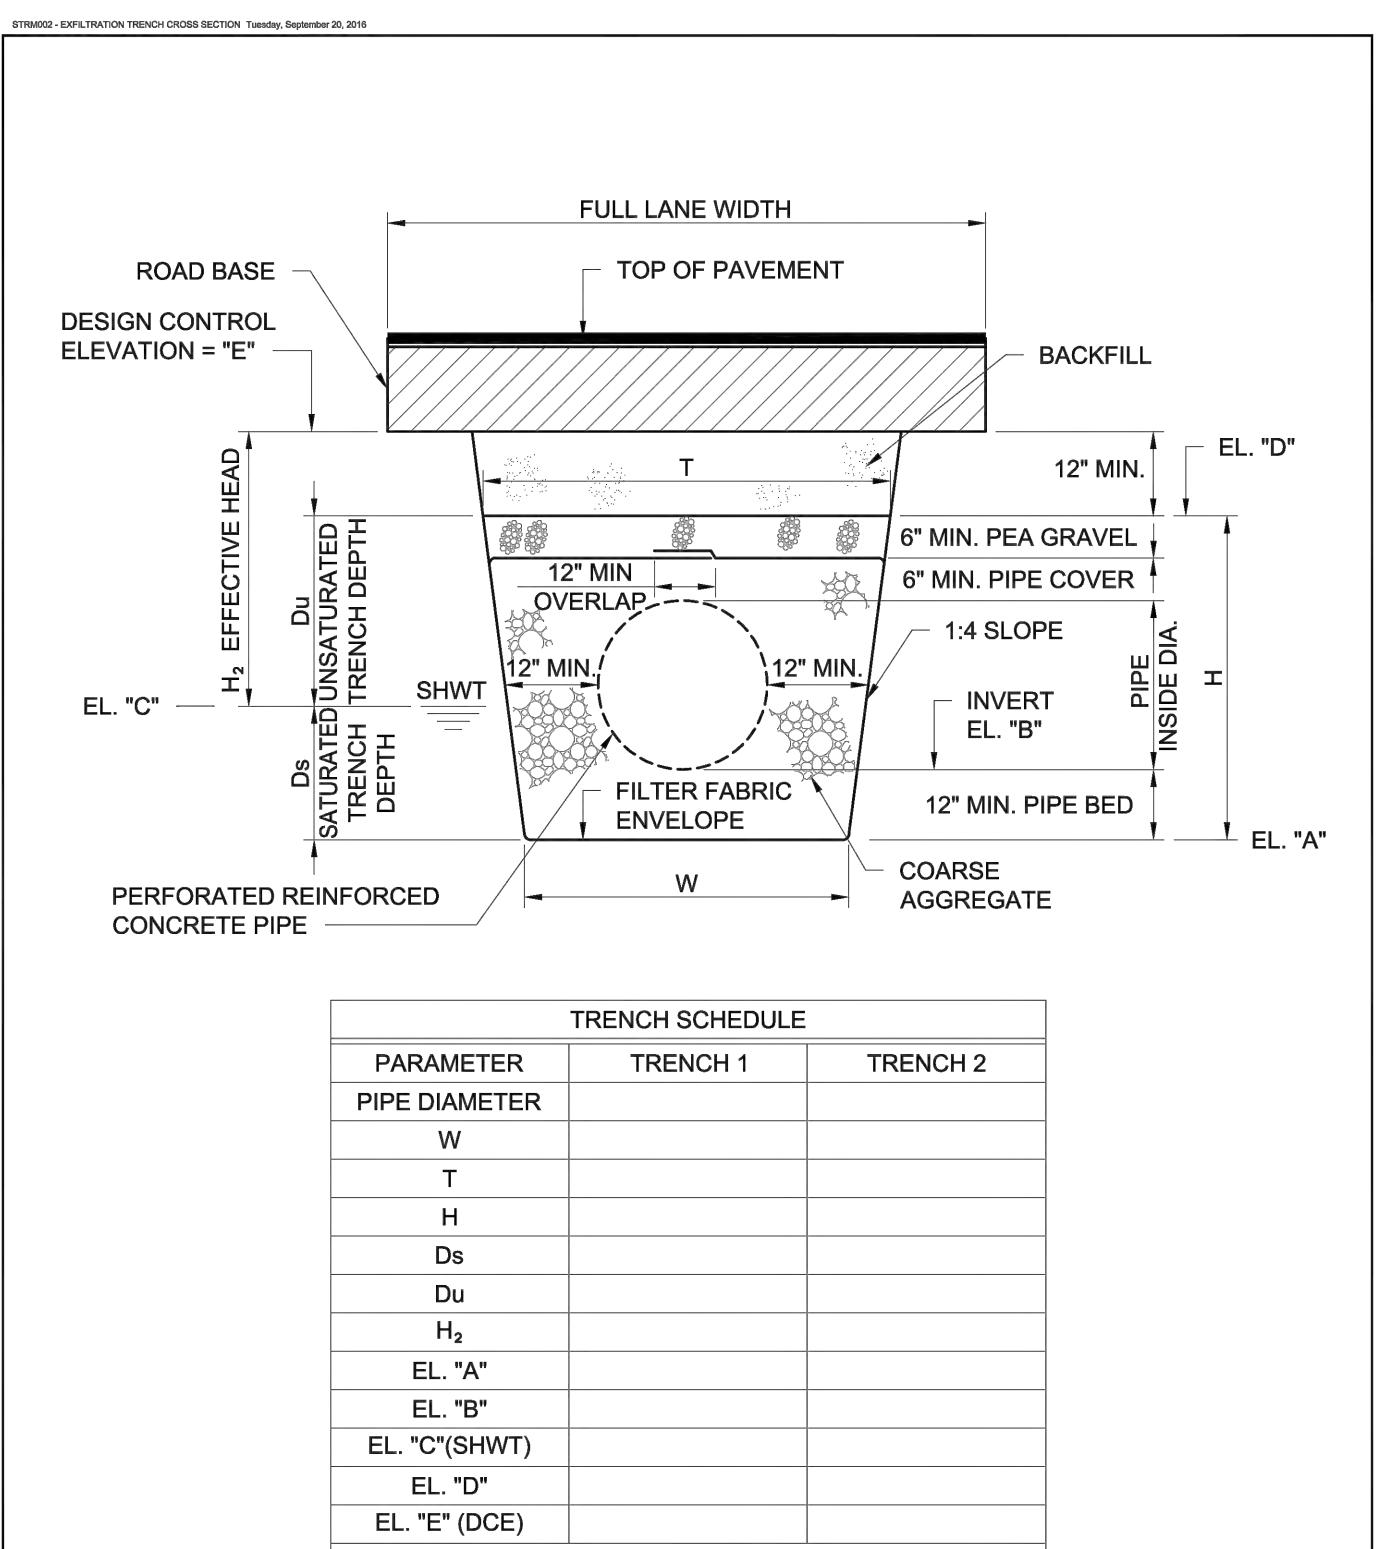


CITY OF FORT LAUDERDALE
PUBLIC WORKS DEPARTMENT
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100 North Andrews Avenue, Fort Lauderdale, Florida 33301

CONCRETE CURB AND GUTTER
CONTRACTION JOINT IN CURB
SHEET 6

ROAD 010

2017/03/11

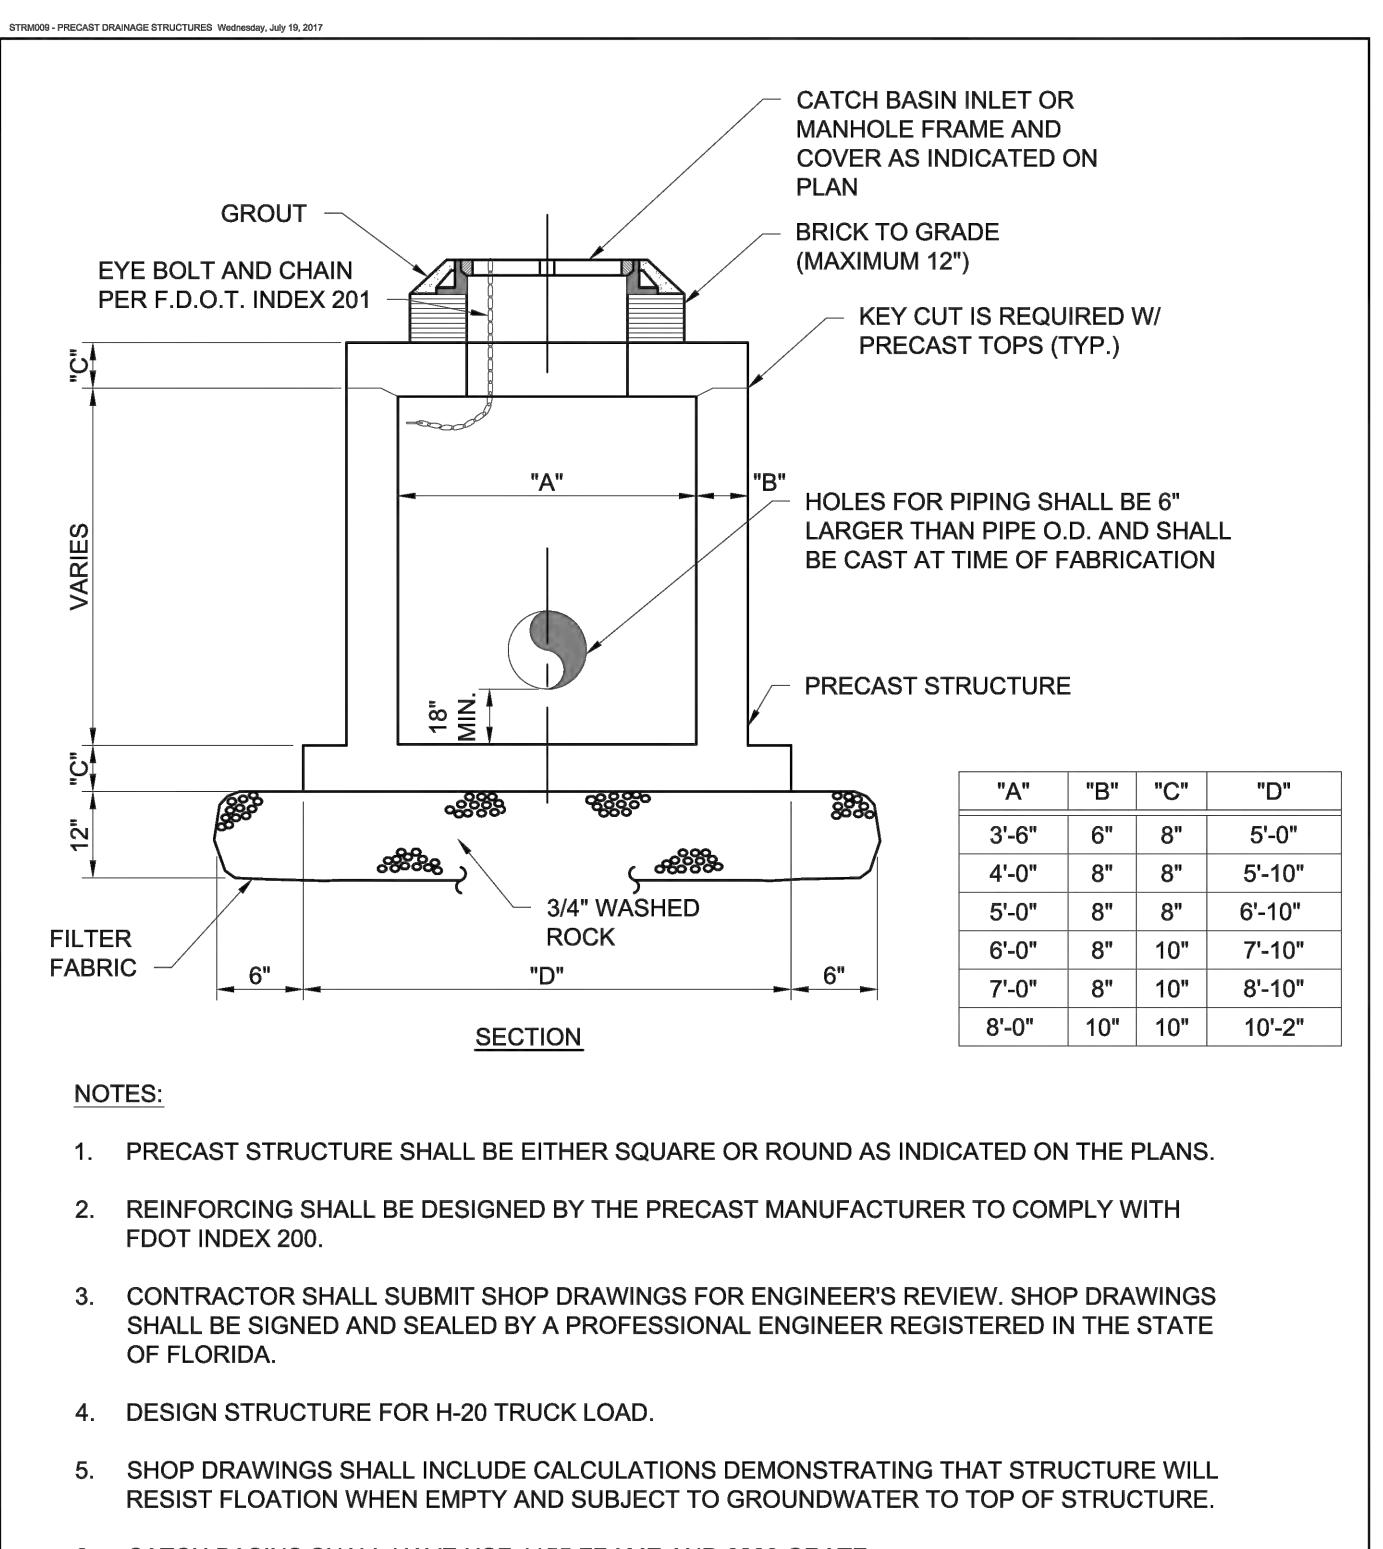


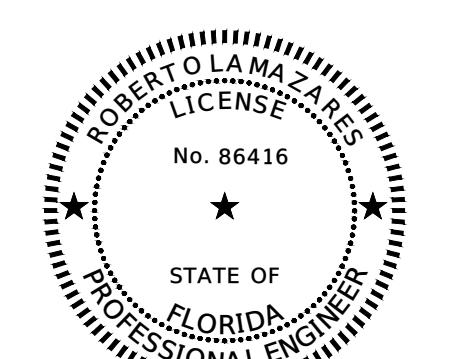
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100 North Andrews Avenue, Fort Lauderdale, Florida 33301

EXFILTRATION TRENCH
CROSS SECTION

STRM 002

2016/09/21





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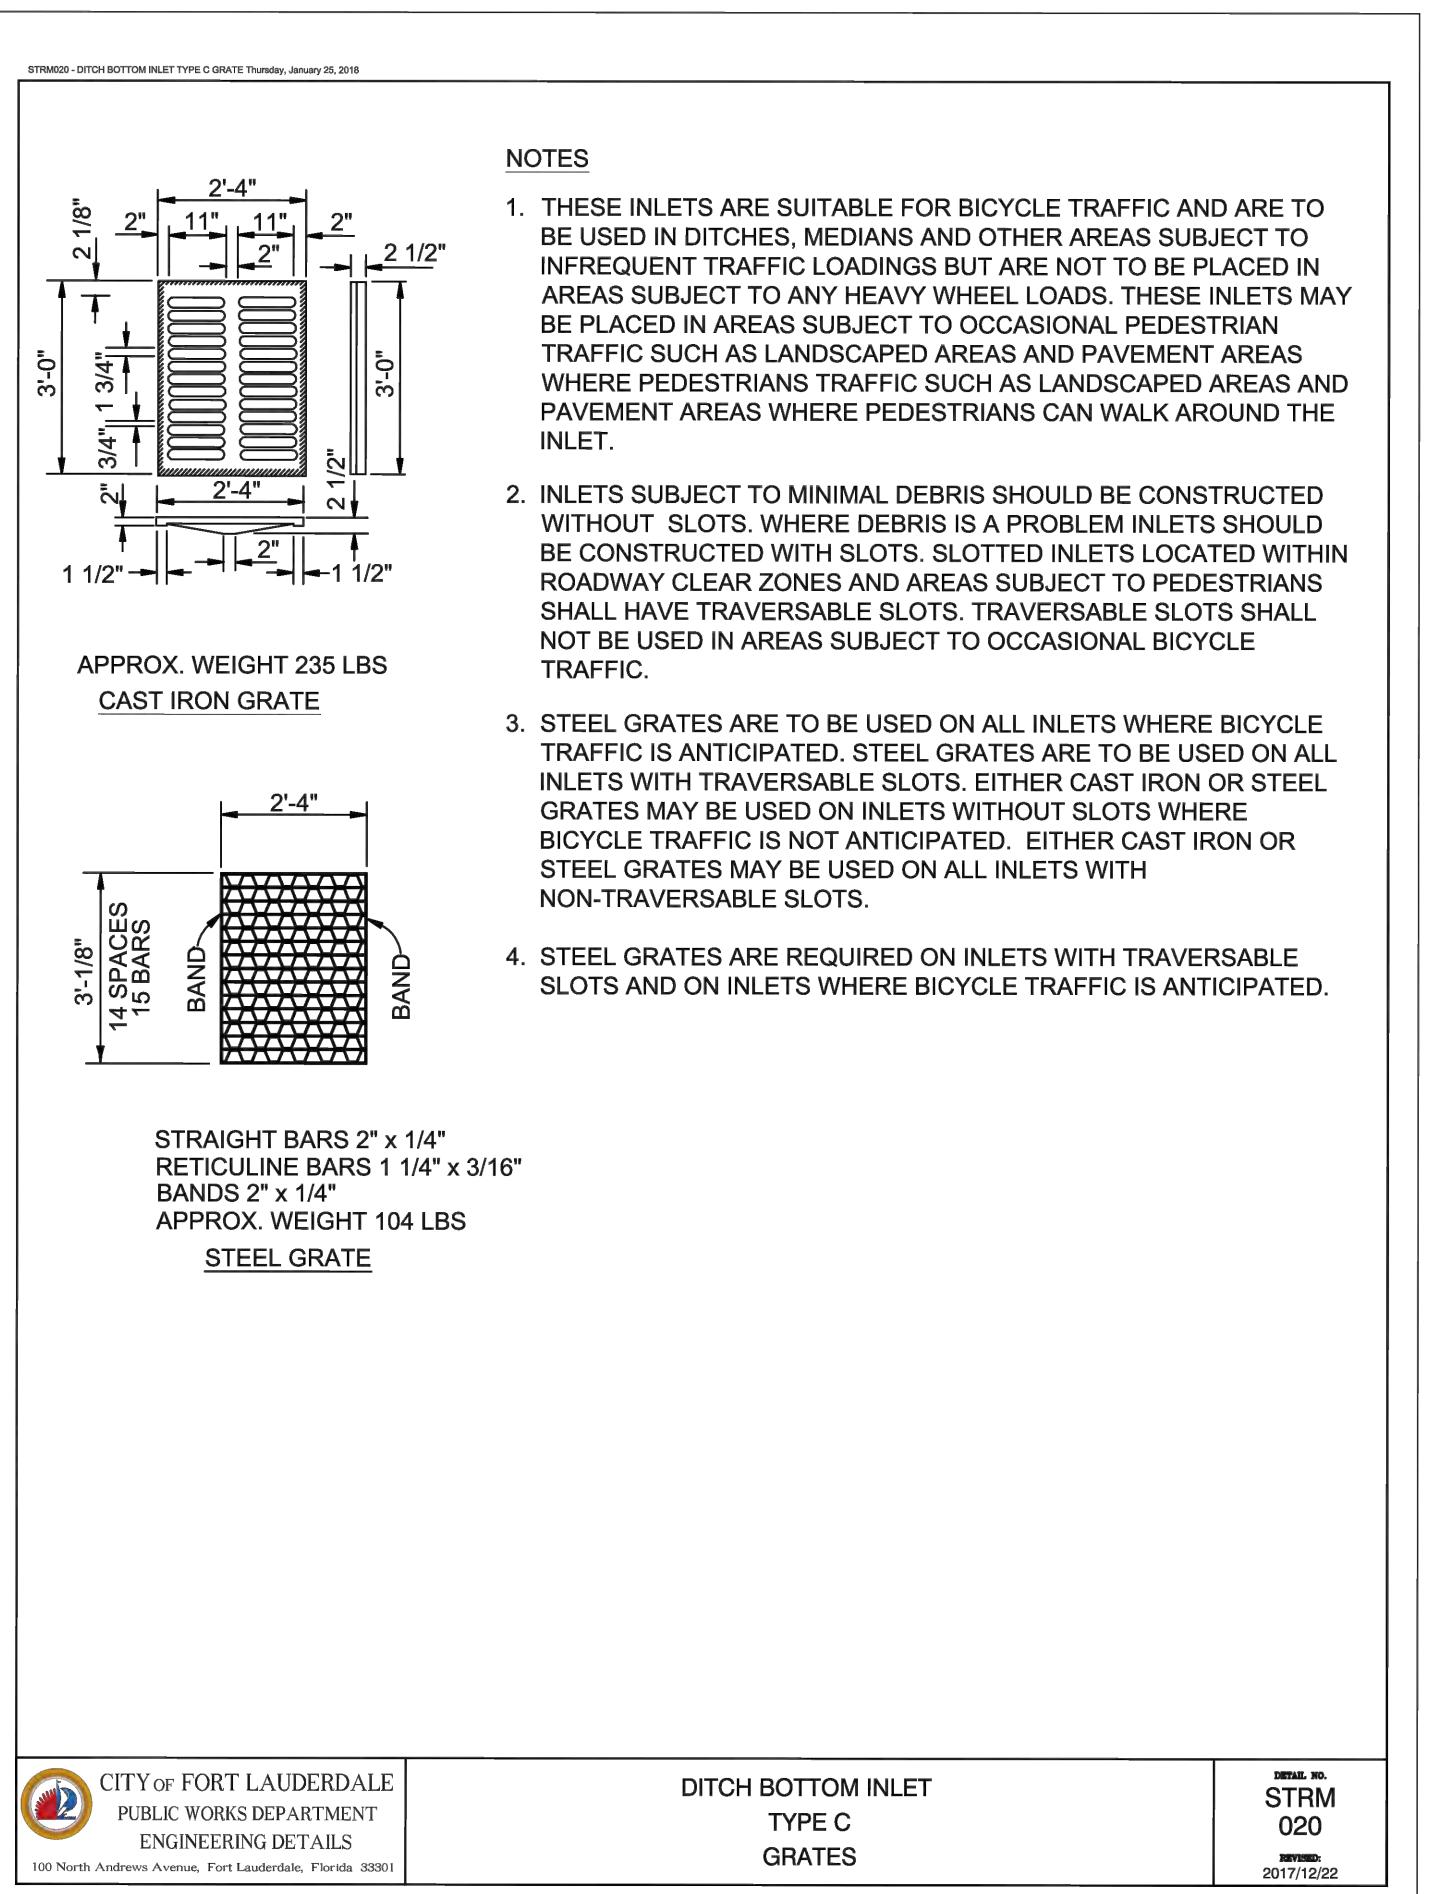
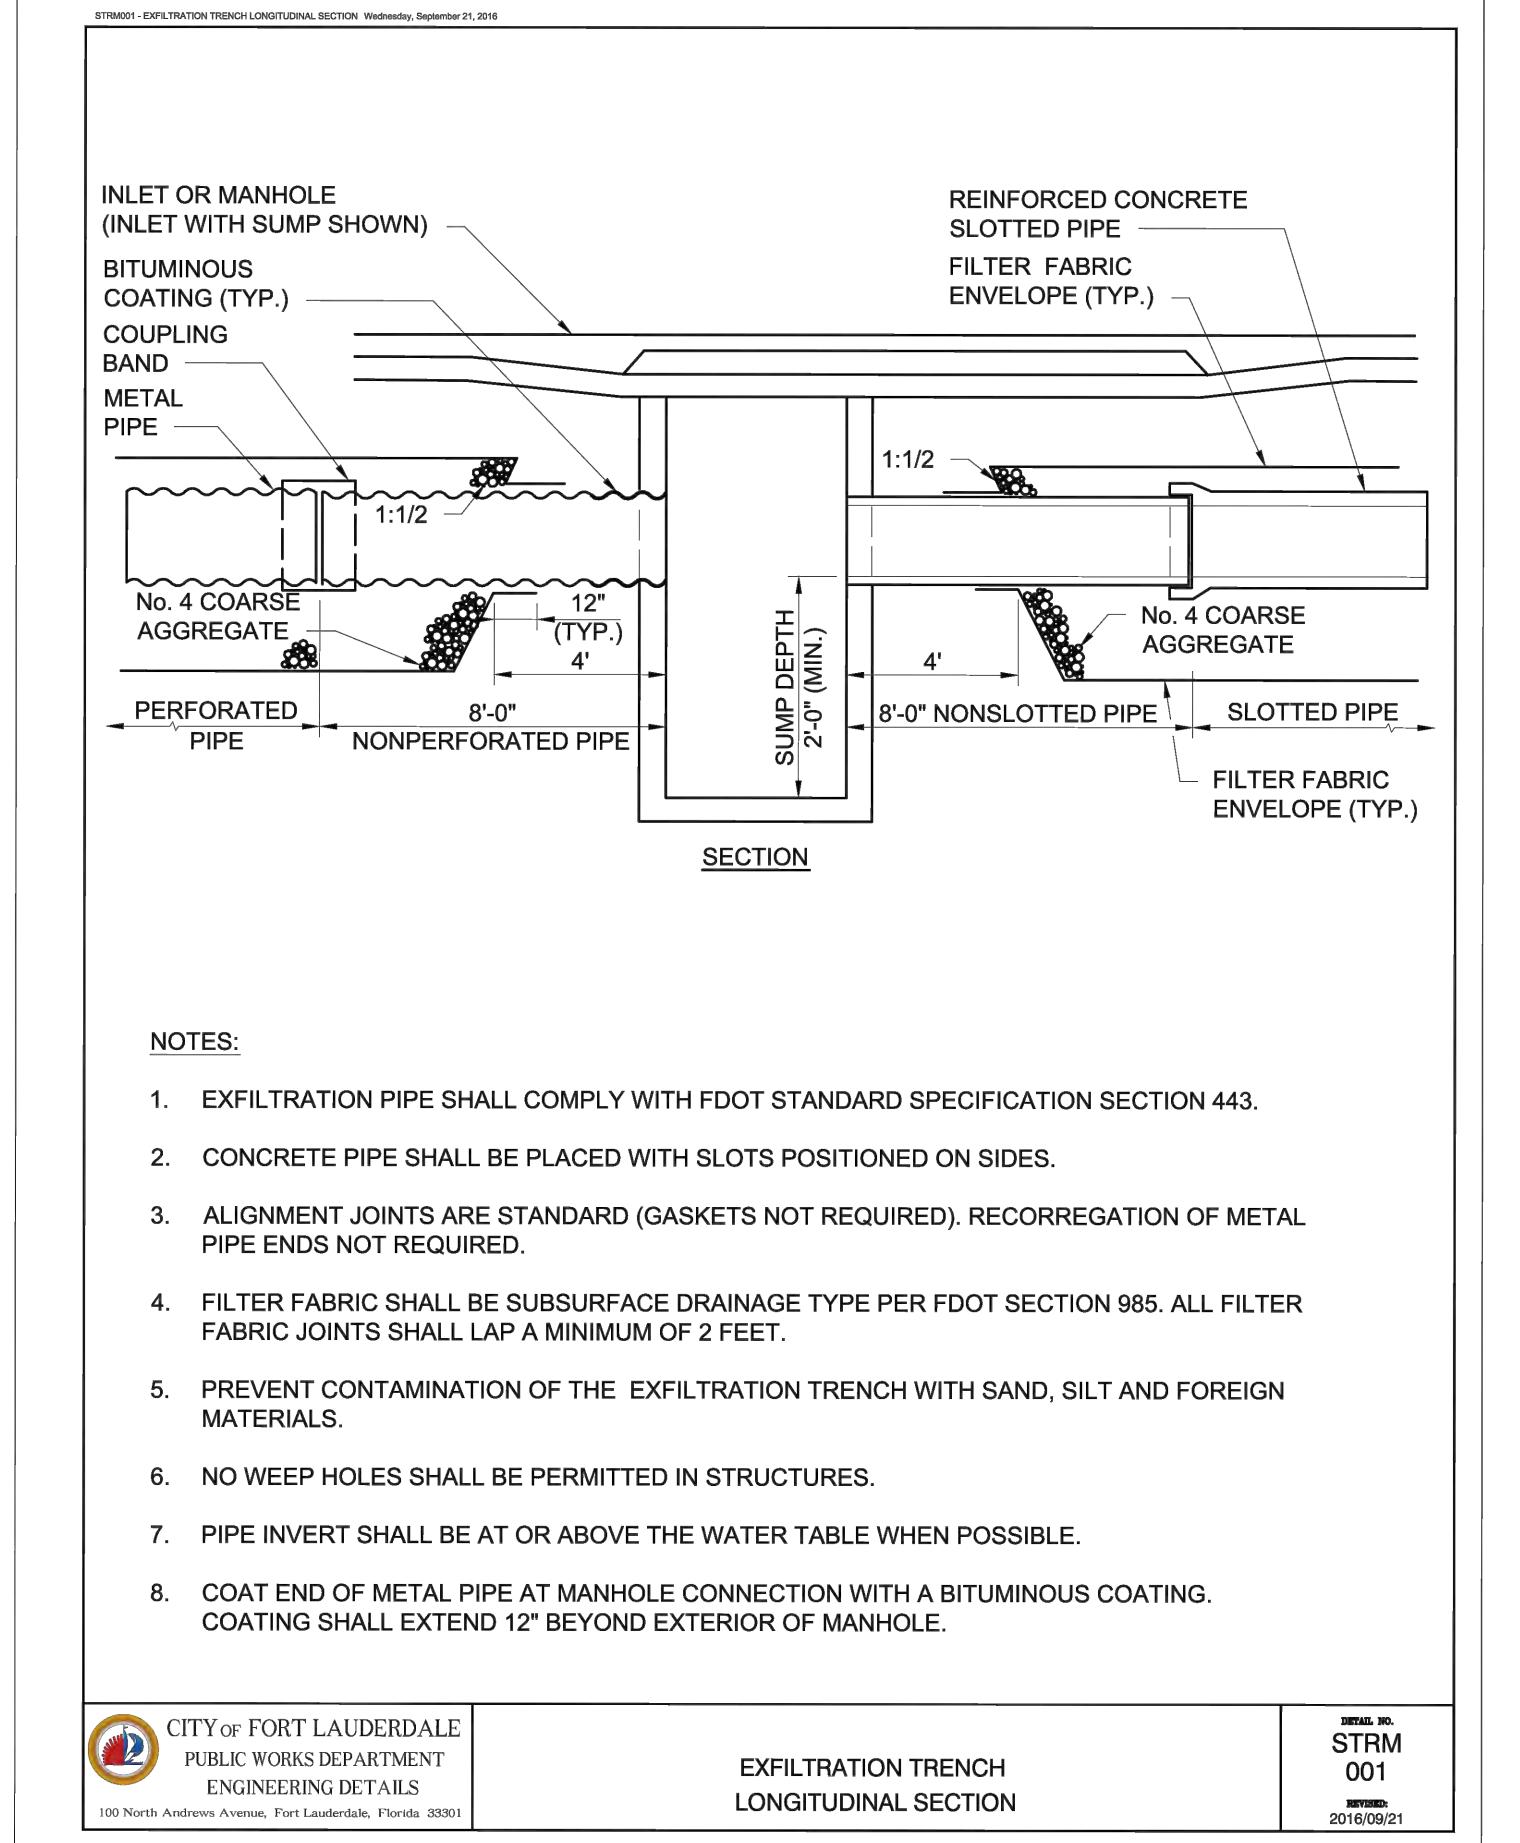
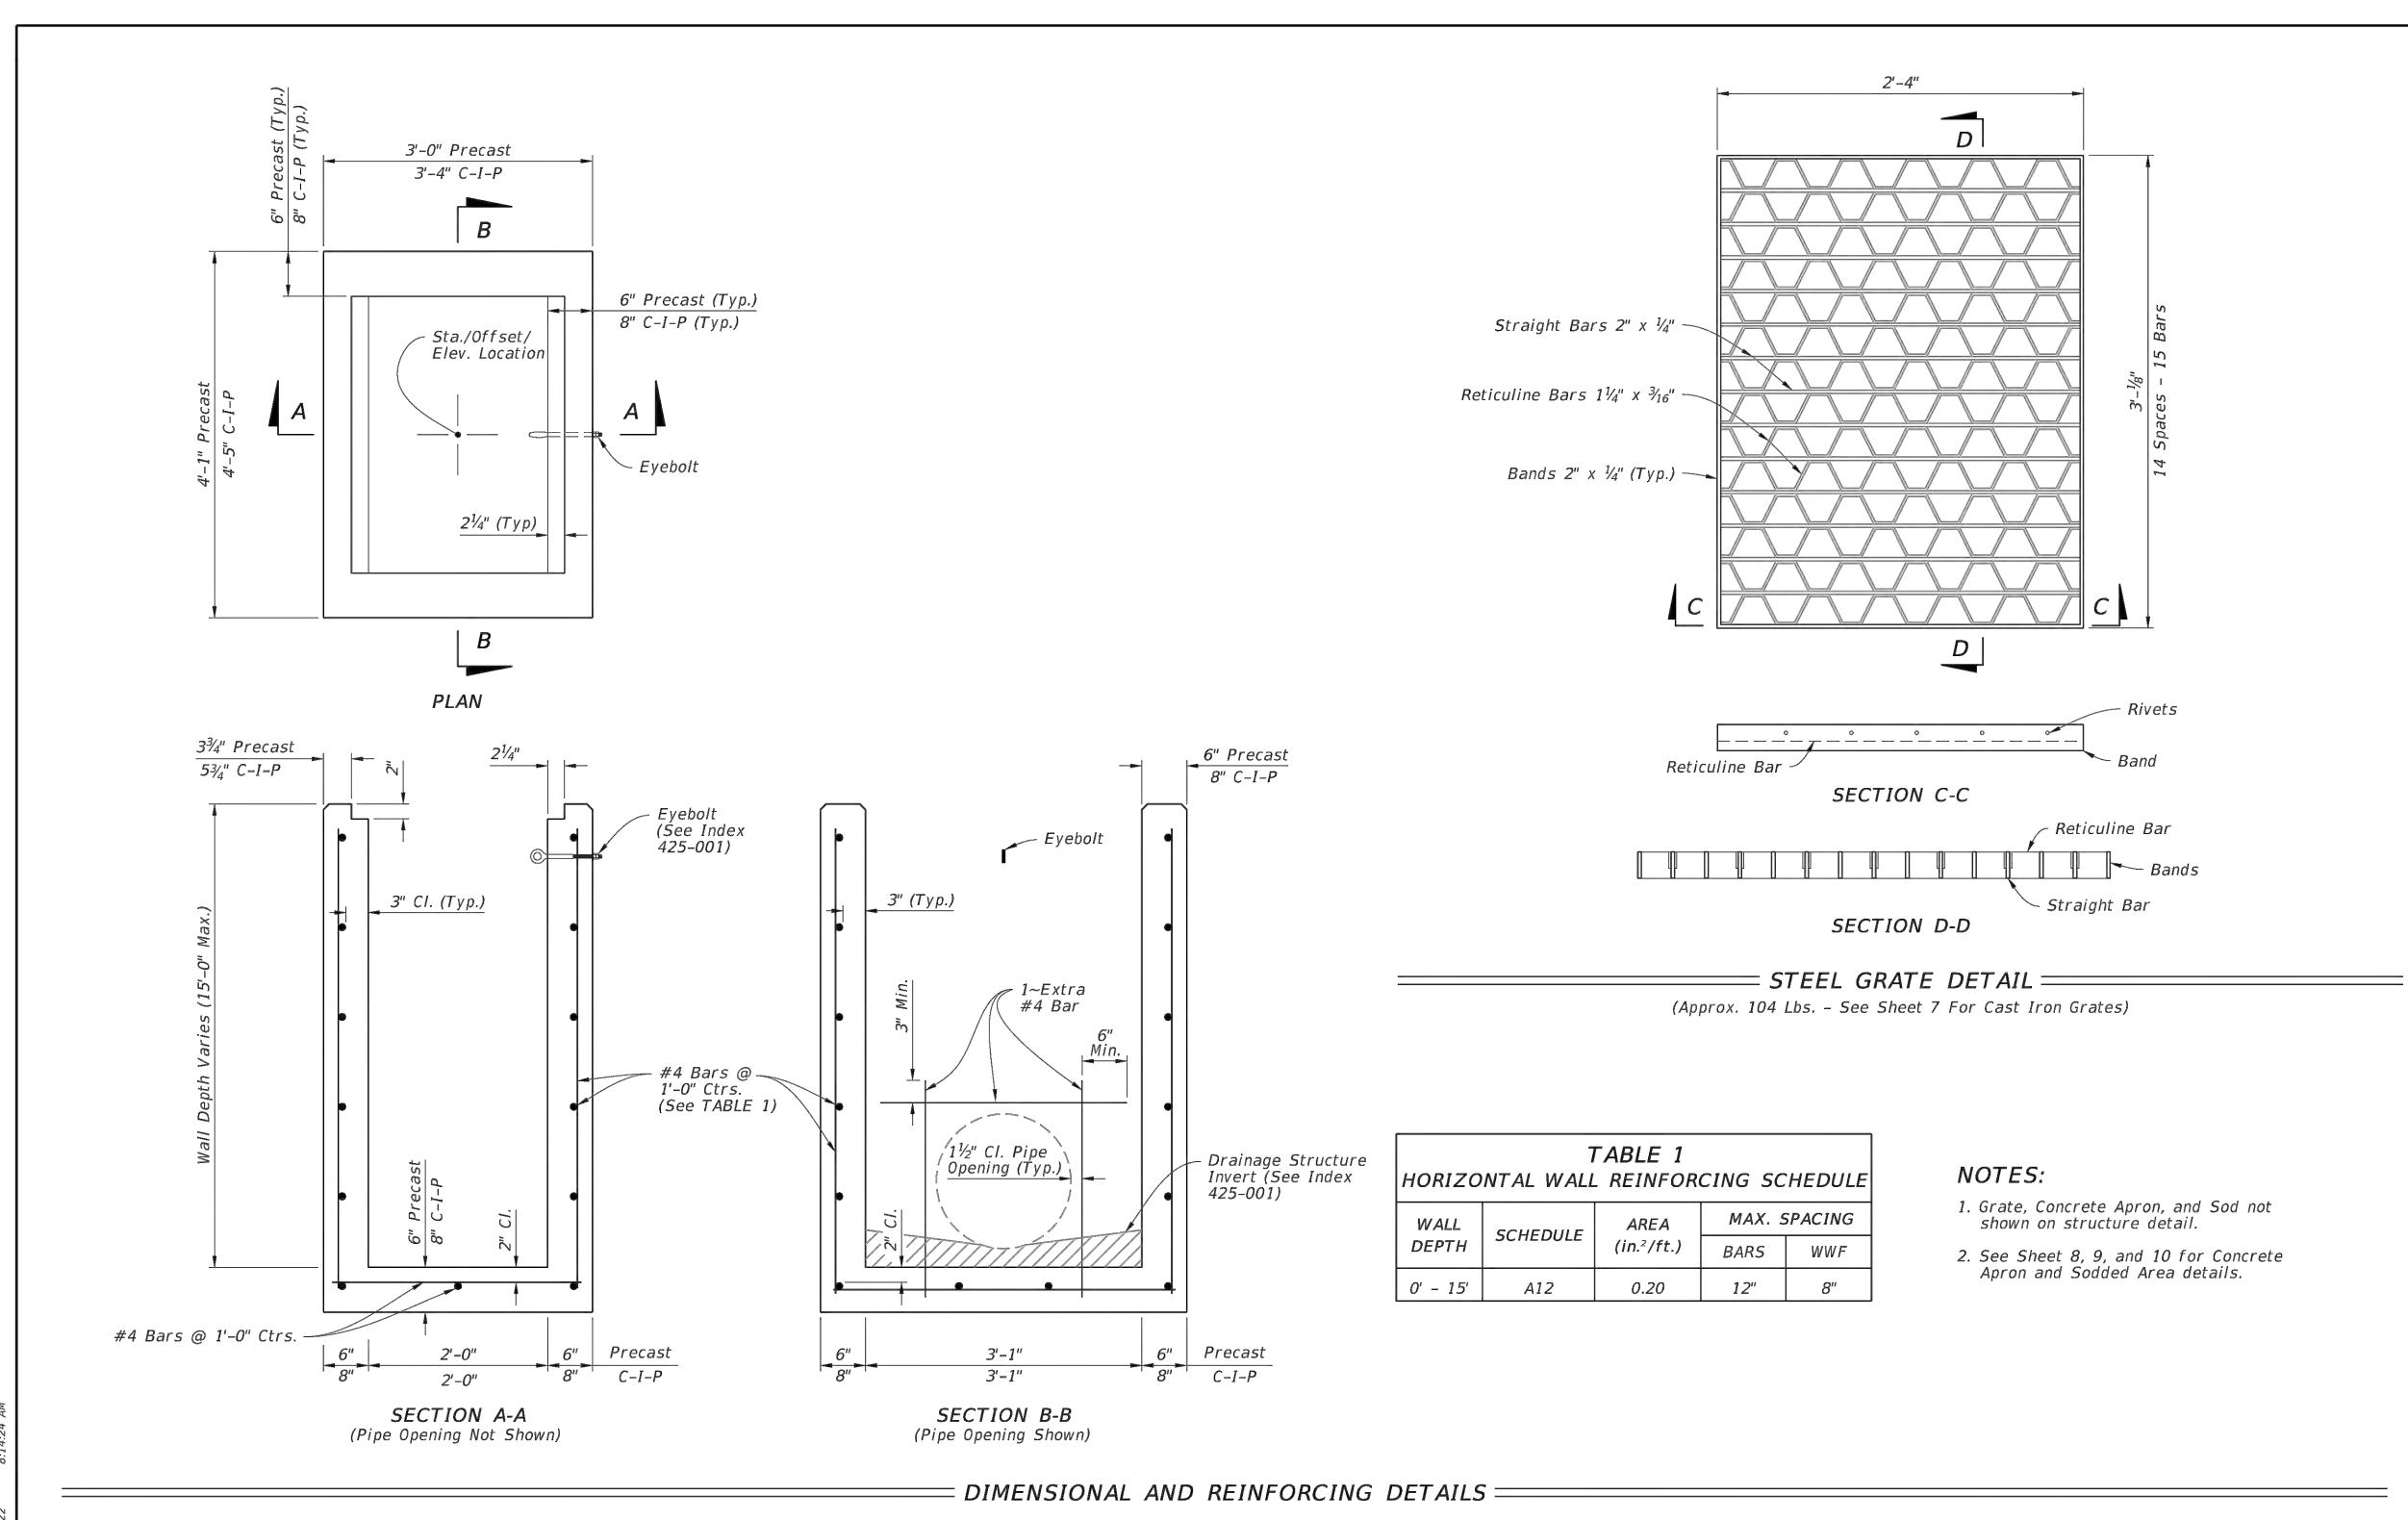
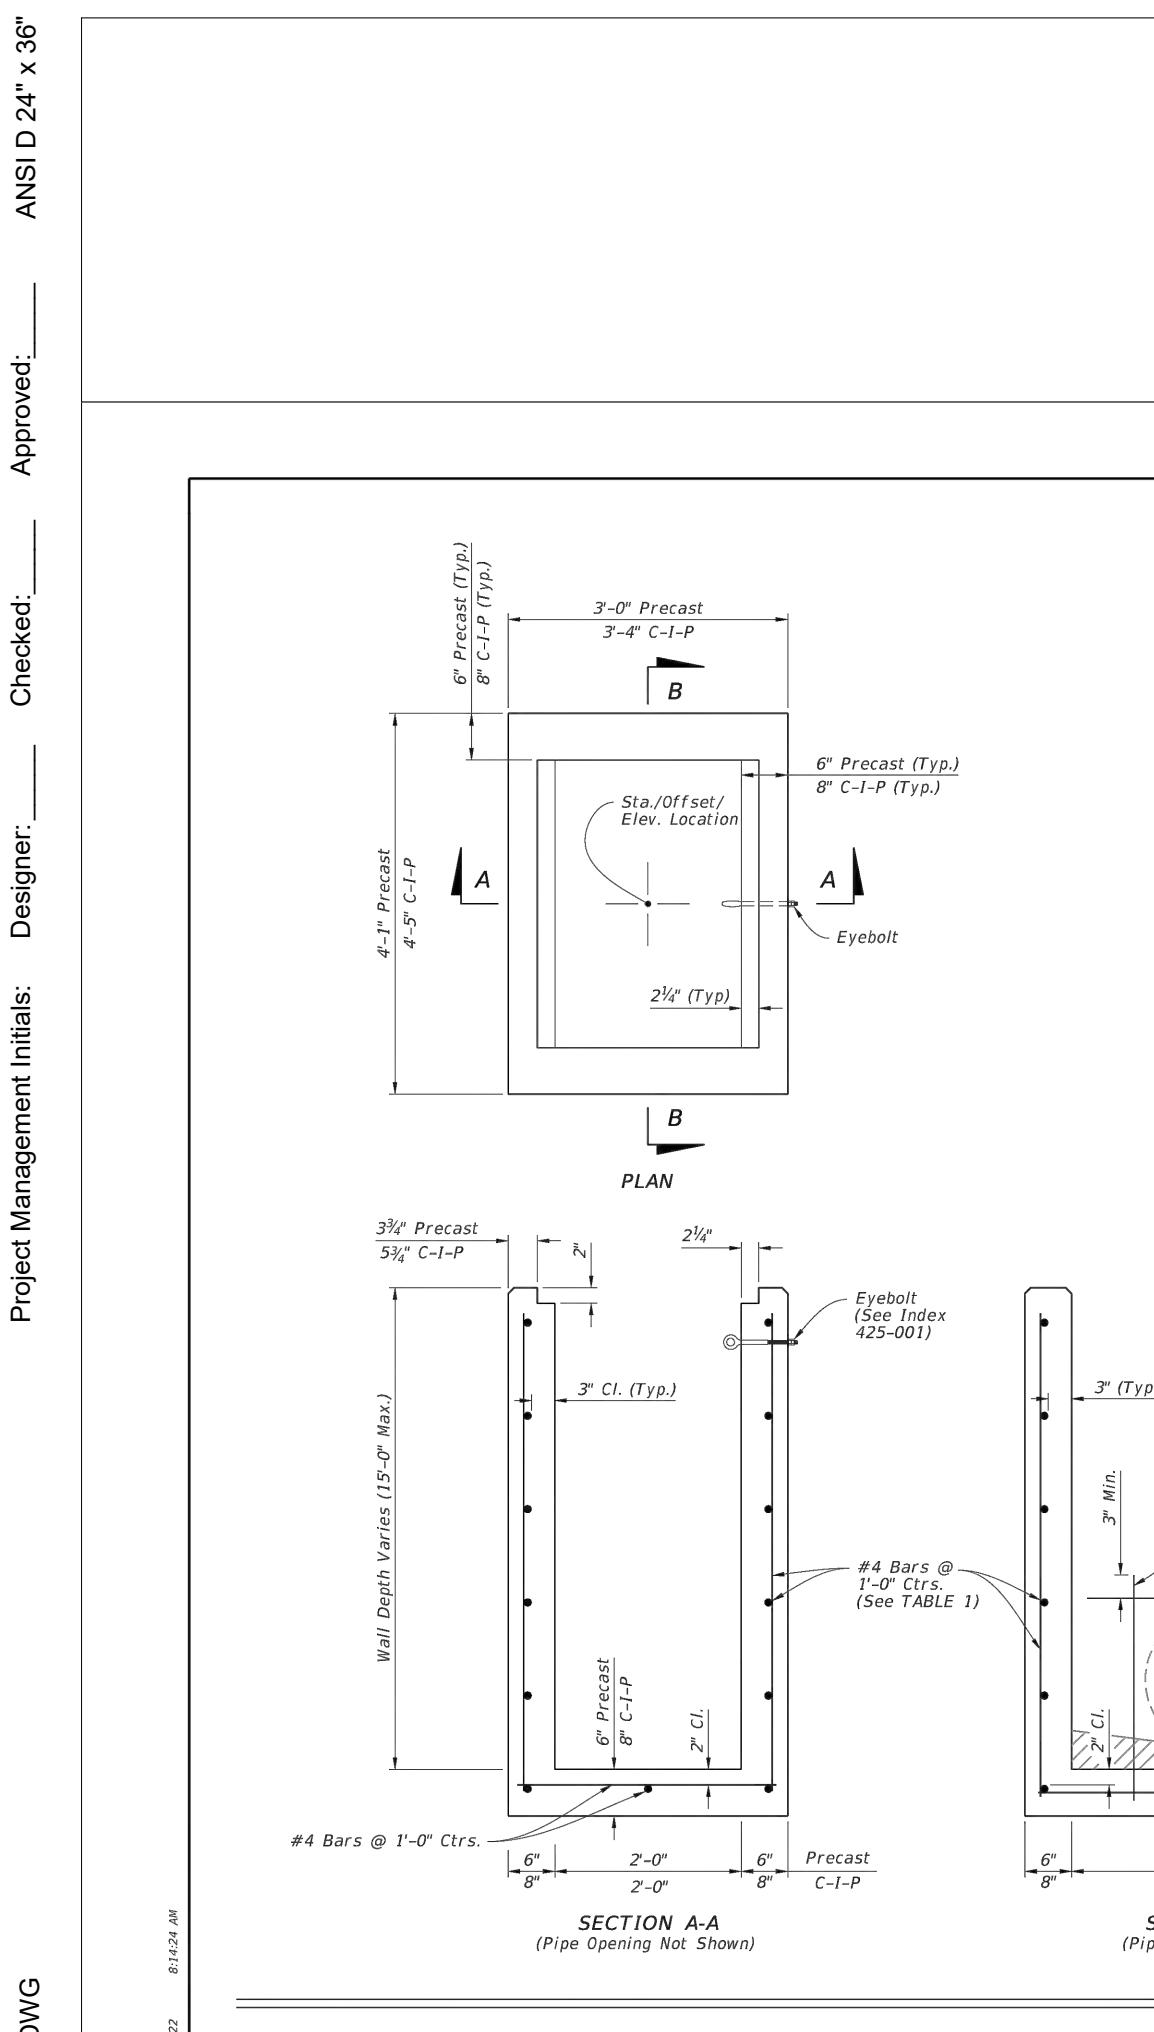
SHEET TITLE

GRADING AND DRAINAGE DETAILS

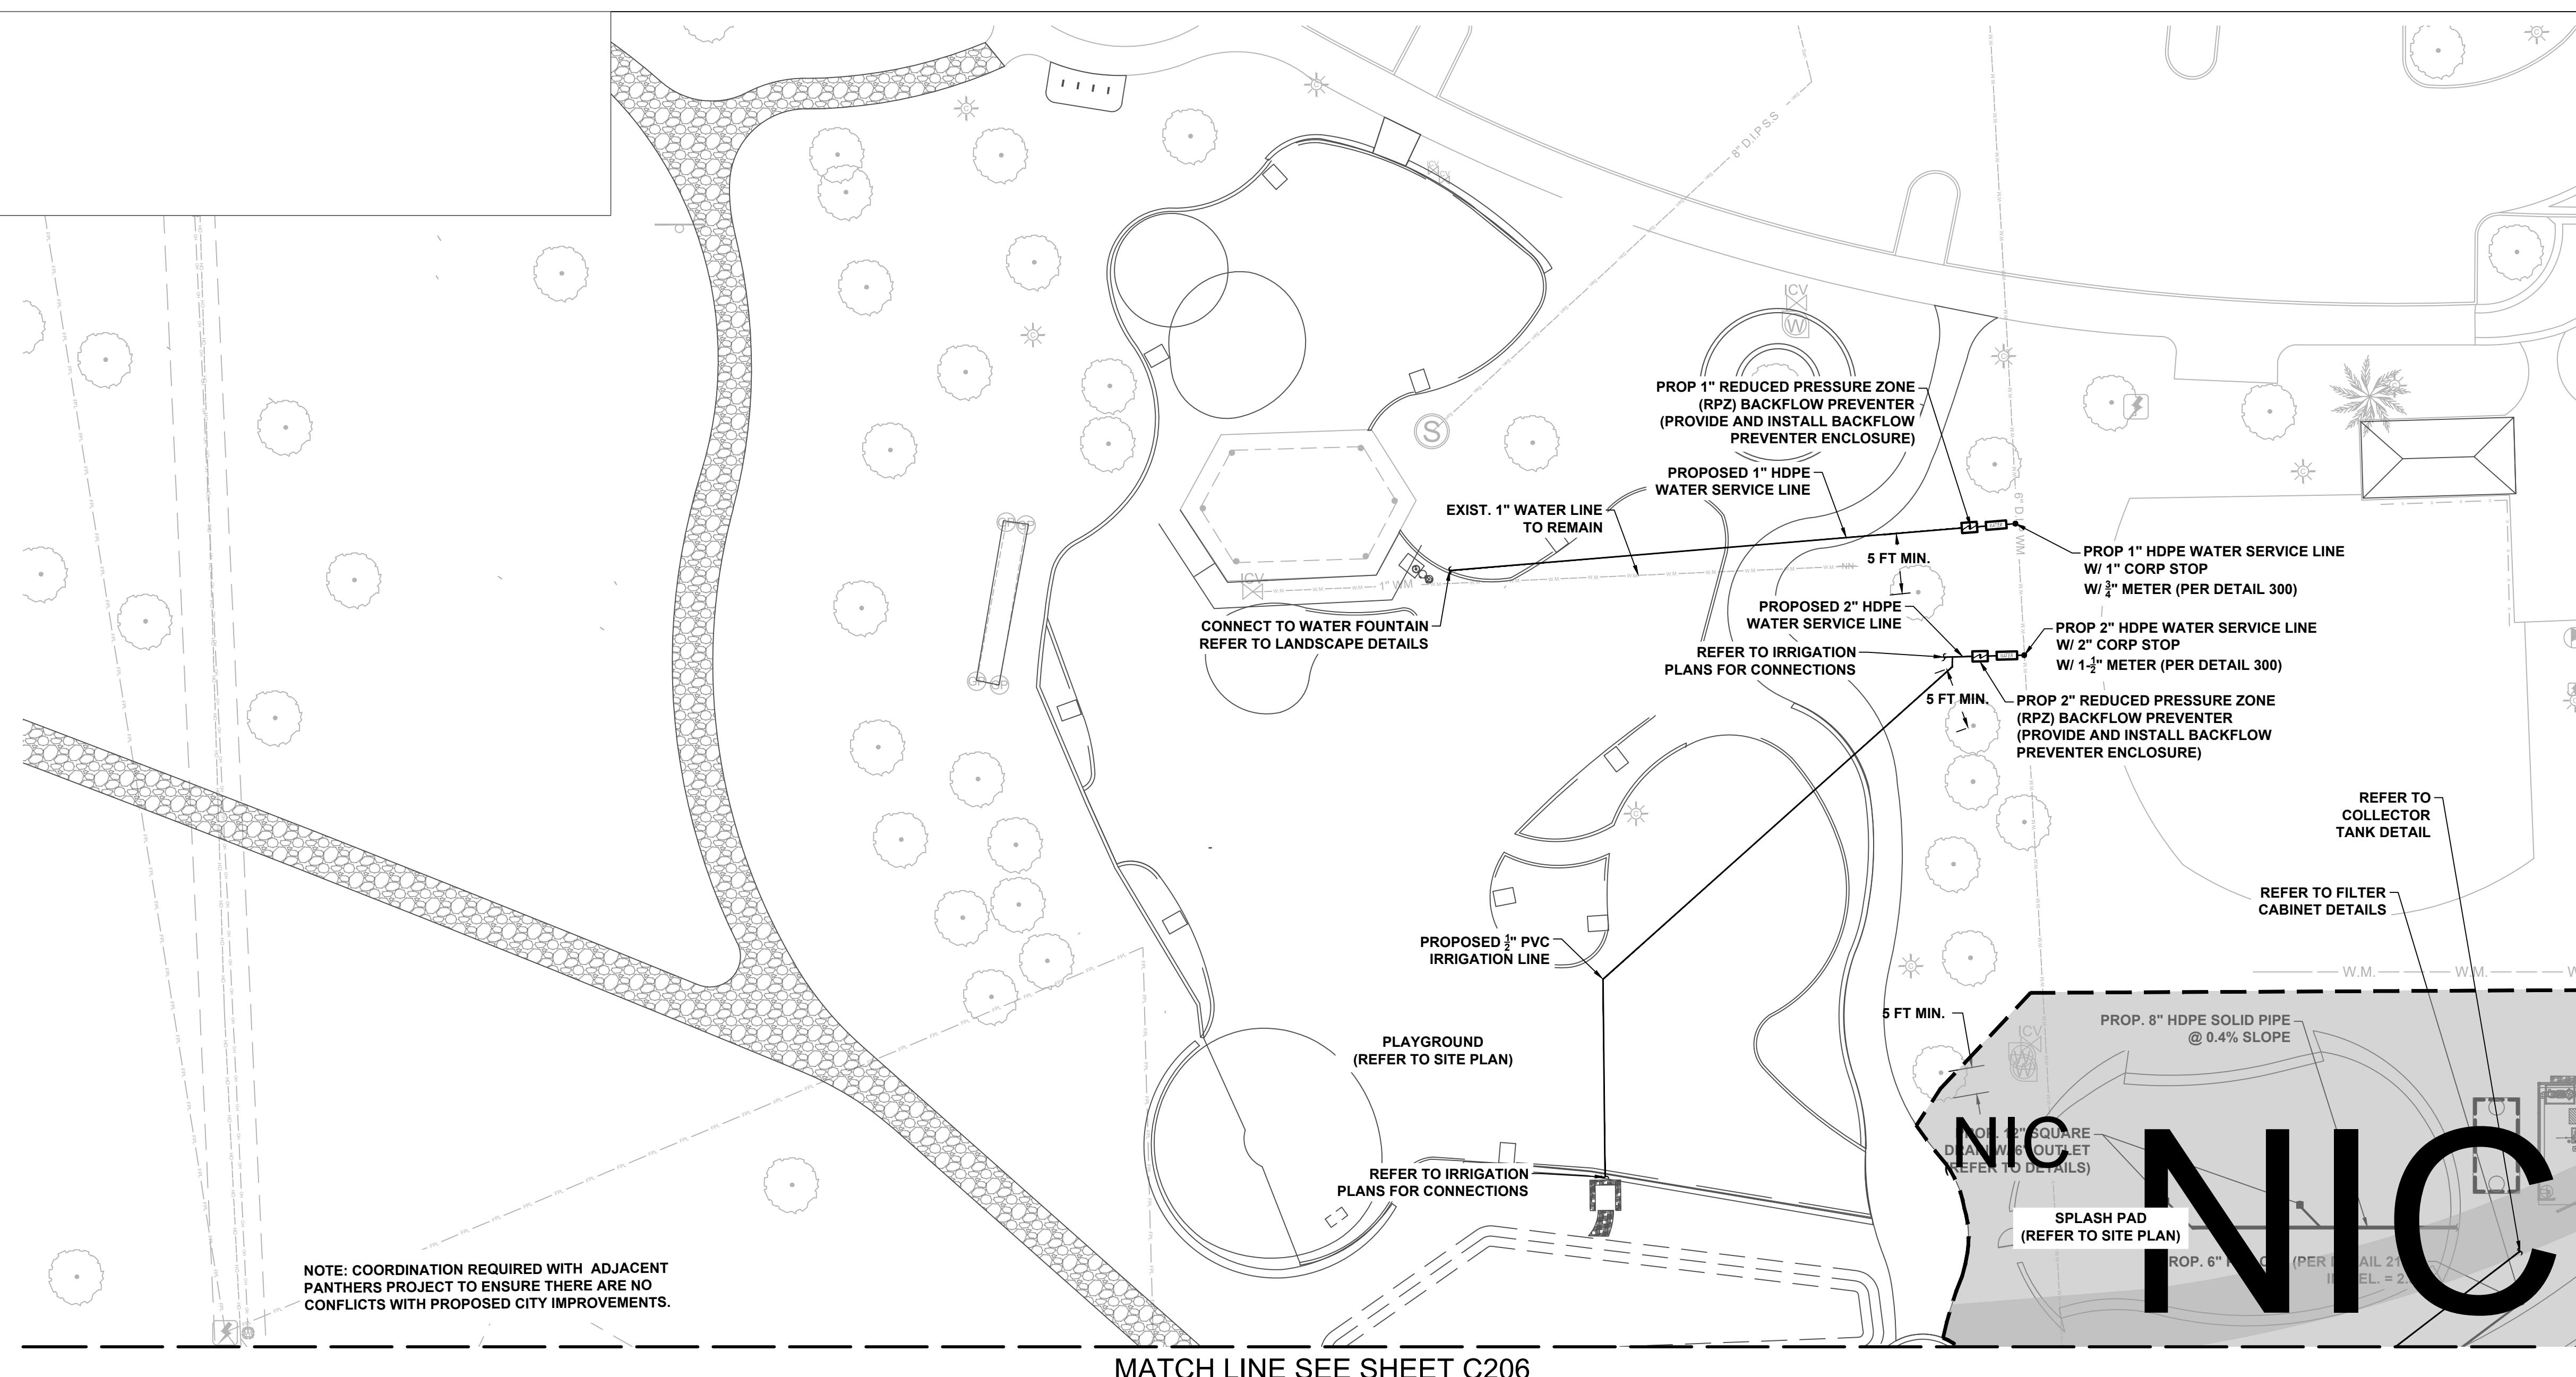
SHEET NUMBER

C121

COORDINATE WITH AECOM ON LATEST ISSUE OF DRAWINGS BEFORE COMMENCEMENT OF CONSTRUCTION
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FRENCH DRAIN TABLE (PLAYGROUND AREA)					
FRENCH DRAIN SECTION	LENGTH OF FD	SIZE (IN)	INVERT ELEV. (NAVD)	TOP OF TRENCH ELEV. (NAVD)	BOTTOM OF TRENCH ELEV.
SD-10 TO SD-11	72				
SD-12 TO SD-13	53				
SD-13 TO SD-14	66				
SD-15 TO SD-16	36				
SD-17 TO END	60				



PROJECT

HOLIDAY PARK
FORT LAUDERDALE
PARKS BOND PROGRAM

CLIENT

PARKS &
RECREATION
City of Fort Lauderdale

PRIME CONSULTANT

AECOM
7650 W. COURTNEY CAMPBELL CAUSEWAY
SUITE 700
TAMPA, FL 33607
813.286.1711 tel 813.287.8591 fax
www.aecom.com

SUB-CONSULTANT

CIVIL
BCC ENGINEERING
305.670.2350 tel
www.bcceng.com

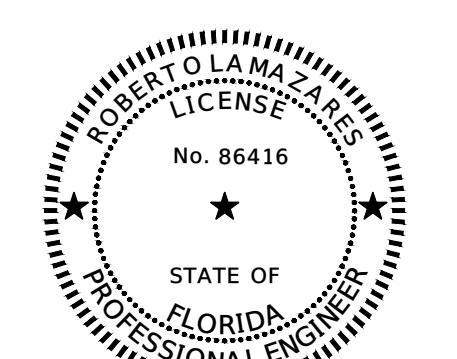
LANDSCAPE
CURTIS + ROGERS DESIGN STUDIO
305.442.1774 tel
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GEOSOL, INC.
305.828.4367 tel
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MECHANICAL, PLUMBING AND FIRE PROTECTION
HAMMOND AND ASSOCIATES CONSULTING
954.327.7111 tel
www.harmondeengineers.com

REGISTRATION



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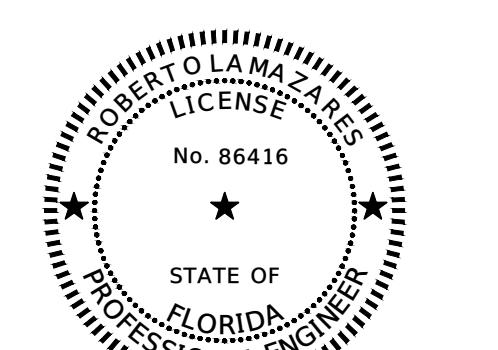
P12633

SHEET TITLE

UTILITY PLAN

SHEET NUMBER

C204



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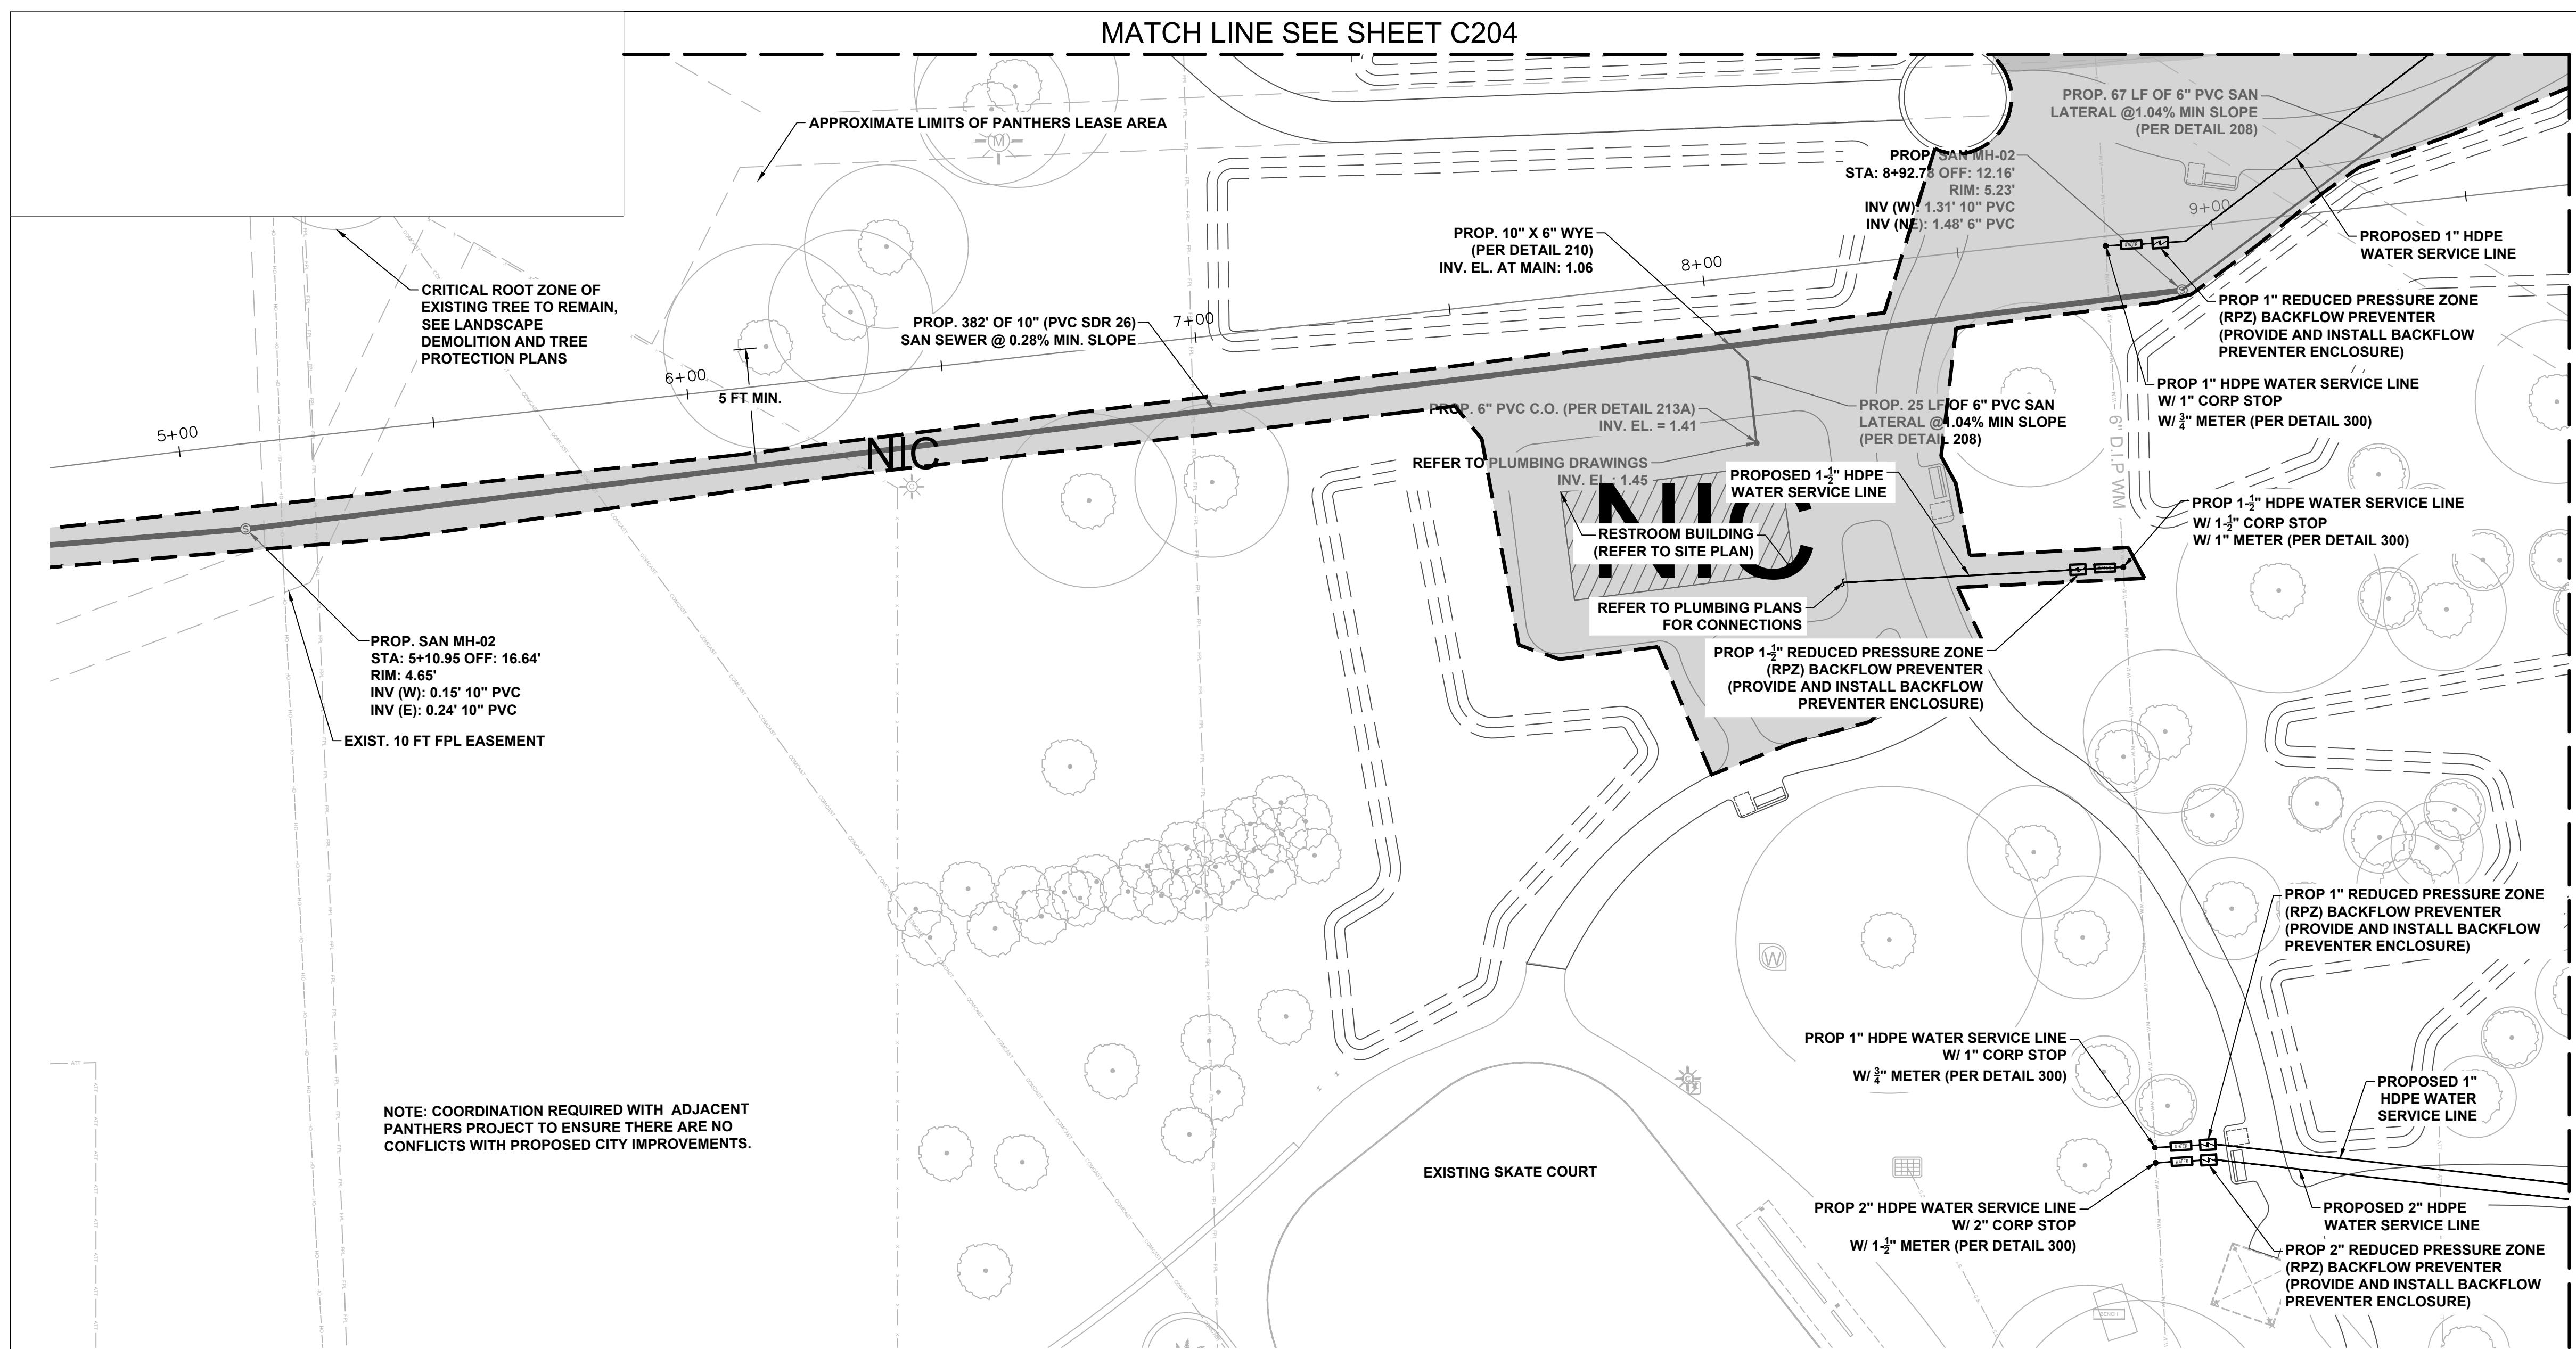
ISSUE/REVISION	
06/24/2025	PHASE 2 BID DOCUMENTS
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	DESCRIPTION

PROJECT NUMBER
P12633

SHEET TITLE
UTILITY PLAN

SHEET NUMBER
C206

COORDINATE WITH AECOM ON LATEST ISSUE OF DRAWINGS BEFORE COMMENCEMENT OF CONSTRUCTION
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LEGEND

- OHW EXISTING ELECTRIC LINE TO REMAIN
- W(C) EXISTING POTABLE WATER LINE TO REMAIN
- EXISTING STORM LINE TO REMAIN
- EXISTING STORM STRUCTURE TO REMAIN
- S(C) EXISTING SANITARY SEWER TO REMAIN
- EXISTING IRRIGATION LINE TO REMAIN
- BE(C) EXISTING BURIED ELECTRIC TO REMAIN

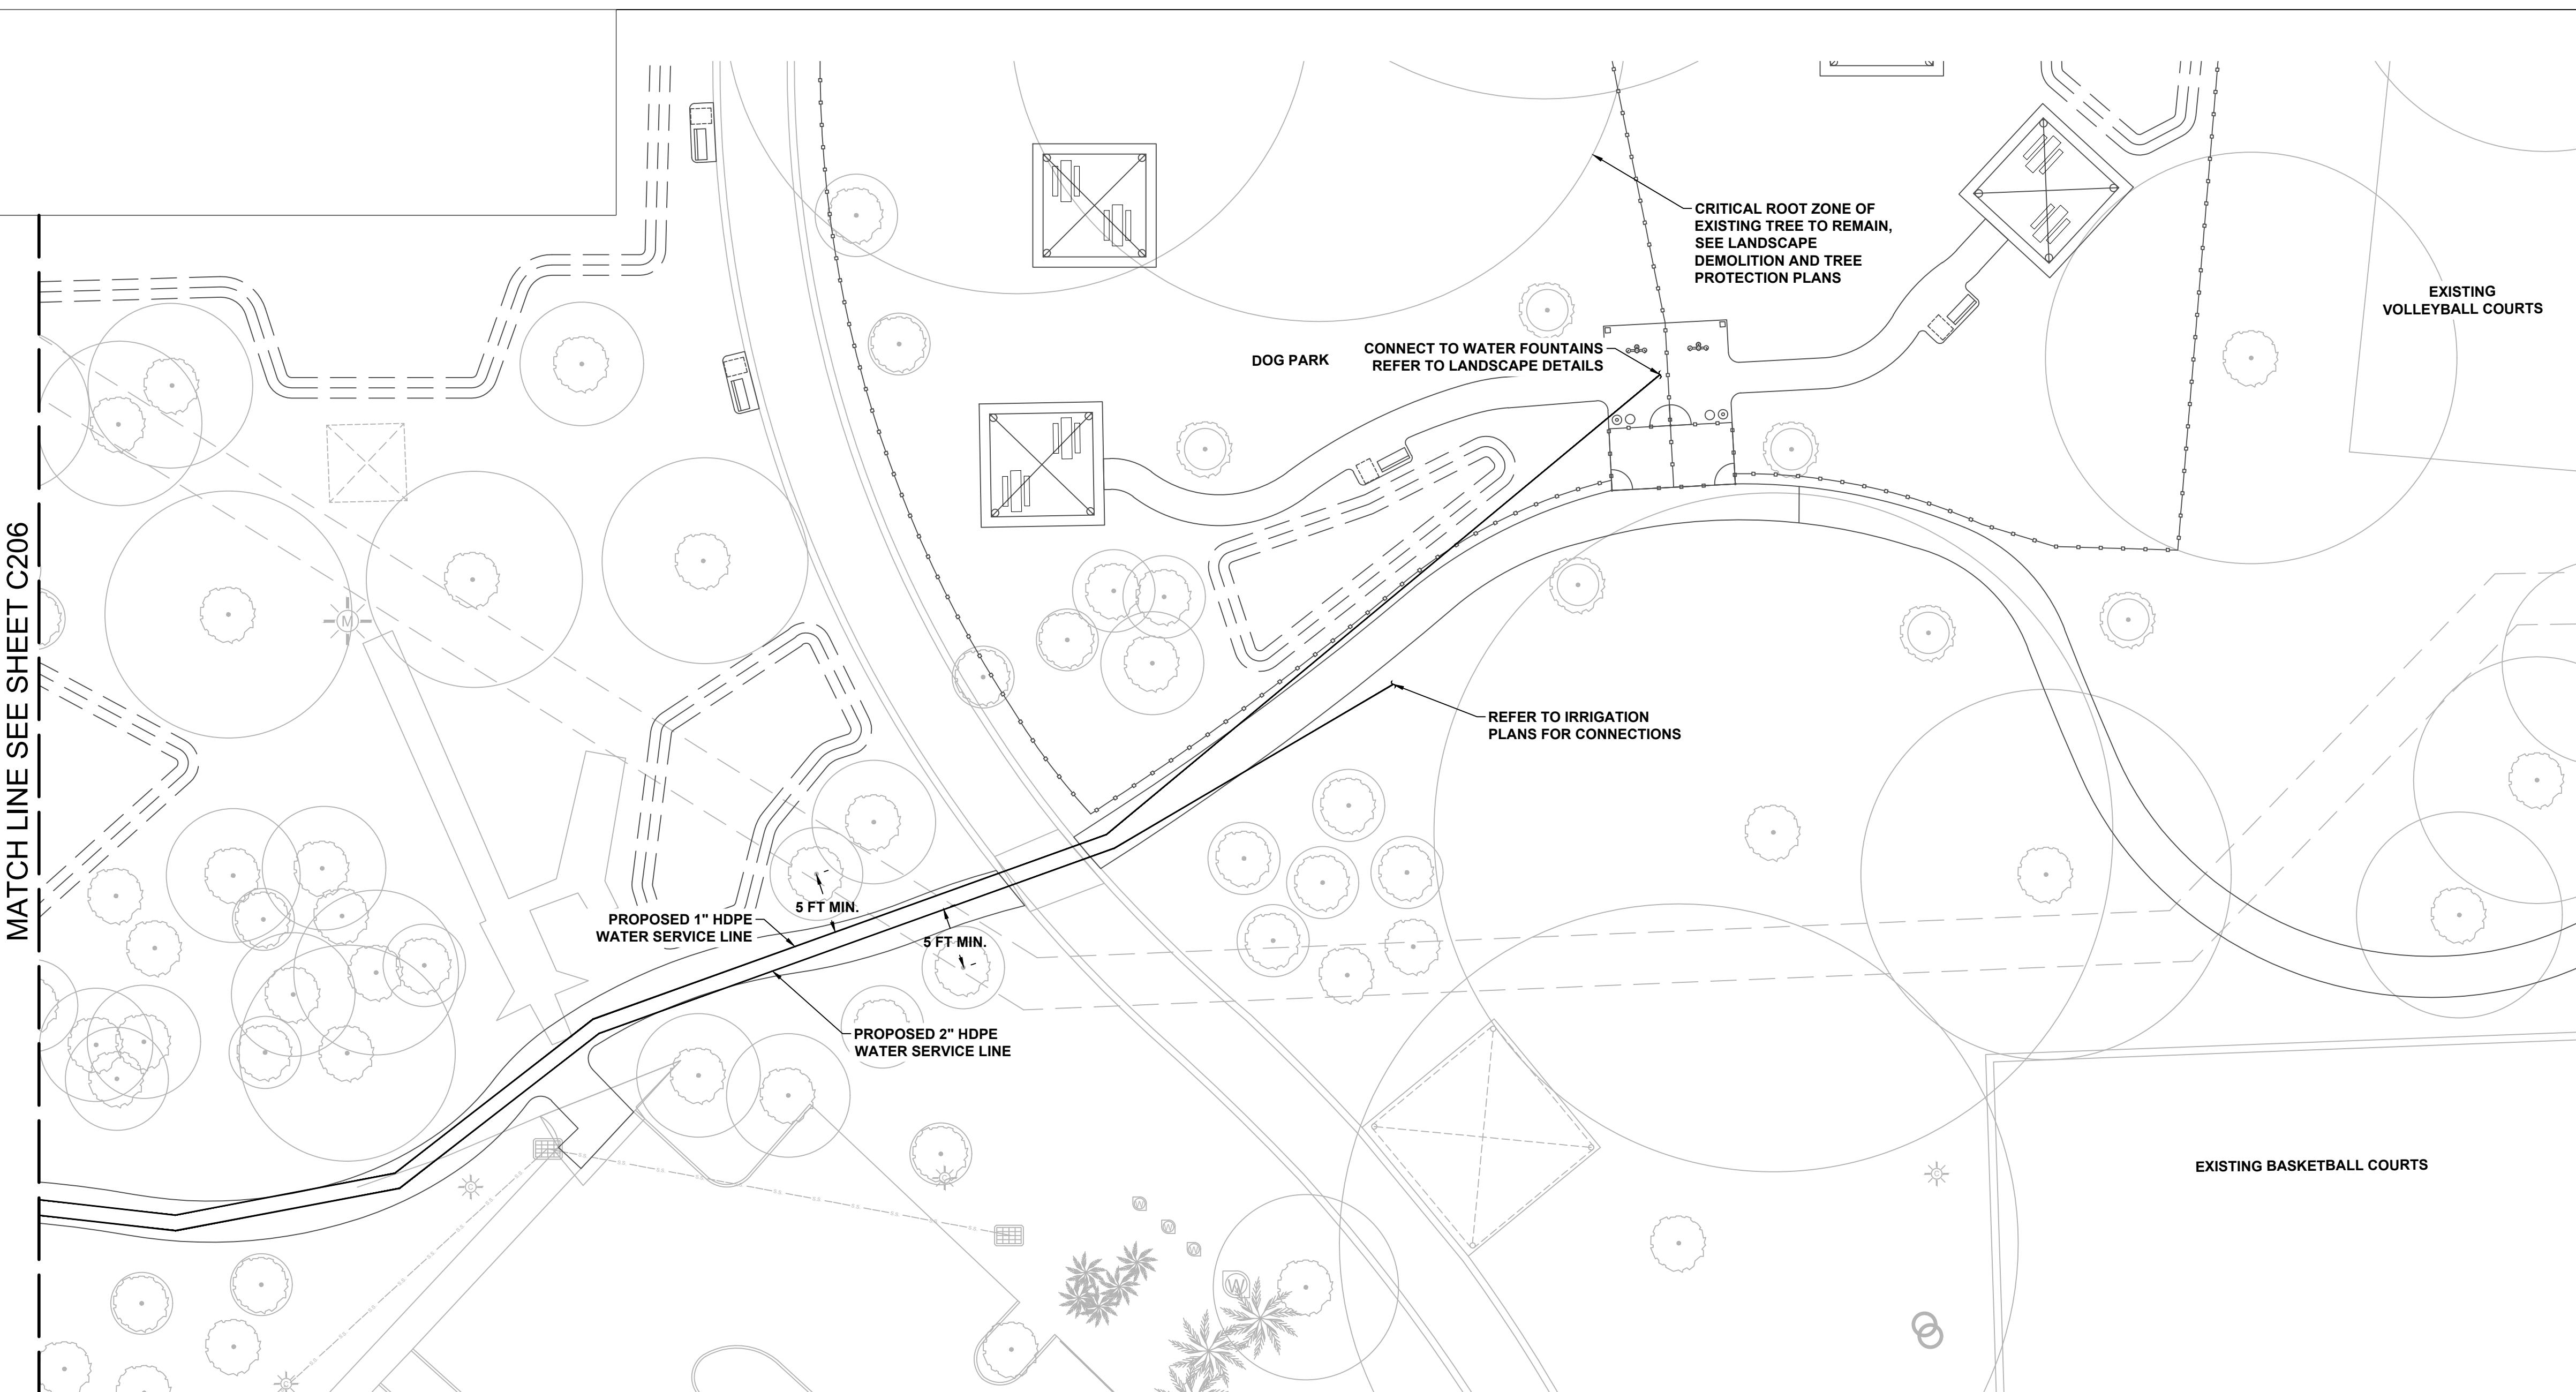
NOTES:

1. ALL WATER MAIN INSTALLATION SHALL COMPLY WITH THE REQUIREMENTS OF CHAPTER 62-555 OF THE FAC AS APPLICABLE.
2. RESTORE EXISTING VALVES AND MANHOLES AT PROPOSED CONNECTIONS TO CITY STANDARDS.
3. CONTRACTOR TO NOTIFY ENGINEER OF RECORD OF ANY FIELD CHANGES.
4. CONTRACTOR MUST PROTECT AND/OR RESTORE, IN KIND, IF ANY DAMAGE OCCURS TO ALL DRIVEWAYS, SIDEWALKS, SWALES, AND IRRIGATION.
5. LOCATIONS OF EXISTING UNDERGROUND UTILITIES SHOWN HAVE BEEN PREPARED FROM THE MOST RELIABLE INFORMATION AVAILABLE TO THE ENGINEER. THE CONTRACTOR SHALL BE RESPONSIBLE FOR VERIFYING LOCATIONS AND DEPTHS OF ALL PERTINENT UTILITIES PRIOR TO COMMENCEMENT OF CONSTRUCTION WORK.
6. REFER TO LANDSCAPE DEMOLITION AND TREE PROTECTION PLANS FOR TREE PROTECTION.
7. CRITICAL ROOT ZONES TO BE PROTECTED AT ALL TIMES. CONTRACTOR TO UTILIZE TRENCHLESS TECHNOLOGIES AS NEEDED.
8. SEE G101 KEY PLAN FOR NOT IN CONTRACT (NIC) LIMIT OF WORK.
9. ALL WATER LINES TO BE AT A MINIMUM DEPTH OF 30" PER FTL DETAIL W300. WATER LINE FITTINGS AND JOINTS TO BE HDPE AND JOINED BY FUSION.

N

0 10' 20' 40' 60'

SCALE: 1" = 20'-0"



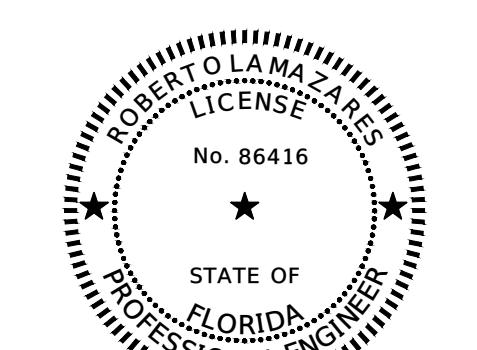
LEGEND

OHW	EXISTING ELECTRIC LINE TO REMAIN
W(C)	EXISTING POTABLE WATER LINE TO REMAIN
	EXISTING STORM LINE TO REMAIN
	EXISTING STORM STRUCTURE TO REMAIN
S(C)	EXISTING SANITARY SEWER TO REMAIN
	EXISTING IRRIGATION LINE TO REMAIN
BE(C)	EXISTING BURIED ELECTRIC TO REMAIN

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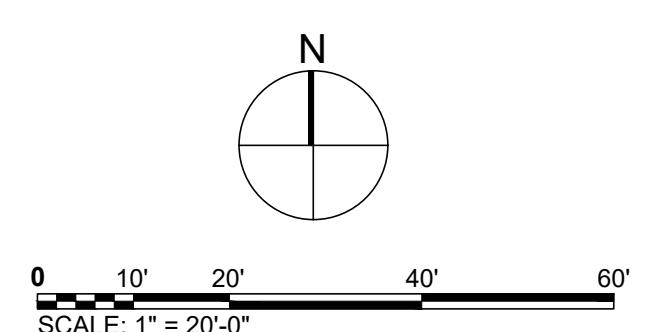
P12633

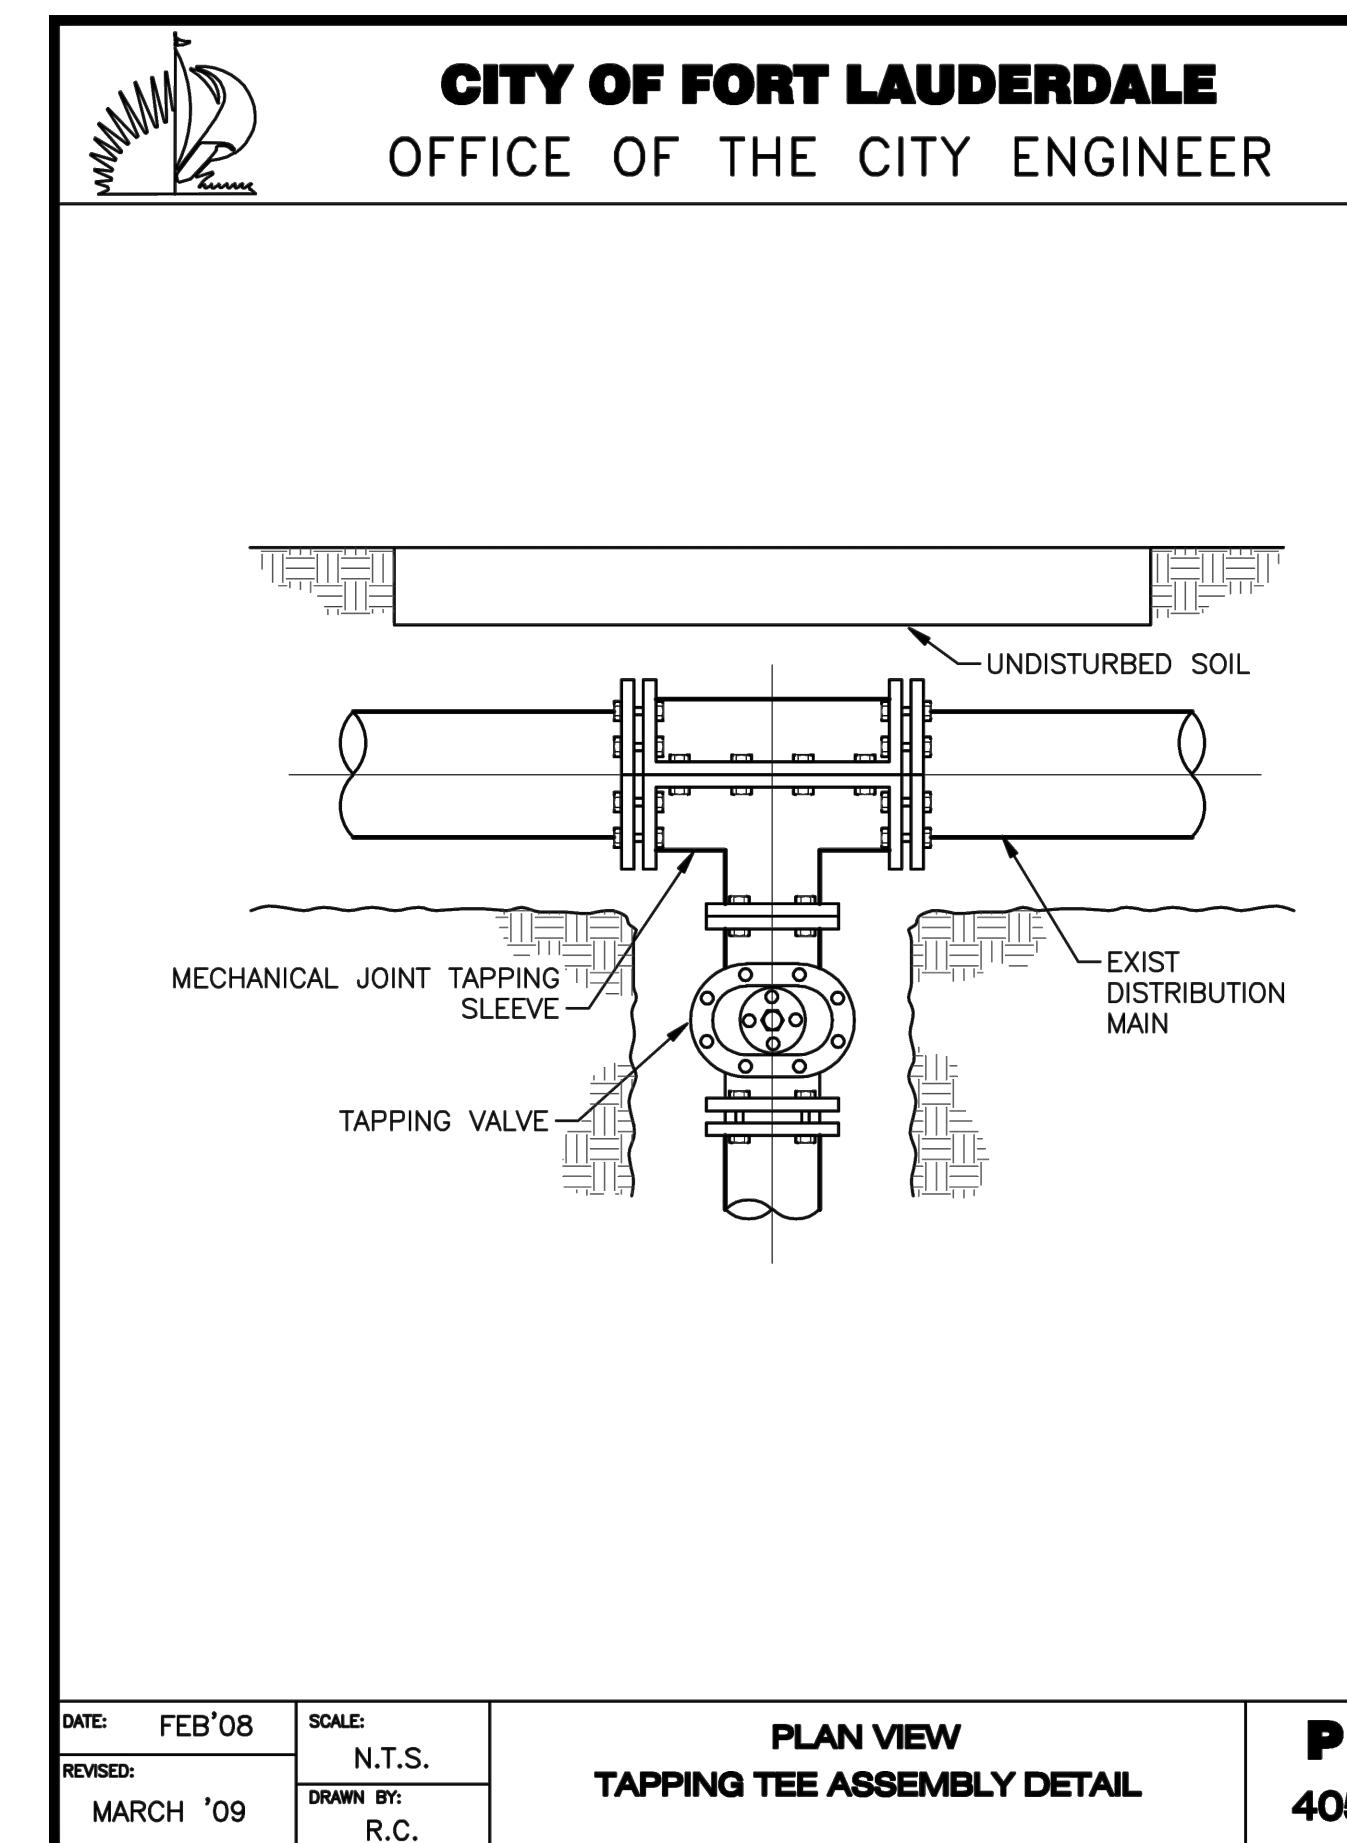
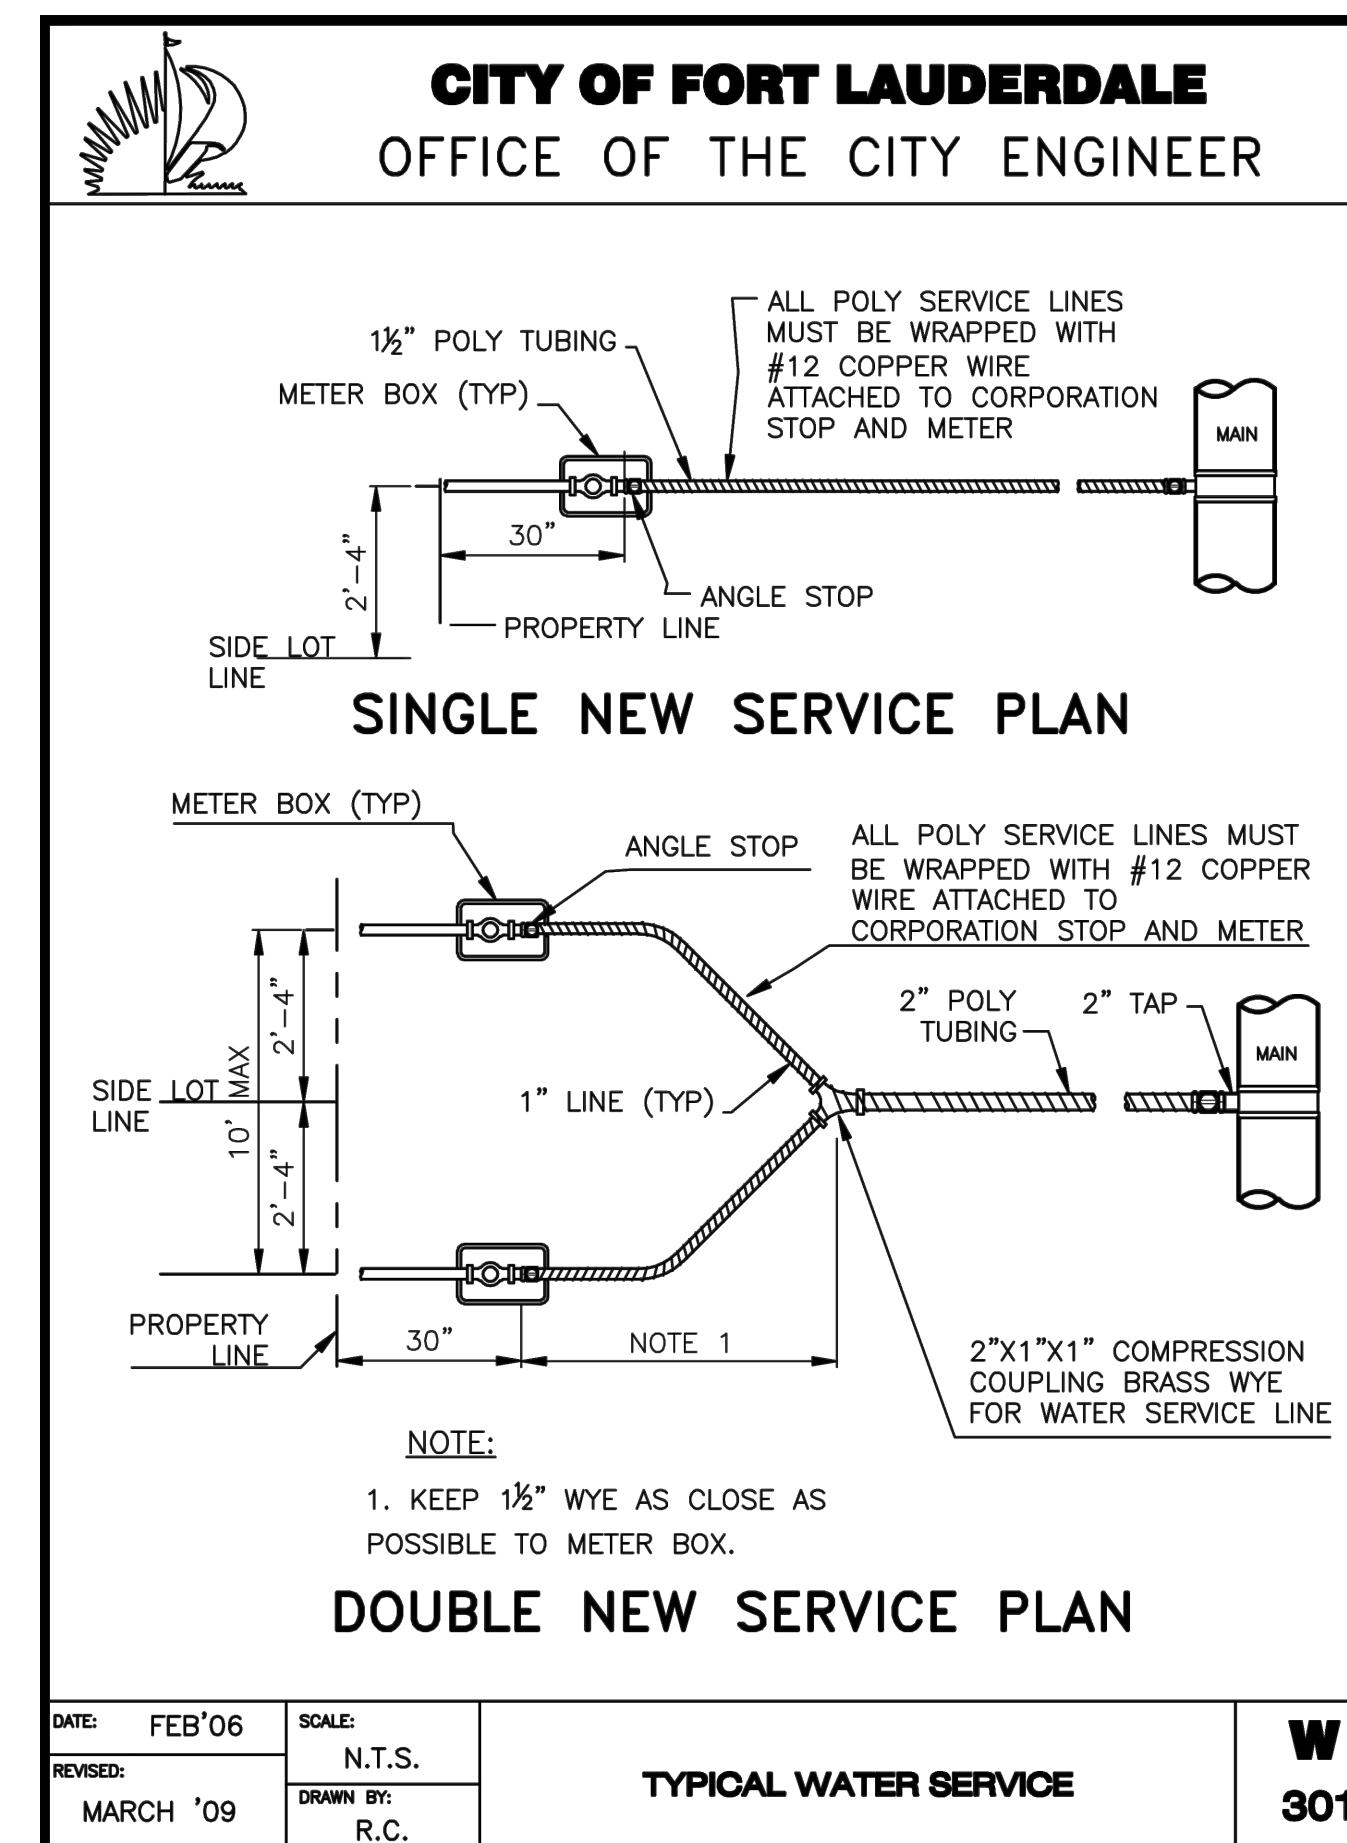
SHEET TITLE

UTILITY PLAN

SHEET NUMBER

C207





CITY OF FORT LAUDERDALE
OFFICE OF THE CITY ENGINEER

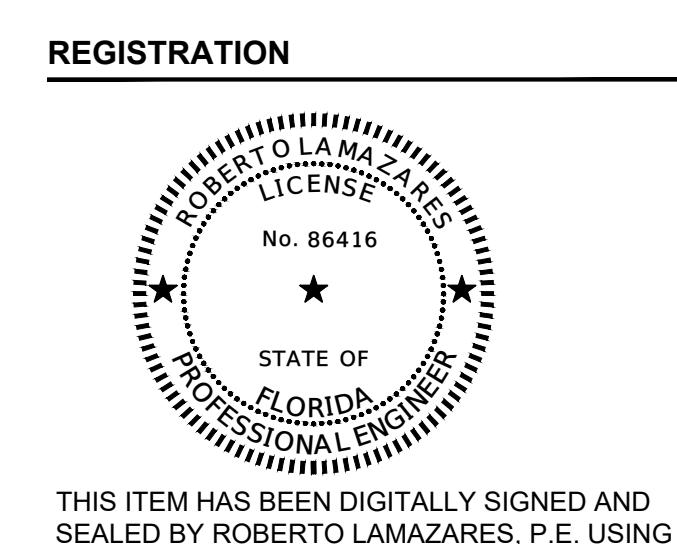
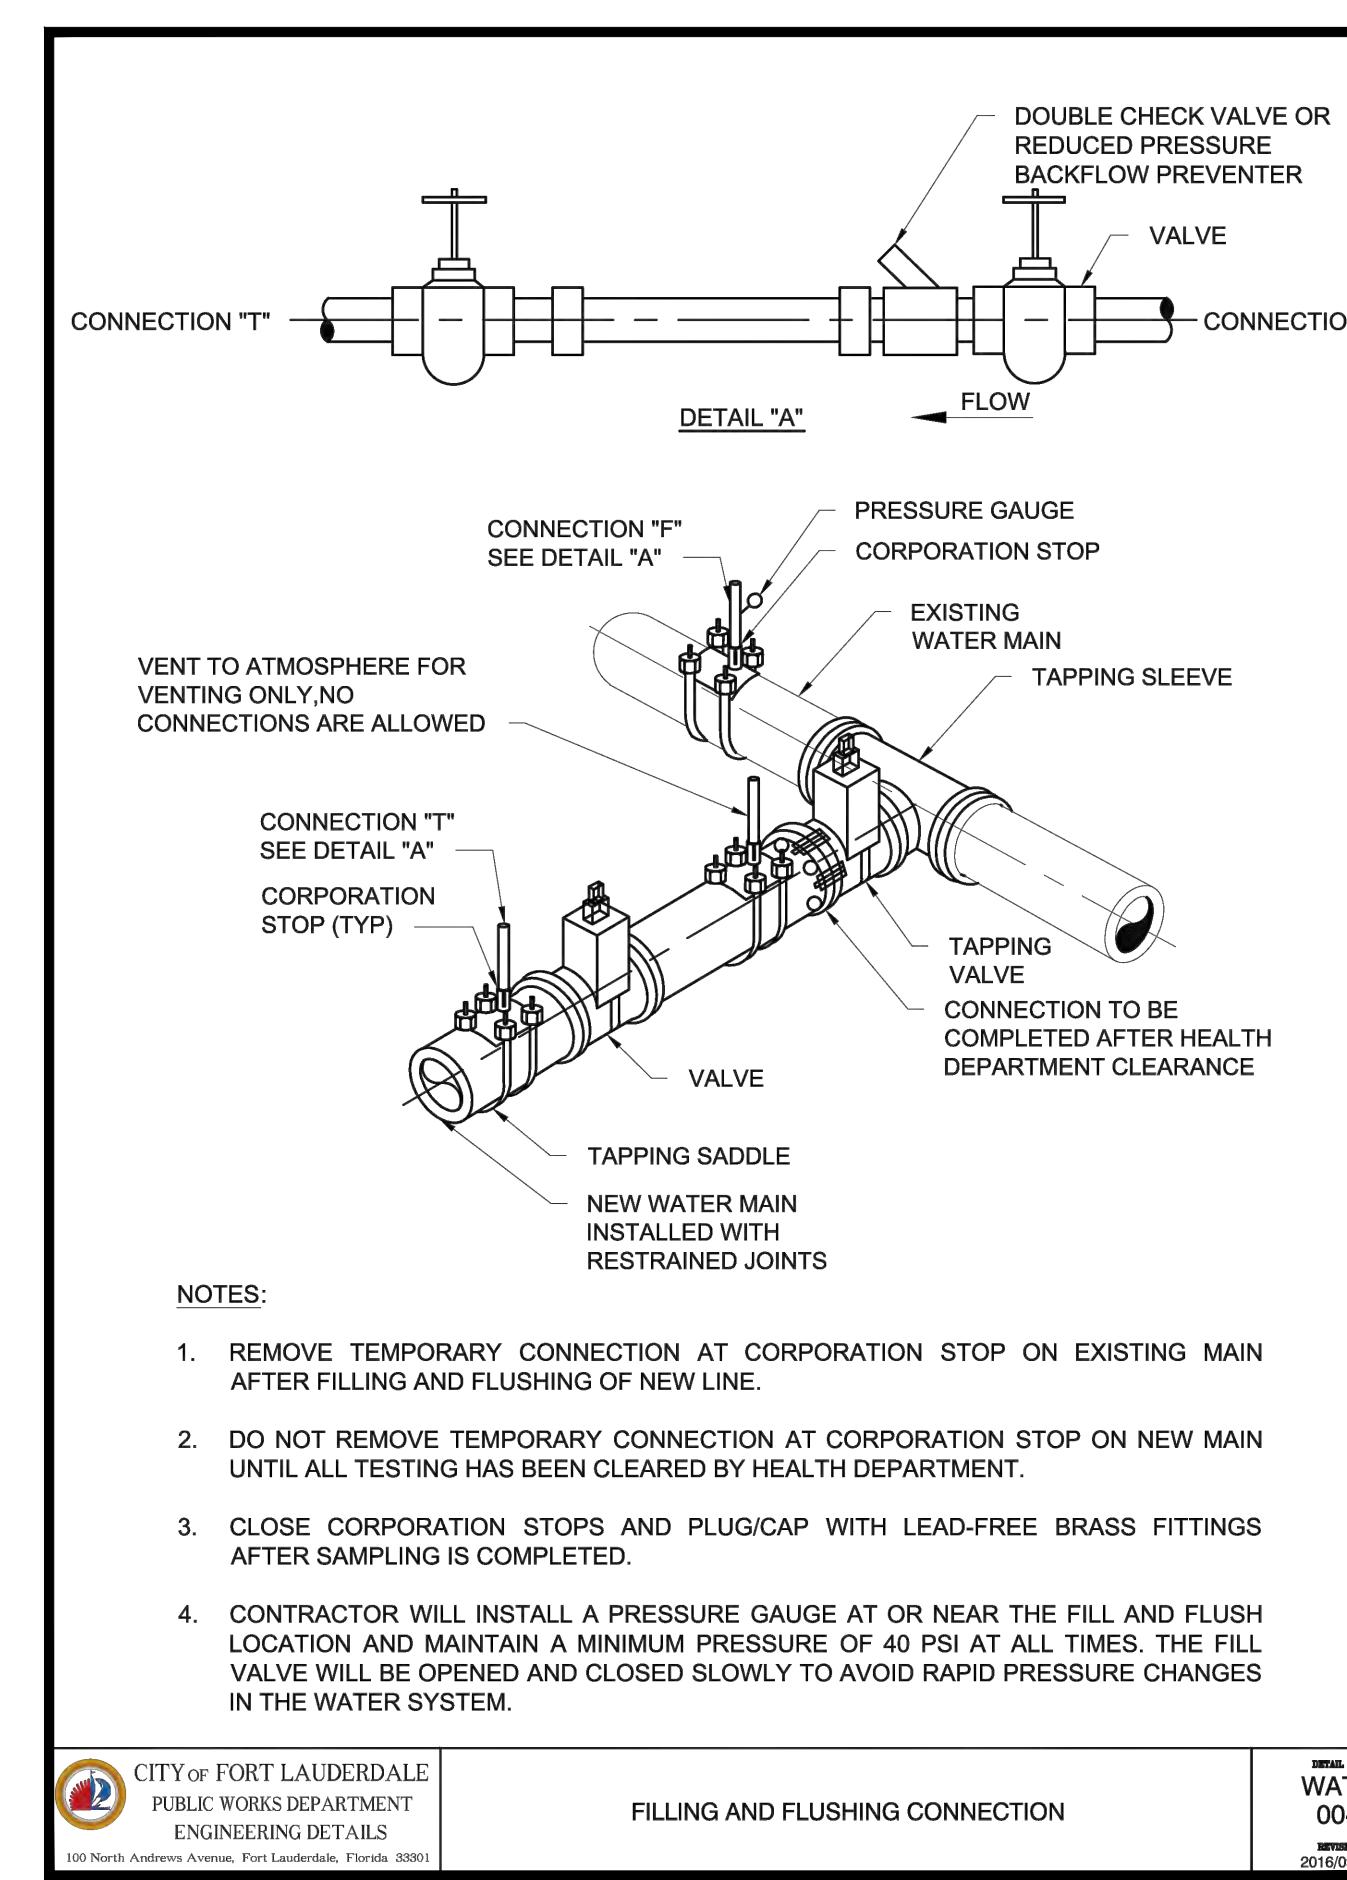
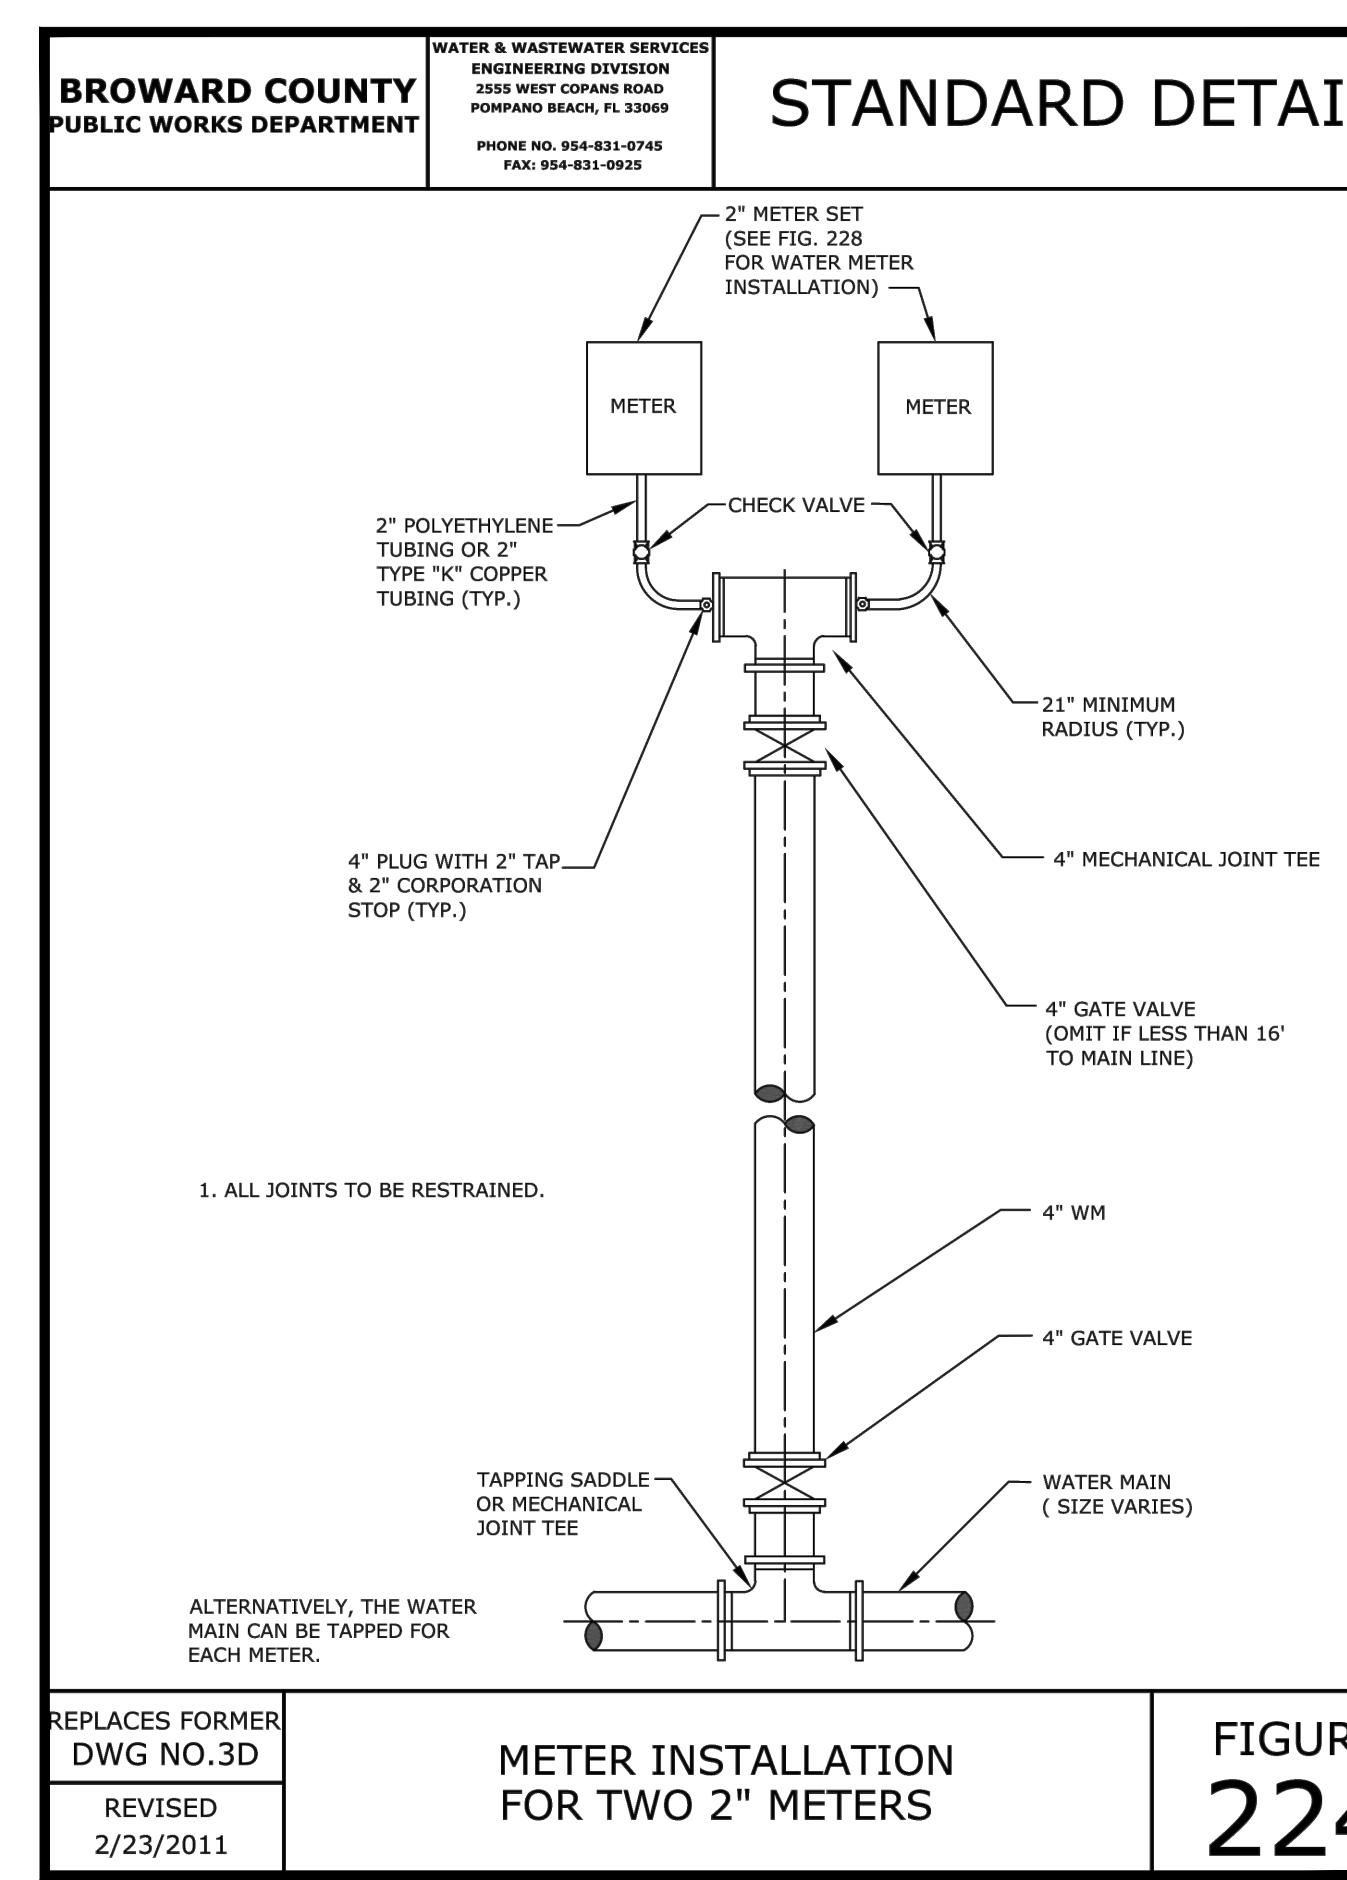
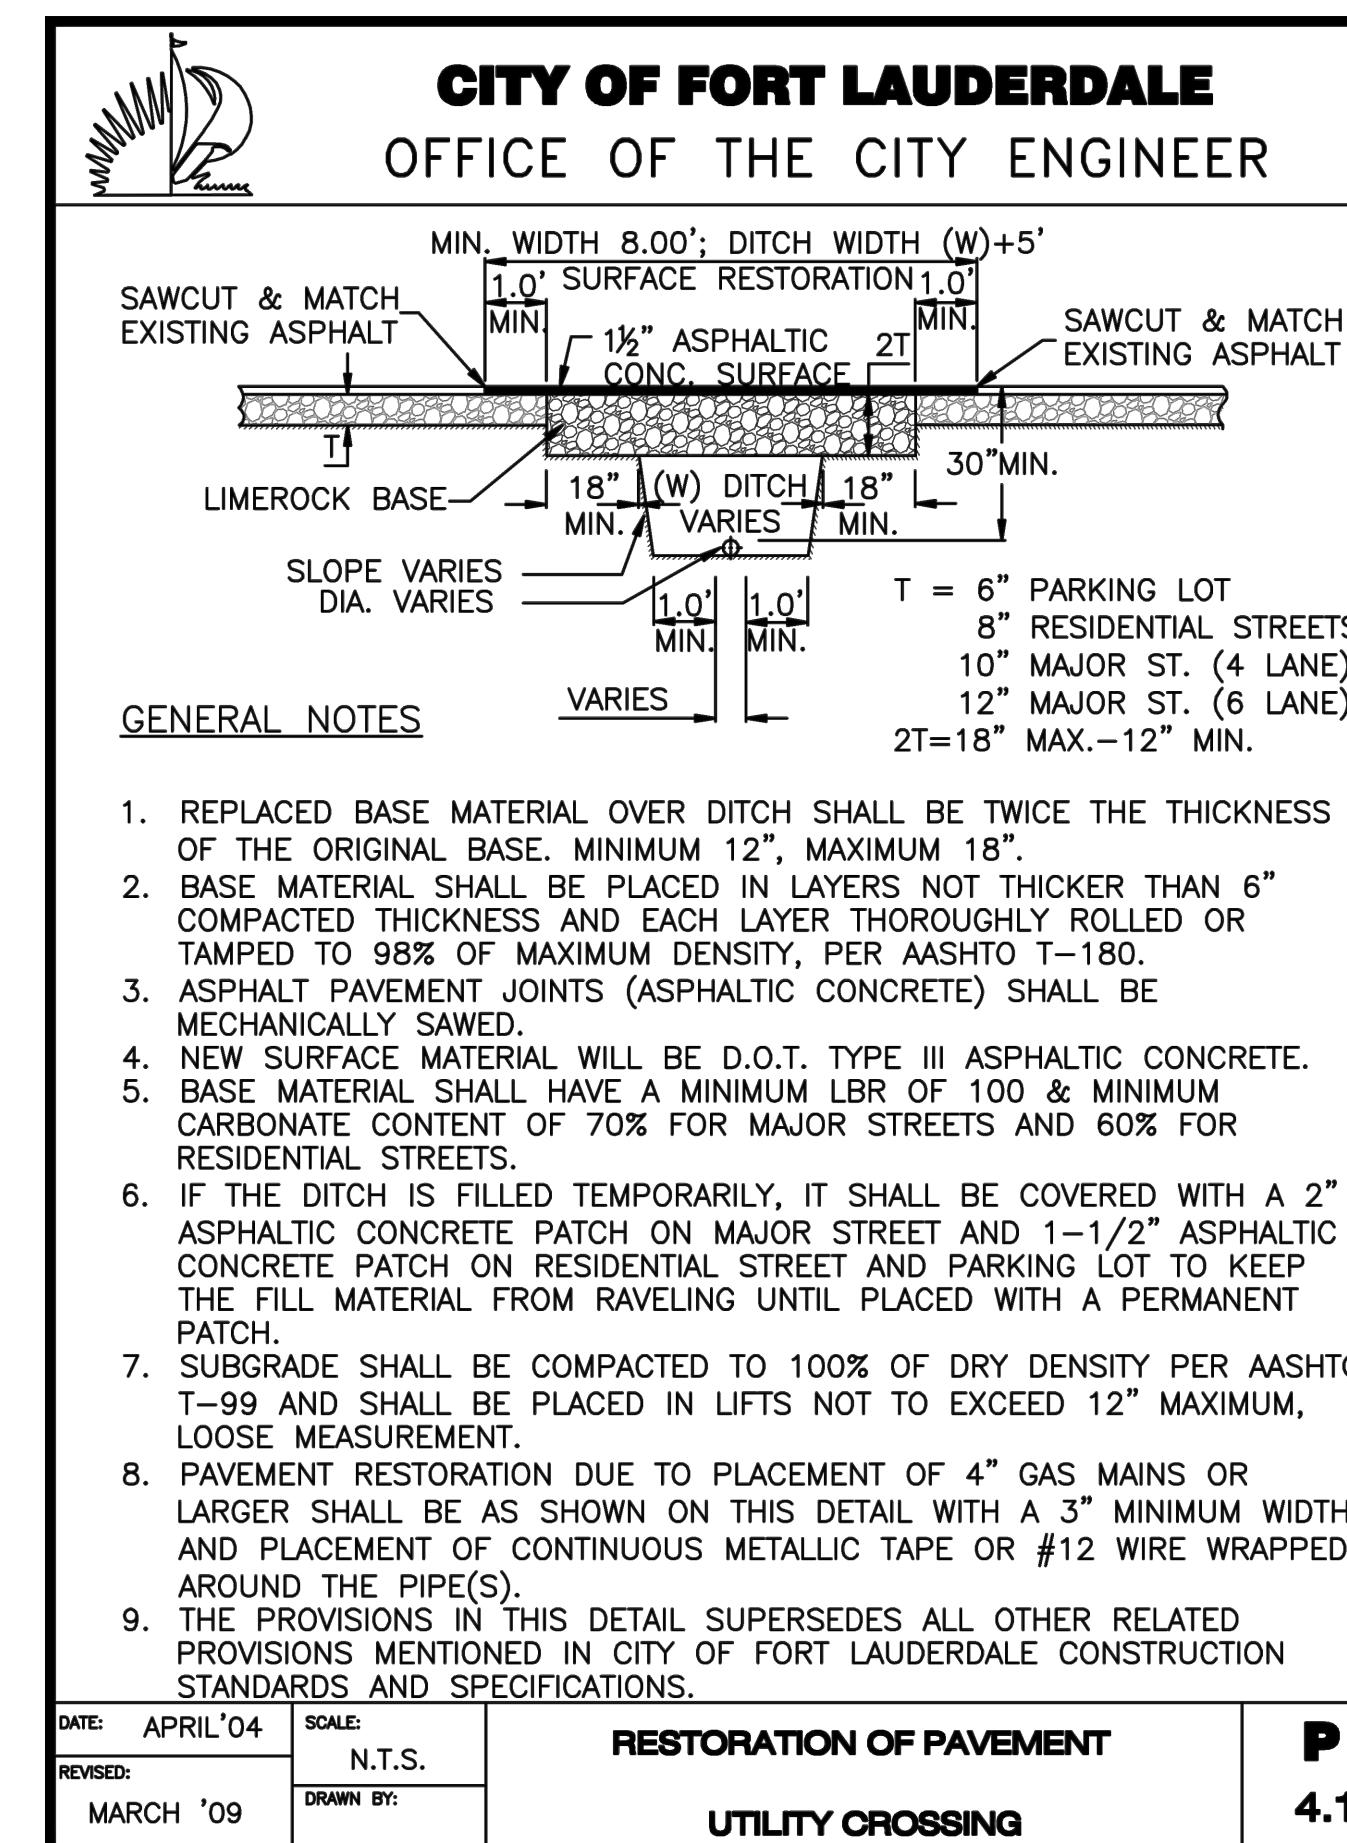
THE PROCEDURE FOR BACKFILL AND PAVEMENT RESTORATION SHALL BE AS FOLLOWS: "DENSITY TESTS OF COMPAKTED FILL, BACKFILL SHALL BE TAKEN AT EACH 12" PRIOR TO PLACEMENT OF THE SUCCEEDING LIFT OF MATERIAL ACCORDING TO THE FOLLOWING SCHEDULE".

1. FOR ANY ROAD CROSSING IN WHICH THE ROAD IS CUT AND RESTORED ONE LANE AT A TIME, ONE DENSITY TEST SHALL BE TAKEN IN EACH LANE.
2. FOR ANY ROAD CROSSING IN WHICH THE ROAD IS CUT AND RESTORED THREE LANES AT A TIME, DENSITIES SHALL BE TESTED IN TWO LOCATIONS STAGGERED WITH EACH SUCCESSIVE LIFT.
3. FOR ANY ROAD CROSSING IN WHICH THE ROAD IS CUT AND RESTORED TWO LANES AT A TIME, DENSITIES SHALL BE TESTED IN ONE LANE PER LIFT, ALTERNATING LANES WITH EACH LIFT.
4. CUTS ACROSS ROADS SHALL NOT BE LEFT OPENED OVER NIGHT UNLESS ABSOLUTELY NECESSARY. TRENCHES SHALL BE BACKFILLED AND A TEMPORARY ASPHALT APPLIED TO MAKE A SMOOTH LEVEL PATCH. THE TRENCHES SHALL THEN BE EXCAVATED THE NEXT DAY AND PERMANENT BACKFILL AND PAVEMENT INSTALLED IN ACCORDANCE WITH THESE STANDARDS. THE ONLY EXCEPTIONS WILL BE IN CASES WHERE THE FACILITY INSTALLED MUST BE TESTED BEFORE THE ROADS ARE RESTORED. IN THESE CASES, THE PERMANENT RESTORATION MUST BE PERFORMED ON THE DAY OF TESTING OR THE NEXT DAY.
5. IN CASES WHERE THE INSTALLATION PARALLELS THE ROADWAY AND DAMAGES THE PAVEMENT, THE DENSITY TESTS SHALL BE MADE EVERY 100' L.F. WITH TEST LOCATIONS STAGGERED 25' EACH LIFT.
6. SHOULDER AREAS AND SWALE AREAS BEYOND SHOULDERS SHALL BE COMPAKTED TO A MINIMUM OF 98% OF MAXIMUM DRY DENSITY, ALL AS DETERMINED BY AASHTO T-99-C STANDARD PROCTOR TEST.
7. RESTORATION OF STRIPING, SIGNING, AND SIGNALIZATION DEVICES SHALL BE ACCOMPLISHED IMMEDIATELY AFTER PAVEMENT RESTORATION IS COMPLETED.

A COPY OF ALL PROCTOR AND FIELD DENSITY TESTS SHALL BE FURNISHED TO THE ENGINEERING DIVISION.

PROCEDURE FOR RESTORATION **P 4.13**

DATE: APRIL '04 SCALE: N.T.S.
REVISED: MARCH '09 DRAWN BY:



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I/R DATE	DESCRIPTION

PROJECT NUMBER
P12633

SHEET TITLE
UTILITY DETAILS

SHEET NUMBER
C213

CLIENT



PRIME CONSULTANT

AECOM
7650 W. COURTNEY CAMPBELL CAUSEWAY
SUITE 700
TAMPA, FL 33607
813.286.1711 tel 813.287.8591 fax
www.aecom.com

SUB-CONSULTANT

CIVIL
BCC ENGINEERING
305.670.2350 tel
www.bcceng.com

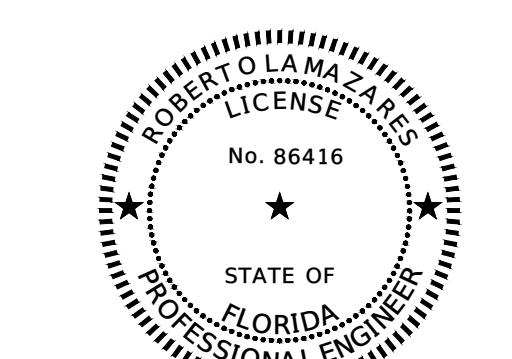
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06/24/2025	PHASE 2 BID DOCUMENTS
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PROJECT NUMBER

P12633

SHEET TITLE

SIGNING AND PAVEMENT

MARKING PLAN

SHEET NUMBER

C302

COORDINATE WITH AECOM ON LATEST ISSUE OF DRAWINGS BEFORE COMMENCEMENT OF CONSTRUCTION
NOTICE: THE OFFICIAL RECORD OF THIS SHEET IS THE ELECTRONIC FILE SIGNED AND SEALED UNDER RULE 61G15-23.004, F.A.C.

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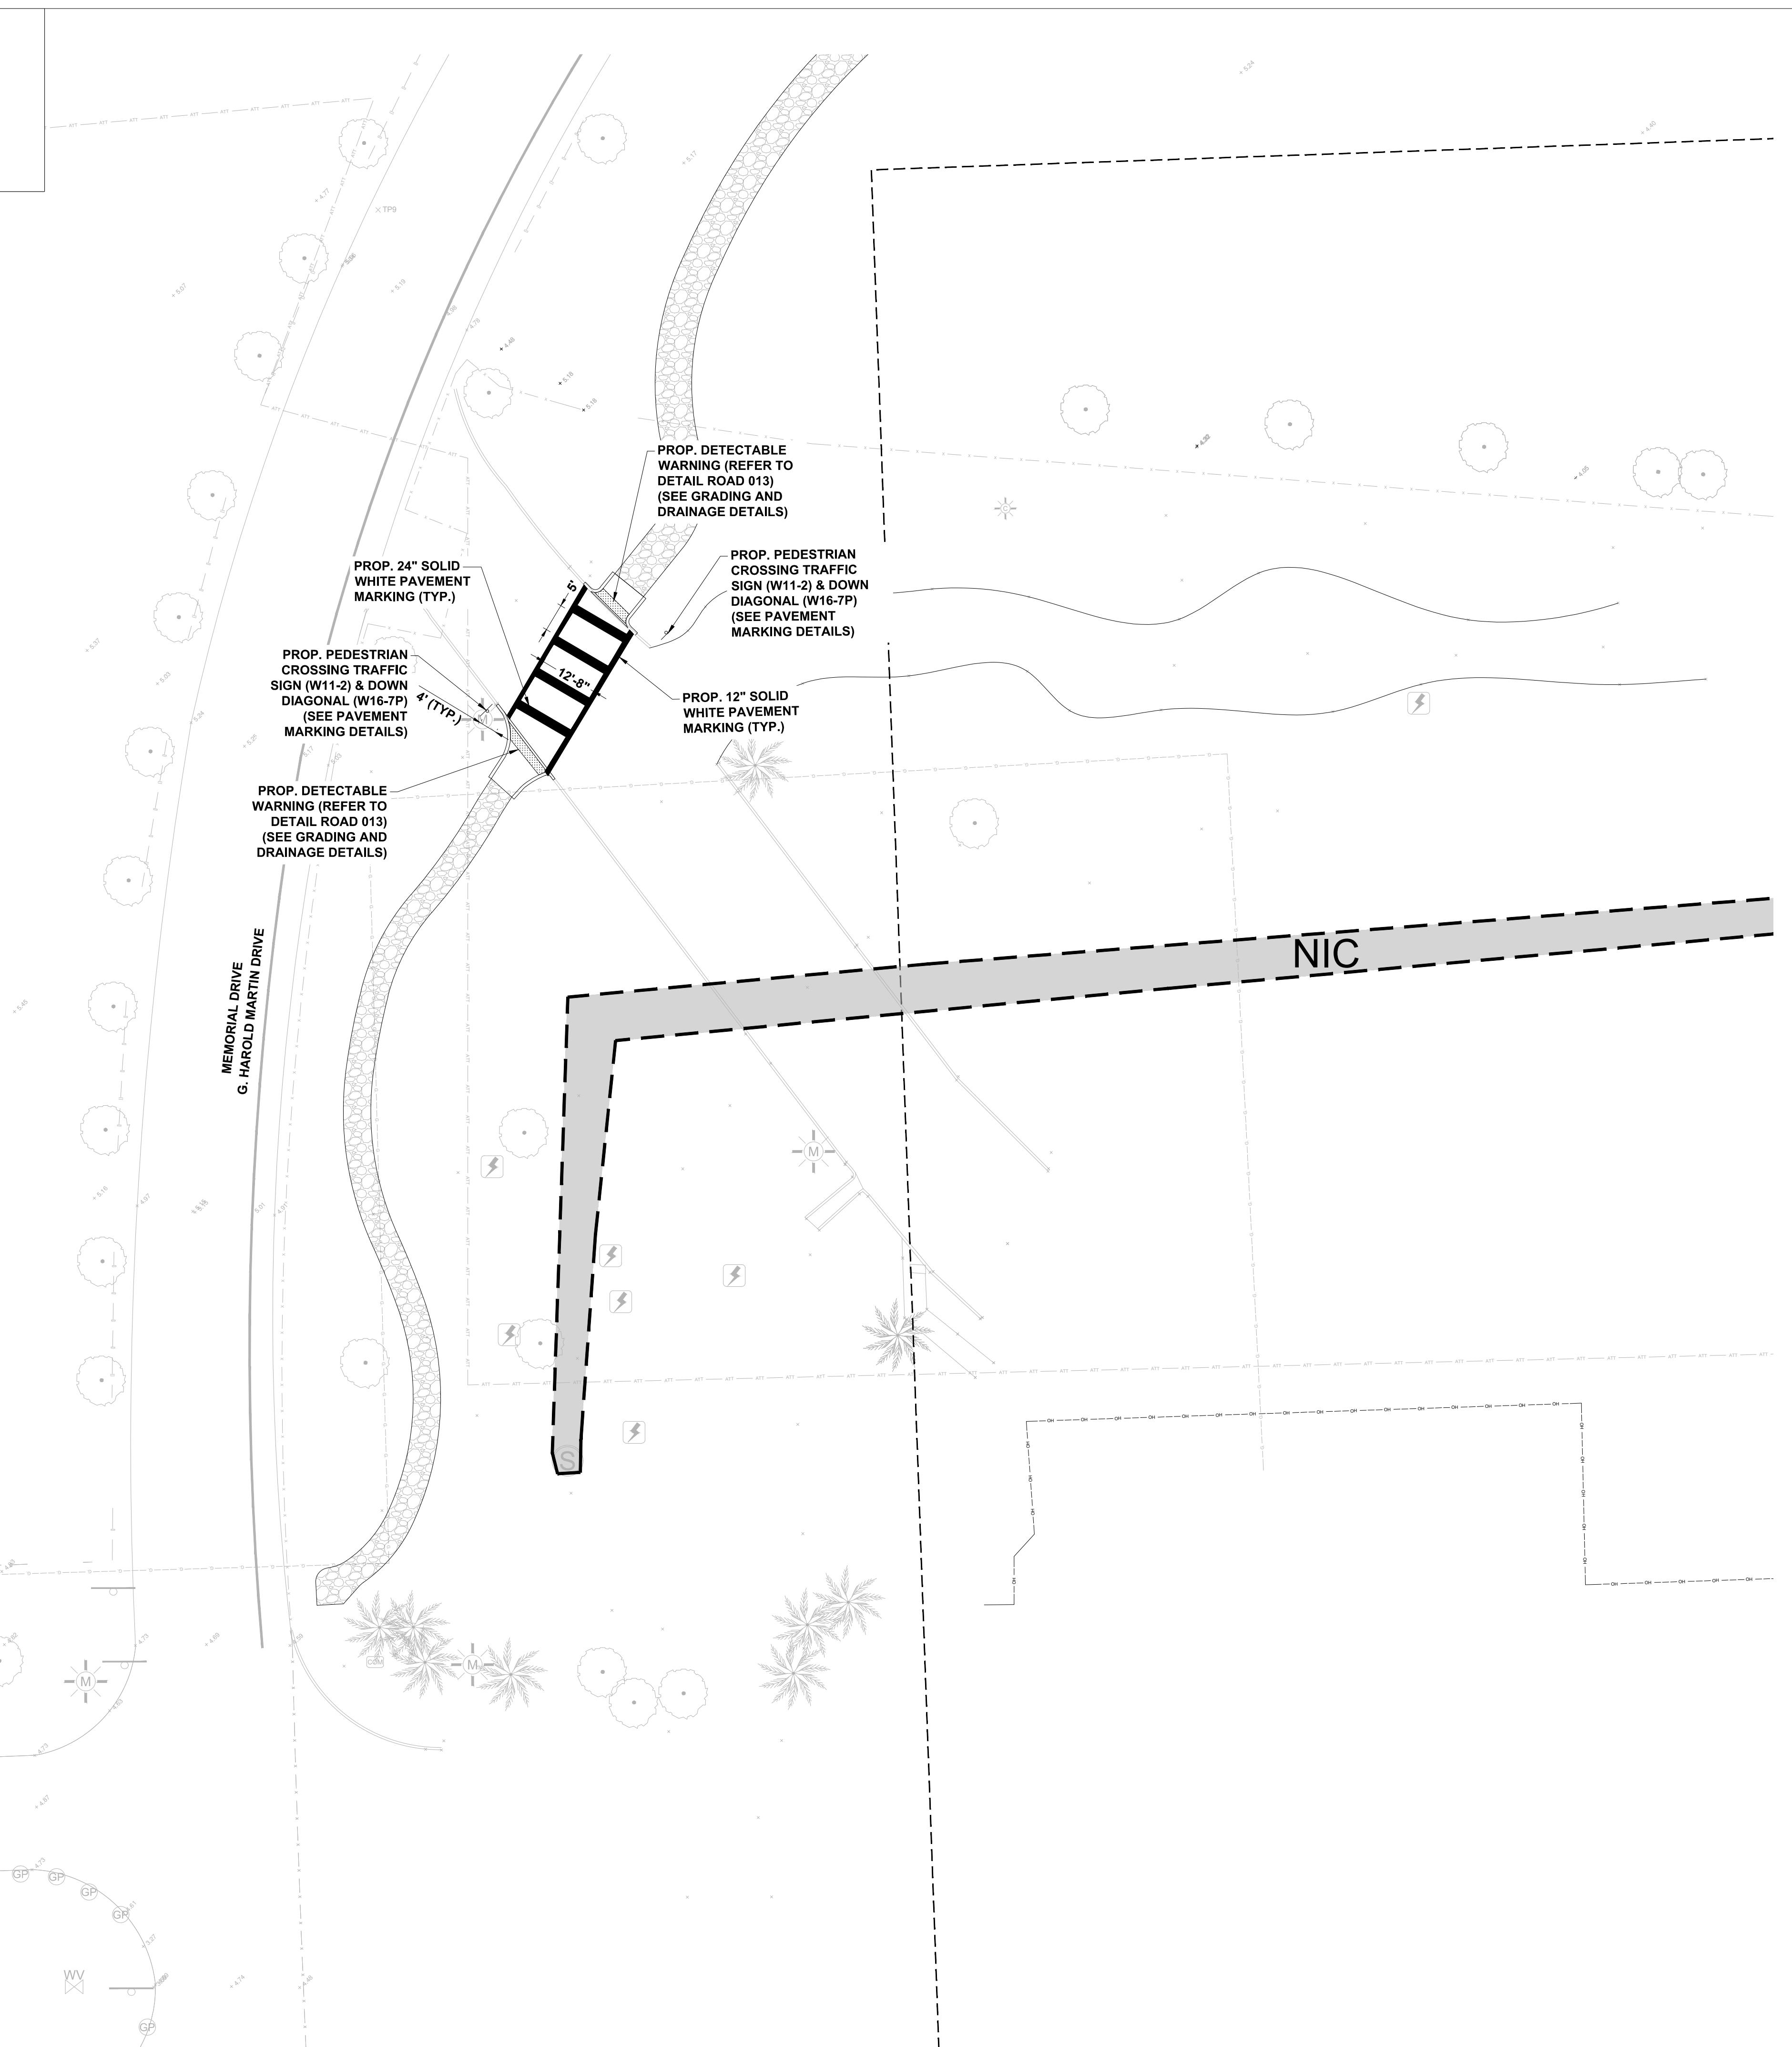
Checked: _____

Designer: _____

ANSI D 24" x 36"

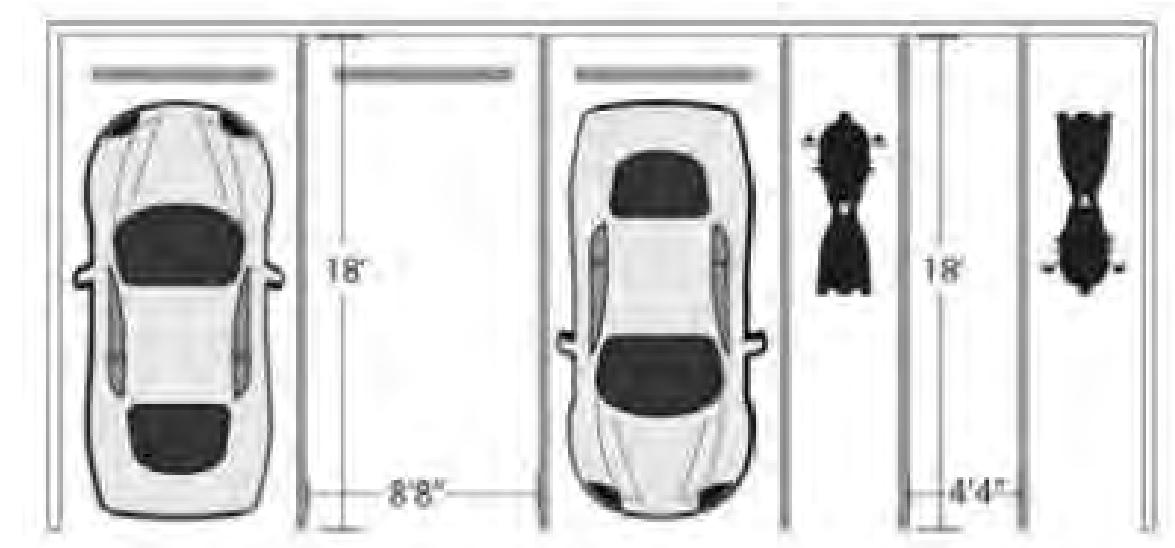
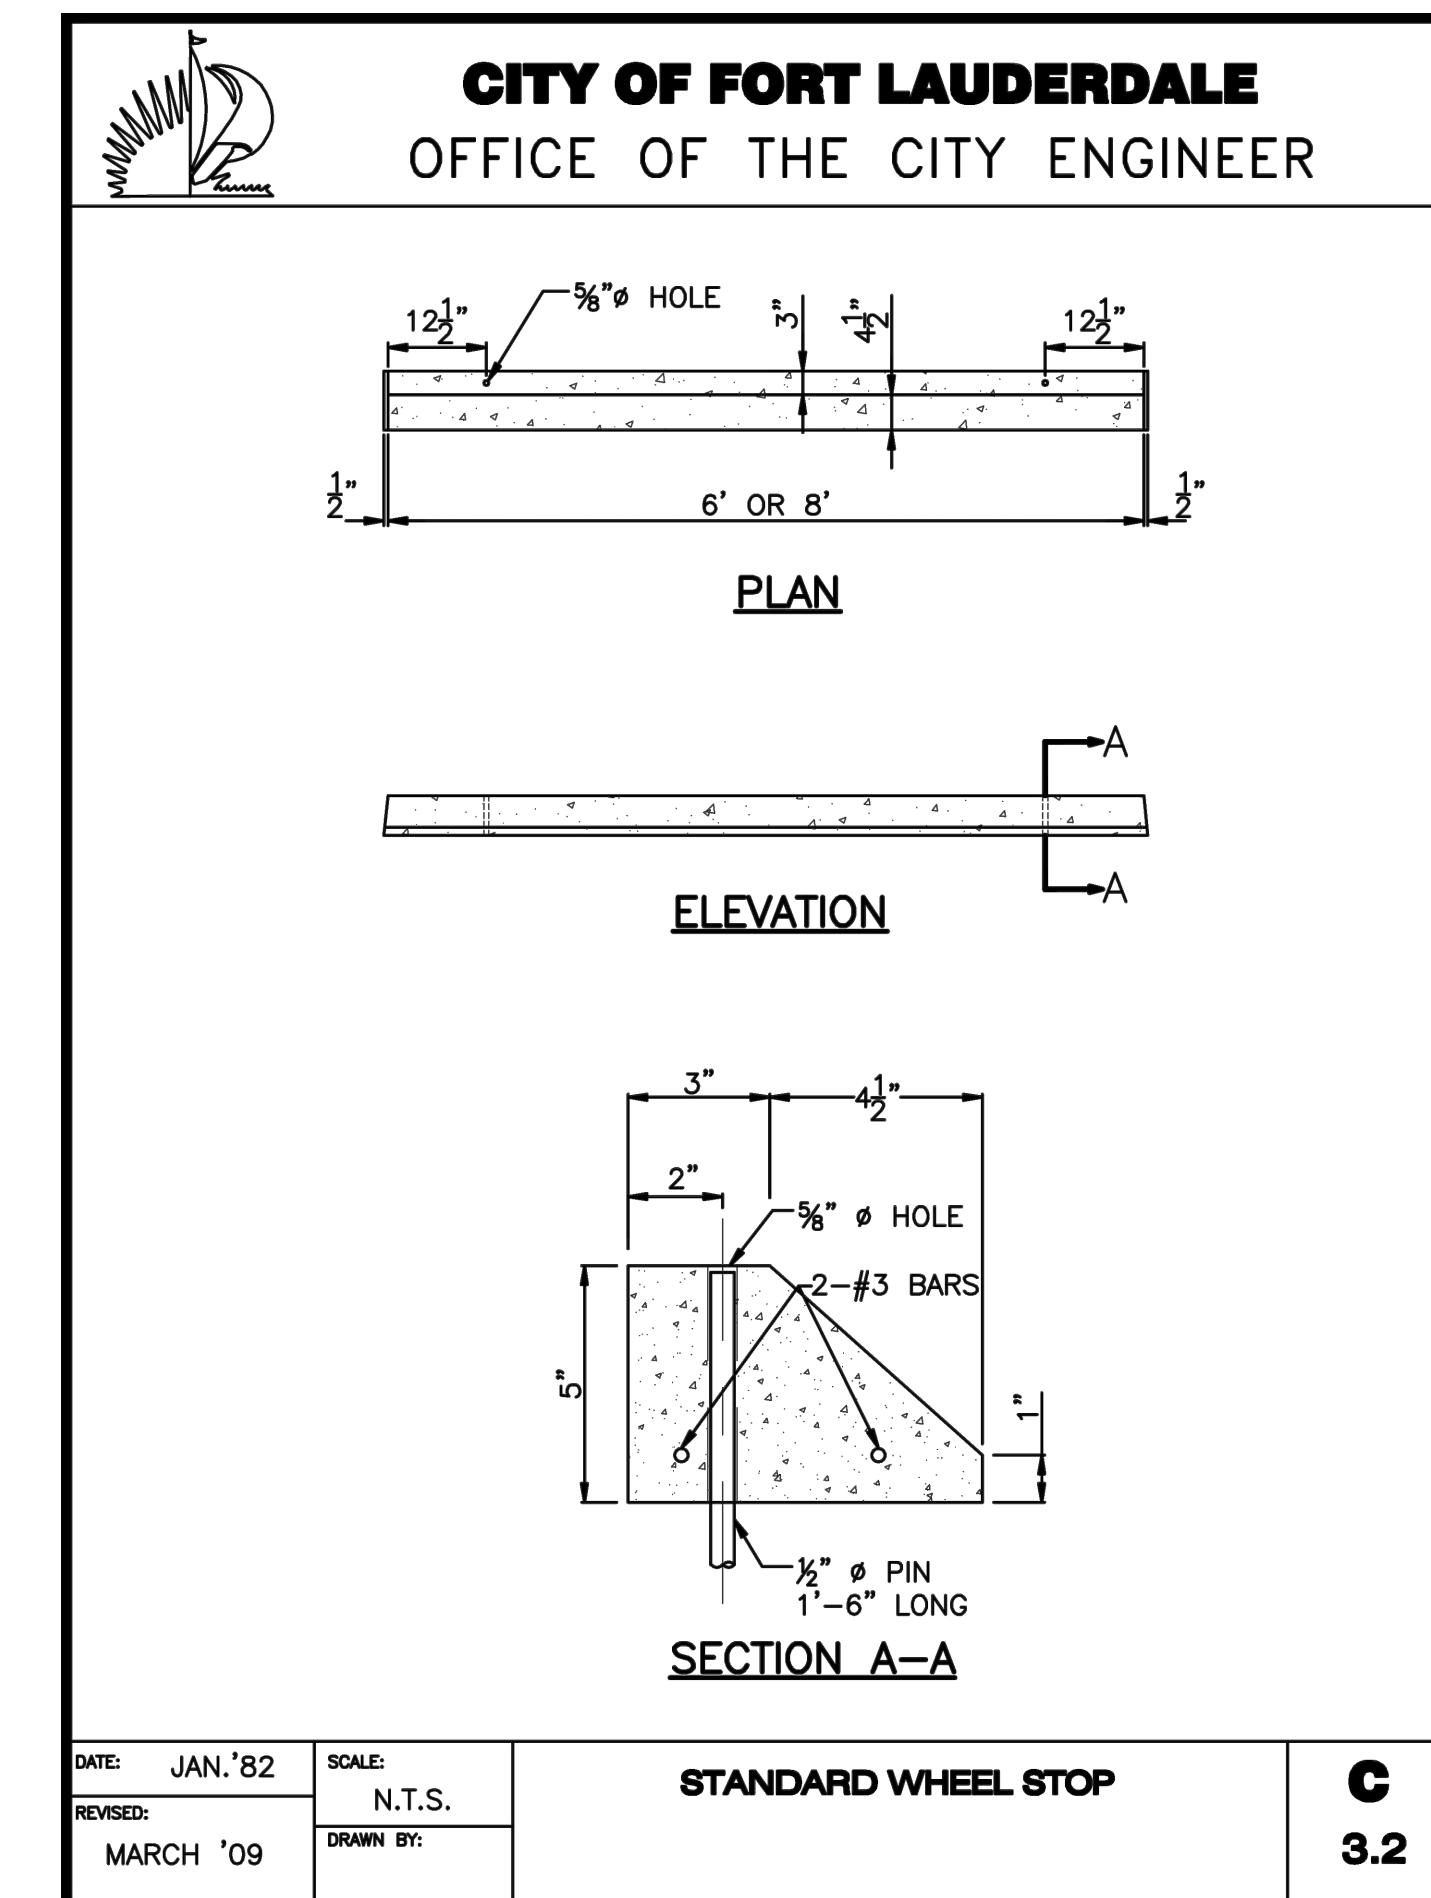
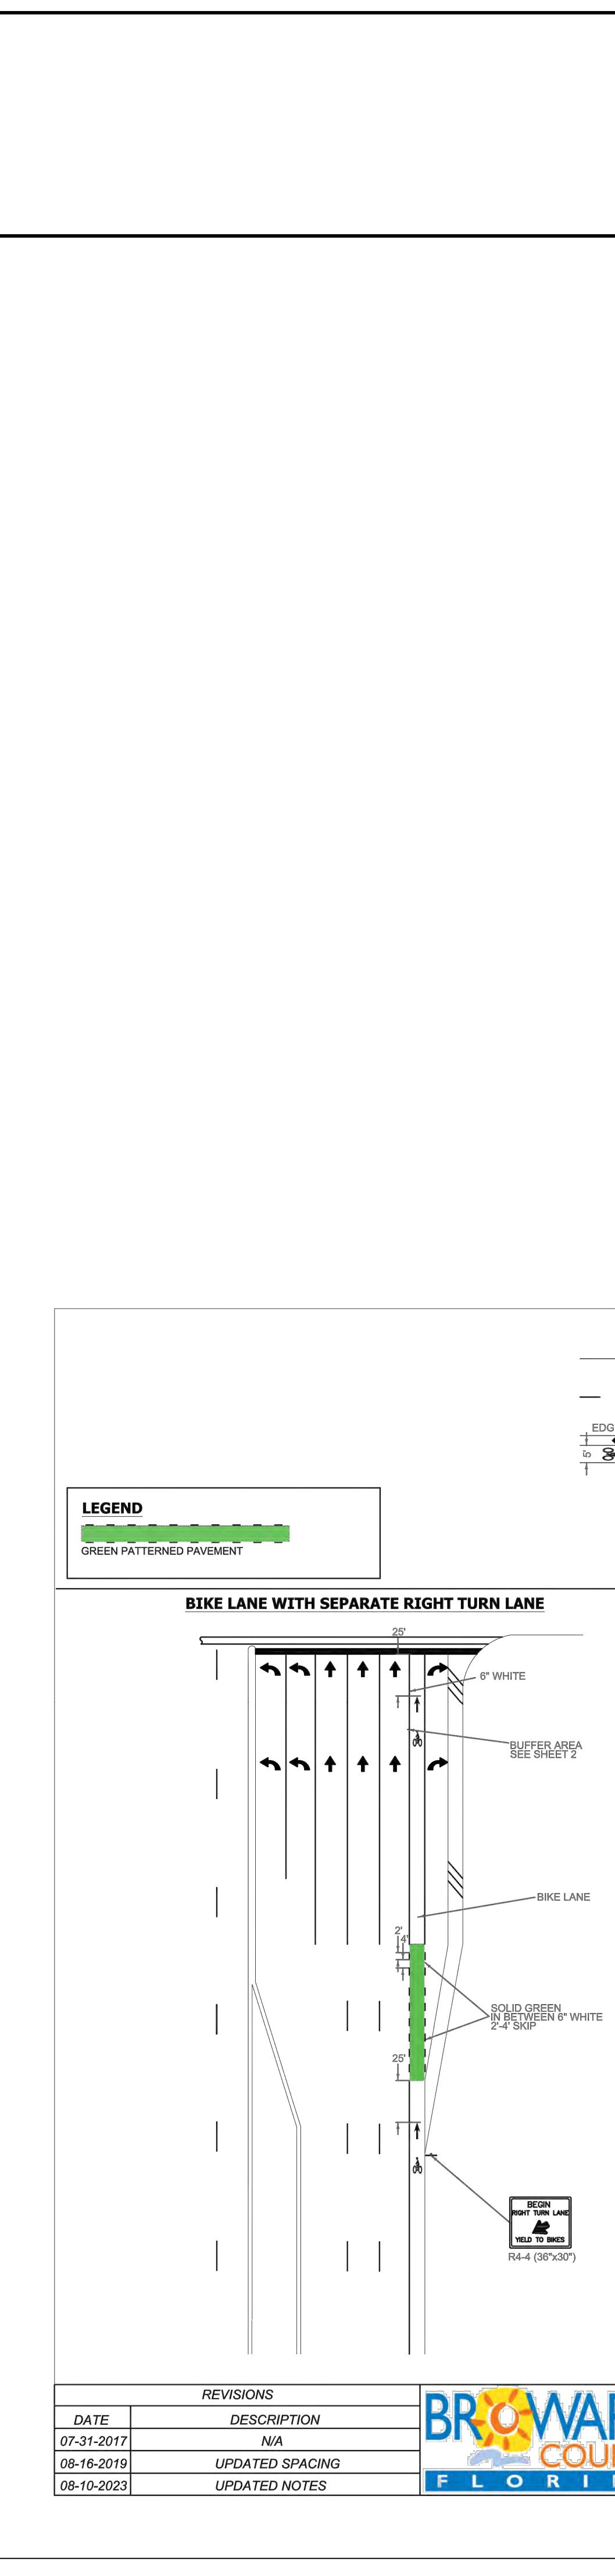
RK" PAGE 14 LIC RECORDS

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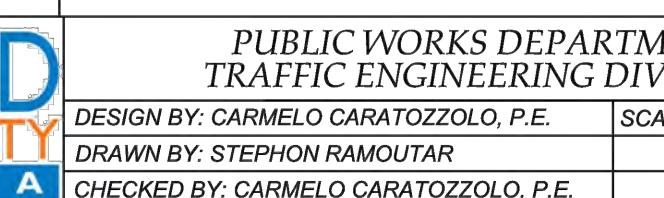
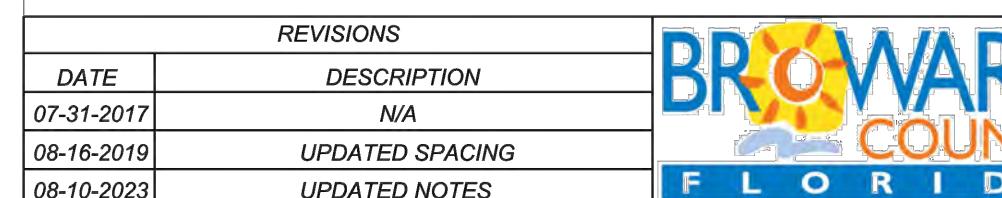
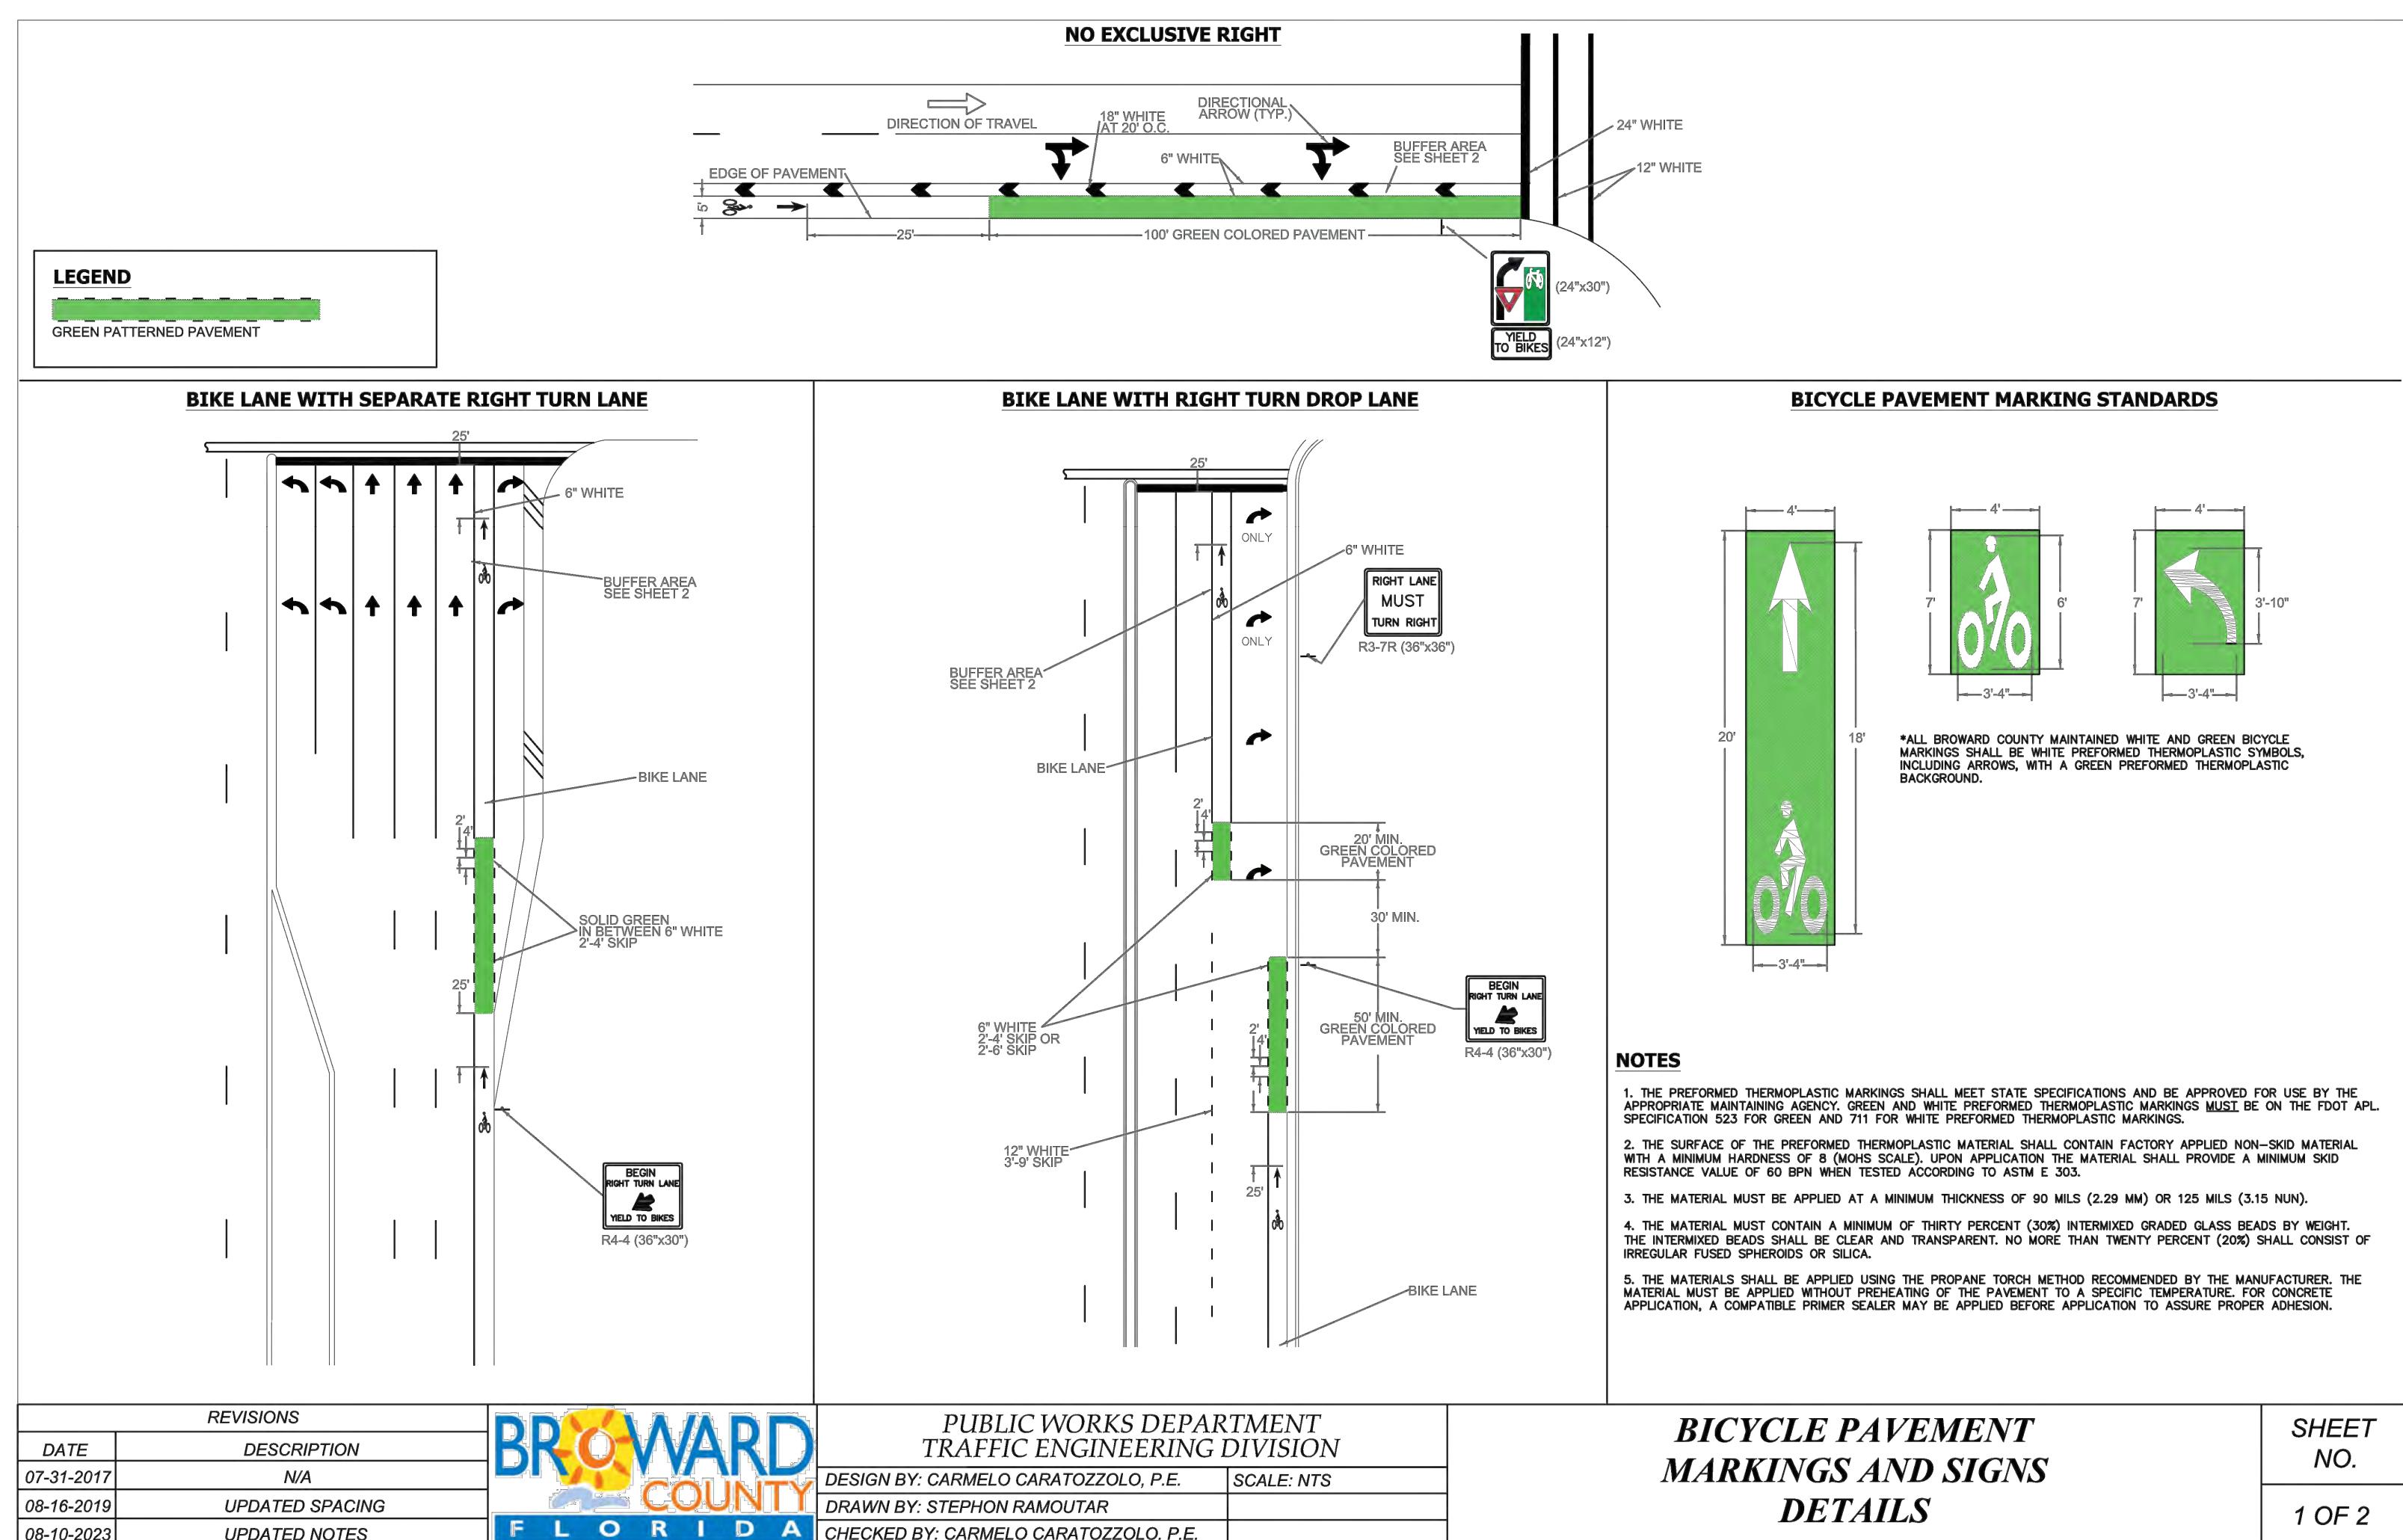


NOTES:
1. FOR PAVEMENT MARKING DETAILS REFER TO SHEET C305.
2. RESTORATION OF STRIPING, SIGNING, AND SIGNALIZATION DEVICES SHALL BE ACCOMPLISHED IMMEDIATELY AFTER PAVEMENT RESTORATION IS COMPLETED.

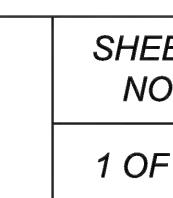
SIGN SIZES:
W11-2: 24" x 24"
W16-7P: 24" x 12"



CITY OF FORT LAUDERDALE
STANDARD PARKING STALL DETAIL



DESIGN BY: CARMELO CARATOZZOLO, P.E. DRAWN BY: STEPHON RAMOUTAR
CHECKED BY: CARMELO CARATOZZOLO, P.E.



COORDINATE WITH AECOM ON LATEST ISSUE OF DRAWINGS BEFORE COMMENCEMENT OF CONSTRUCTION
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06/24/2025	PHASE 2 BID DOCUMENTS
I/R DATE	DESCRIPTION

PROJECT NUMBER

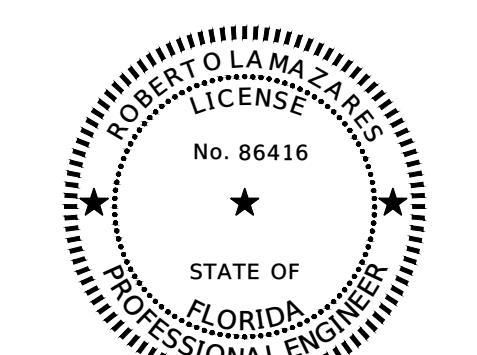
P12633

SHEET TITLE

PAVEMENT MARKING DETAILS

SHEET NUMBER

C307



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I/R DATE DESCRIPTION

PROJECT NUMBER
P12633

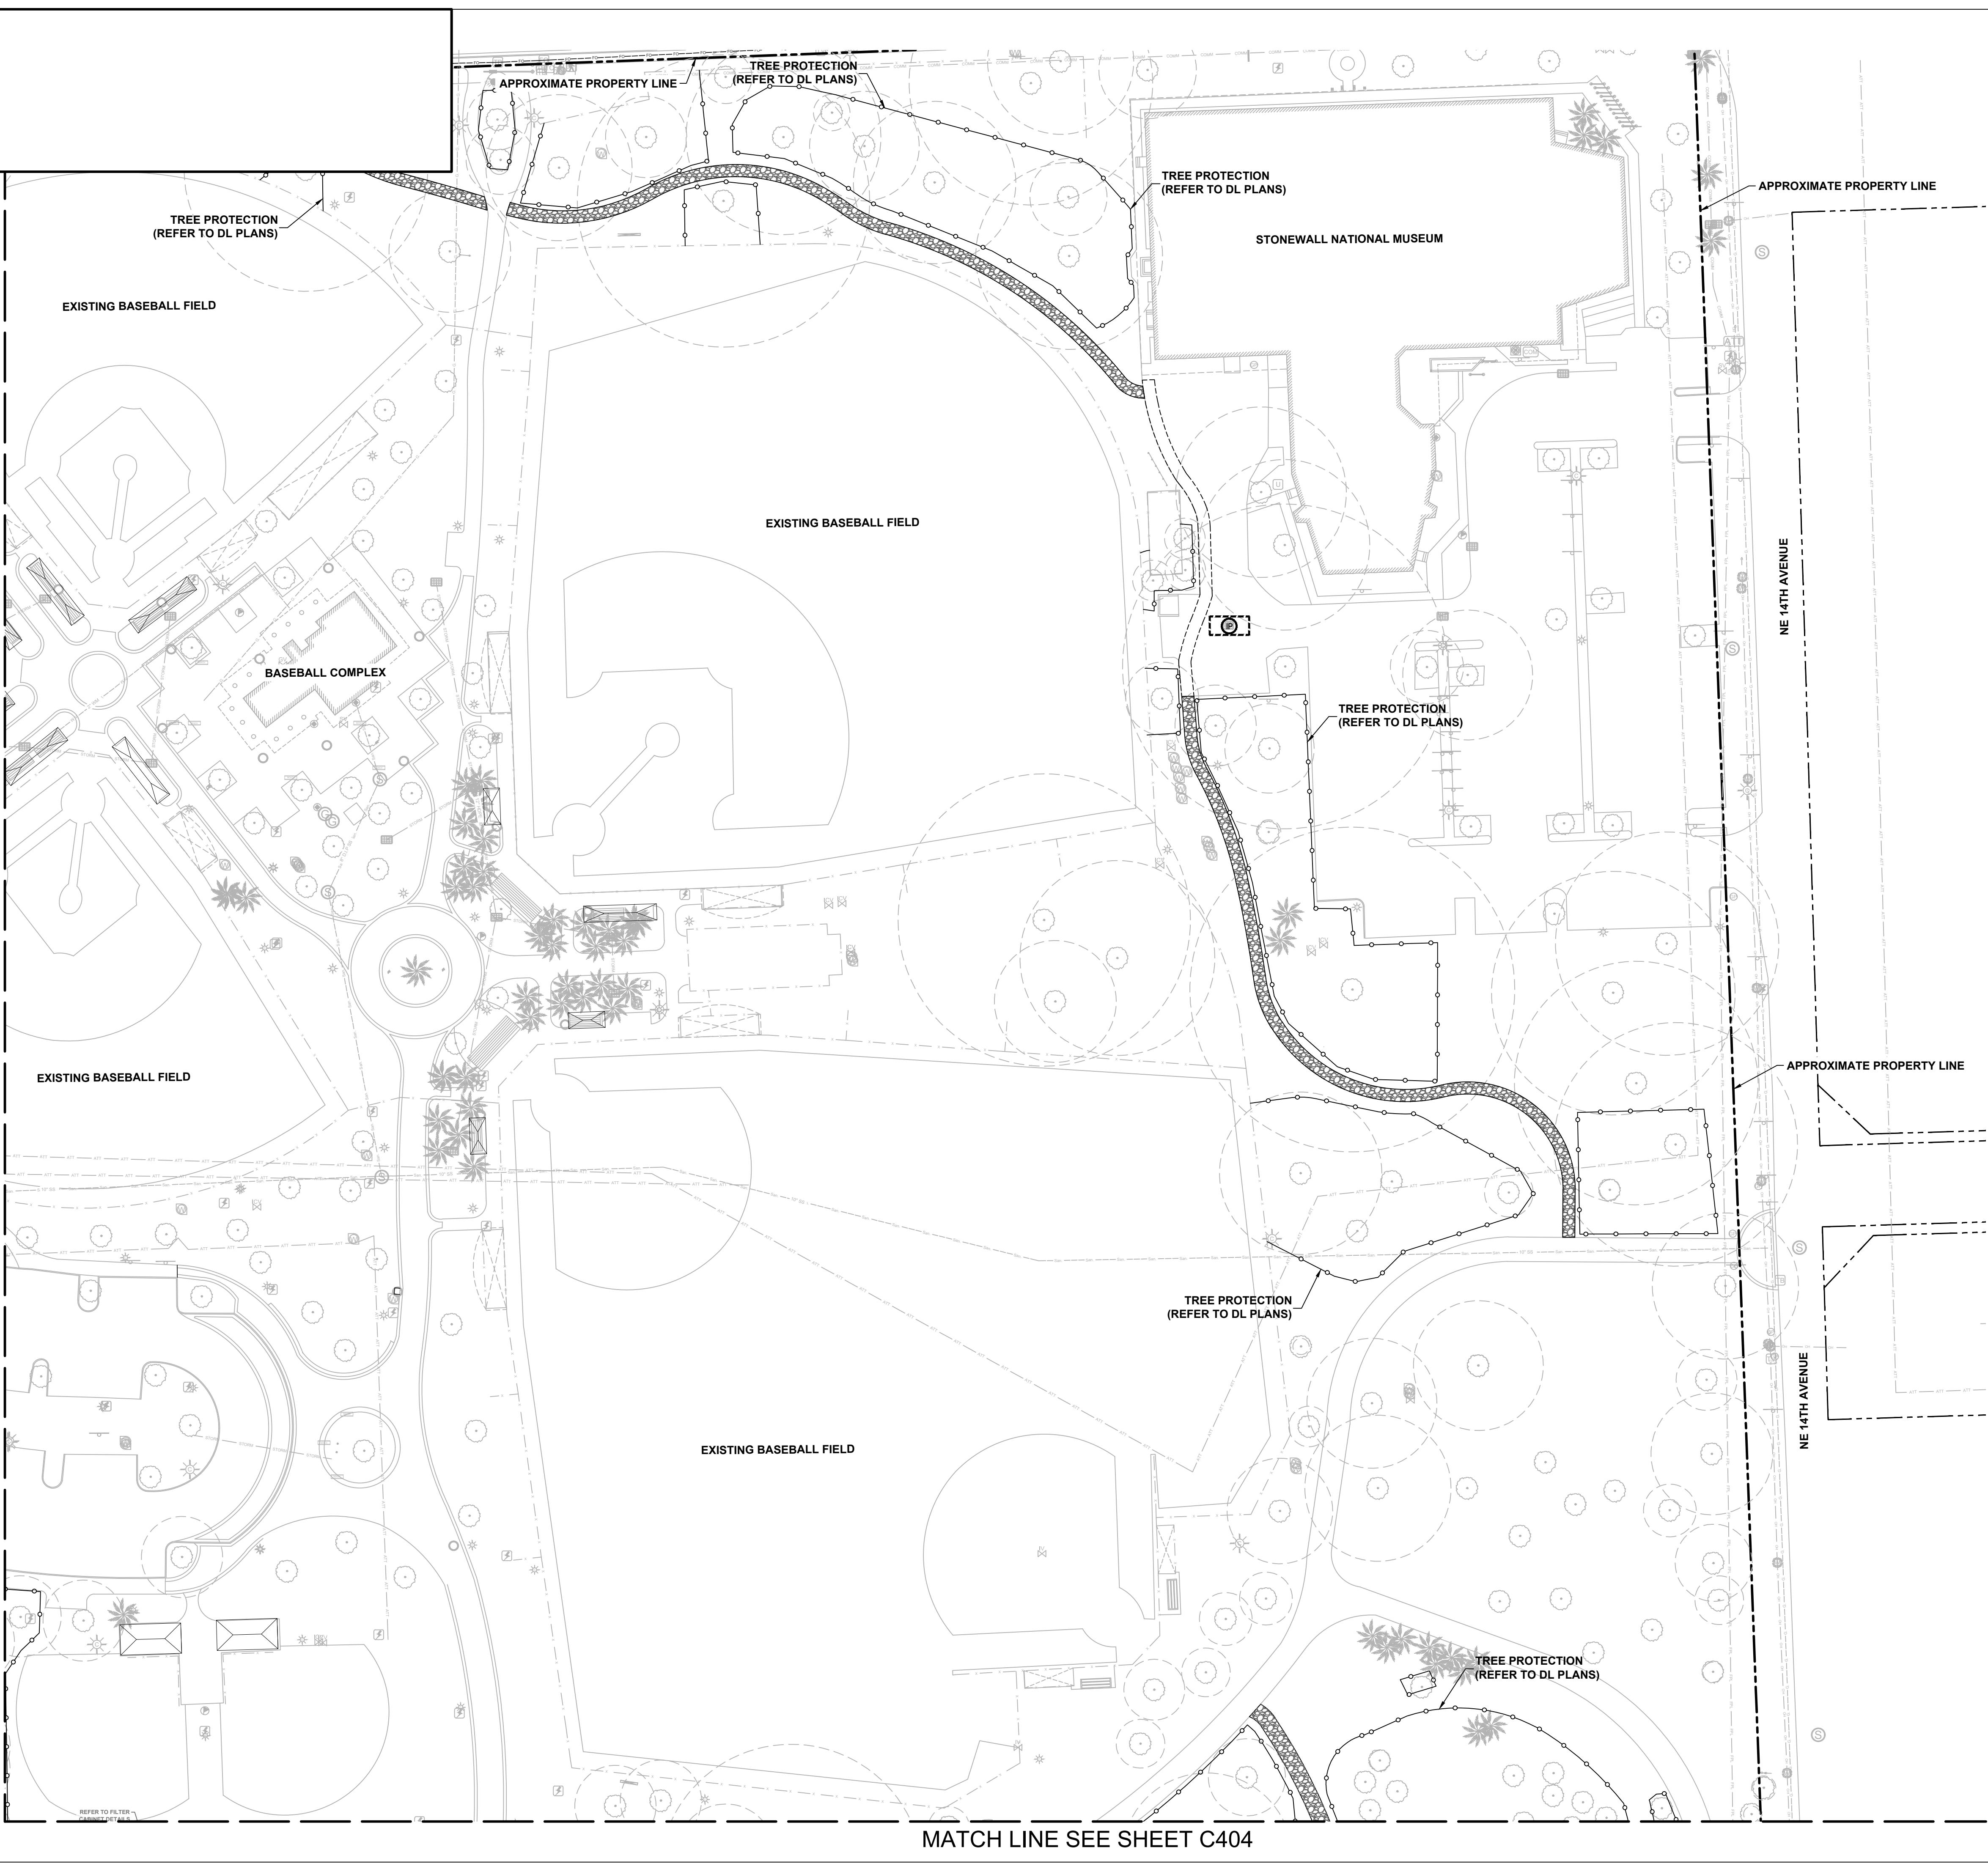
SHEET TITLE
EROSION CONTROL PLAN

SHEET NUMBER
C402

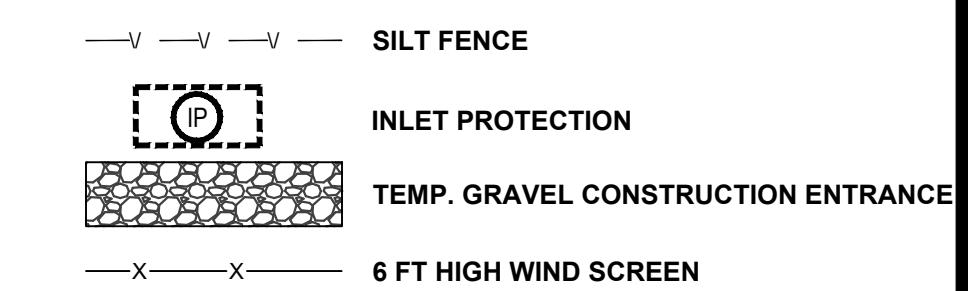
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ANSI D 24" x 36"

MATCH LINE SEE SHEET C401

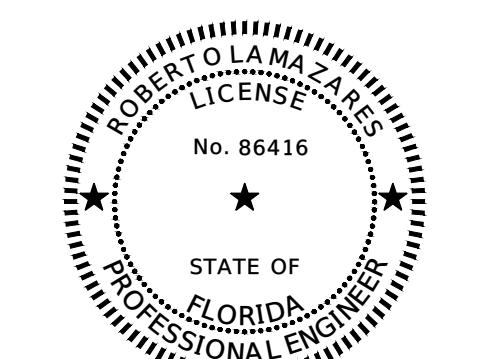


LEGEND



NOTE:

1. 6 FT HIGH WIND SCREEN SECTION LENGTHS OF 10 FT, GALVANIZED STEEL CONSTRUCTION, WITH BASE STAND. USE SAND BAGS AS NEEDED.
2. SEE G101 KEY PLAN FOR NOT IN CONTRACT (NIC) LIMIT OF WORK.
3. EXISTING RIGHT-OF-WAY INLETS WITHIN 100 FT OF THE PROPERTY SHALL BE PROTECTED.



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06/24/2025	PHASE 2 BID DOCUMENTS	

I/R DATE DESCRIPTION

PROJECT NUMBER

P12633

SHEET TITLE

EROSION CONTROL PLAN

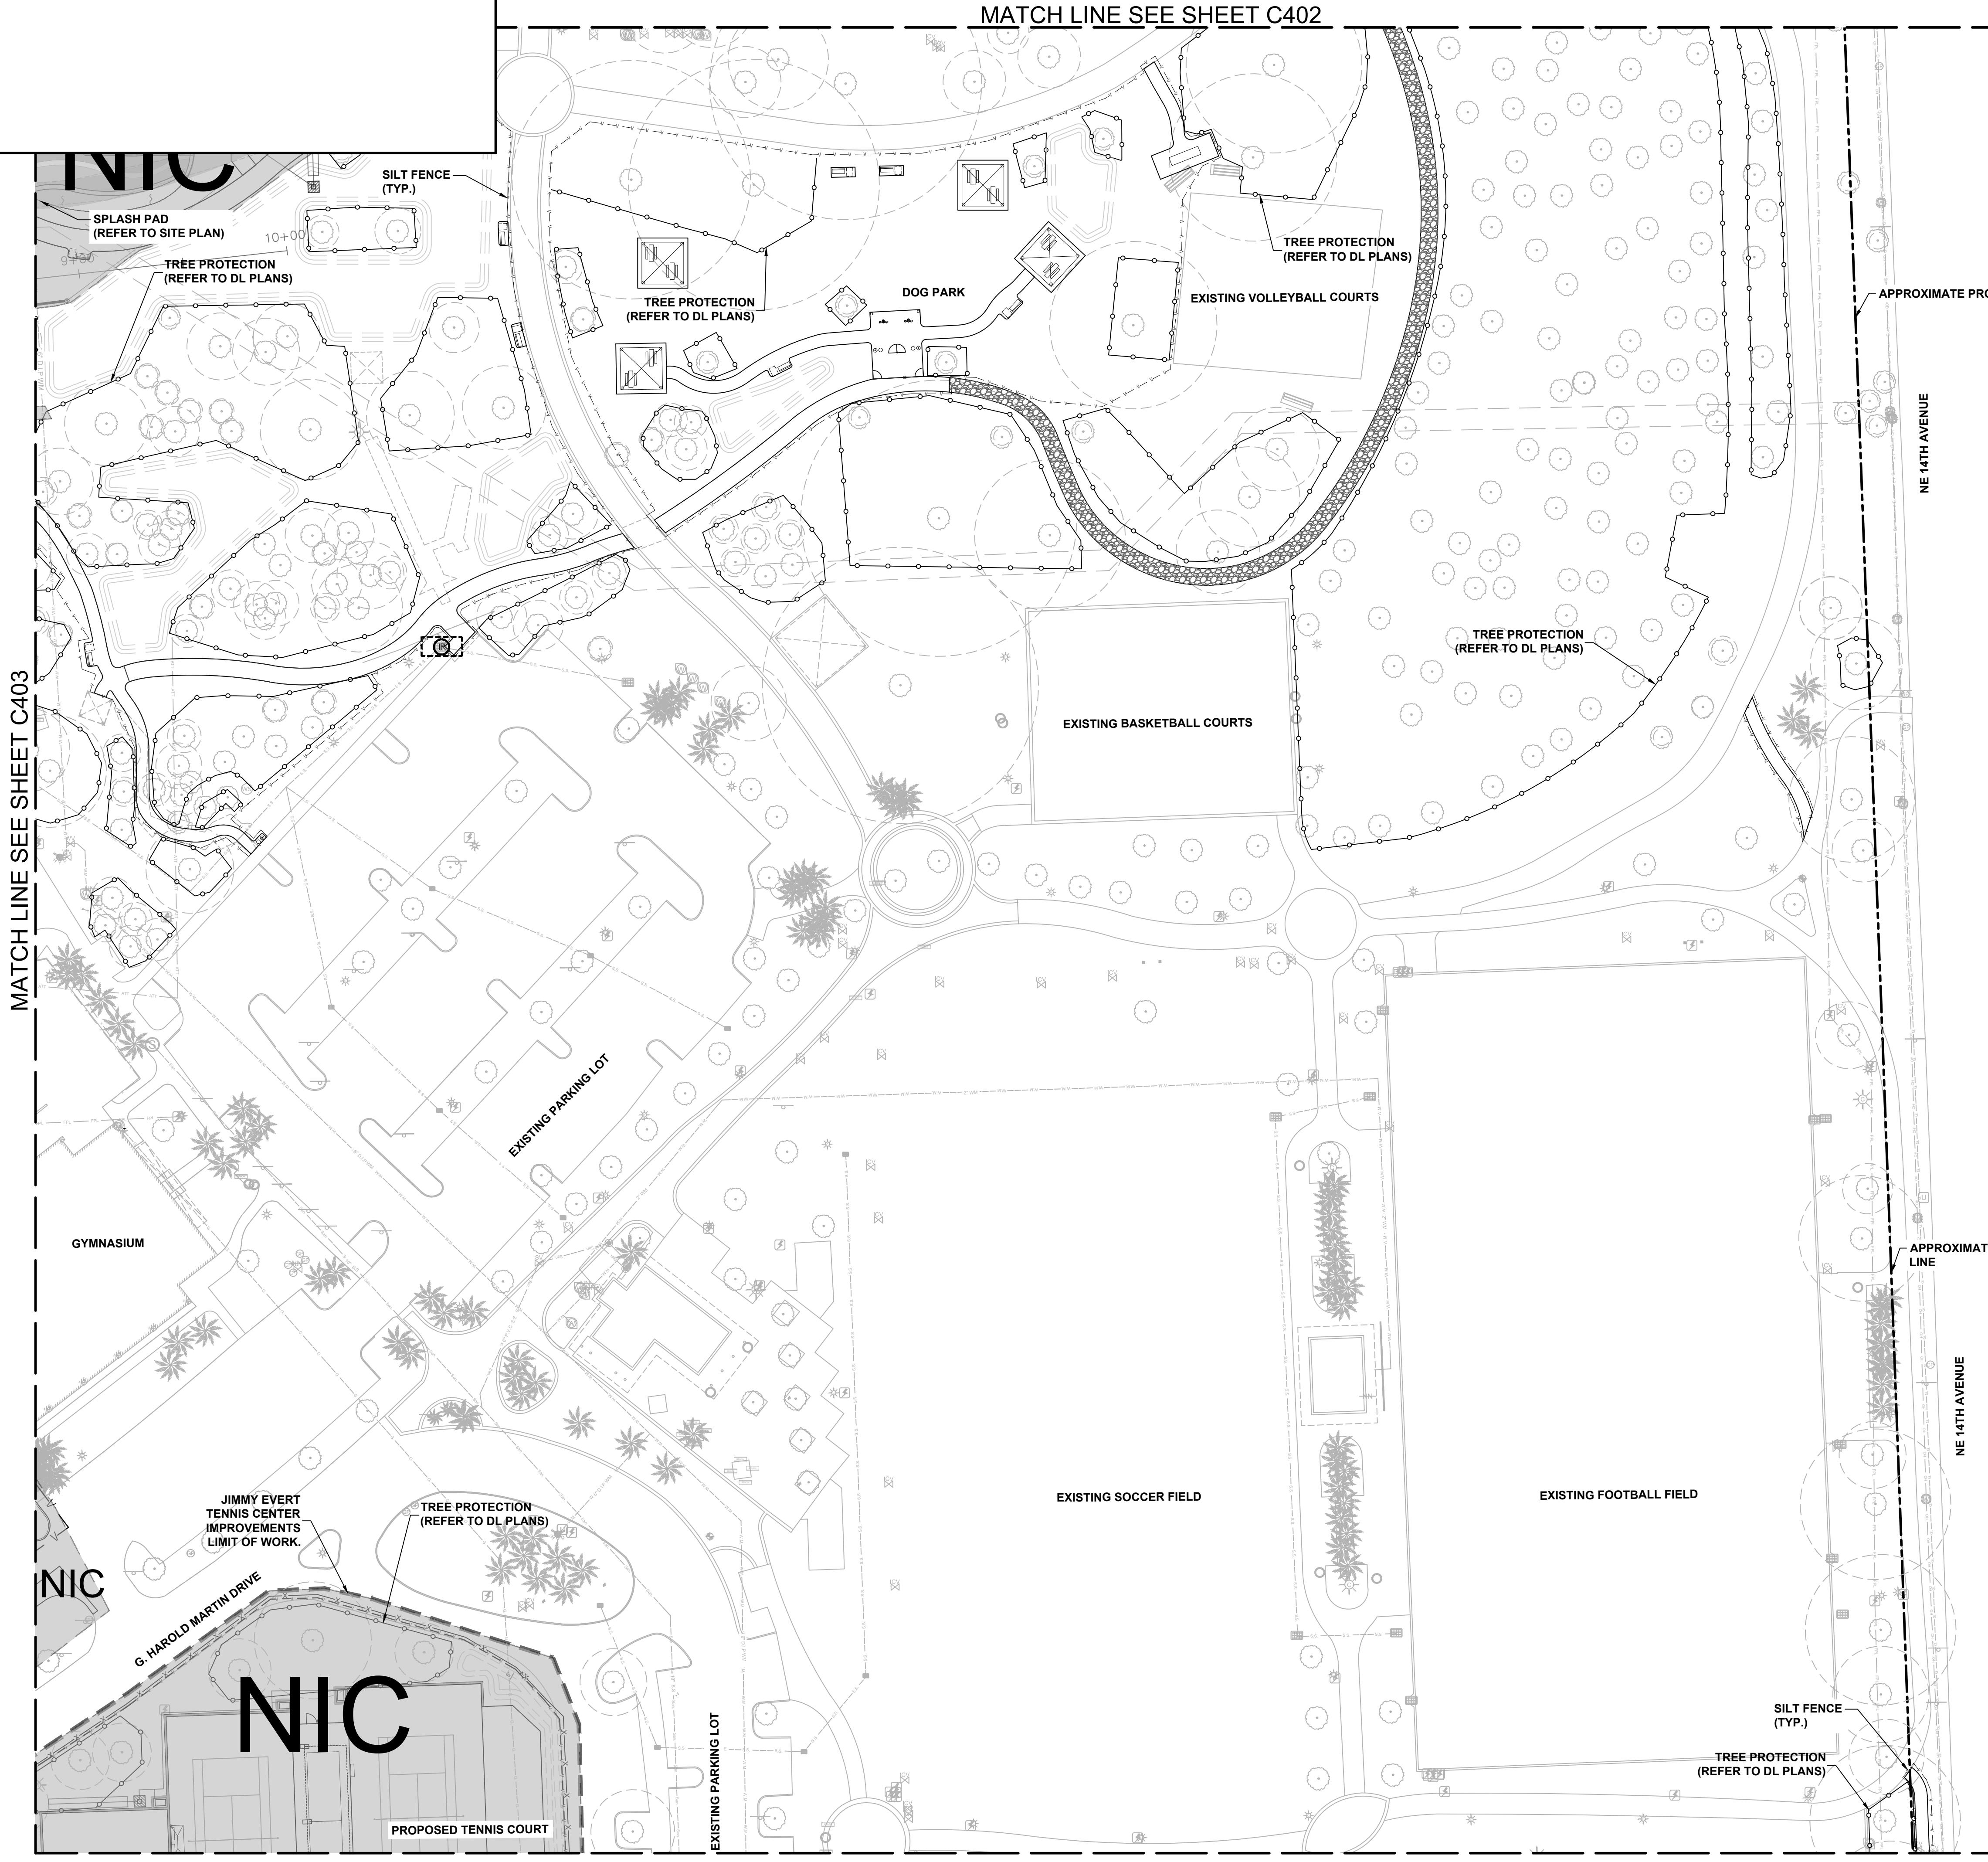
SHEET NUMBER

C404

COORDINATE WITH AECOM ON LATEST ISSUE OF DRAWINGS BEFORE COMMENCEMENT OF CONSTRUCTION
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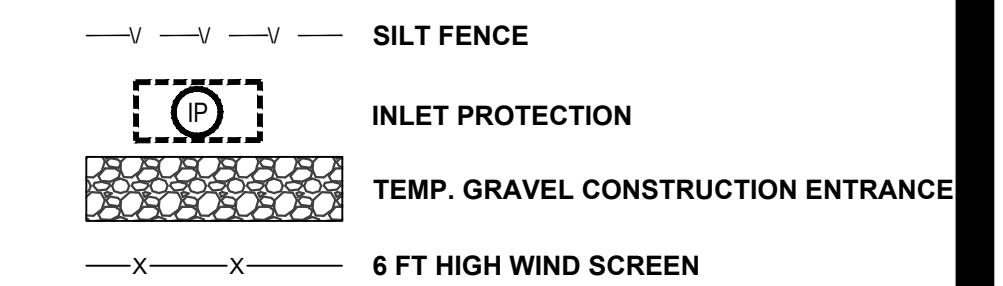
MATCH LINE SEE SHEET C403



MATCH LINE SEE SHEET C402

MATCH LINE SEE SHEET C406

LEGEND



NOTE:

1. 6 FT HIGH WIND SCREEN SECTION LENGTHS OF 10 FT, GALVANIZED STEEL CONSTRUCTION, WITH BASE STAND. USE SAND BAGS AS NEEDED.
2. SEE G101 KEY PLAN FOR NOT IN CONTRACT (NIC) LIMIT OF WORK.
3. EXISTING RIGHT-OF-WAY INLETS WITHIN 100 FT OF THE PROPERTY SHALL BE PROTECTED.

NE 14TH AVENUE

N

0 20' 40' 60' 80' 100' 120'

SCALE: 1" = 40'-0"

**SITE PLAN LEGEND**

EXISTING TREE TO REMAIN
-M-

MEMORIAL TREE

CANOPY AREA

CRITICAL ROOT ZONE

PAVING TYPES

A - 4" CONCRETE

C - 6" CONCRETE

**F - ASPHALT
(VEHICULAR USE)**

**M - SPORT COURTS
SURFACE**

**N - CLAY
(TENNIS COURTS)**

Q - CONCRETE PAVERS

S - RICE ROCK

10' FENCE

6' FENCE

4' FENCE

NOTES:

1. FIELD LOCATE ALL UTILITIES.
2. STAKE PROPOSED LAYOUT FOR ALL PROPOSED IMPROVEMENTS IN FIELD FOR APPROVAL BY LANDSCAPE ARCHITECT PRIOR TO CONSTRUCTION. NOTIFY LANDSCAPE ARCHITECT 48 HOURS PRIOR TO SITE VISIT.
3. TREE CANOPY AND CRITICAL ROOT ZONE LIMITS SHOWN ARE APPROXIMATE BASED ON SURVEY.

PROJECT
HOLIDAY PARK
FORT LAUDERDALE
PARKS BOND PROGRAM

CLIENT
PARKS & RECREATION
City of Fort Lauderdale

PRIME CONSULTANT
AECOM
7650 W. COURTNEY CAMPBELL CAUSEWAY
SUITE 700
TAMPA, FL 33607
813.286.1711 tel 813.287.8591 fax
www.aecom.com

SUB-CONSULTANT

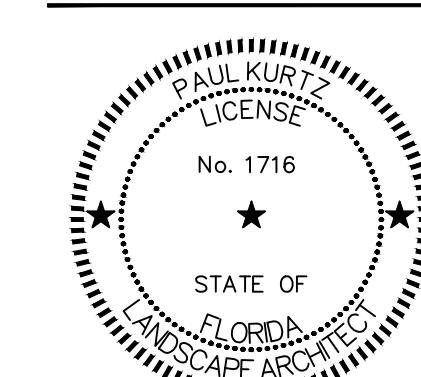
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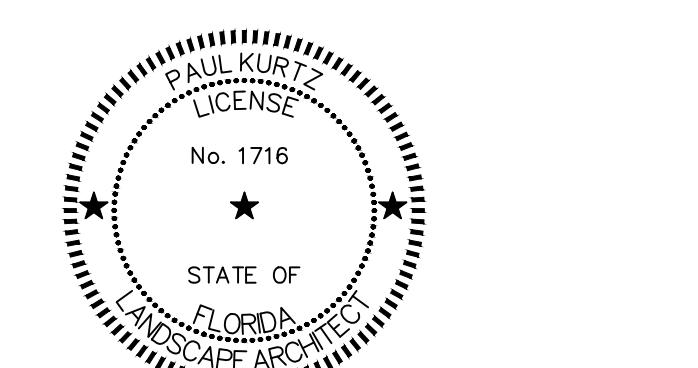
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PROJECT NUMBER

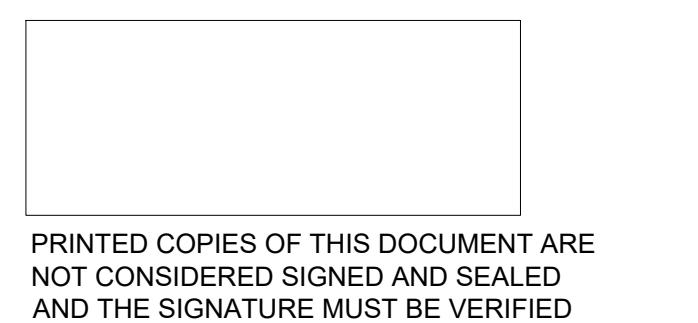
P12633

SHEET TITLE
LANDSCAPE SITE PLAN

SHEET NUMBER
L101



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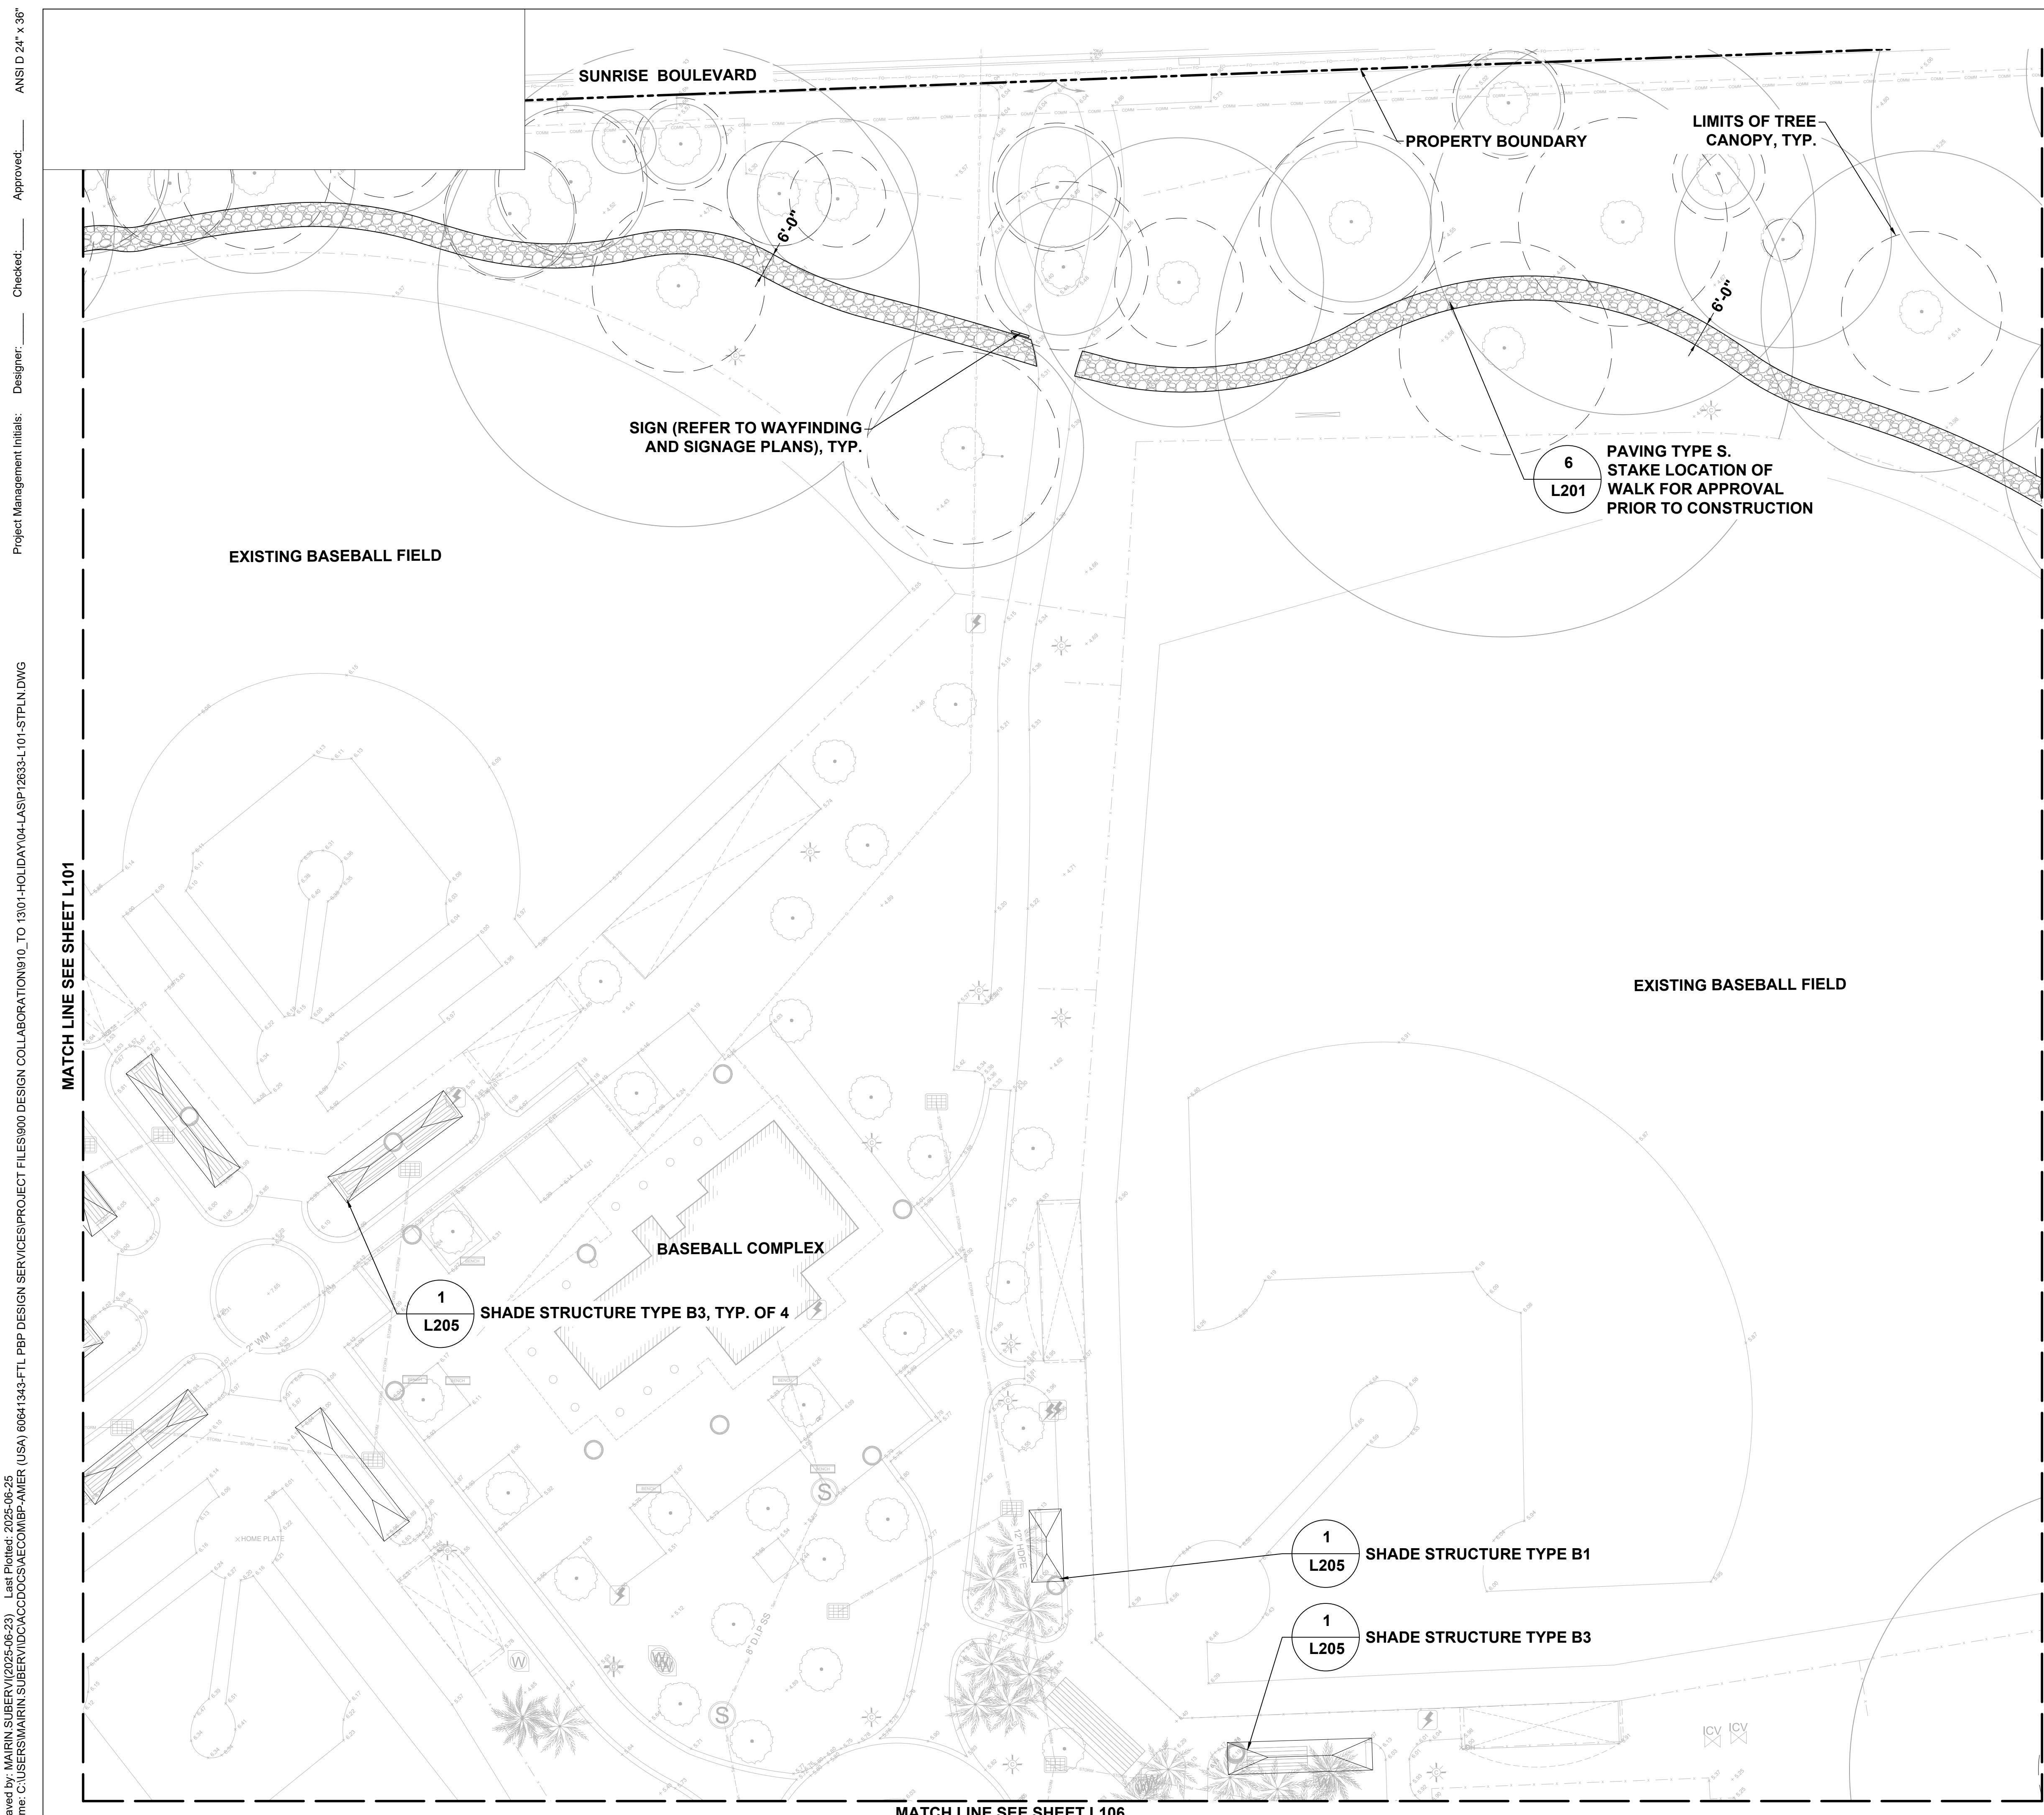
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SHEET TITLE
LANDSCAPE SITE PLAN

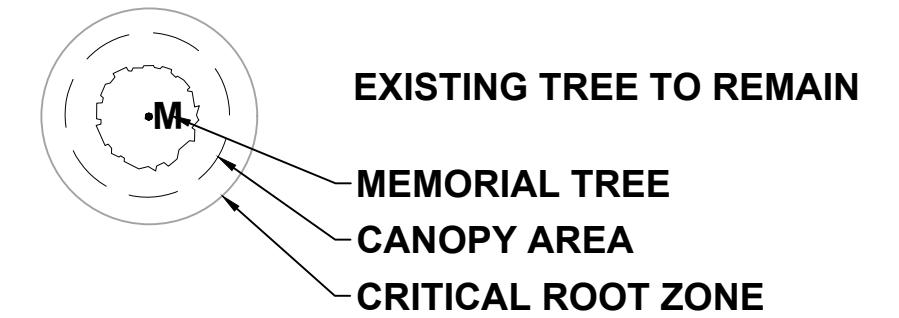
SHEET NUMBER

L102

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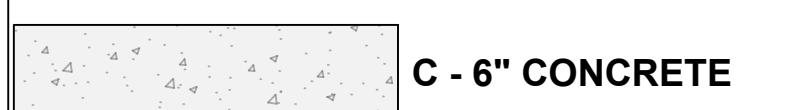
SITE PLAN LEGEND



PAVING TYPES



A - 4" CONCRETE



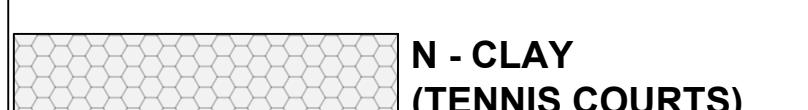
C - 6" CONCRETE



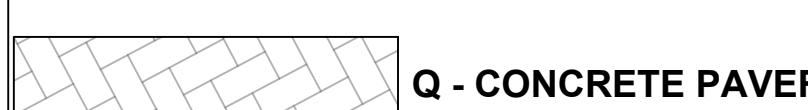
F - ASPHALT
(VEHICULAR USE)



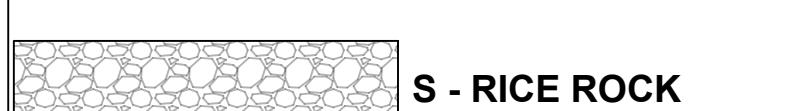
M - SPORT COURTS
SURFACE



N - CLAY
(TENNIS COURTS)



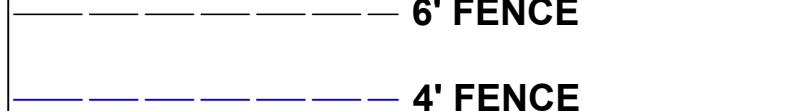
Q - CONCRETE PAVERS



S - RICE ROCK



10' FENCE



6' FENCE



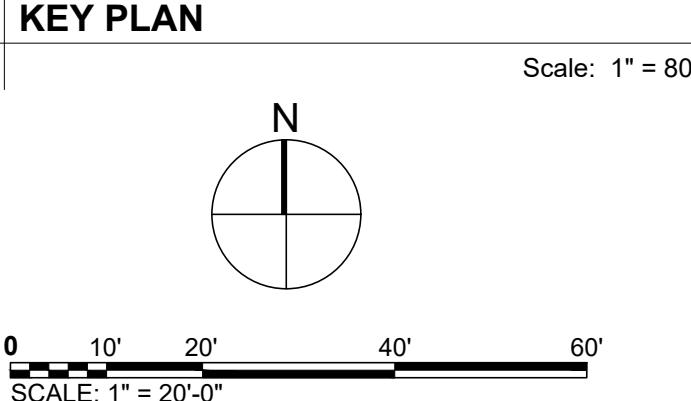
4' FENCE

NOTES:

1. FIELD LOCATE ALL UTILITIES.
2. STAKE PROPOSED LAYOUT FOR ALL PROPOSED IMPROVEMENTS IN FIELD FOR APPROVAL BY LANDSCAPE ARCHITECT PRIOR TO CONSTRUCTION. NOTIFY LANDSCAPE ARCHITECT 48 HOURS PRIOR TO SITE VISIT.
3. TREE CANOPY AND CRITICAL ROOT ZONE LIMITS SHOWN ARE APPROXIMATE BASED ON SURVEY.

MATCH LINE SEE SHEET L105

4 | KEY PLAN



Scale: 1" = 800'-0"

0 10' 20' 40' 60'

SCALE: 1" = 20'-0"

L104

N

MATCH LINE SEE SHEET L102

EXISTING BASEBALL FIELD

Last saved by: MAIRIN SUBERVI/2025-06-23 Last Plotted: 2025-06-23

Filename: C:\USERS\MAIRIN\SUBERVI\DC\ACCDocs\AECOM\BPF-AMER (USA) 60641343-FTL.PBF DESIGN SERVICE\PROJECT FILES\900 DESIGN COLLABORATION\910_TO_1301-HOLIDAY04-LAS\SP\12633-L101-STPLN.DWG

MATCH LINE SEE SHEET L105

SIGN (REFER TO WAYFINDING
AND SIGNAGE PLANS)

EXISTING BASEBALL FIELD

MATCH LINE SEE SHEET L110

1

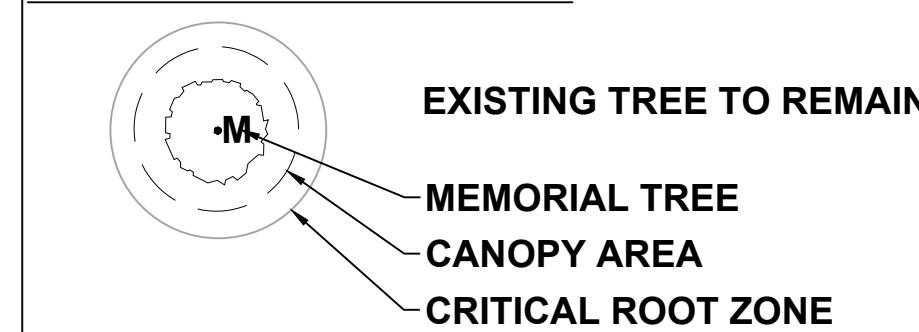
L205

SHADE STRUCTURE TYPE B4

1
L205
SHADE STRUCTURE TYPE B1, TYP. OF 2

MATCH LINE SEE SHEET L107

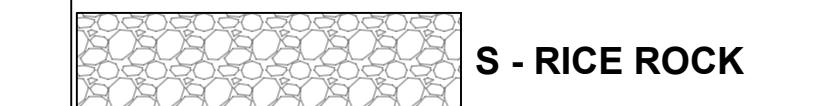
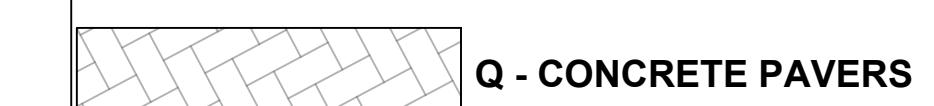
SITE PLAN LEGEND



PAVING TYPES



C - 6" CONCRETE



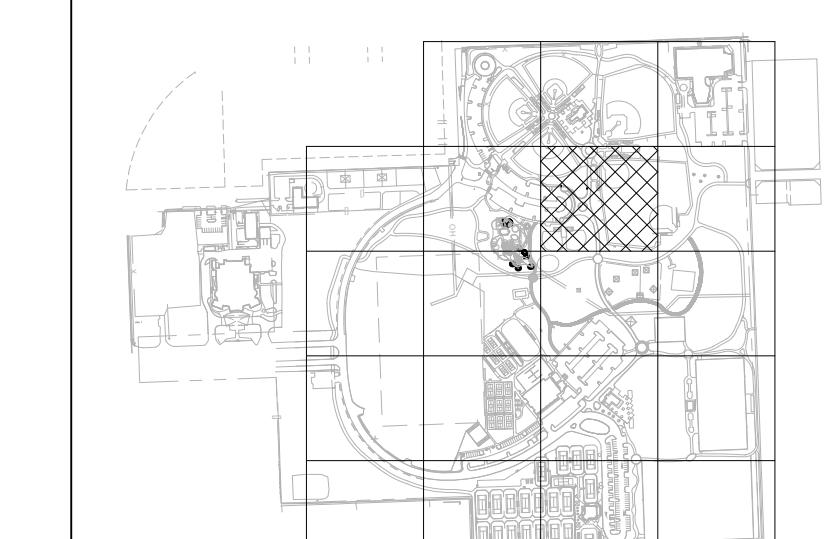
10' FENCE

6' FENCE

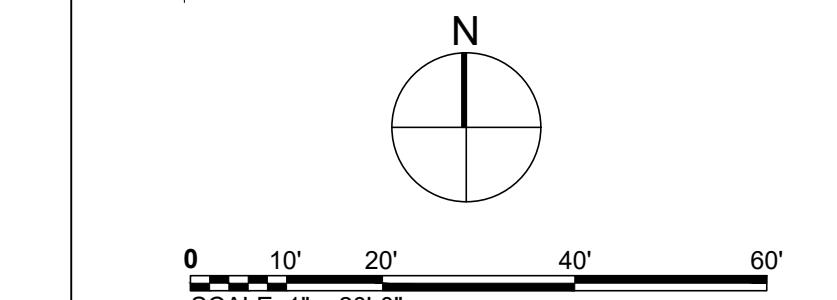
4' FENCE

NOTES:

1. FIELD LOCATE ALL UTILITIES.
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3. TREE CANOPY AND CRITICAL ROOT ZONE LIMITS SHOWN ARE APPROXIMATE BASED ON SURVEY.

6
KEY PLAN

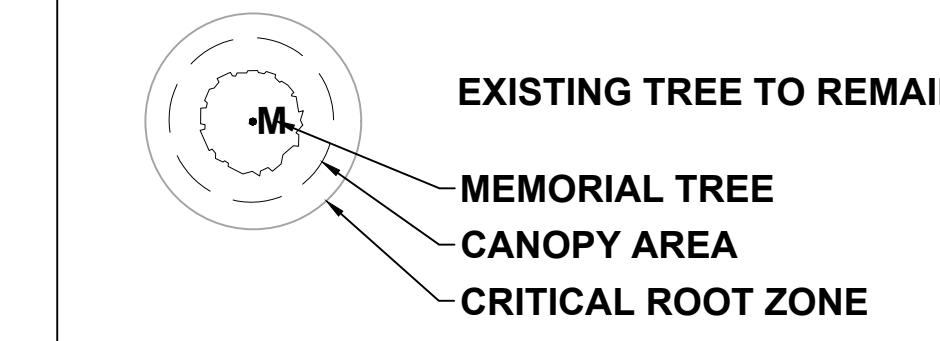
L106 Scale: 1" = 800'-0"



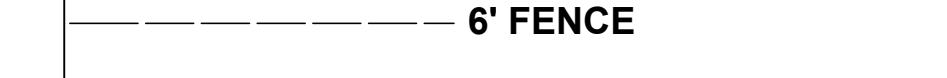
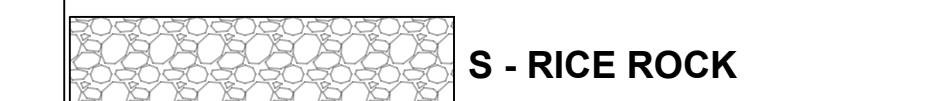
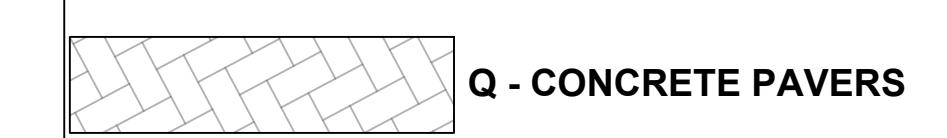
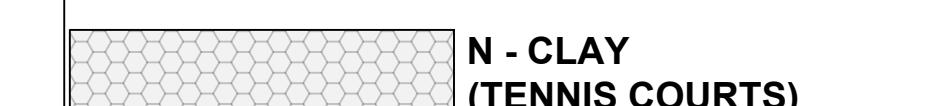
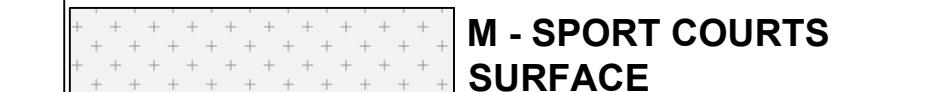
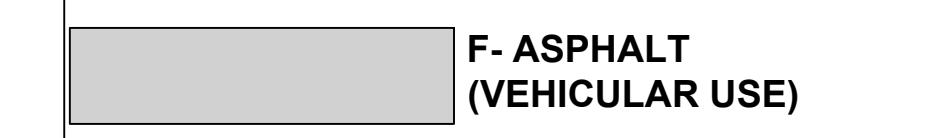
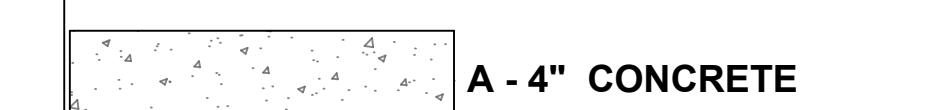
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SCALE: 1" = 20'-0"

SITE PLAN LEGEND

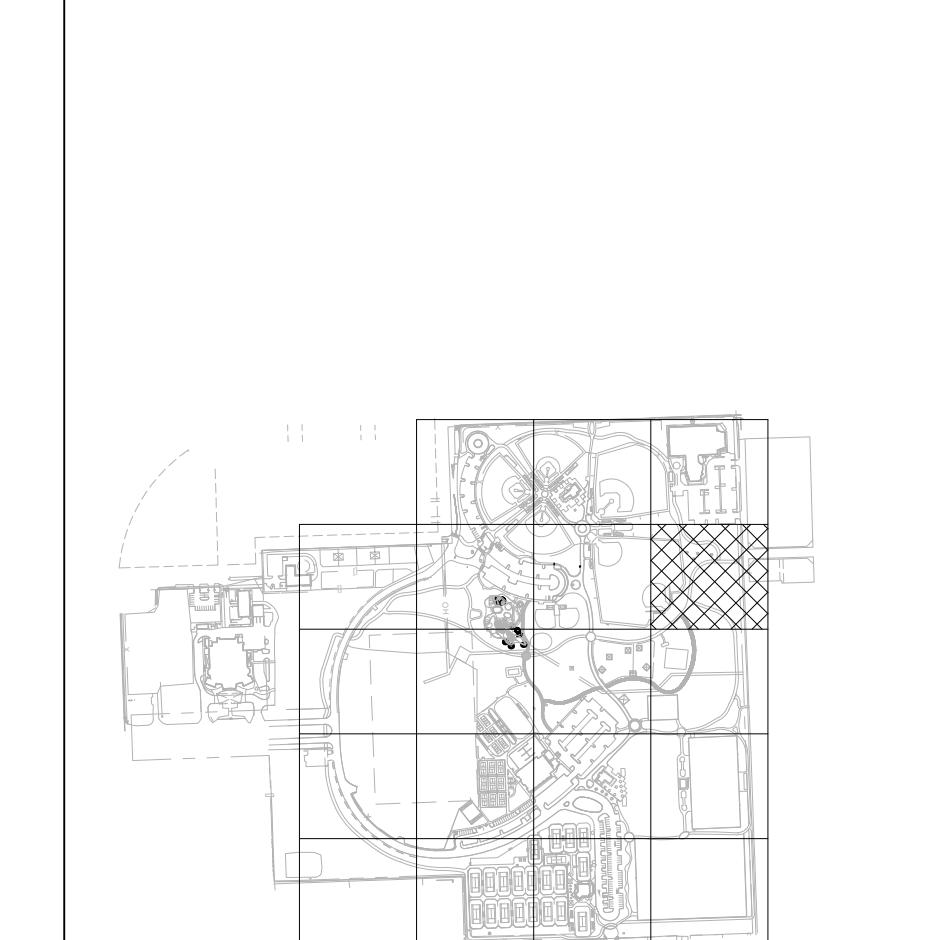


PAVING TYPES

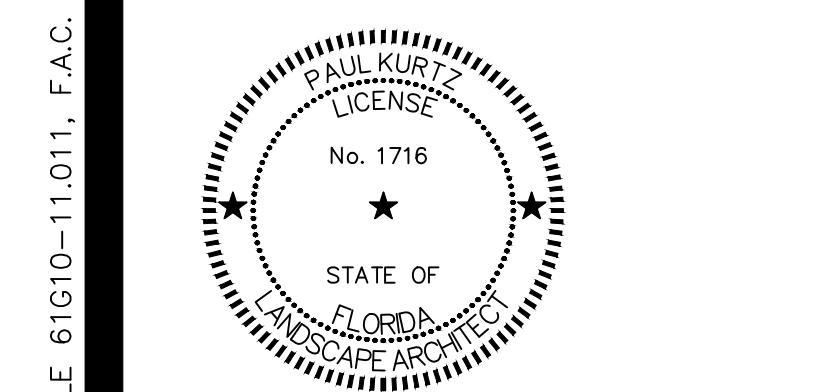
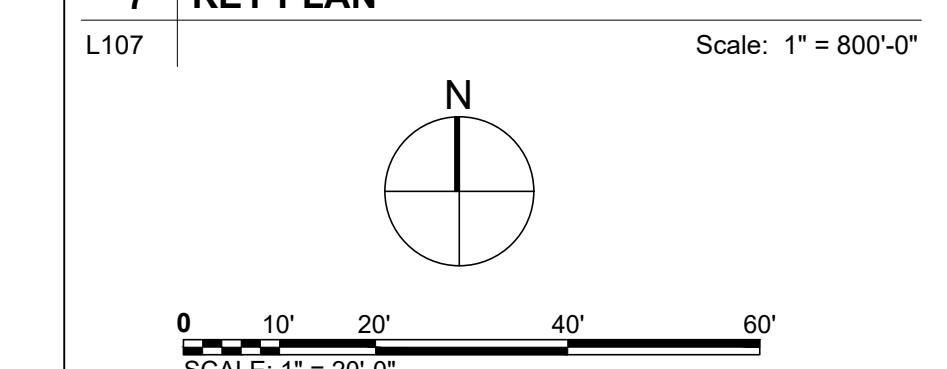


NOTES:

1. FIELD LOCATE ALL UTILITIES.
2. STAKE PROPOSED LAYOUT FOR ALL PROPOSED IMPROVEMENTS IN FIELD FOR APPROVAL BY LANDSCAPE ARCHITECT PRIOR TO CONSTRUCTION. NOTIFY LANDSCAPE ARCHITECT 48 HOURS PRIOR TO SITE VISIT.
3. TREE CANOPY AND CRITICAL ROOT ZONE LIMITS SHOWN ARE APPROXIMATE BASED ON SURVEY.



7 KEY PLAN



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Tampa, FL 33607-1462

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06/24/2025	PHASE 2 BID DOCUMENTS
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PROJECT NUMBER

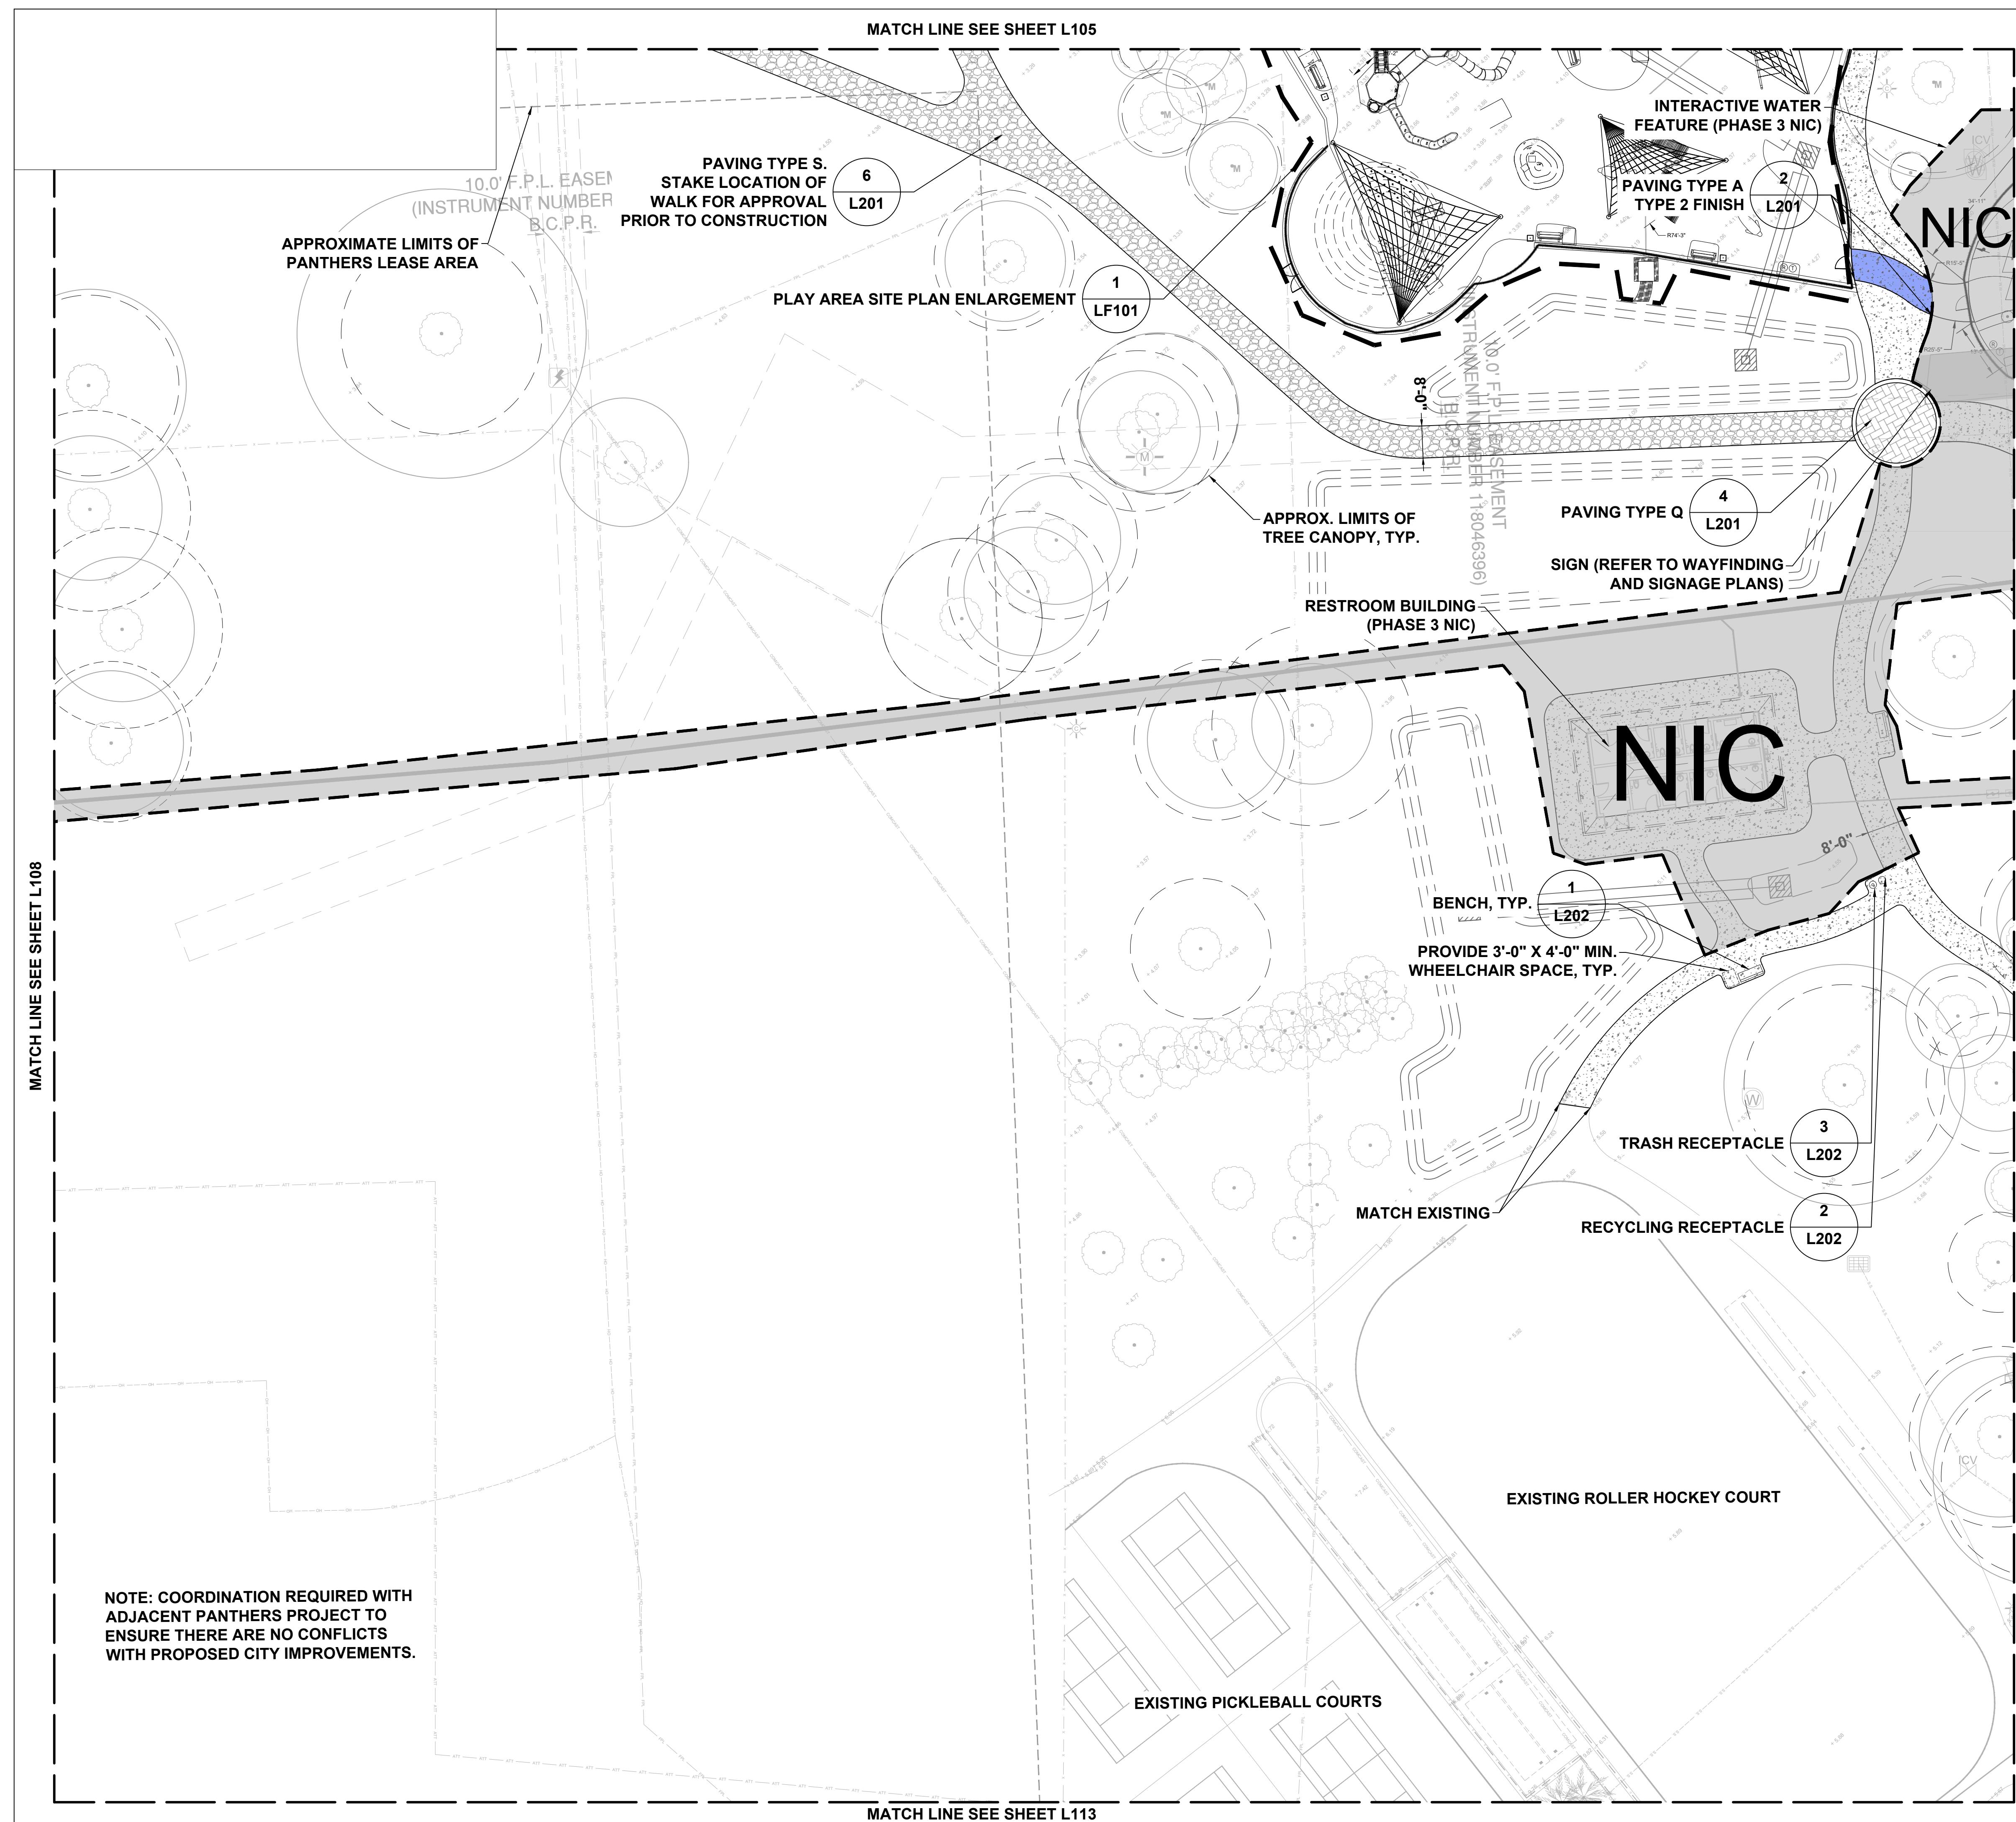
P12633

SHEET TITLE

LANDSCAPE SITE PLAN

SHEET NUMBER

L107



SITE PLAN LEGEND

EXISTING TREE TO REMAIN
MEMORIAL TREE
CANOPY AREA
CRITICAL ROOT ZONE

PAVING TYPES

A - 4" CONCRETE

C - 6" CONCRETE

F - ASPHALT (VEHICULAR USE)

M - SPORT COURTS SURFACE

N - CLAY (TENNIS COURTS)

Q - CONCRETE PAVERS

S - RICE ROCK

10' FENCE

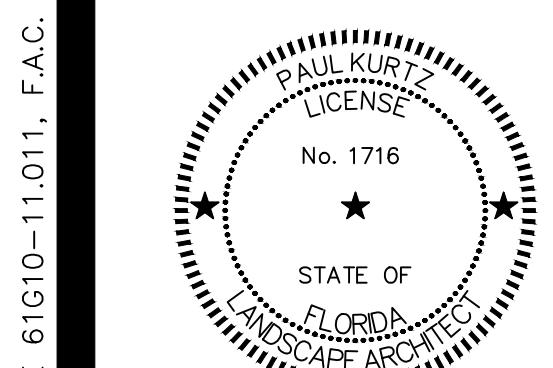
6' FENCE

4' FENCE

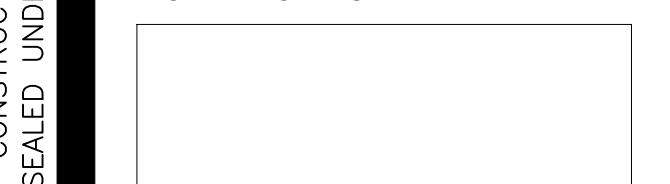
NOTES:

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- SEE G101 KEY PLAN FOR NOT IN CONTRACT (NIC) LIMIT OF WORK.

DESIGN INTENT FOR
PAVING TYPE A
TYPE 2 FINISH



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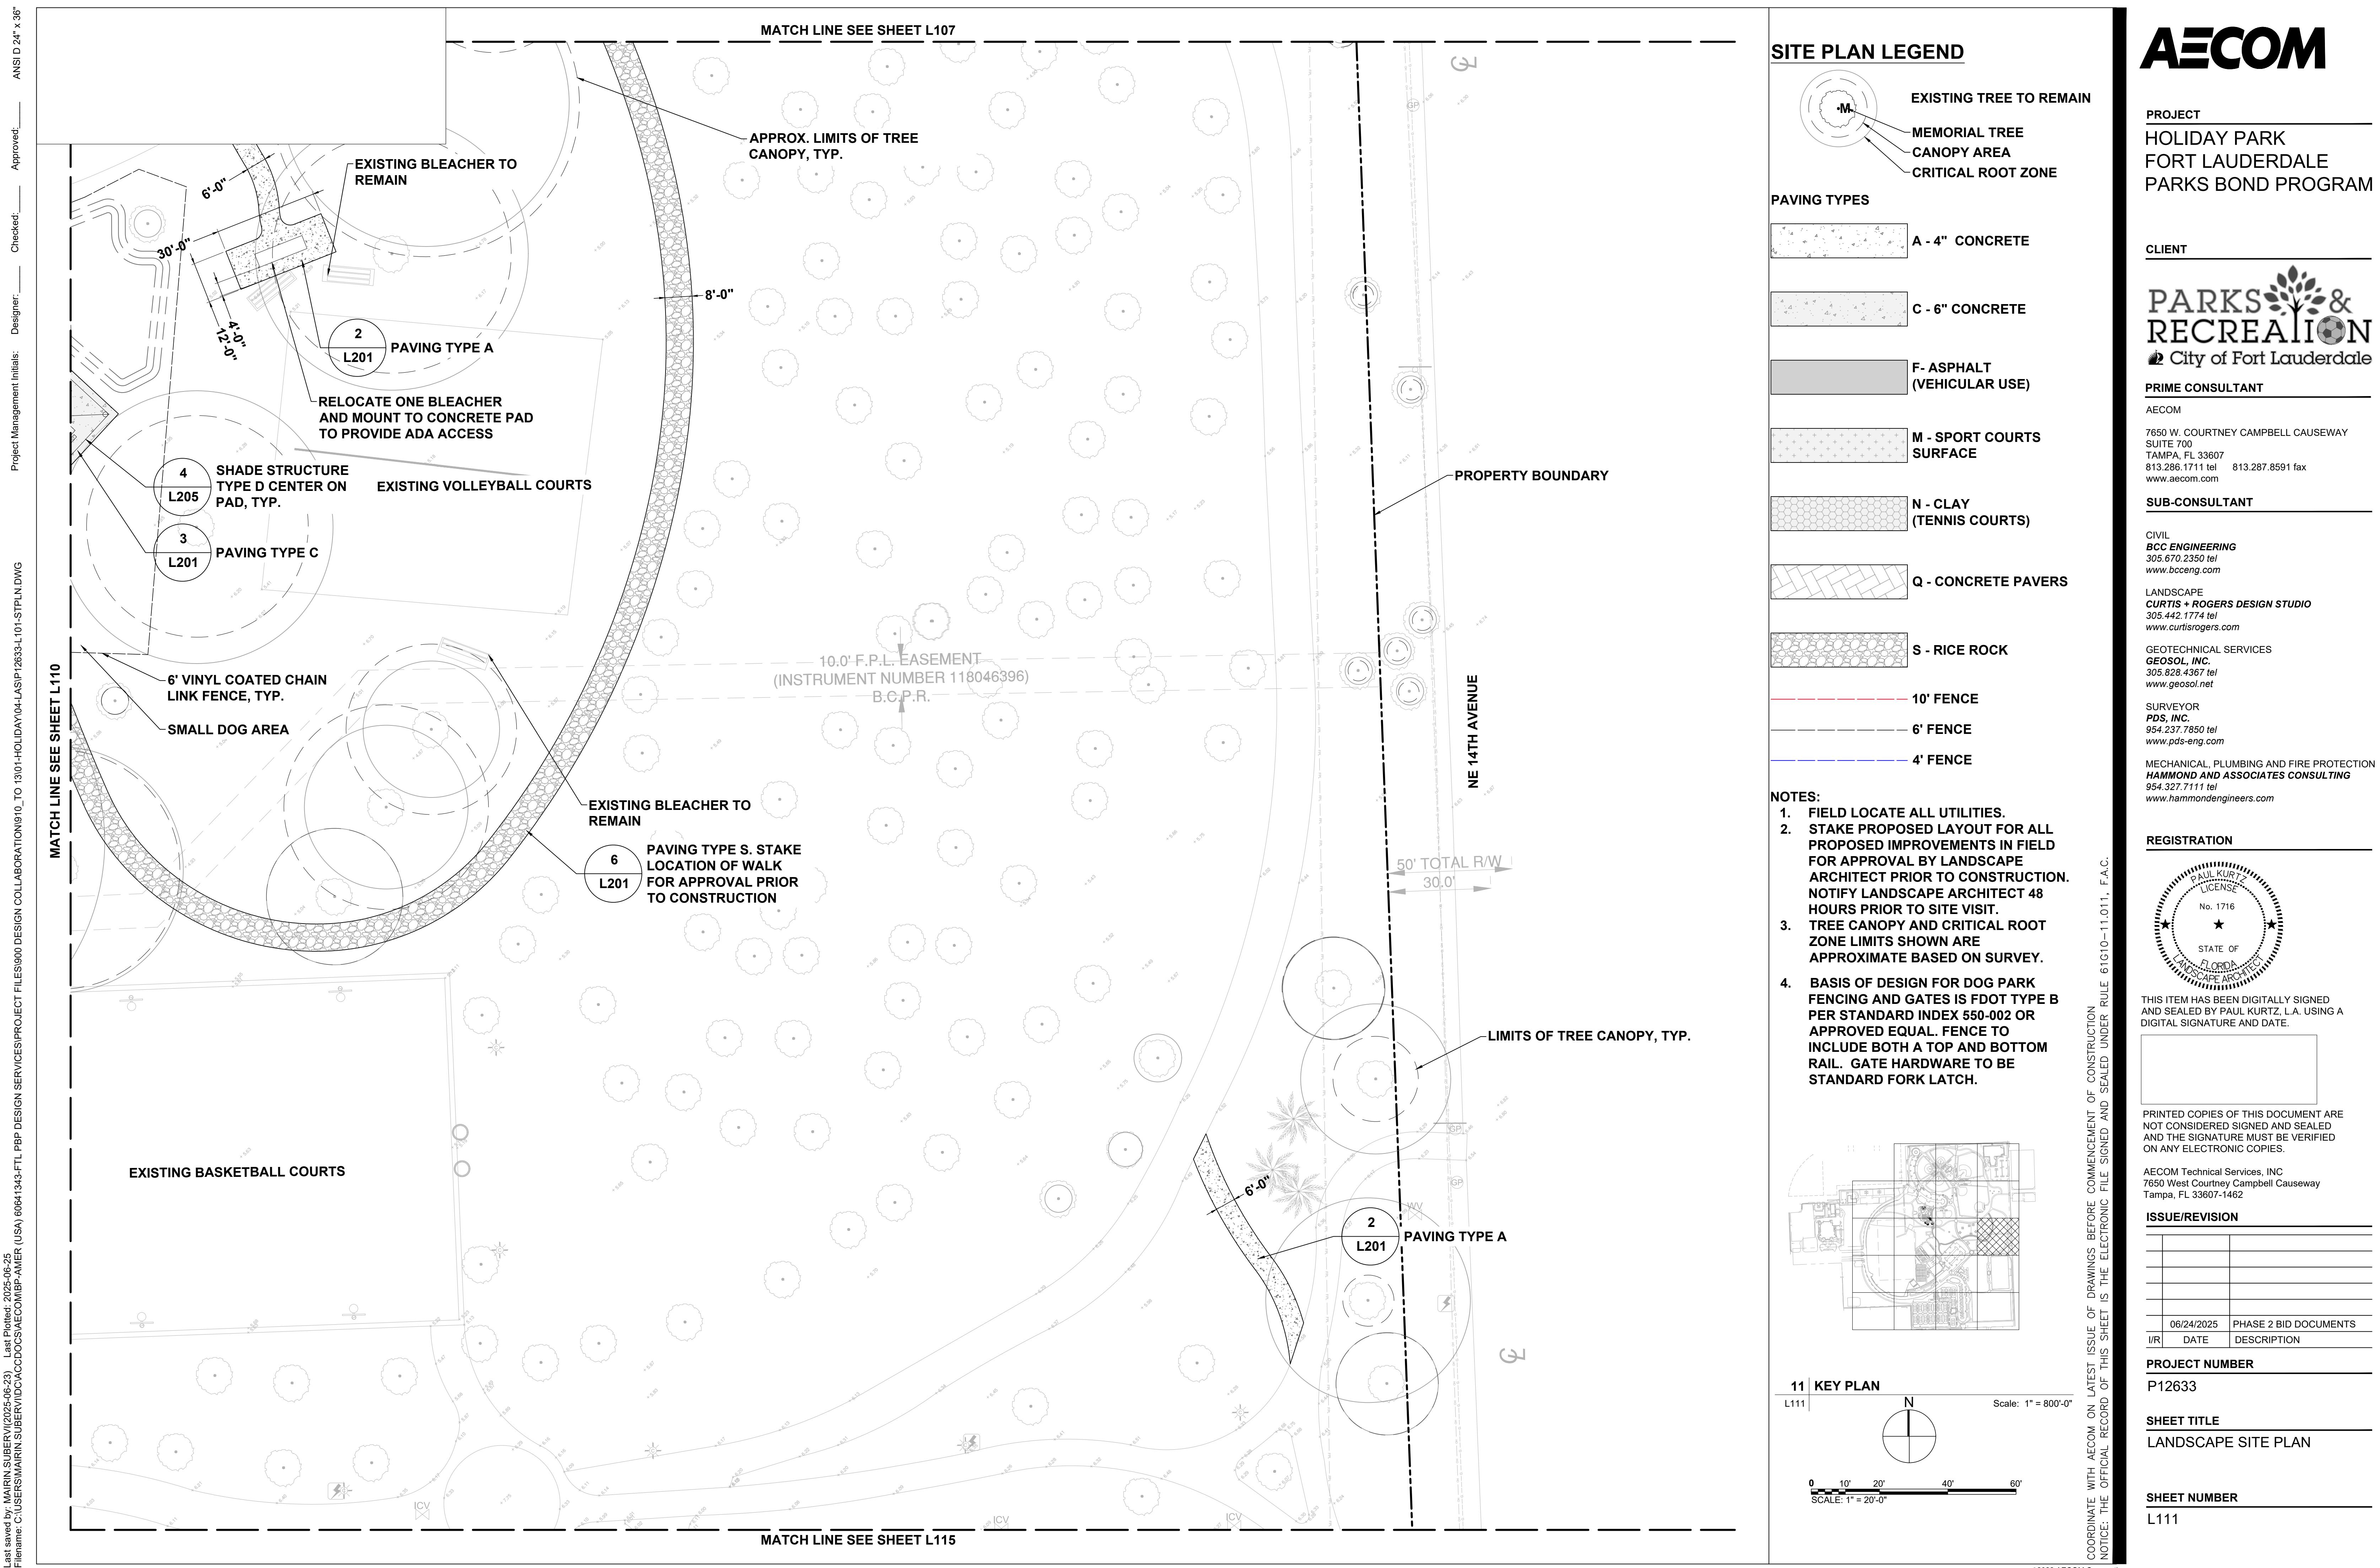
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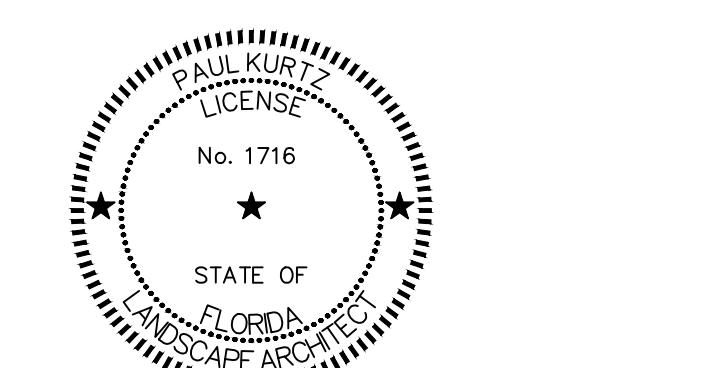
SHEET TITLE

LANDSCAPE SITE PLAN

SHEET NUMBER

L109





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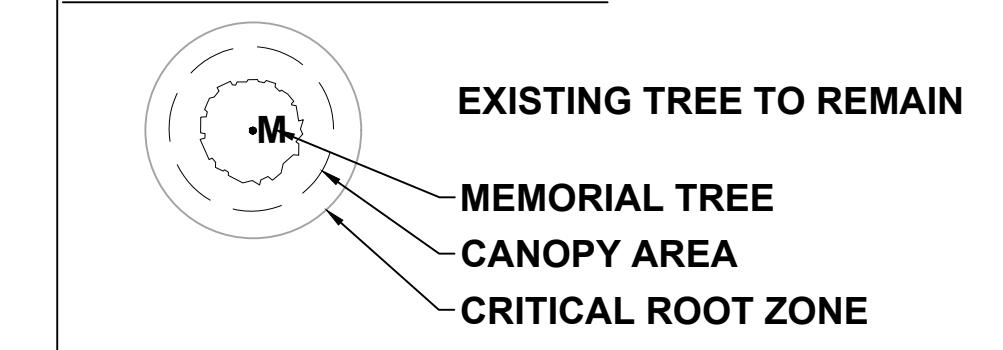
PROJECT NUMBER
P12633

SHEET TITLE
LANDSCAPE SITE PLAN

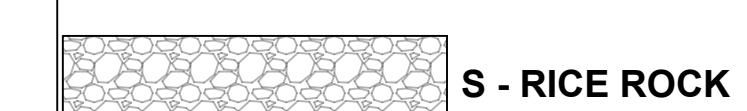
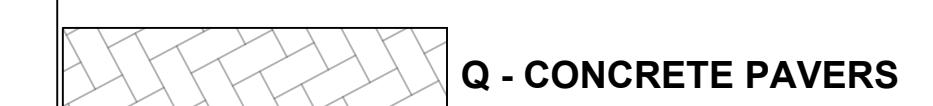
SHEET NUMBER
L113

COORDINATE WITH AECOM ON LATEST ISSUE OF DRAWINGS BEFORE COMMENCEMENT OF CONSTRUCTION
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SITE PLAN LEGEND



PAVING TYPES



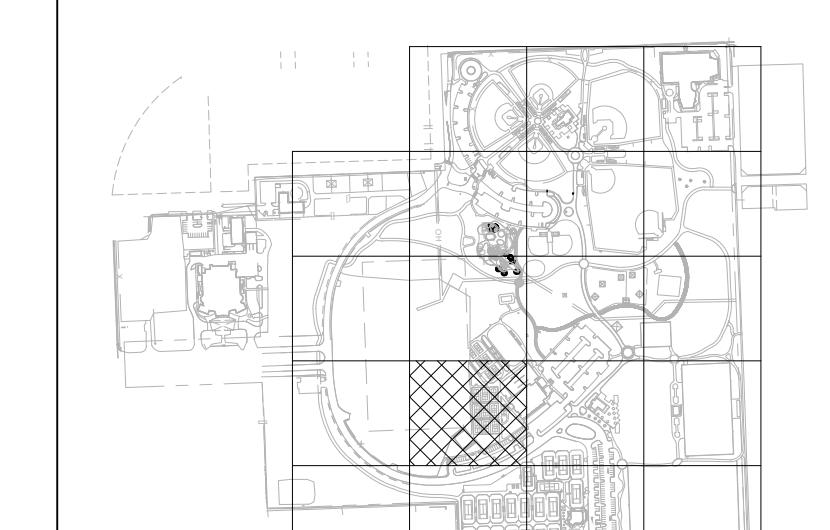
10' FENCE

6' FENCE

4' FENCE

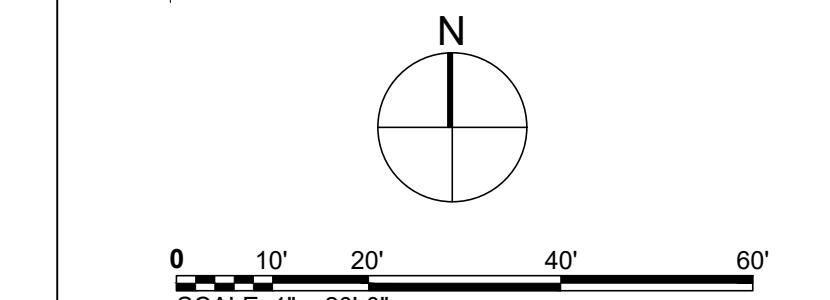
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4. SEE G101 KEY PLAN FOR NOT IN CONTRACT (NIC) LIMIT OF WORK.



13 KEY PLAN

L113 Scale: 1" = 800'-0"



0 10' 20' 40' 60' Scale: 1" = 20'-0"

ANSI D 24" x 36"
Approved: _____
Designer: _____ Checked: _____
Project Management Initials: _____

NOTE: COORDINATION REQUIRED WITH ADJACENT PANTHERS PROJECT TO ENSURE THERE ARE NO CONFLICTS WITH PROPOSED CITY IMPROVEMENTS.

APPROXIMATE LIMITS OF PANTHERS LEASE AREA

PICKLEBALL (PHASE 3 NIC)

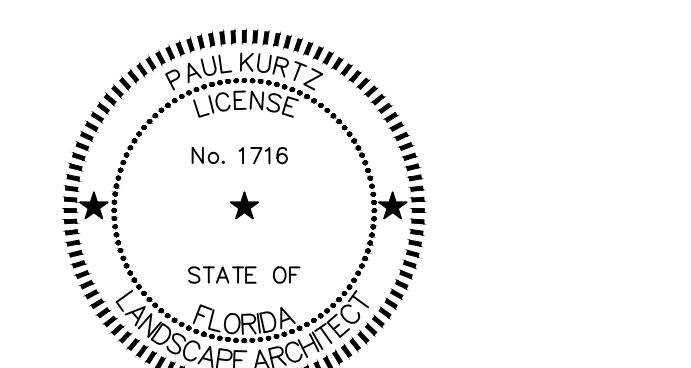
EXISTING PICKLEBALL COURTS

EXISTING RACQUETBALL COURTS

EXISTING GYMNASIUM

NIC

COORDINATION REQUIRED WITH
ADJACENT JETC DEVELOPMENT TO
ENSURE THERE ARE NO CONFLICTS WITH
PROPOSED PROJECT IMPROVEMENTS
JIMMY EVERETT TENNIS CENTER (JETC)
IMPROVEMENTS LIMIT OF WORK NIC



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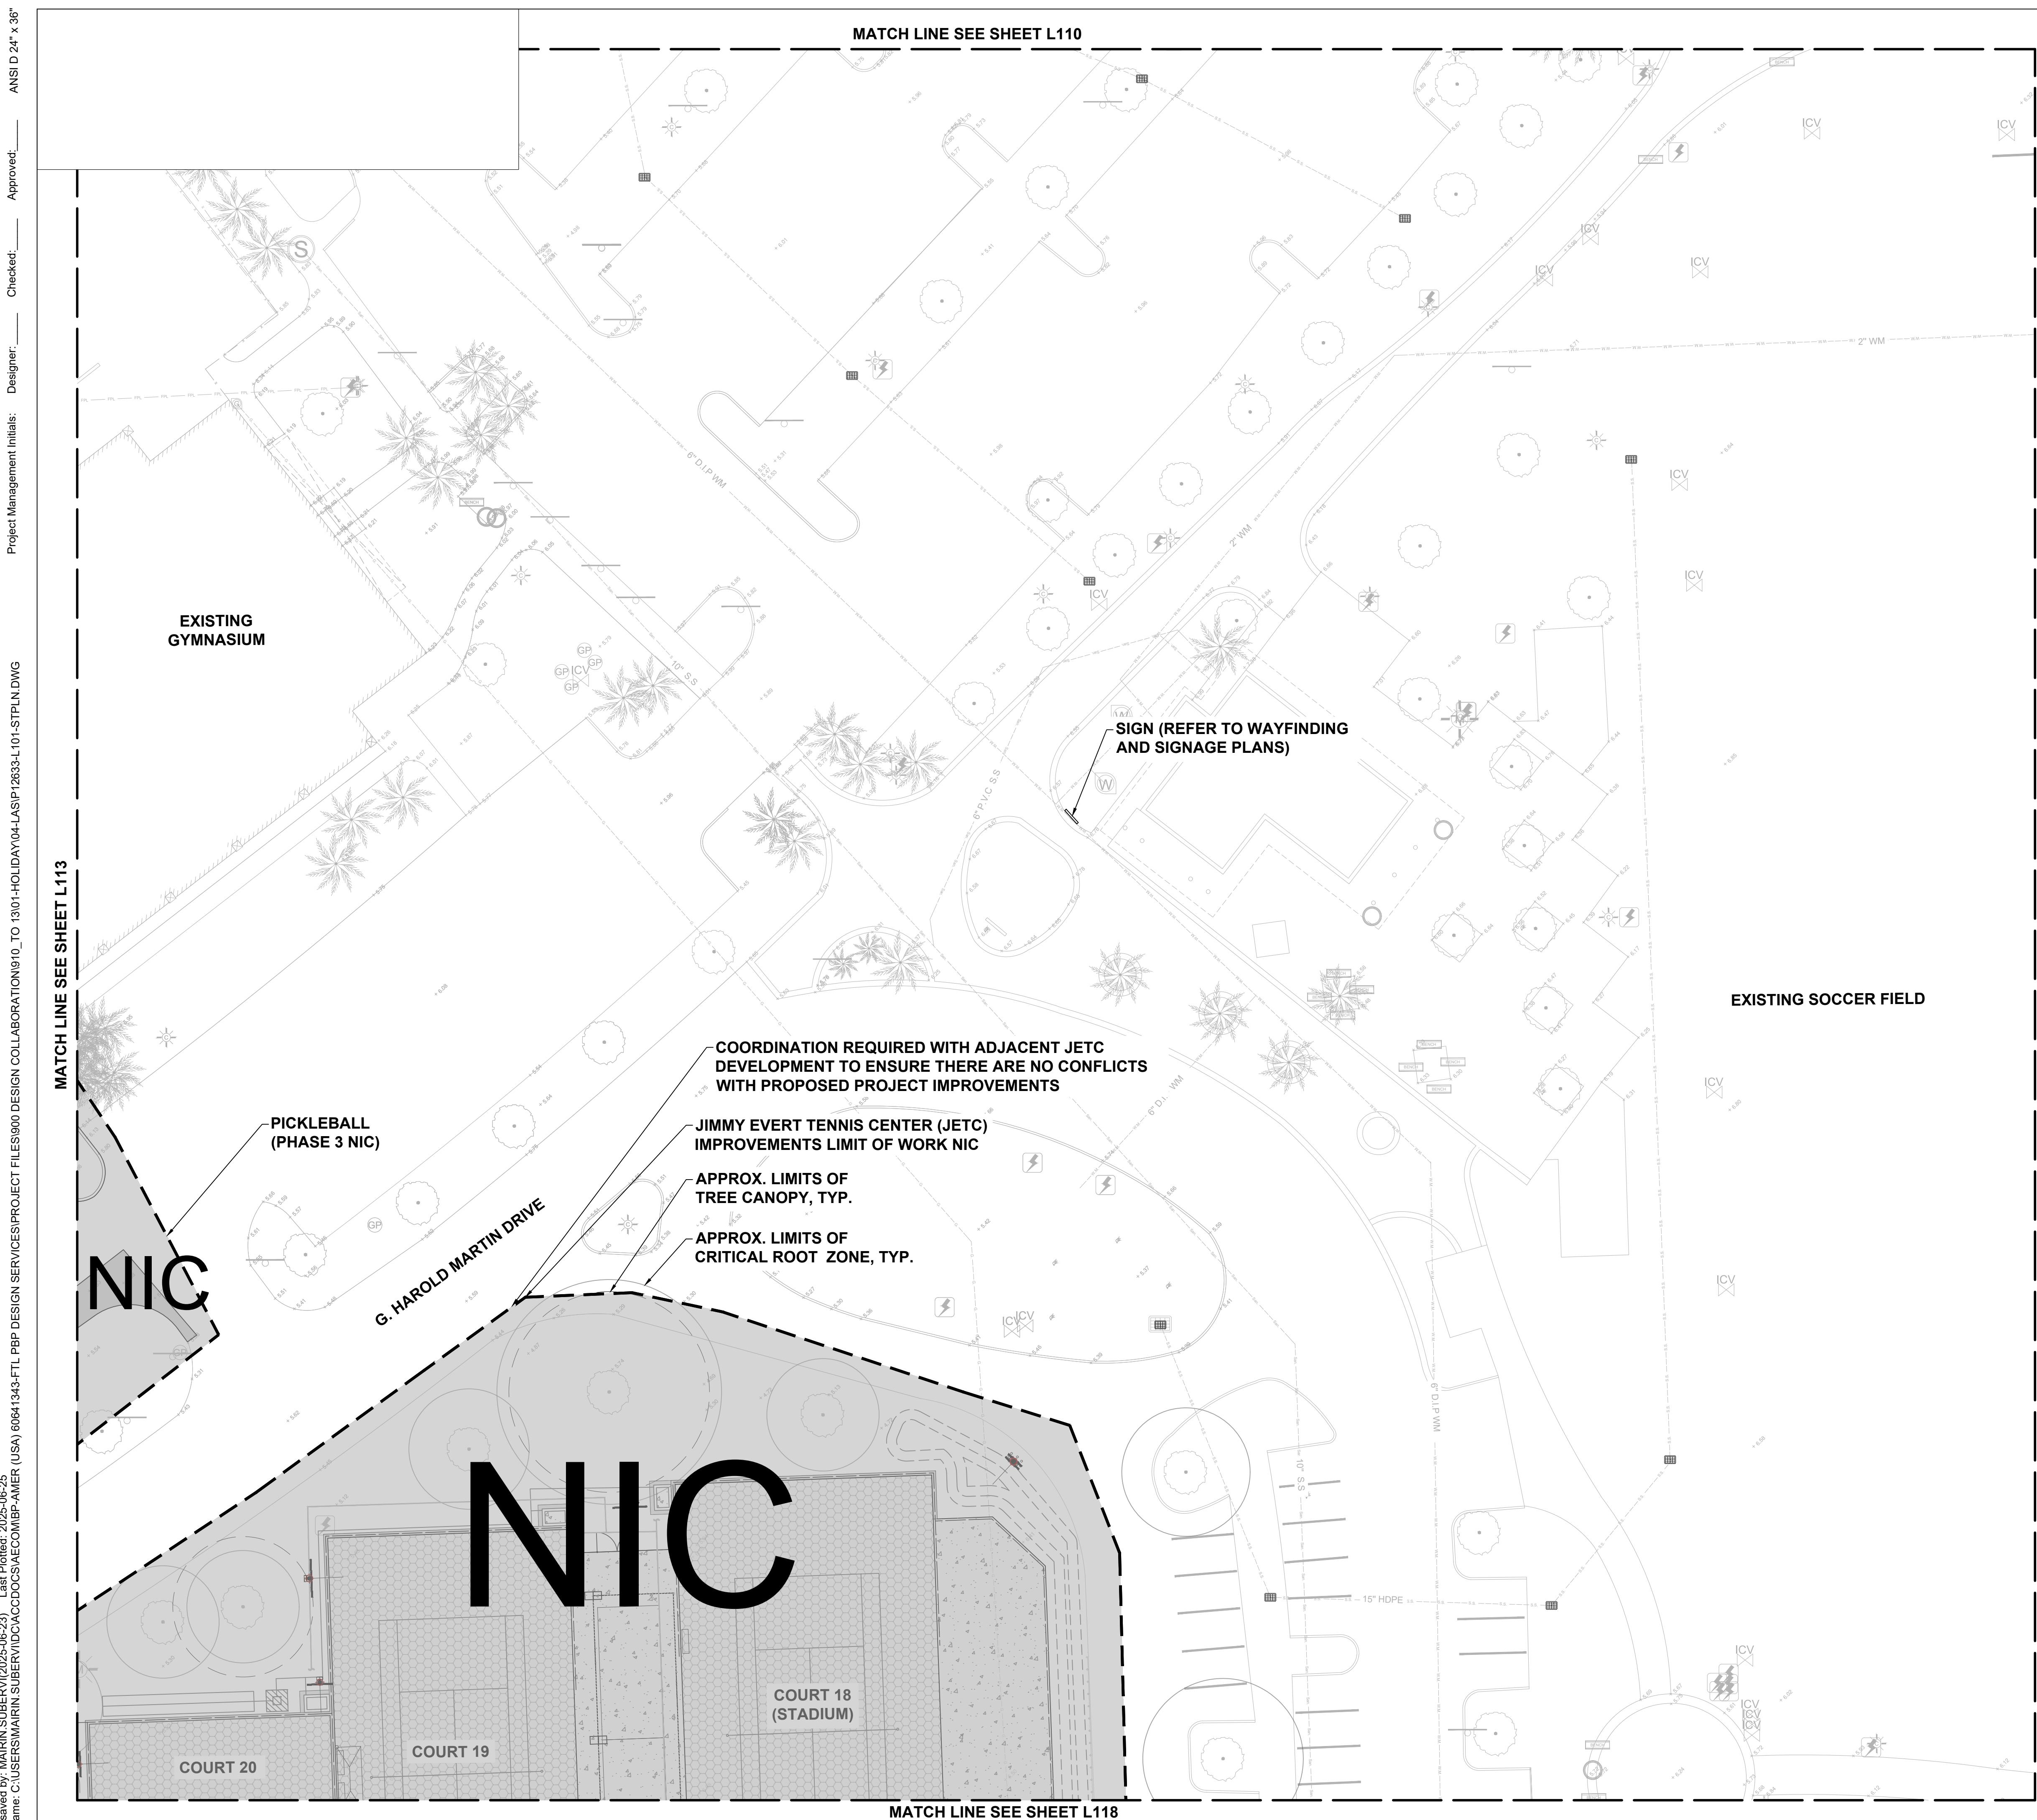
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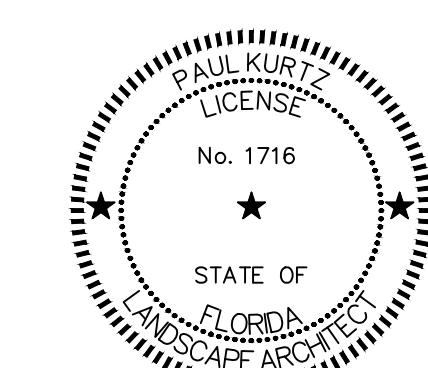
SHEET TITLE
LANDSCAPE SITE PLAN

SHEET NUMBER

L114

COORDINATE WITH AECOM ON LATEST ISSUE OF DRAWINGS BEFORE COMMENCEMENT OF CONSTRUCTION
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PROJECT NUMBER

P12633

SHEET TITLE

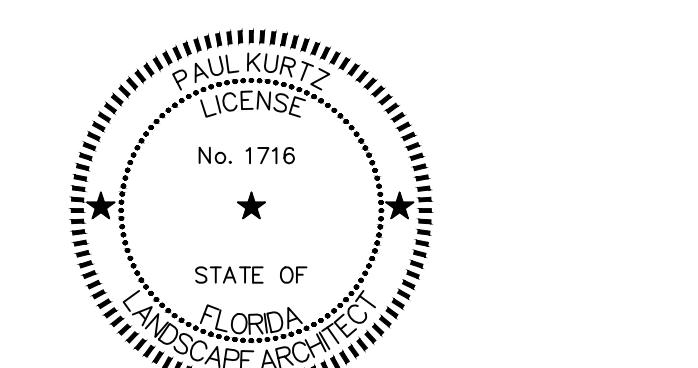
LANDSCAPE SITE PLAN

SHEET NUMBER

L115

COORDINATE WITH AECOM ON LATEST ISSUE OF DRAWINGS BEFORE COMMENCEMENT OF CONSTRUCTION
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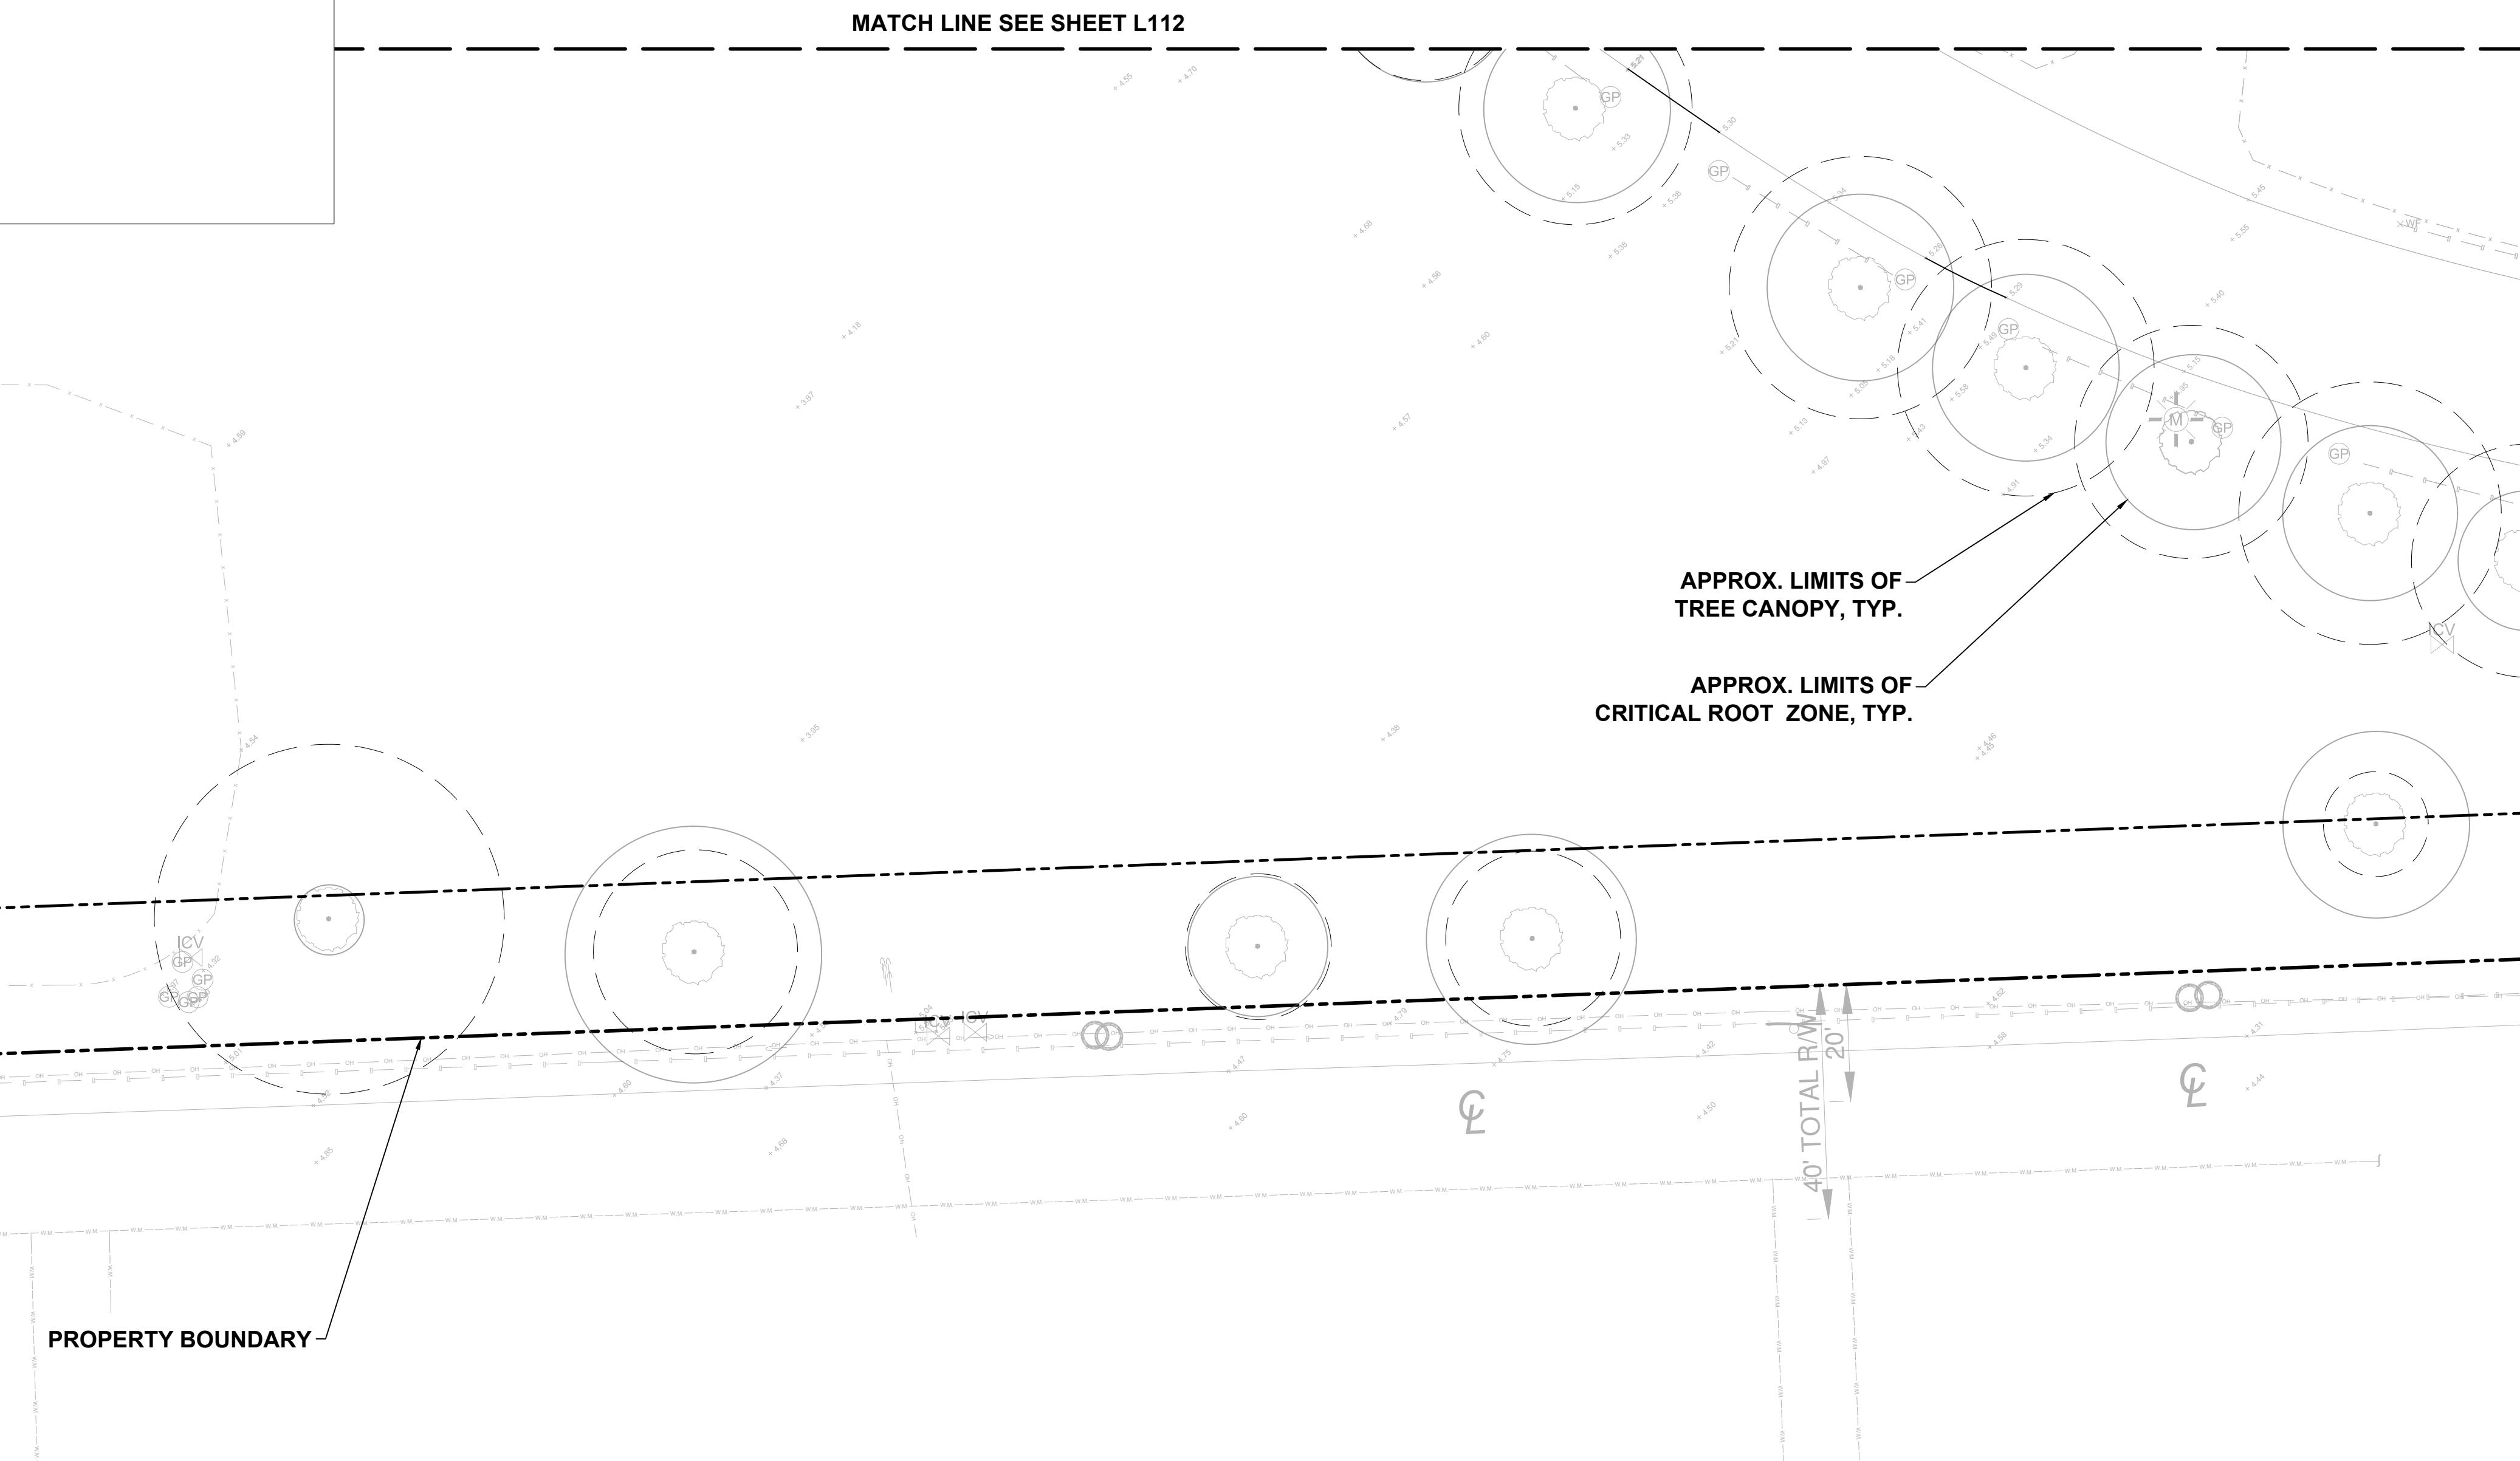
SHEET TITLE
LANDSCAPE SITE PLAN

SHEET NUMBER
L116

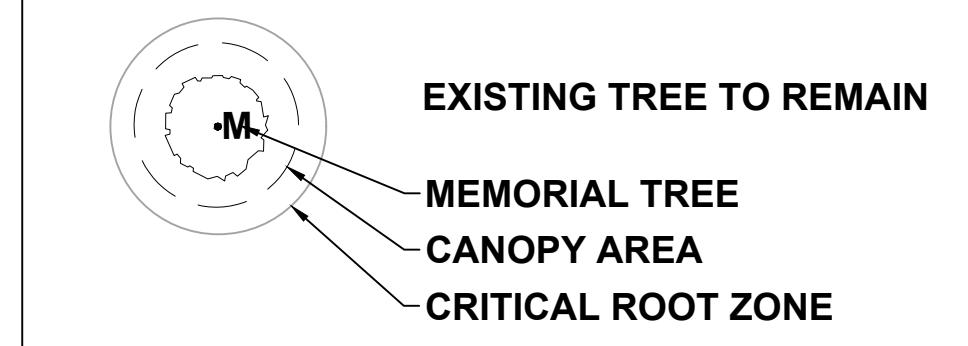
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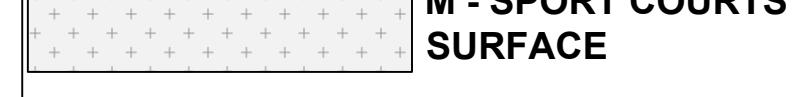
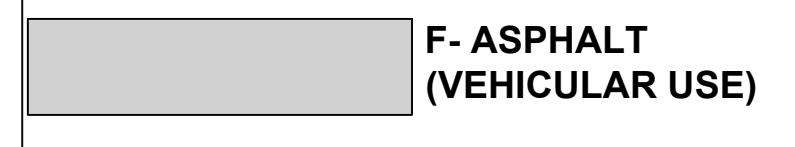
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SITE PLAN LEGEND



PAVING TYPES



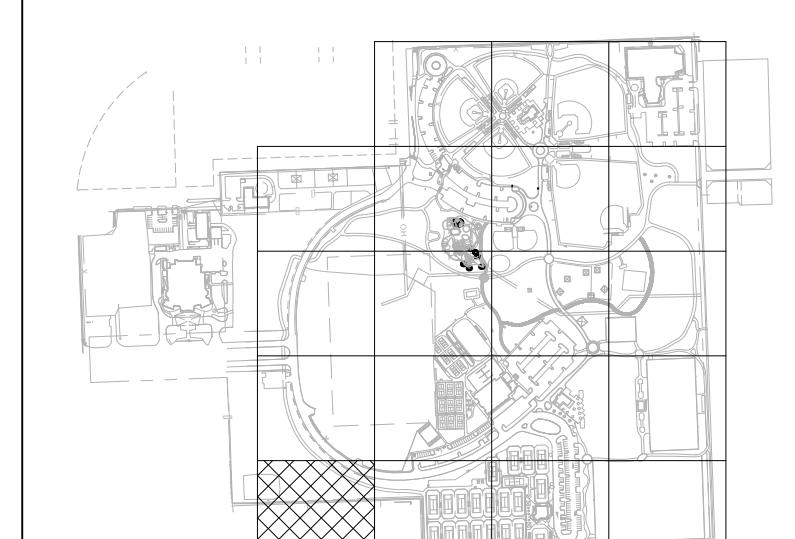
10' FENCE

6' FENCE

4' FENCE

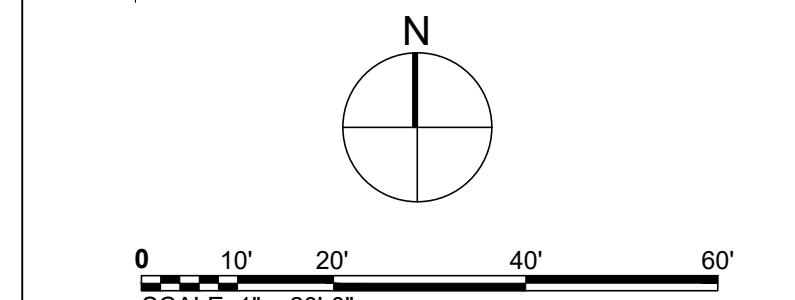
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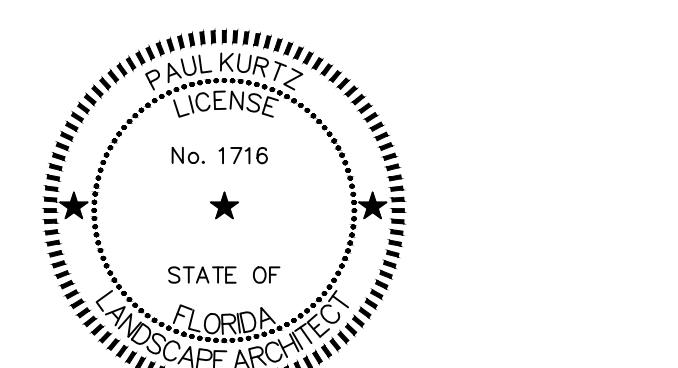
1. FIELD LOCATE ALL UTILITIES.
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16 KEY PLAN

L116 Scale: 1" = 800'-0"





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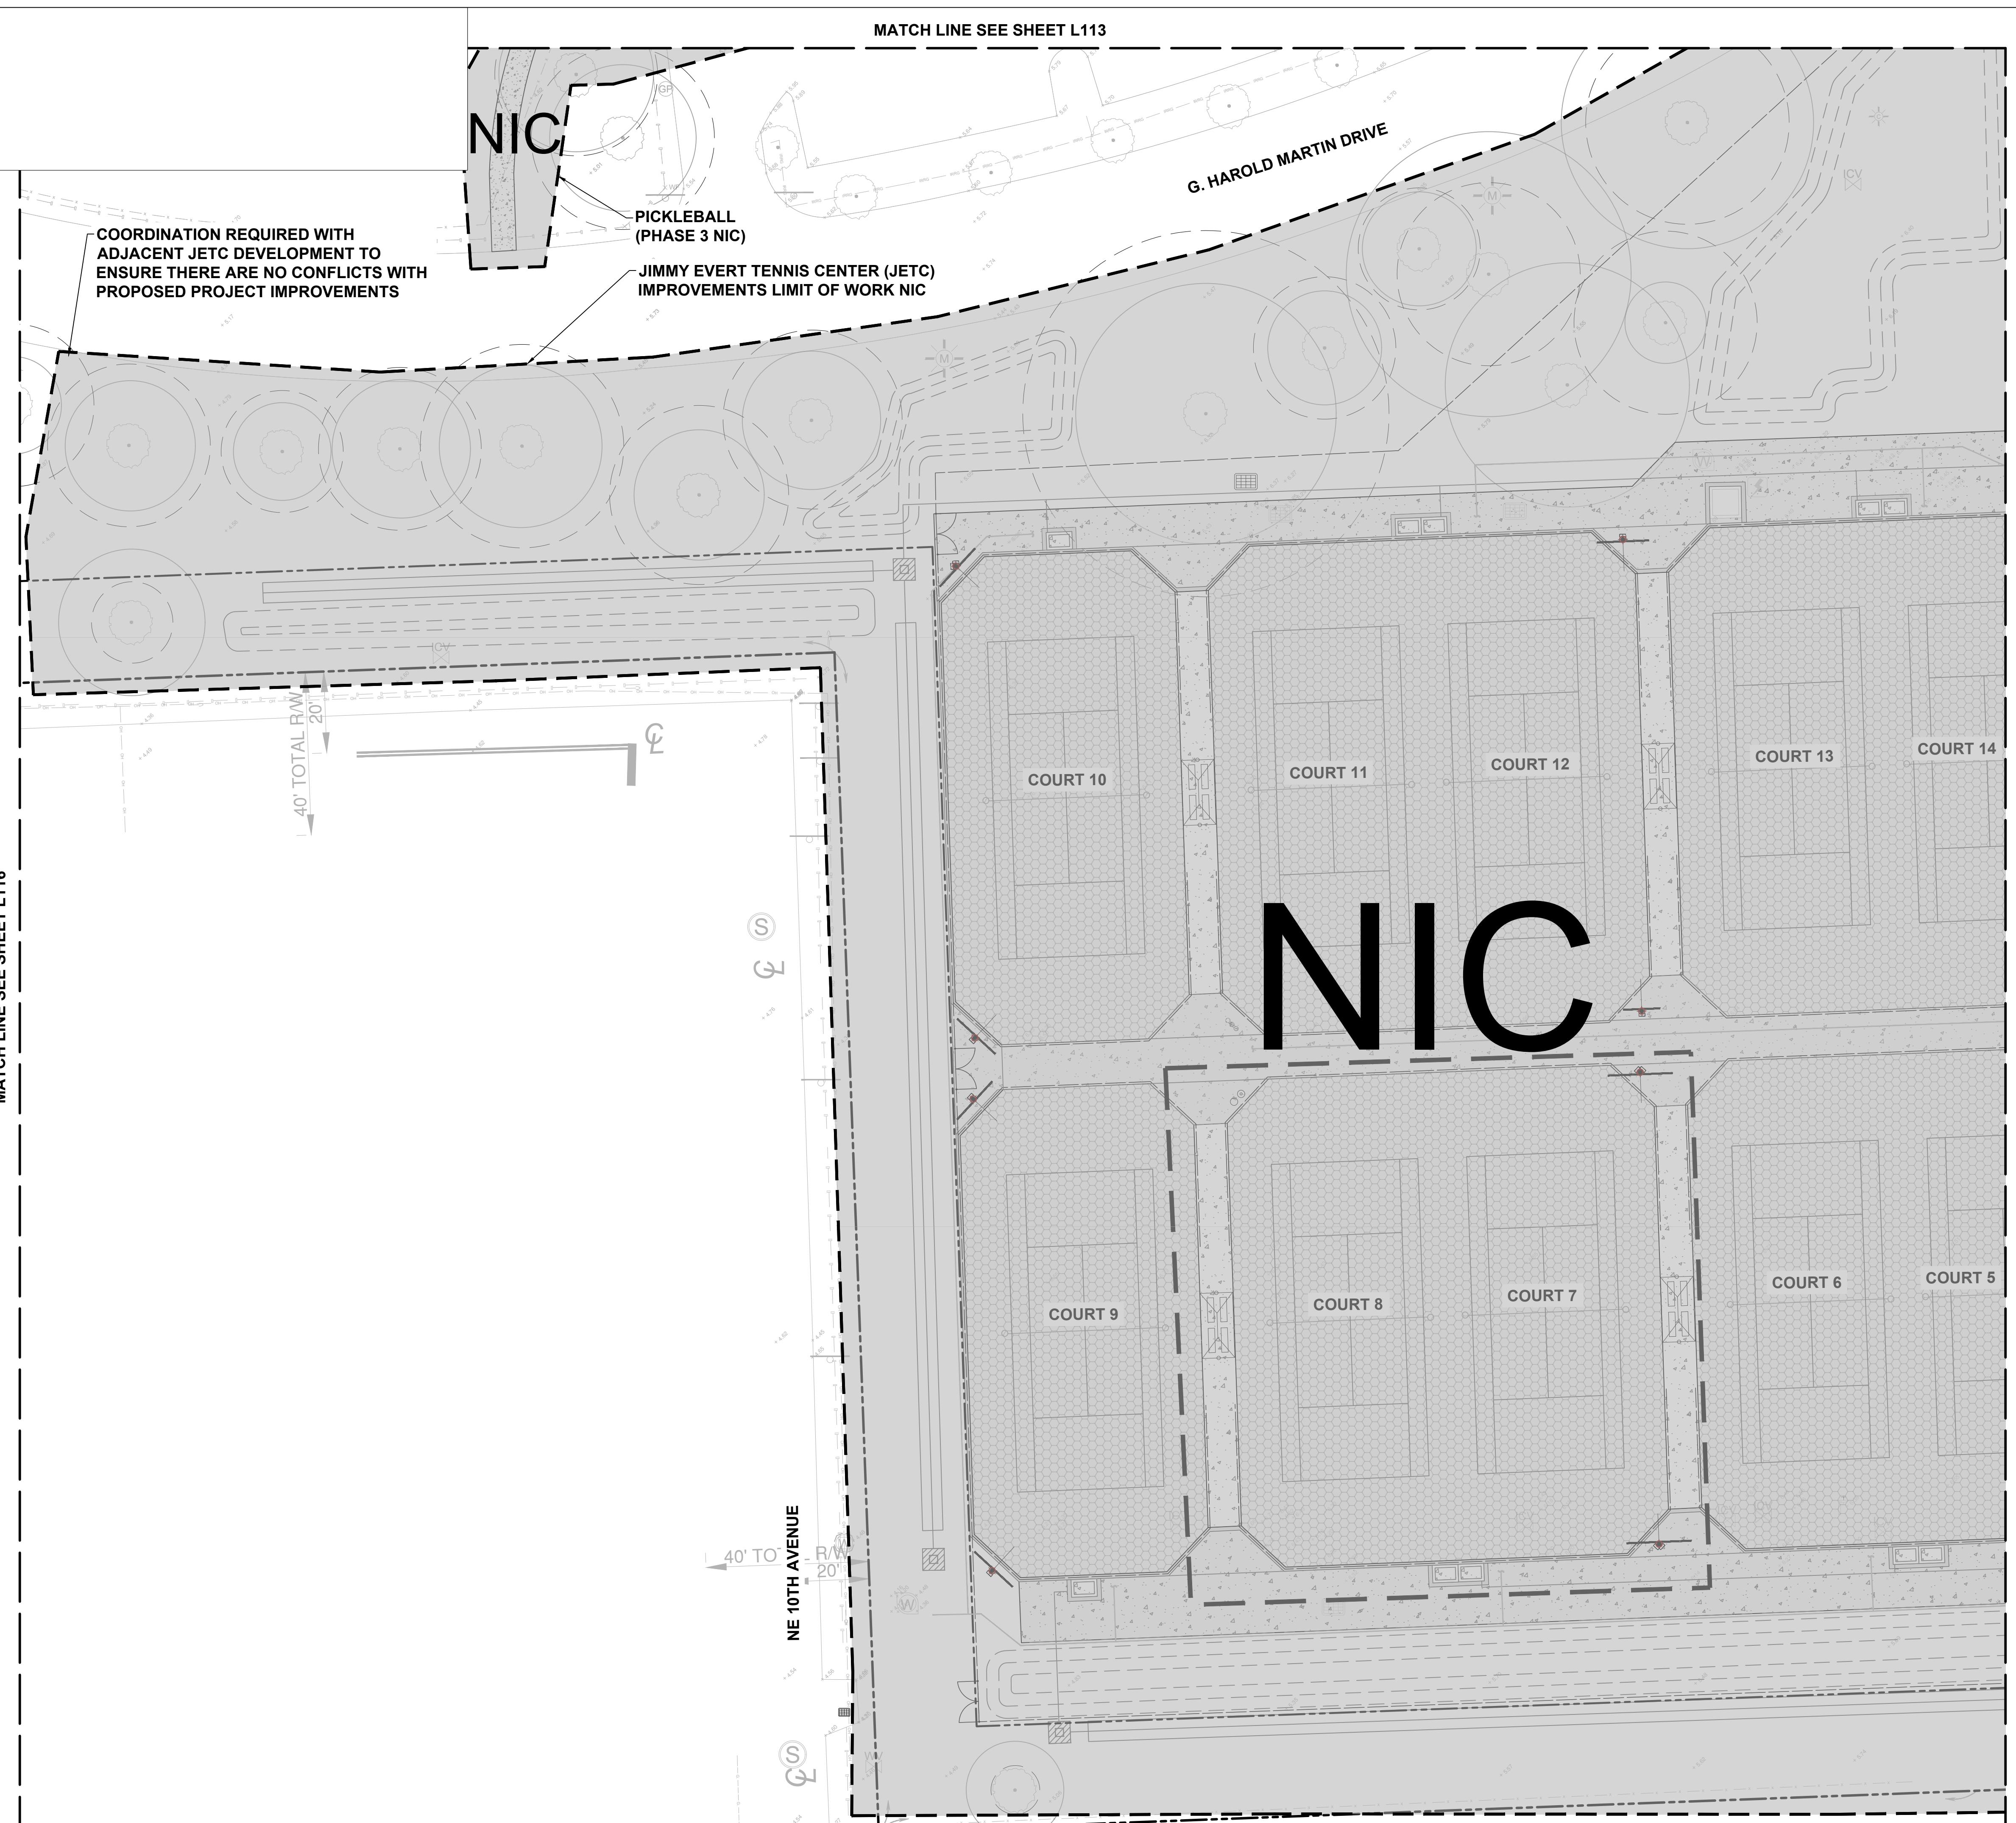
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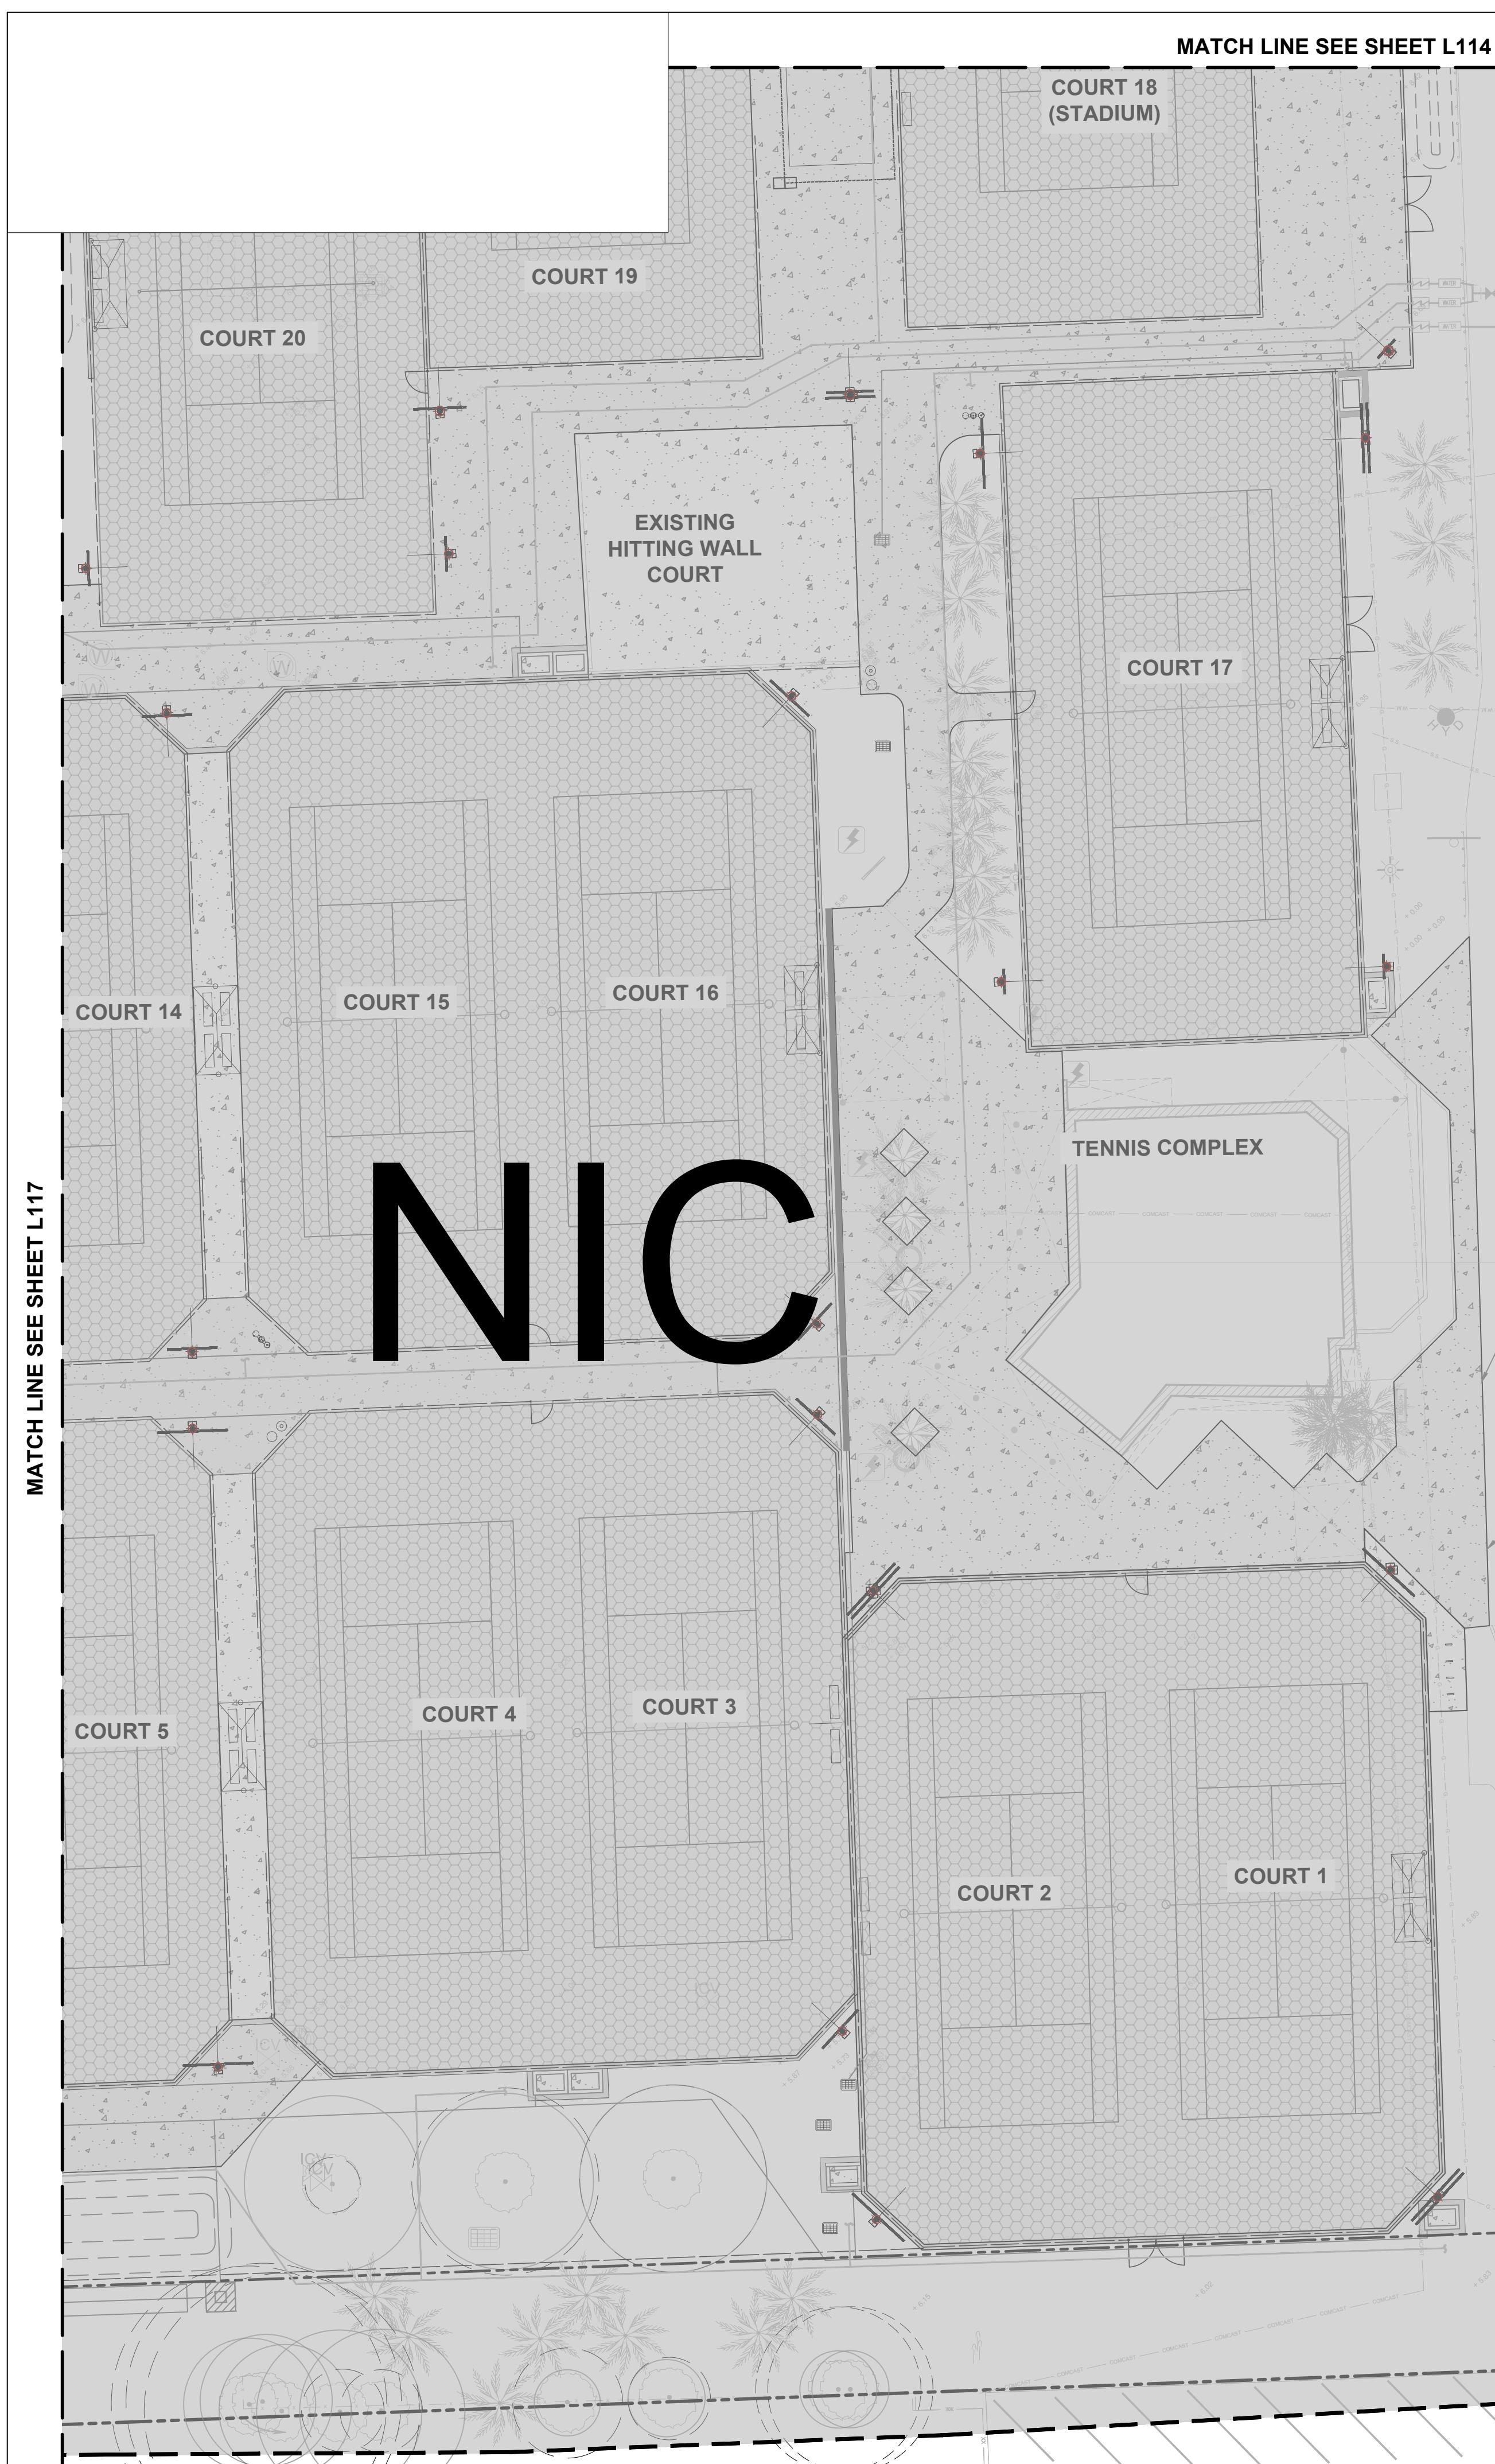
LANDSCAPE SITE PLAN

SHEET NUMBER

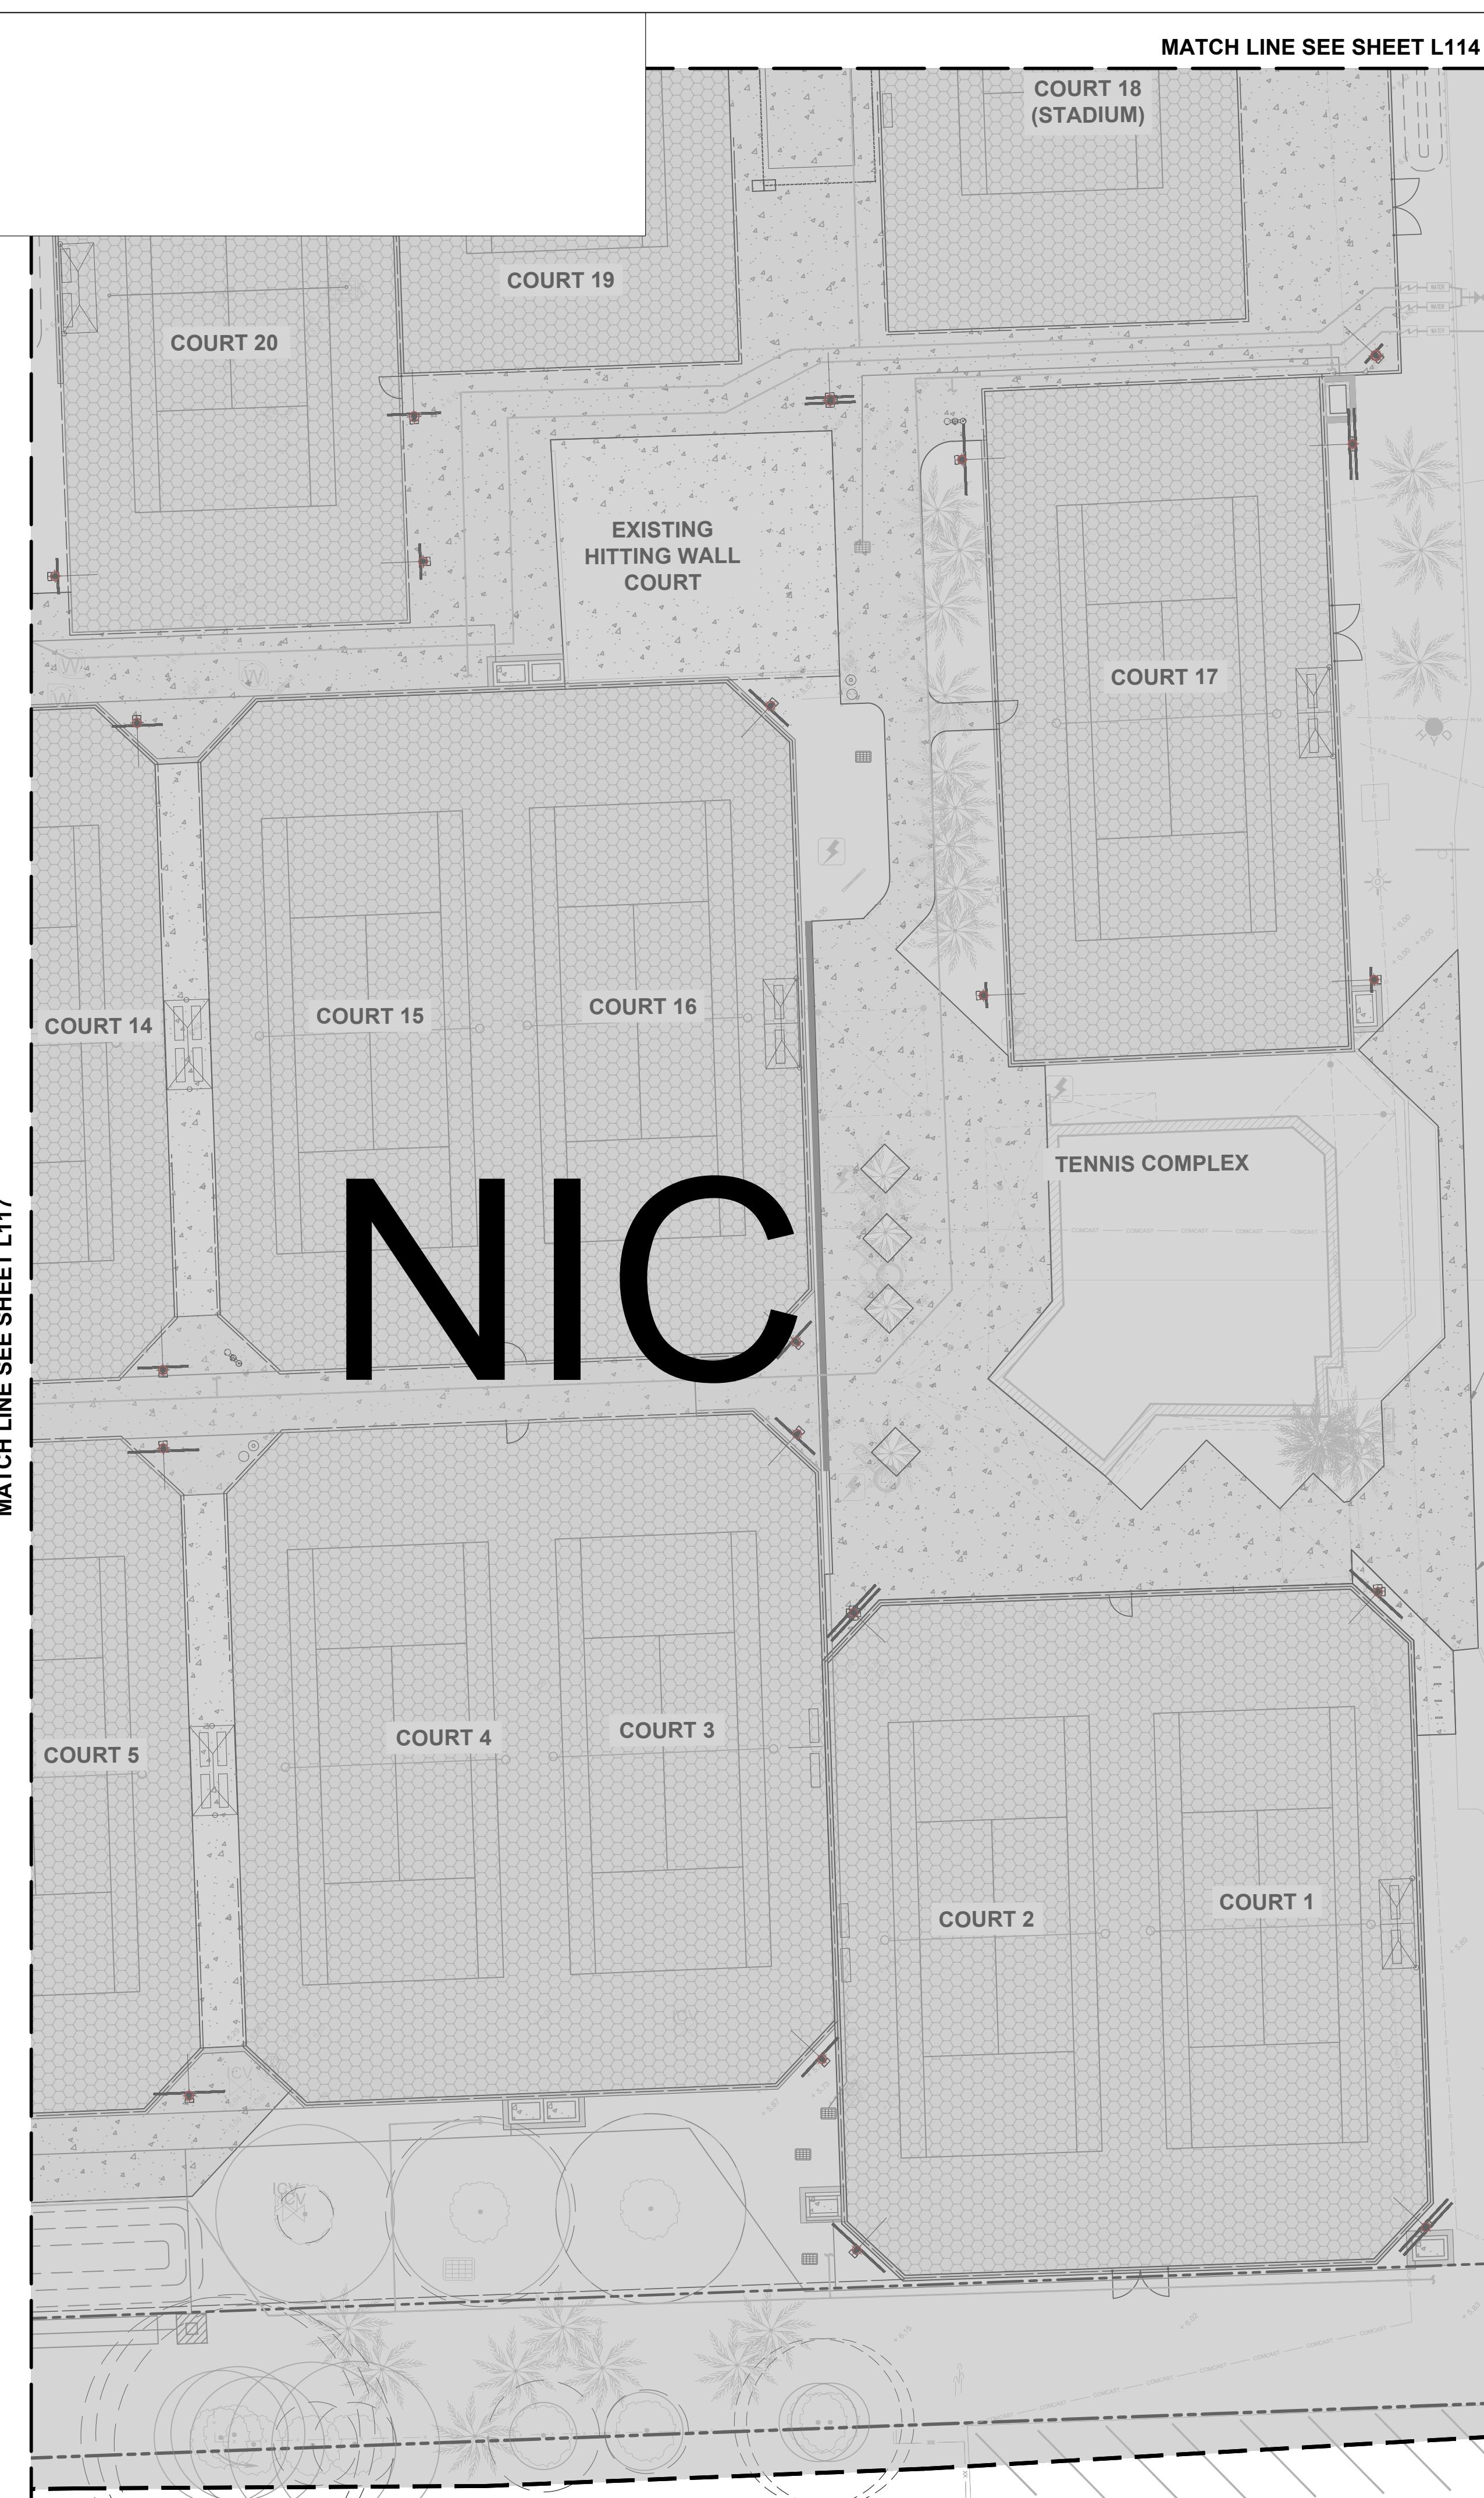
L117

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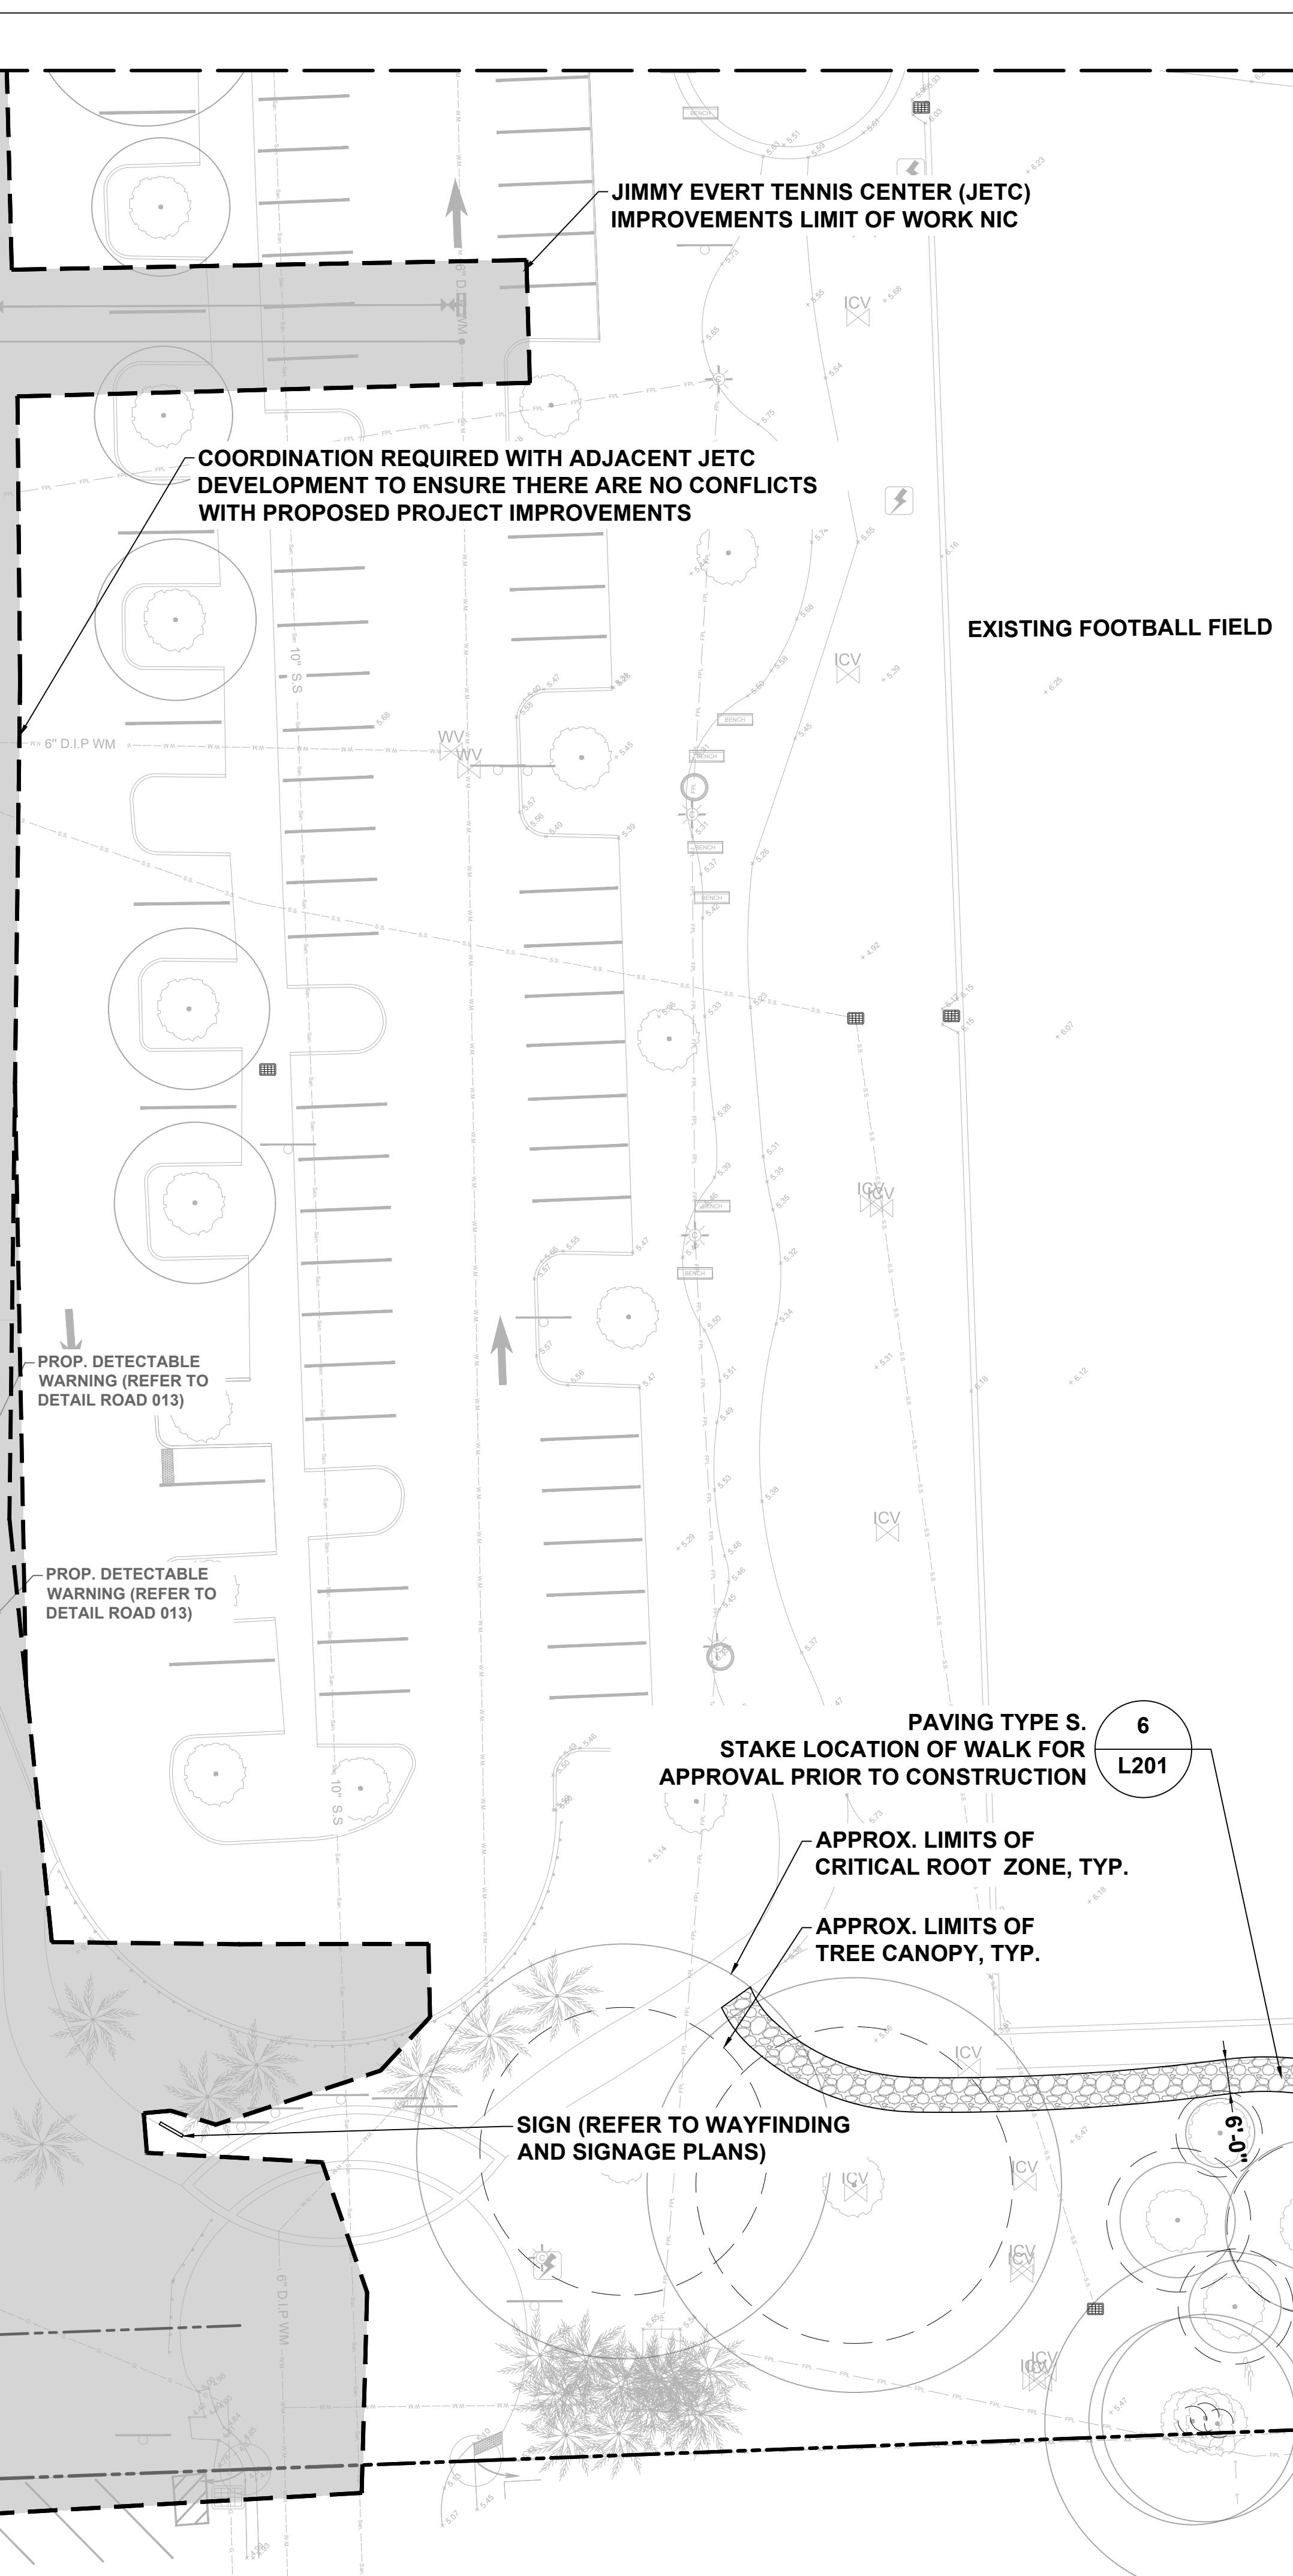




MATCH LINE SEE SHEET L117

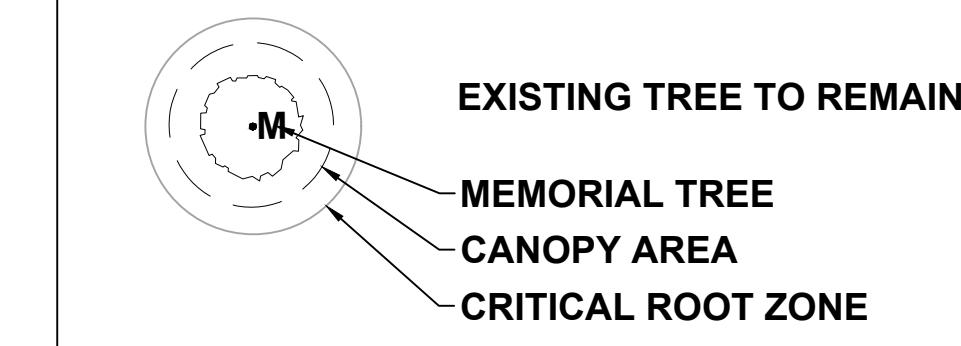


MATCH LINE SEE SHEET L114



MATCH LINE SEE SHEET L119

SITE PLAN LEGEND



PAVING TYPES



10' FENCE

6' FENCE

4' FENCE

NOTES:

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4. SEE G101 KEY PLAN FOR PHASE 2 AND JETC NOT IN CONTRACT (NIC) LIMIT OF WORK

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HOLIDAY PARK
FORT LAUDERDALE
PARKS BOND PROGRAM

CLIENT
PARKS & RECREATION
City of Fort Lauderdale

PRIME CONSULTANT
AECOM
7650 W. COURTNEY CAMPBELL CAUSEWAY
SUITE 700
TAMPA, FL 33607
813.286.1711 tel 813.287.8591 fax
www.aecom.com

SUB-CONSULTANT

CIVIL
BCC ENGINEERING
305.670.2350 tel
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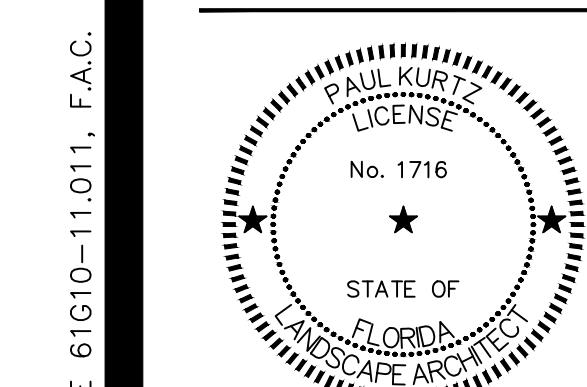
LANDSCAPE
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GEOTECHNICAL SERVICES
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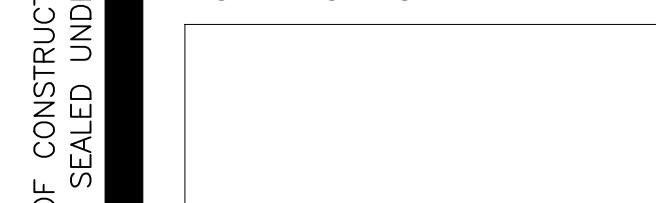
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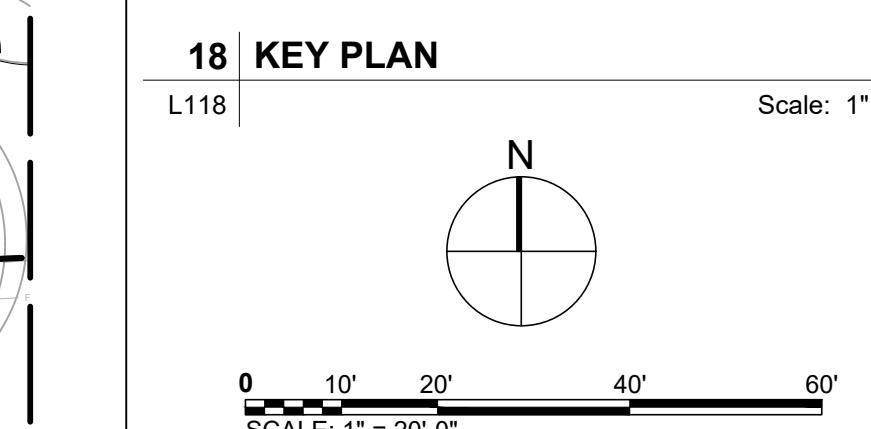
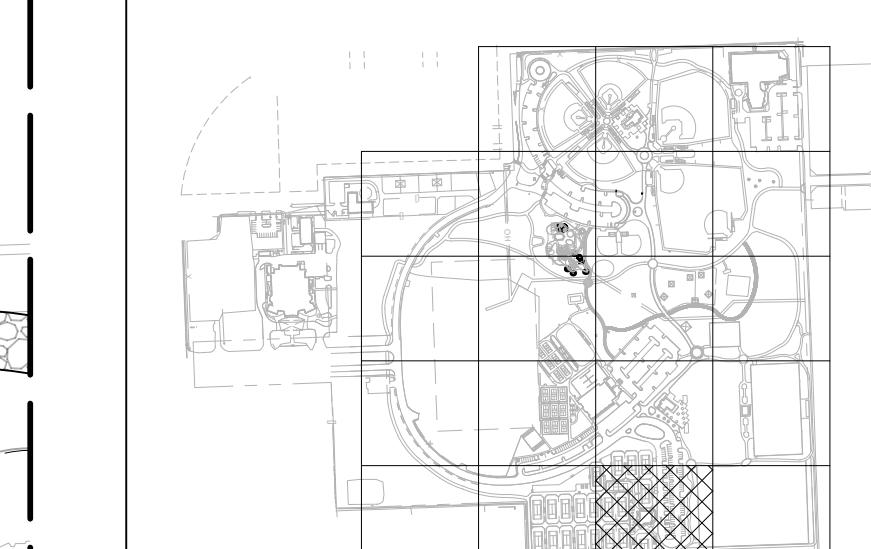
P12633

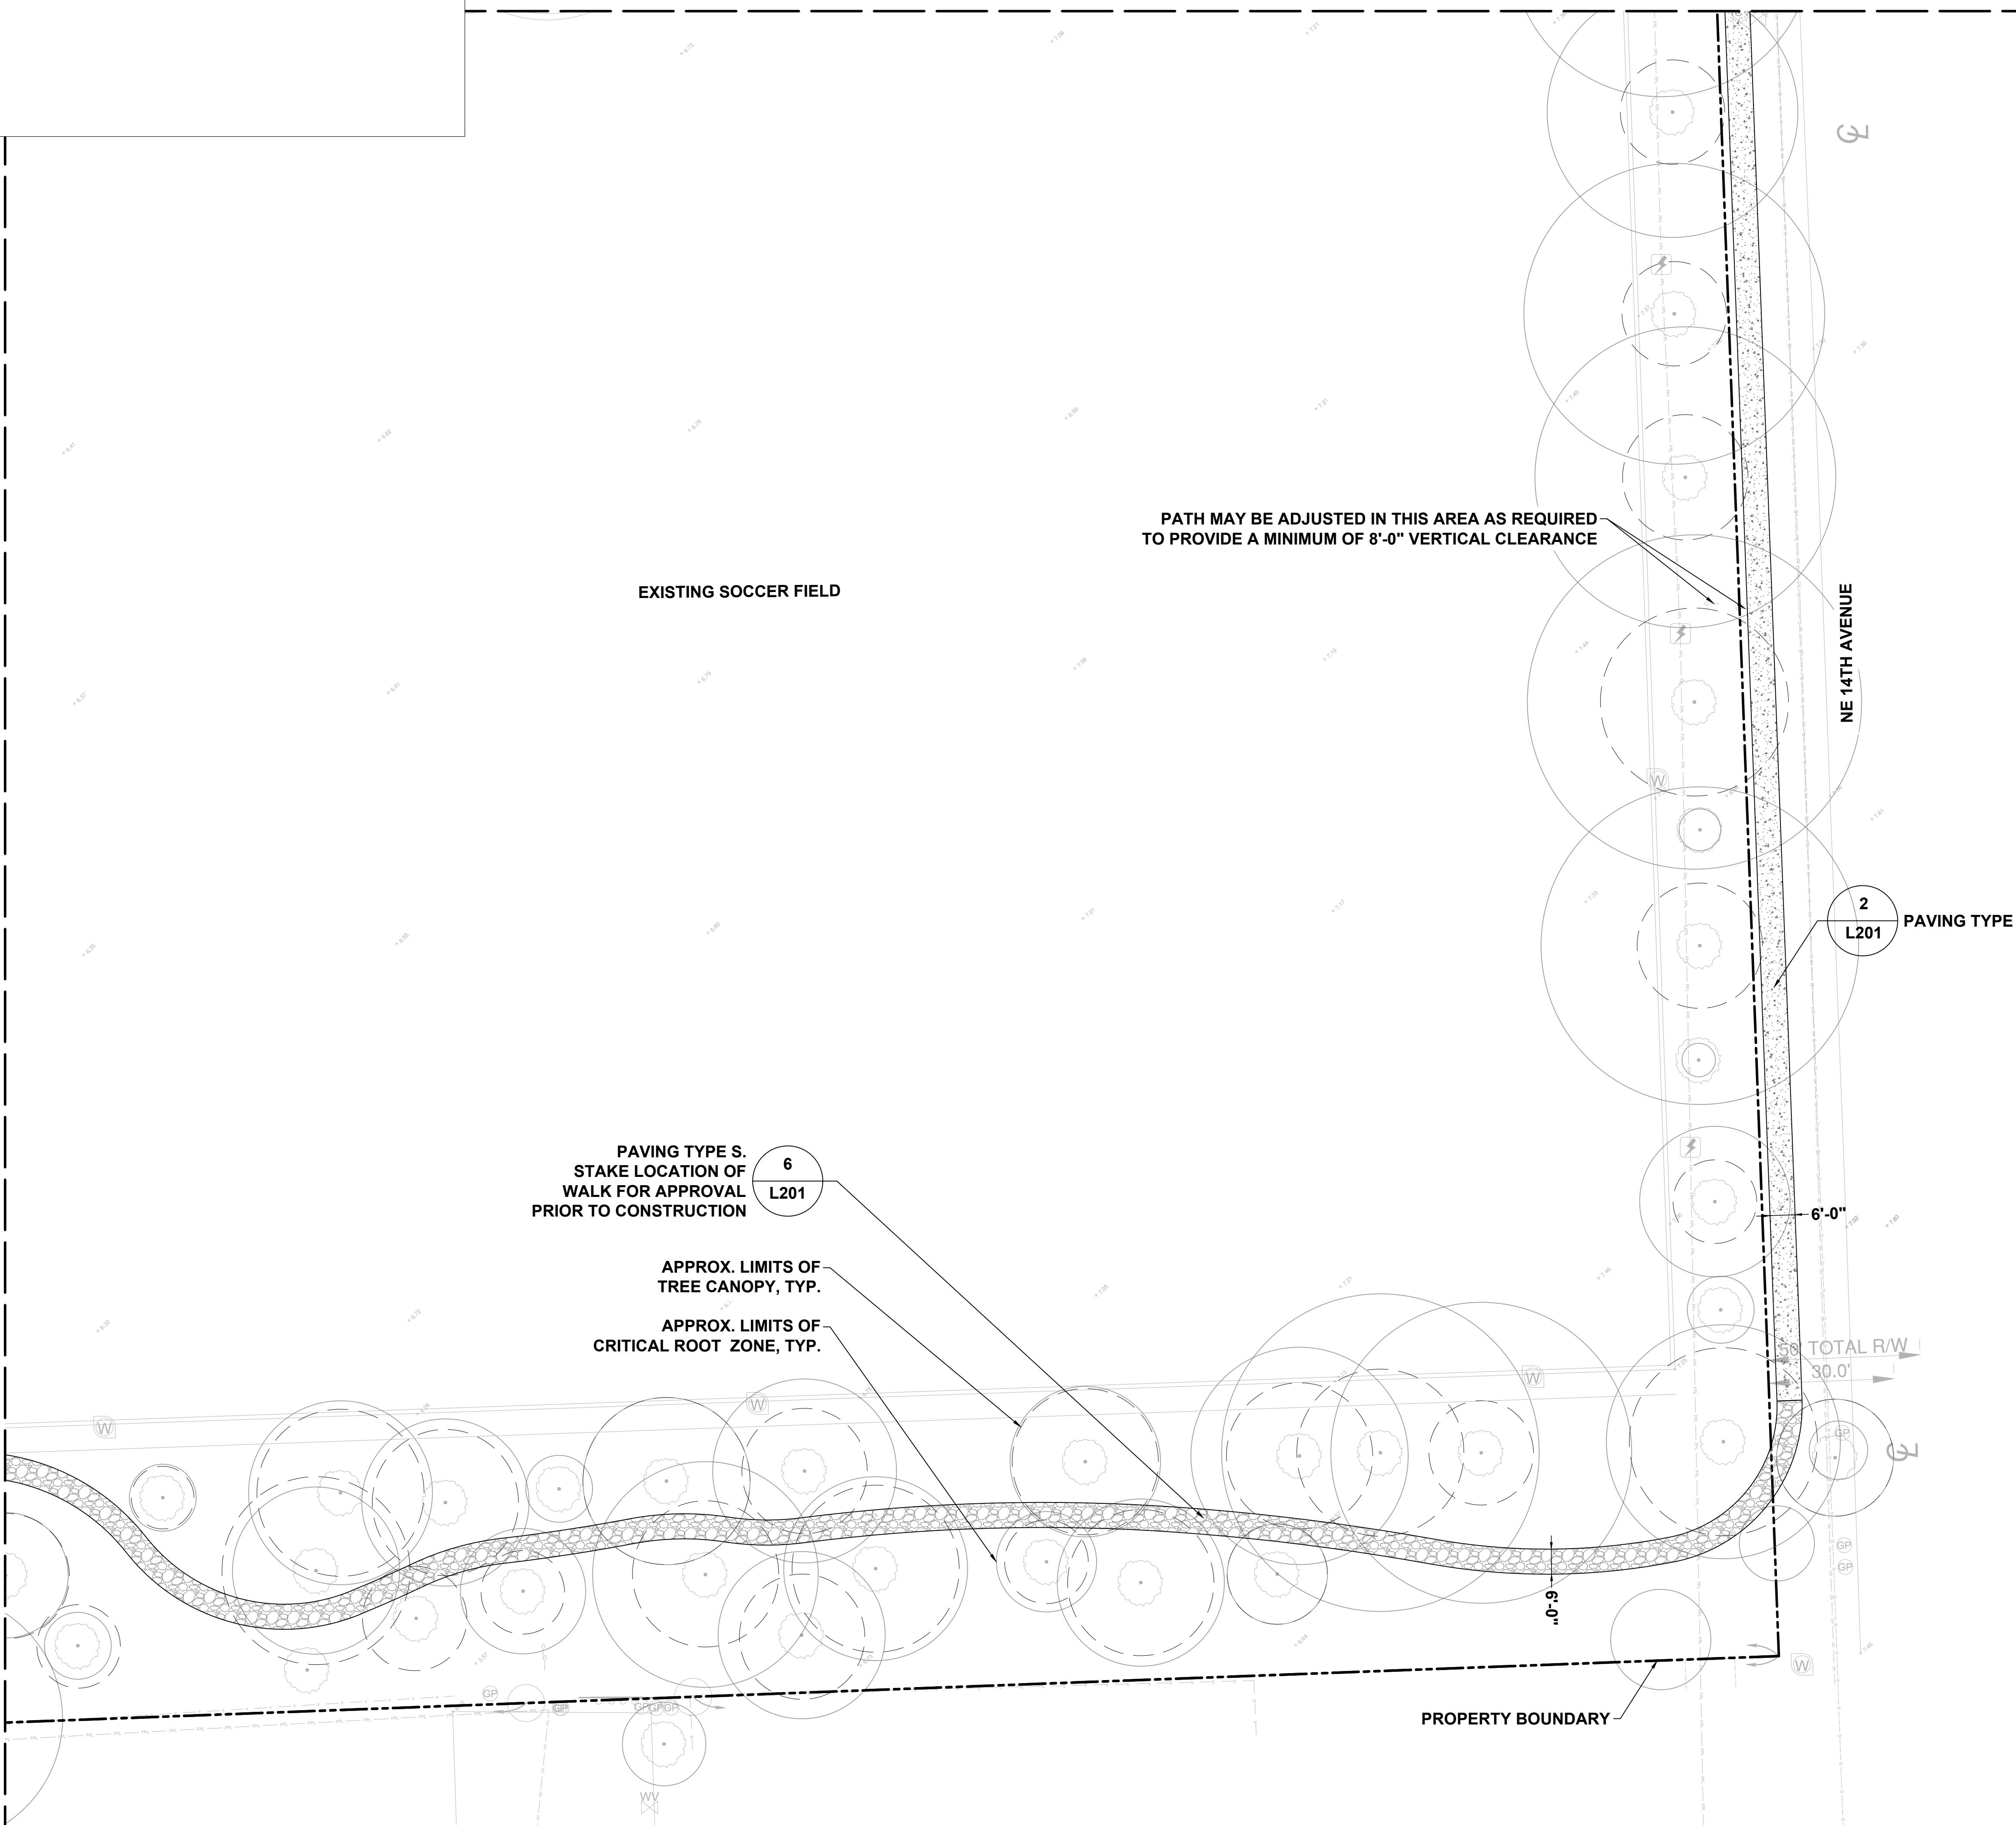
SHEET TITLE

LANDSCAPE SITE PLAN

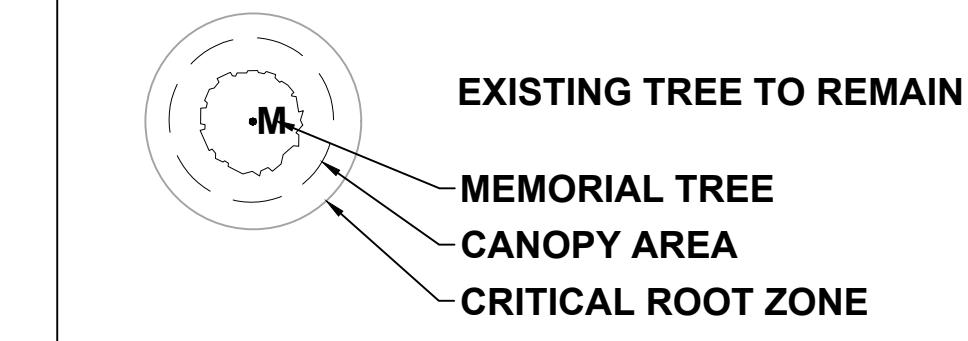
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L118

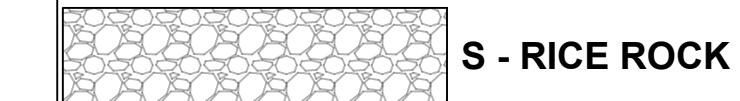
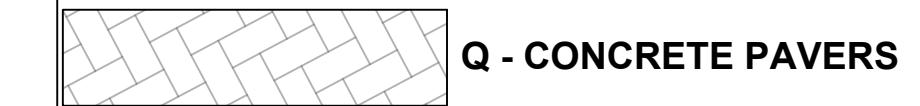




SITE PLAN LEGEND



PAVING TYPES



10' FENCE

6' FENCE

4' FENCE

NOTES:

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AECOM

PROJECT
HOLIDAY PARK
FORT LAUDERDALE
PARKS BOND PROGRAM

CLIENT



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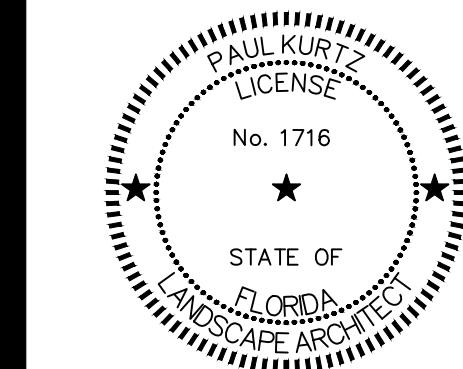
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305.828.4367 tel
www.geosol.net

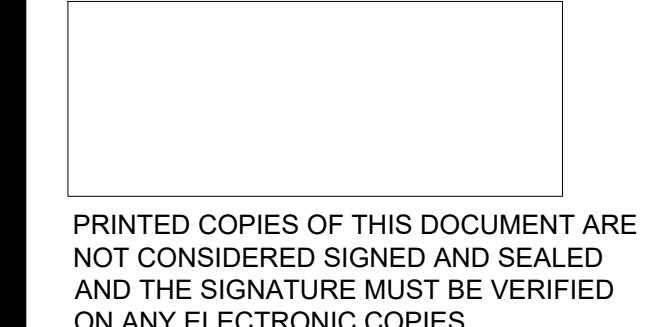
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P12633

SHEET TITLE
LANDSCAPE SITE PLAN

SHEET NUMBER
L119

