NOTE: FRP BOARD TO BE ADDED TO ALL EXISTING WALLS IN FOOD PREP AREAS



Door Schedule:

DOOR NO.	TYPE	DOOM NAME	SIZE		DOOR		FRAME		HARDWARE	DEMARKS
DOOK NO.	ITPE	ROOM NAME	WxH	THK.	MAT.	FINISH	MAT.	FINISH	HANDWANE	REMARKS
1	В	FOOD PREP AREA	3'-0" x 8'-0"	1 3 "	MTL	PTD	НМ	PTD	12,15,16,18	DOUBLE ACTING DOOR W/ SPRING HINGE CLOSER
2	Α	MOP SINK CLOSET	3'-0" x 8'-0"	1 3 "	WDSC	PTD	НМ	PTD	1,3,7	
3	С	STORAGE	(PAIR) 2'-0" x 8'-0"	1 3 "	WDSC	PTD	НМ	PTD	1,3,7	
4	Α	ADA BATHROOM	3'-0" x 8'-0"	1 3 "	WDSC	PTD	НМ	PTD	1,3,5	
5	Α	ADA BATHROOM	3'-0" x 8'-0"	1 3 "	WDSC	PTD	НМ	PTD	1,3,5	
6	Α	OFFICE	3'-0" x 8'-0"	1 3 "	WDSC	PTD	НМ	PTD	1,3,5	
Е	EXISTING DOORS/FRAMES TO REMAIN									

AL- ALUMINUM

BR- BRONZE CLR- CLEAR

ESP- ELECTROSTATIC PAINT FBGL- FIBERGLASS GALVM- GALVANIZED METAL GL- GLASS HM- HOLLOW METAL IM- IMPACT RESISTANT

MTL- METAL PTD- PAINTED SS- STAINLESS STEEL STL- STEEL

STND- STAINED

TME- TO MATCH EXISTING TEM- TEMPERED SAFETY GLASS

WD- WOOD WDHC- WOOD HOLLOW CORE WDSC- WOOD SOLID CORE

1. 1 ½ PAIR STANDARD HINGES

2. 2 PAIR BALL BEARING HINGES SELF CLOSER 4. ENTRY LOCKSET

5. PRIVACY LOCKSET 6. PASSAGE LOCKSET 7. STOREROOM LOCKSET 8. DEADBOLT

9. PANIC HARDWARE - PUSH BAR 10. VISION PANEL

11. EDGE PULL W/ HANDLE 12. 18" SS KICK PLATE BOTH SIDES

13. SECURITY DOOR LOCK W/ MAGNETIC LOCKSET

14. PULL/ PUSH HANDLE 15. PAIR DOUBLE ACTION SWING HINGES WITH SELF CLOSING SPRING


16. 3/8" FROSTED TEMPERED SAFETY GLASS VISION PANEL


17. %" CLEAR TEMPERED SAFETY GLASS 18. DOOR SWING STOP


1. ALL WOOD TO BE SOLID CORE, BIRCH FINISH STAIN GRADE 2. ALL LOCKSET TO BE SCHLAGE 'F' SERIES. BRUSH STAINLESS STEEL DOOR HINGES 1/2 PAIR BUTT HINGES UNLESS OTHERWISE STATED IN SCHEDULE

3. ALL DOOR MOULDING TO BE $3\frac{1}{2}$ " PAINTED TIMBER.

4. PAINTED DOORS TO BE FINISHED IN PAINT. FINISH COLOR TO BE AGREED UPON BY OWNER AND ARCHITECT.

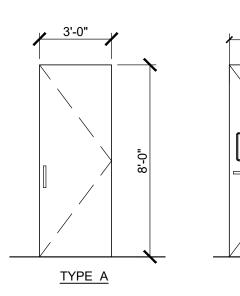

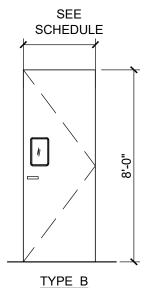

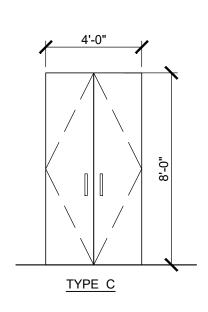

Kitchen Equipment Schedule:

		KITCI	HEN EQUIPMENT SCHEDULE		
NO.	QTY.	DESCRIPTION	MANUFACTURER	MODEL No.	REMARKS
1	1	ELAV-R2-GO-LOCKER SYSTEM-FLOOP-MOUNT	MATCO	F2G-24-C	~~~
2	2	SANDWICH/SALAD PREPARATION REFRIGERATOR	BISON REFRIGERATION	BST-48	
3	2	HOT SERVING COUNTER/TABLE	ATOSA USA	CSTEA-3C	
4	1	POS SYSTEM	TBD	TBD	
5.1	1	RANGE, STOCK POT - (1) BURNER	ATOSA USA	ATSP-18-1	
5.2	1	RANGE, STOCK POT - (2) BURNERS	ATOSA USA	ATSP-18-2	
6	2	GAS FRYER	ATOSA USA	ATFS-40	
7	2	36" 4-BURNER RANGE W/ 12" GRIDDLE	SERV-WARE	SGR-4B-12G	
8	-	NOT USED			
9	1	IN-COUNTER HAND SINK	KROWNE	HS-1225	WITH KROWNE 15-306L DECK MOUNT FAUCET
10	1	SALAD/PREP SINK	KROWNE	HS-2017	WITH KROWNE 15-308L DECK MOUNT FAUCET
11	1	3-COMPARTMENT SINK	ATOSA USA, INC.	MRSA-3-D	WITH KROWNE 17-108WL FAUCET
12	1	WALL MOUNTED HAND SINK	KROWNE	HS-26L	WITH KROWNE 15-306L DECK MOUNT FAUCET
13	1	3-DOOR REACH-IN REFRIGERATOR	ATOSA USA	MBF8508GR	
14	1	2-DOOR REACH-IN FREEZER	ATOSA USA	MBF8503GR	
15	3	WIRE SHELVING - 18" W. x 48" L. x 75" H.	TBD	TBD	BY SPECIALTY MANUFACTURER
16	1	PREP TABLE - 12" W. x 30" L. x 34" H.	TBD	TBD	BY SPECIALTY MANUFACTURER

Finishes Schedule:

ROOM NAME	FLOOR		WALLS		CEILING		REMARKS	
ROOM NAME	6" BASE	FINISH	MATERIAL	FINISH	MATERIAL	FINISH	REWIARRO	
SALES/CUSTOMER AREA	VT	VT	GWB	PTD/SS	ACT	PTD	2'X2' ACT TILE	
ADA RESTROOMS	СТ	СТ	DENS	CT/PTD	GWB	PTD	GWB	
COOKING & PREP AREAS	VT	QT	DENS/FRP	SS/FRP	ACT	SF	VINYL 2'X4' ACT TILE	
OFFICE	VT	VT	GWB	PTD	ACT	PTD	2'X2' ACT TILE	
STORAGE	VT	VT	GWB	PTD	ACT	PTD	2'X2' ACT TILE	
MOP SINK CLOSET	VT	VT	DENS/FRP	PTD/FRP	ACT	PTD	2'X2' ACT TILE	
CORRIDOR	VT	VT	GWB	PTD/SS	ACT	PTD	2'X2' ACT TILE	

ACT- ACCOUSTICAL CEILING TILE AFF- ABOVE FINISH FLOOR

GWB- GYPSUM WALLBOARD

CPT- CARPET CT - CERAMIC TILE DENS - DENS BOARD FRP - FIBER REINFORCED POLYESTER, WHITE HSC- HOMOGENEOUS SEALED CONCRETE MRGWB- MOISTURE RESISTANT GYPSUM WALLBOARD PTD- PAINTED QT- QUARRY TILES VT- VINYL TILE WD- WOOD SS- STAINLESS STEEL

SF- SELF FINISH

- . ALL WALLS SHALL BE PAINTED CUSTOM COLORS AS SELECTED BY THE ARCHITECT/OWNER.
- 2. ALL CERAMIC & PORCELAIN TILE COLORS AND TEXTURE SHALL BE AS SELECTED BY ARCHITECT/OWNER.
- 3. ALL INTERIOR FINISHES AT WALLS AND CEILINGS SHALL BE CLASS A, CLASS B OR CLASS C. EXCEPT IN CORRIDORS SHALL BE CLASS C AS PER FBC TABLE
- 4. STAINLESS STEEL FINISHES SHALL REACH FUME
- 5. FRP FINISHES TO REACH TOP OF CEILING.
- 6. ALL INTERIOR FLOOR FINISH SHALL BE NOT LESS THAN CLASS II.
- 7. CEILING IN COOKING & FOOD PREP AREAS SHALL BE ARMSTRONG - CLEAN ROOM MYLAR SMOOTH TEXTURE, UNPERFORATED 2'x4' LAY-IN TILES.
- 8. CEILING: REFER TO REFLECTED CEILING PLAN ON SHEET A3.1 FOR CEILING HEIGHTS.

EXISTING WALLS/PARTITIONS EXISTING TO BE DEMOLISHED (XXXXXX NEW PARTITION WALLS NEW INSULATION PARTITION WALLS NEW EXTERIOR MASONRY WALLS NEW REINF. CONC COLUMN WALL TYPE TAG DOOR TAG (E) EXT'G. DOOR WINDOW TAG $\langle E \rangle$ EXT'G. WINDOW **EQUIPMENT TAG** FIRE EXTINGUISHER **EMERGENCY EXIT SIGN EXISTING** REPLACE/ RELOCATE **ELECTRICAL PANEL**

AREA OF WORK (NOT HATCHED)

NOT PART OF THIS PERMIT

(HATCHED AREA)

Notes:

Legend:

- 1. THIS SET OF DRAWINGS IS FOR INTERIOR PERMIT WORK.
- 2. CONTRACTOR TO VERIFY EXISTING AND NEW CONDITIONS AND REPORT ANY
- ALL CONTRACTORS AND SUBCONTRACTORS SHALL BE RESPONSIBLE FOR OBTAINING ALL NECESSARY PERMITS AND SECURE ANY ADDITIONAL DATA REQUIRED TO OBTAIN SAID PERMITS PER BUILDING DEPARTMENT REGULATIONS.
- THE GENERAL CONTRACTOR IS RESPONSIBLE FOR THE FIELD SUPERVISION CONSTRUCTION ADMINISTRATION AND REVIEW AND APPROVAL OF ALL SUBMITTALS AND SHOP DRAWINGS FROM SUPPLIERS AND SUBCONTRACTORS.
- 5. IT IS THE CONTRACTOR AND OWNER/TENANT RESPONSIBILITY TO ENSURE THAT ALL CONSTRUCTION IS PERFORMED IN THE STRICTEST COMPLIANCE WITH THESE CONSTRUCTION DOCUMENTS, SPECIFICATIONS AND CODES.
- 6. AT COMPLETION OF PROJECT OR WORK, THE CONTRACTOR SHALL CLEAN OR RE-CLEAN THE ENTIRE WORK OF ALL CONSTRUCTION DEBRIS AND REMOVE SAME FROM SITE TO LEAVE WORK IN A MANNER FIT FOR THIS TYPE OF BUILDING OCCUPANCY, REMOVE ALL TEMPORARY PROTECTION AND LABELS IF ANY, CLEAN EXPOSED SURFACES, TOUCH UP MINOR DAMAGE AND SWEEP AND WASH PAVED AREAS IF SAID AREA DAMAGE OR DEBRIS ACCUMULATION HAS BEEN CAUSED BY THE CONTRACTOR DURING THE COURSE OF THE WORK, DURING CONSTRUCTION CONTRACTOR SHALL AT ALL TIMES ENSURE THE EXTERIOR SITE REMAINS FREE OF DEBRIS, SAFE FROM OBSTACLE, ETC TO MAINTAIN SAFE USE FOR OTHER TENANTS IN THE BUILDING. ANY EXTERIOR SITE USAGES FOR STORING, CONTRACTOR SHALL OBTAIN
- 7. CONTRACTOR TO PROVIDE BLOCKING AS REQUIRED IN PARTITIONS BEHIND ALL INTERIOR PARTITIONS WHERE SHELVING & CABINET ACCESSORIES ARE TO BE INSTALLED.
- 8. ALL FLOOR AREAS EXISTING AND NEW SHALL BE CLEANED OF OIL OR OTHER LIQUIDS WHICH MAY HAVE PENETRATED FLOOR SLAB. FLOOR SHALL BE SANDED AND MADE LEVEL WHERE NECESSARY TO RECEIVE NEW FLOORING MATERIALS BE IT VINYL TILE, CARPET,
- 9. CONCRETE SLAB REPAIR TO EXISTING ALL CUT SLABS 4" CONC. WITH (1) #3 @ 18" O.C.
- 10. CONTRACTOR TO ENSURE AND COORDINATE ALL EQUIPMENTS, FITTINGS, CABINETRY AND SERVICES LOCATIONS WITH ARCHITECTURAL, STRUCTURAL & MEP DRAWINGS. ALL DISCREPANCIES IN DRAWINGS SHALL BE REPORTED TO ARCHITECT AND VERIFIED PRIOR TO
- 11. CONTRACTOR TO COORDINATE ALL INTERIOR BUILT-IN'S AND INTERIOR FINISHES, (FLOORING, CEILINGS, BLINDS, PAINT, PLASTIC LAMINATING, ETC.) TYP. COLOR AND STYLE
- 12. FLAMMABLE AND COMBUSTIBLE MATERIALS IF USED DURING CONSTRUCTION, SHALL BE HANDLED AND STORED IN ACCORDANCE WITH NFPA 30.
- FOR PROPOSED NEW LIGHTING, ETC.
- PREVENTION CODE (SIXTH EDITION), SECTION 16.4.
- 19. ALL INTERIOR FINISHES TO COMPLY WITH THE FLORIDA FIRE PREVENTION CODE (SIXTH
- 21. NEW FLOORING TO BE SLIP RESISTANT AND LEVEL AS PER CHAPTER 7 OF THE FLORIDA
- 22. CONTRACTOR TO VERIFY ALL EXISTING CONDITIONS AS DOCUMENTED DUE TO
- 23. ALL DIMENSIONS AS SHOWN ON THE PLANS ARE TO STRUCTURE UNLESS OTHER WISE NOTED. ALL FINISH ROOM DIMENSIONS SHALL BE SHOWN AT LEAST 2" LESS THAN SHOWN ON
- 24. ALL EXISTING CONDITIONS SHOWN ON DRAWINGS ARE ACCURATE TO THE BEST OF OUR
- 25. ANY EXPOSED STEEL LEFT EXPOSED DURING DEMOLITION OR CONSTRUCTION SHALL BE PATCHED AND FIRE PROOFED.

PROPOSED FLOOR PLAN

Project Manager:

Drawing Name:

Drawn by:

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REVISIONS:

No: Date: Description:

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Total Sheets: Issue Date:

Exhibit 3

Page 1 of 7

DISCREPANCIES TO ARCHITECT PRIOR TO ANY WORK.

WRITTEN PERMISSION FROM LANDLORD AND OTHER TENANTS.


CONTRACTOR TO COORDINATE EXACT LOCATION WITH TENANT.

CERAMIC TILE OR WOOD.

DOWEL & EPOXY MIN. 4" INTO EXISTING SLAB, REINFORCEMENT LOCATED IN MIDDLE.

INSTALLATION/WORK CARRIED OUT

- 13. AISLES OF NOT LESS THAN 44" IN WIDTH SHALL BE ESTABLISHED TO PROVIDE ACCESS TO
- 16. CONTRACTOR TO ENSURE/VERIFY EXISTING POWER SUPPLY AVAILABLE IS ADEQUATE
- 17. CONTRACTOR TO PROVIDE ALL REQUIRED SAFEGUARDS AS PER THE FLORIDA FIRE
- 18. EGRESS DOORS TO BE EASILY OPERABLE AND WILL NOT REQUIRE A KEY OR ANY SPECIAL KNOWLEDGE TO OPERATE THE DOORS FROM THE EGRESS SIDE.
- EDITION), SECTION 10.2.2.
- 20. ANY AND ALL WOOD FINISHES UTILIZED ON THE PROJECT TO BE FIRE RETARDANT.
- FIRE PREVENTION CODE (SEVENTH EDITION), NFPA 101.
- UNCOMPLETED AND TEMPORARY WORK PREVIOUSLY COMPLETED.
- THESE DRAWINGS, AND WILL BE NOTED ON THE PLANS AS SUCH
- KNOWLEDGE. IN THE EVENT OF ANY INCONSISTENCY NOTIFY THE ARCHITECT.

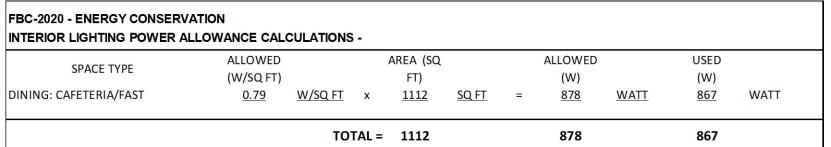

FLORIDA BUILDING CODE 2020 ENERGY CONSERVATION: SECTION 405.2 LIGHTING CONTROLS PROVIDE A CONTACTOR WITH AN ASTRONOMICAL TIME CLOCK TO TURN OFF ALL OTHER LIGHTS AND CONTROLLED RECEPTACLES DURING OFF BUSINESS HOURS.

PROVIDE TIME CLOCK BYPASS SWITCHES AT LOCATIONS SHOWN ON THE PLAN. THE BYPASS SWITCHES MUST BE CAPABLE OF OVERRIDING TIME OF DAY SCHEDULED SHUT-OFF CONTROL FOR NO MORE THAN TWO HOURS AND BE EQUIPPED WITH LED.

THE AUTOMATIC TIME SWITCH CONTROL DEVICE INSTALLED SHALL INCORPORATE AN AUTOMATIC HOLIDAY SCHEDULING FEATURE THAT TURNS OFF ALL LOADS FOR AT LEAST 24 HOURS, THEN RESUMES THE NORMALLY SCHEDULED OPERATION. ALL EMERGENCY AND EXIT LIGHTS TO BE CONNECTED AHEAD OF ANY

SWITCH OR TIME CLOCK. (LIGHTING INTENDED FOR 24HR OPERATION IS EXEMPT FROM THE REQUIREMENTS OF THIS CODE.)

CIRCUITS ON AUTOMATIC TIME SWITCH:

B-14. SIGN: B-10.


RECEPTACLES ON TIME CLOCK: B-15.

THIS DESIGN COMPLIES WITH THE REQUIREMENTS OF ASHARE 90.1 (2013) SECTION 8 AS ADOPTED BY THE FIFTH EDITION (2014) FLORIDA BUILDING CODE IN THE ENERGY CODE (FBC CE 405).

AUTOMATIC RECEPTACLE CONTROL AT LEAST 50% OF ALL 120V 15 AND 20 AMPERE RECEPTACLES, INCLUDING THOSE INSTALLED IN MODULAR PARTITIONS AND IN THE FOLLOWING SPACES: PRIVATE OFFICES, CONFERENCE ROOMS, PRINTING AND COPYING, BREAK ROOMS, CLASS ROOMS AND INDIVIDUAL WORKSTATIONS SHALL BE CONTROLLED BY AN AUTOMATIC CONTROL DEVICE THAT SHALL FUNCTION ON: A. A SCHEDULED BASIS USING A TIME OF DAY OPERATED CONTROL DEVICE THAT TURNS RECEPTACLES OFF AT SPECIFIC

PROGRAMMED TIMES AND INDEPENDENT PROGRAM SCHEDULE SHALL BE PROVIDE FOR AREAS OF NO MORE THAN 25000 SG FT BUT NO MORE THAN ONE FLOOR, OR B. AN OCCUPANT SENSOR THAT SHALL TURN RECEPTACLES OFF WITHIN 30 MINUTES OF ALL OCCUPANTS LEAVING A SPACE, OR C. A SIGNAL FROM ANOTHER CONTROL OR ALARM SYSTEM THAT INDICATES THE AREA IS UNOCCUPIED.


RECEPTACLES FOR THE FOLLOWING SHALL NOT REQUIRE AN AUTOMATIC CONTROL DEVICE: A. RECEPTACLES SPECIFICALLY DESIGNATED FOR EQUIPMENT REQUIRING 24 HOUR OPERATION. B. SPACES WHERE AN AUTOMATIC SHUTOFF WOULD ENDANGER THE SAFETY OR SECURITY OF THE ROOM OR BUILDING OCCUPANT(S).

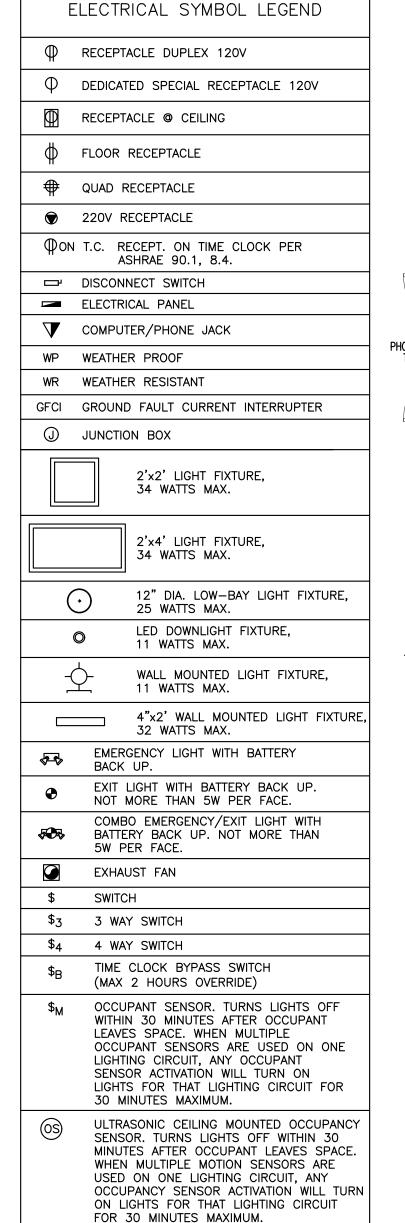

OCCUPANCY SENSOR SHALL BE SELECTED TO PROVIDE FULL COVERAGE FOR THE AREA IT SERVES. ALL RECEPTACLES TO BE @ 15" AFF TO BOTTOM OF RECEPTACLE UNLESS NOTED OTHERWISE OR ABOVE COUNTER. ALL SWITCHES TO BE @ 48" AFF TO TOP OF SWITCH UNLESS NOTED


OTHERWISE.

	KITCHEN EQUIPMENT SCHEDULE							
NO.	QTY.	DESCRIPTION	MANUFACTURER	MODEL No.	REMARKS			
1	1	FLAV-R 2-GO LOCKER SYSTEM - FLOOR MOUNT	HATCO	F2G-24-C				
2	2	SANDWICH/SALAD PREPARATION REFRIGERATOR	BISON REFRIGERATION	BST-48				
3	2	HOT SERVING COUNTER/TABLE	ATOSA USA	CSTEA-3C				
4	1	POS SYSTEM	TBD	TBD				
5.1	1	RANGE, STOCK POT - (1) BURNER	ATOSA USA	ATSP-18-1				
5.2	1	RANGE, STOCK POT - (2) BURNERS	ATOSA USA	ATSP-18-2				
6	2	GAS FRYER	ATOSA USA	ATFS-40				
7	2	36" 4-BURNER RANGE W/ 12" GRIDDLE	SERV-WARE	SGR-4B-12G				
8	-	NOT USED						
9	1	IN-COUNTER HAND SINK	KROWNE	HS-1225	WITH KROWNE 15-306I DECK MOUNT FAUCET			
10	1	SALAD/PREP SINK	KROWNE	HS-2017	WITH KROWNE 15-308I DECK MOUNT FAUCET			
11	1	3-COMPARTMENT SINK	ATOSA USA, INC.	MRSA-3-D	WITH KROWNE 17-108WL FAUCET			
12	1	WALL MOUNTED HAND SINK	KROWNE	HS-26L	WITH KROWNE 15-306I DECK MOUNT FAUCET			
13	1	3-DOOR REACH-IN REFRIGERATOR	ATOSA USA	MBF8508GR				
14	1	2-DOOR REACH-IN FREEZER	ATOSA USA	MBF8503GR				
15	3	WIRE SHELVING - 18" W. x 48" L. x 75" H.	TBD	TBD	BY SPECIALTY MANUFACTURER			
16	1	PREP TABLE - 12" W. x 30" L. x 34" H.	TBD	TBD	BY SPECIALTY MANUFACTURER			

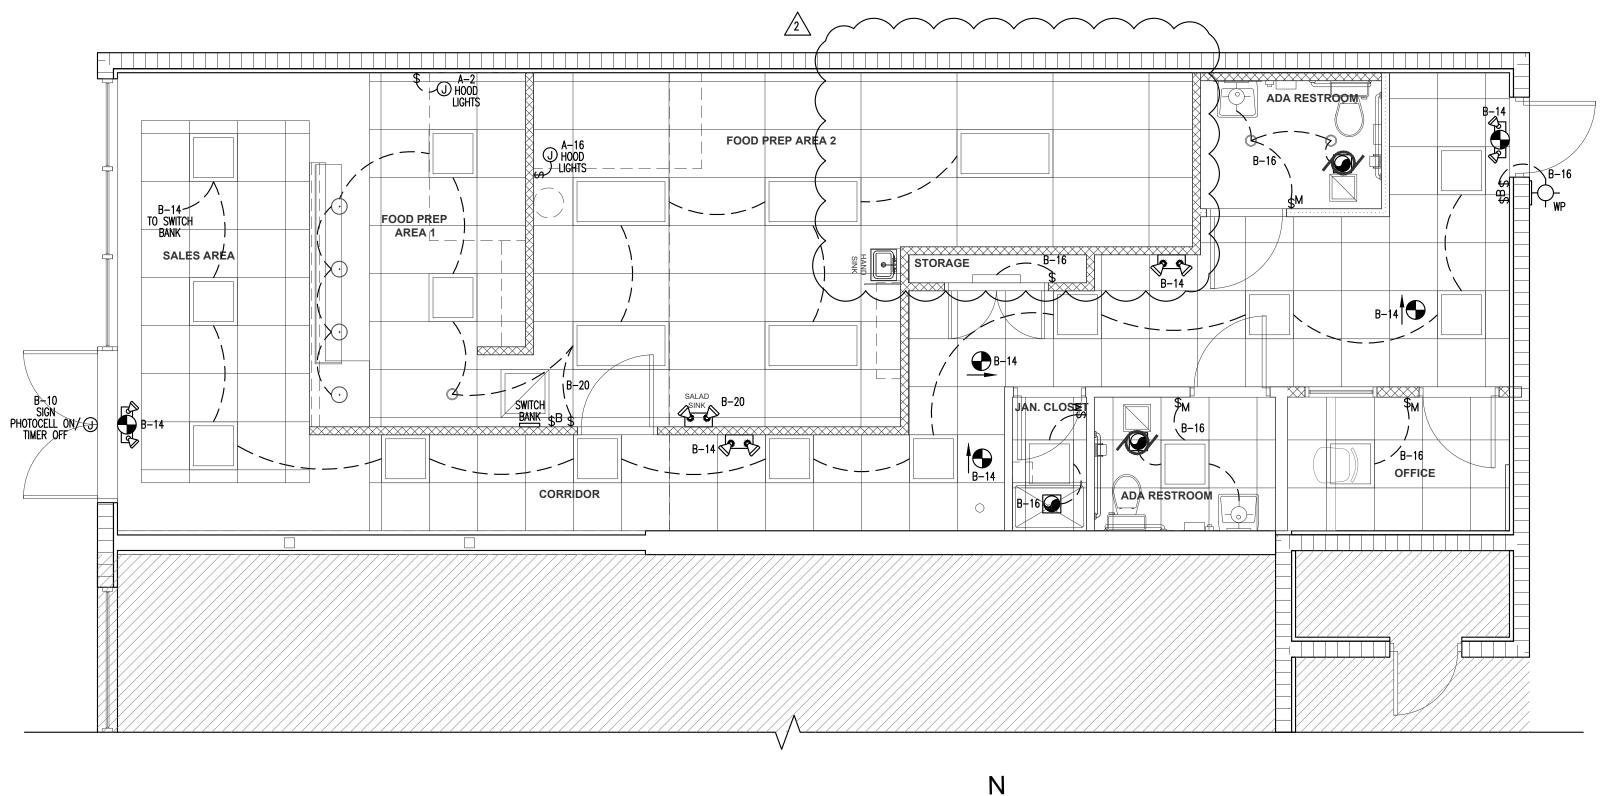

LIGHTING PLAN

SCALE: 1/4" = 1'-0"

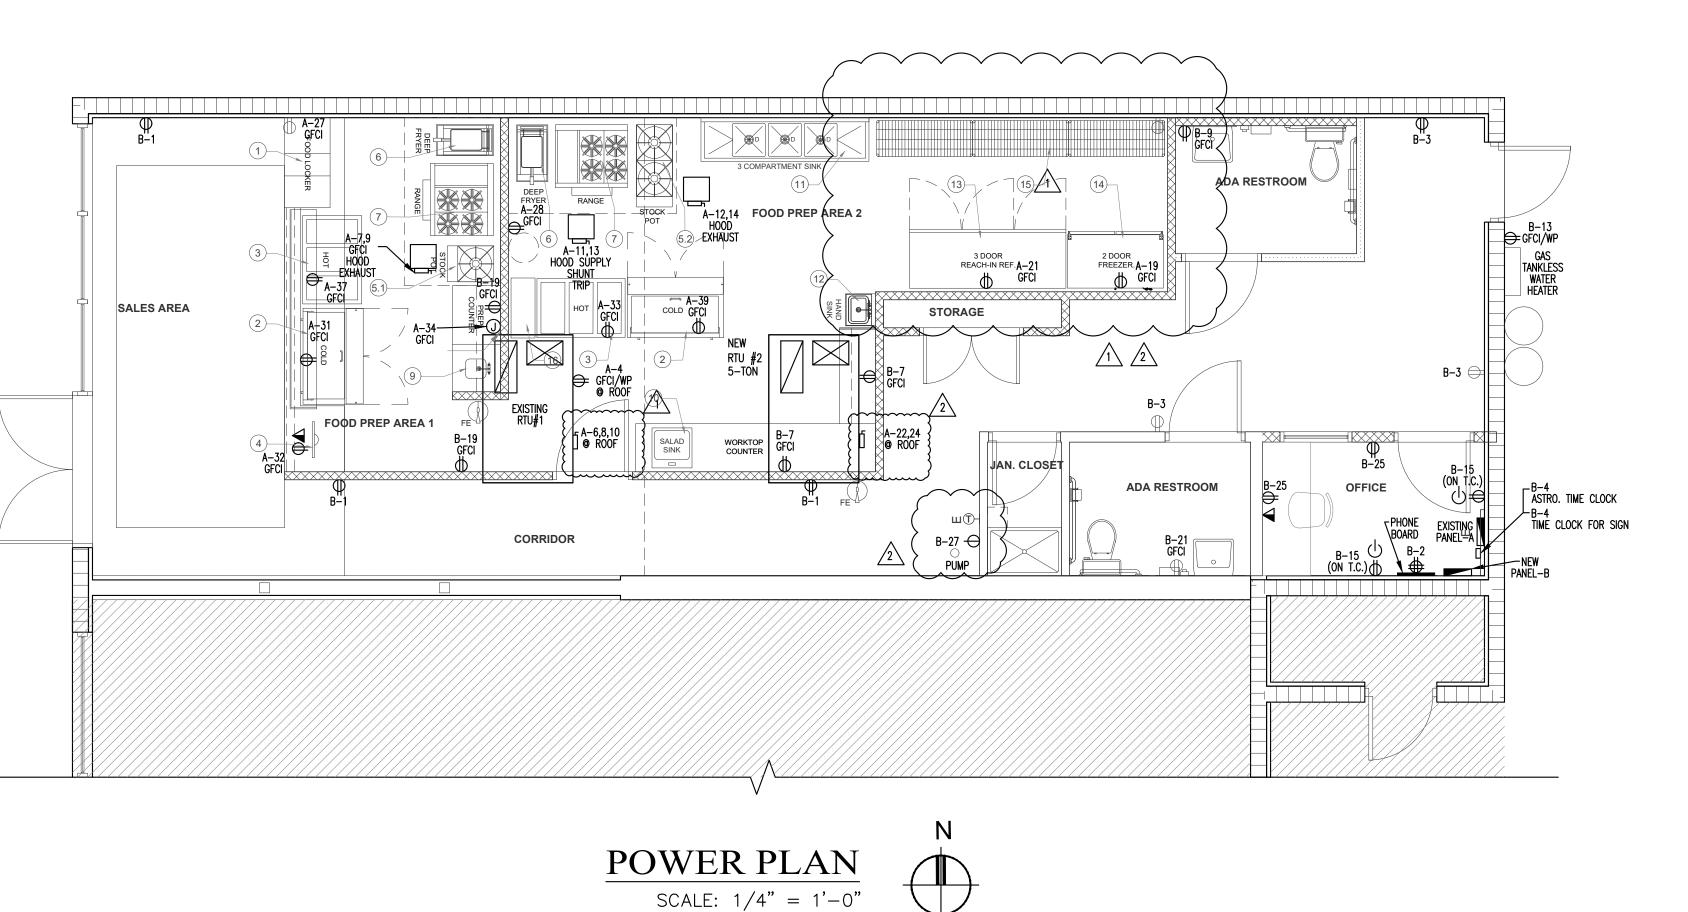

CAM #22-0358 Exhibit 3

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REVISIONS:

Principal:

Drawing No:

roject No:

Printed copies of this document are not considered signed and sealed and the signature must be verified on any electronic copies.

BUCHANAN P.E CONSULTING INC. WHEN DIGITALLY SIGNED

ELECTRICAL * MECHANICAL * PLUMBING ENGINEERING 6191 W. ATLANTIC BLVD, SUITE# 2 MARGATE, FL 33063

> CERTIFICATE OF AUTHORIZATION # 8842 RAJA BUCHANAN P.E # 48916

Ph: 954-590-3300 Fax: 954-590-2232 Email: BUCHANAN@MEPENGINEERS.COM

Project Manager: Drawn by: Drawing Name:

ELECTRICAL

PLAN

Total Sheets: Issue Date:

No: Date: Description:

1 7/22/21 CORRECTIONS

2 2/8/22 COORDINATION

Page 2 of 7

GENERAL ELECTRICAL NOTES ALL WORK SHALL BE DONE IN ACCORDANCE WITH THE NATIONAL ELECTRICAL CODE (N.E.C. 2017), FLORIDA BUILDING CODE 2020 AND GOVERNING MUNICIPAL, STATE AND LOCAL CODES. ALL MATERIAL SHALL BE NEW AND SHALL BEAR THE U.L. LABEL WHERE APPLICABLE. ALL WORK SHALL BE PERFORMED BY A LICENSED ELECTRICAL CONTRACTOR IN A FIRST CLASS WORKMANLIKE MANNER. THE COMPLETED SYSTEM SHALL BE FULLY OPERATIVE AND ACCEPTED BY THE IT IS NOT THE INTENT OF THESE PLANS TO SHOW EVERY MINOR DETAIL OF CONSTRUCTION. THE CONTRACTOR IS EXPECTED TO FURNISH AND INSTALL ALL ITEMS FOR A COMPLETE ELECTRICAL SYSTEM AND PROVIDE ALL REQUIREMENTS NECESSARY FOR EQUIPMENT TO BE PLACED IN PROPER WORKING CONTRACTOR SHALL MAKE ALL NECESSARY CUTTING AND DO ALL THE REPATCHING AS NECESSARY FOR THE PROPER EXECUTION OF THIS WORK. AFTER COMPLETION OF THE INSTALLATION, THE SYSTEM SHALL TEST FREE FROM SHORT CIRCUITS AND GROUNDS. WHERE ELECTRICAL CONDUCTORS ARE INSTALLED IN CONDUIT, THE CONDUIT SHALL COMPLY WITH THE N.E.C. REQUIREMENTS. ALL CONDUCTORS SHALL BE COPPER. NO CONDUCTOR SHALL BE SMALLER THAN #12 AWG AND SHALL BE RATED FOR 600VOLTS THWN OR THHN INSULATION. INSTALL A GROUNDING CONDUCTOR WITH ALL CIRCUITS, UNLESS NOTED OTHERWISE, SIZED PER N.E.C. 250-122. VERIFY BREAKER AND CORRESPONDING WIRE SIZES FOR ALL ELECTRICAL EQUIPMENT. DO NOT ORDER MATERIAL BEFORE VERIFYING BREAKER & WIRE SIZE. REPORT ANY DISCREPANCY IMMEDIATELY TO THE ENGINEER OF RECORD. ALL OUTDOOR DISCONNECTS AND ELECTRICAL PANELS TO BE NEMA-3R. ALL OUTDOOR DISCONNECTS AND ELECTRICAL PANELS IN A SALT SPRAY AREA TO BE NEMA-4X. 10. PANELS SHALL BE SQUARE 'D', GENERAL ELECTRIC OR EQUAL, TYPE AND NUMBER OF BREAKERS AS INDICATED ON PANEL SCHEDULE, STENCIL PANEL DESIGNATION ON INSIDE OF PANEL. ALL TWO-POLE BREAKERS SHALL BE COMMON TRIP. PROVIDE TYPE WRITTEN SCHEDULE IN EACH LOAD CENTERS. CONNECTION TO MAIN BUS SHALL BE WITH BURNDY ANNULAR COMPRESSION LUGS. PANELS AIC RATING SHALL BE AS INDICATED ON PLANS. . PROVIDE NAMEPLATES FOR ALL PANEL BOARDS, DISCONNECTS, TRANSFORMER, TERMINAL CABINETS AND ALL ELECTRICAL EQUIPMENT IDENTIFIED BY NAME ON DRAWINGS. 12. ALL ELECTRICAL MATERIALS, DEVICES, APPLIANCES AND EQUIPMENT SHALL BE LABEL LISTED BY AN APPROVED THIRD PARTY TESTING AGENCY. 13. LOAD DATA IS BASED ON INFORMATION GIVEN ENGINEER AT TIME OF DESIGN, VERIFY ALL EQUIPMENT AND PANEL SIZES BEFORE ORDERING AND BEFORE INSTALLATION. 14. ALL EXTERIOR ELECTRICAL EQUIPMENT SHALL BE ANCHORED TO COMPLY WITH LOCAL CODE FOR WIND RESISTANCE. 15. ALL ELECTRICAL AND COMMUNICATIONS OUTLETS TO BE AT 15" A.F.F TO BOTTOM OF OUTLET (MINIMUM) UNLESS OTHERWISE NOTED, ALL LIGHT SWITCHES SHALL BE @ 48" AFF. TO TOP OF SWITCH. 16. TIME CLOCK FOR LIGHTING CONTROL TO BE AN ASTRONOMICAL TIME CLOCK. 17. THE CONTRACTOR SHALL CONTACT THE LOCAL POWER COMPANY AND OBTAIN, IN WRITING, THE AVAILABLE FAULT CURRENT OF THE UTILITY TRANSFORMER. THE CONTRACTOR SHALL ENSURE THAT ALL ELECTRICAL EQUIPMENT HAS AN AMP INTERRUPTING CAPACITY (AIC) GREATER THAN THE AVAILABLE FAULT CURRENT AT ANY POINT IN THE ELECTRICAL DISTRIBUTION SYSTEM. ALL CONDUCTORS SHALL BE INSTALLED IN ELECTRICAL METALLIC TUBING (EMT) OR MC CABLE & FLEXIBLE METAL CONDUIT (GREENFIELD) AS PER NEC 330-10, PROVIDED IT IS USED IN NON DESTRUCTIVE OR CORROSIVE SURROUNDINGS AS SPECIFIED IN NEC 2017 330-12. ALL FITTINGS AND COUPLINGS FOR EMT CONDUIT SHALL BE ALL STEEL RAIN TIGHT COMPRESSION TYPE OR ALL STEEL CONCRETE TIGHT SET SCREW TYPE. SCHEDULE 40 PVC CONDUIT, WITH FITTINGS AND COUPLINGS APPROPRIATE FOR THE USE, SHALL BE USED UNDERGROUND OR BELOW SLABS ON GRADE. 9. BRANCH-CIRCUIT WIRING. OTHER THAN 2-WIRE OR MULTIWIRE BRANCH CIRCUITS SUPPLYING POWER TO LUMINAIRES CONNECTED TOGETHER. SHALL NOT BE PASSED THROUGH AN OUTLET BOX THAT IS AN INTEGRAL PART OF A LUMINAIRE UNLESS THE LUMINAIRE IS IDENTIFIED FOR THROUGH-WIRING. LUMINAIRES SHALL NOT BE USED AS A RACEWAY FOR CIRCUIT CONDUCTORS UNLESS LISTED AND MARKED FOR USE AS A RACEWAY. PROVIDE J-BOXES AS REQUIRED. 20. SEAL ALL NEW CONDUIT PENETRATIONS THROUGH FIRE RATED WALLS. CEILINGS. FLOORS. ETC.. TO EQUIPMENTS PENETRATING FIRE RATED ENVELOPES, SPACES, ECT. ELECTRICAL CONTRACTOR IS RESPONSIBLE TO PROVIDE WIRING FOR HVAC SYSTEM: A/C EQUIPMENT(S), SMOKE DETECTORS, THERMOSTATS, TEST STATIONS, MOTORIZED VOLUME DAMPERS, ETC. ELECTRICAL CONTRACTOR SHALL COORDINATE WITH MECHANICAL DRAWINGS AND PROVIDE ALL NECESSARY CONTROL WIRING. ELECTRICAL CONTRACTOR TO THOROUGHLY REVIEW MECHANICAL PLANS AND PROVIDE POWER TO ANY MECHANICAL EQUIPMENT OR DEVICE THAT IS NOT SHOWN ON ELECTRICAL PLANS BUT IS SHOWN ON MECHANICAL PLANS. 22. INSTALL "GFCI" GROUND FAULT INTERRUPTER RECEPTACLES WITH WEATHERPROOF COVER WITHIN 25 FT OF HVAC EQUIPMENT, MOUNT RECEPTACLE ON UNISTRUT (UNLESS HVAC EQUIPMENT IS SPECIFIED WITH FACTORY INSTALLED CONVENIENT RECEPTACLE) . 23. WHEN NEW ELECTRIC SERVICE IS BEING INSTALLED, IT IS THE GENERAL CONTRACTOR'S RESPONSIBILITY TO COORDINATE WITH FPL/FPL ENGINEERS ON THE SIZE OF THE FPL TRANSFORMER THAT IS REQUIRED TO PROVIDE THE NEW ELECTRIC SERVICE SHOWN ON ELECTRIC PLANS, GC HAS TO INFORM THE OWNER ABOUT ANY EXTRA FPL CHARGES THAT MIGHT OCCUR IN ORDER TO PULL NEW SERVICE. THIS HAS TO BE DONE AS EARLY AS POSSIBLE DURING THE BIDDING PROCESS. 24. ELECTRICAL SERVICE EQUIPMENT MUST BE 3' ABOVE MSL, AND 8' ABOVE N.V.G.D. VERIFY AT SITE. ALL ELECTRICAL EQUIPMENTS SHALL BE INSTALLED ABOVE FLOOD LEVEL. 25. CONTRACTOR MUST VISIT THE SITE PRIOR TO BID OR CONSTRUCTION TO VERIFY ALL EXISTING CONDITIONS, BEFORE SUBMITTING BID, BECOME THOROUGHLY FAMILIAR WITH ACTUAL EXISTING CONDITIONS AT THE BUILDING SITE. THE INTENT OF THE WORK IS SHOWN ON THE DRAWINGS AND DESCRIBED HEREINAFTER. BY THE ACT OF SUBMITTING A BID PROPOSAL FOR WORK, THE CONTRACTOR SHALL BE DEEMED TO HAVE MADE SUCH STUDY AND EXAMINATION AND TO ACCEPT ALL CONDITIONS PRESENT AT THE SITE. NO REQUEST FOR ADDITIONAL PAYMENT SHALL BE CONSIDERED AS VALID, DUE TO THE FAILURE TO ALLOW FOR CONDITIONS WHICH MAY EXIST. CONTRACTOR TO REPLACE ANY EXISTING DEVICE OR COMPONENT THAT IS CALLED AS EXISTING IF IT IS NOT FULLY OPERATIONAL. 26. WIRING METHODS IN ALL PATIENT CARE AREAS TO BE IN COMPLIANCE WITH REDUNDANT GROUNDING REQUIREMENTS OF NEC 2017 SECTION 517.13. 27. ALL DIMMING MECHANISMS HAVE TO BE COMPATIBLE WITH FIXTURE DIMMING REQUIREMENTS. CONTRACTOR MUST VERIFY ALL DIMMING MECHANISM AND FIXTURE DIMMING REQUIREMENTS BEFORE ANY ORDERING, INSTALLING, OR WIRING OF ANY DIMMING MECHANISMS AND FIXTURES. 28. ALL OUTDOOR RECEPTACLES TO BE GFCI & WEATHER PROOF. 29. CONTRACTOR MUST REVIEW THE OWNER WORK LETTERS AND PROTOTYPE DRAWINGS PRIOR TO BID OR CONSTRUCTION TO VERIFY ALL REQUIREMENTS. BEFORE SUBMITTING BID, BECOME THOROUGHLY FAMILIAR WITH THE OWNER WORK LETTERS AND PROTOTYPE DRAWINGS. THE INTENT OF THE WORK IS SHOWN ON THE DRAWINGS AND DESCRIBED HEREINAFTER. BY THE ACT OF SUBMITTING A BID PROPOSAL FOR WORK, THE CONTRACTOR SHALL BE DEEMED TO HAVE MADE SUCH STUDY AND EXAMINATION PROVIDED IN WRITING TO THE ENGINEER/ARCHITECT ANY DISCREPANCIES. NO REQUEST FOR ADDITIONAL PAYMENT SHALL BE CONSIDERED AS VALID DUE TO THE FAILURE TO ALLOW FOR COORDINATION. CONTRACTOR TO PROVIDE THE TENANT WITH ALL REQUIRED ITEMS.

PER FLORIDA BUILDING CODE 2020 ENERGY CONSERVATION:

2.FLOOR PLANS INDICATING LOCATION AND AREA SERVED FOR ALL DISTRIBUTION

3.NAMES AND ADDRESSES OF AT LEAST ONE QUALIFIED SERVICE AGENCY.

NOTIFY ENGINEER IF ANY DISCREPANCY PRIOR TO

BUYING/INSTALLING ANY MATERIAL/EQUIPMENT

ALL NEW RECEPTACLES IN <u>DAMP LOCATIONS</u> INDICATED AS

ALL NEW RECEPTACLES IN <u>WET LOCATIONS INDICATED</u> AS

ENCLOSURE THAT IS WEATHER-PROOF WHETHER OR NOT THI

RECEPTACLES SHALL BE LISTED WEATHER-RESISTANT TYPE.

WEATHER-RESISTANT ON PLAN (WR) SHALL HAVE AN

ATTACHMENT PLUG CAP IS INSERTED. NONLOCKING

CONTRACTOR TO COORDINATE EXACT LOCATION

OF RECEPTACLE OUTLETS AND DATA OUTLETS

WITH ARCHITECTURAL DRAWINGS, FURNITURE

DRAWINGS AND EQUIPMENT SPECS PRIOR TO

LEVEL OF DETAIL (LOD) OF THIS DRAWINGS IS

POWER/DATA OUTLETS MAY VARY DEPENDING ON

1#6 CU GRD IN

OTHERS

EXISTING

DISC.

120/240V

3 PHASE

2" CONDUIT

OTHERS

EXISTING

120/240V

3 PHASE

EXISTING 4#3/0 CU &

1#4 CU GRD IN

EXISTING

4#3/0 CU &

2" CONDUIT

I#4 CU GRD IN

" CONDUIT

1#4 CU GRD IN

EXISTING

4#3/0 CU &

2" CONDUIT

1#4 CU GRD IN

" CONDUIT

ELECTRICAL RISER DIAGRAM

1#4 CU GRD IN

NTS

2" CONDUIT

AIC=42KA MIN.

EXISTING

#3/0 CU

EXISTING

DISC.

EXISTING

HOUSE PANEL

120/240V

3 PHASE

EXISTING

3 SETS OF

3" CONDUIT

(EACH SET)

TO FLORIDA

POWER & LIGHT

4#350 MCM CU IN |

SCHEMATIC. SPECIFIC LOCATIONS OF

OWNERS PREFERENCES AND/OR FIELD

WEATHERPROOF ON PLAN (WP) SHALL HAVE AN ENCLOSURE THAT IS WEATHERPROOF WHETHER OR NOT THE ATTACHMENT

405.5.3 VOLTAGE DROP.

MAXIMUM OF 5 PERCENT VOLTAGE DROP TOTAL.

PROVIDED TO THE BUILDING OWNER, INCLUDING:

INCLUDE, AT A MINIMUM, THE FOLLOWING:

EXPECT COPIES OF ANY OF THE MATERIALS.

PER N.E.C. 2017 406.9

PLUG CAP IS INSERTED.

INSTALLATION.

CONDITIONS.

SYMBOL DENOTES


CONTROLLED RECEPTACLE ON


CONTACTOR AND MUST BE


MARKED 'CONTROLLED'

EQUIPMENT REQUIRING MAINTENANCE.


405.5.4 COMPLETION REQUIREMENTS.

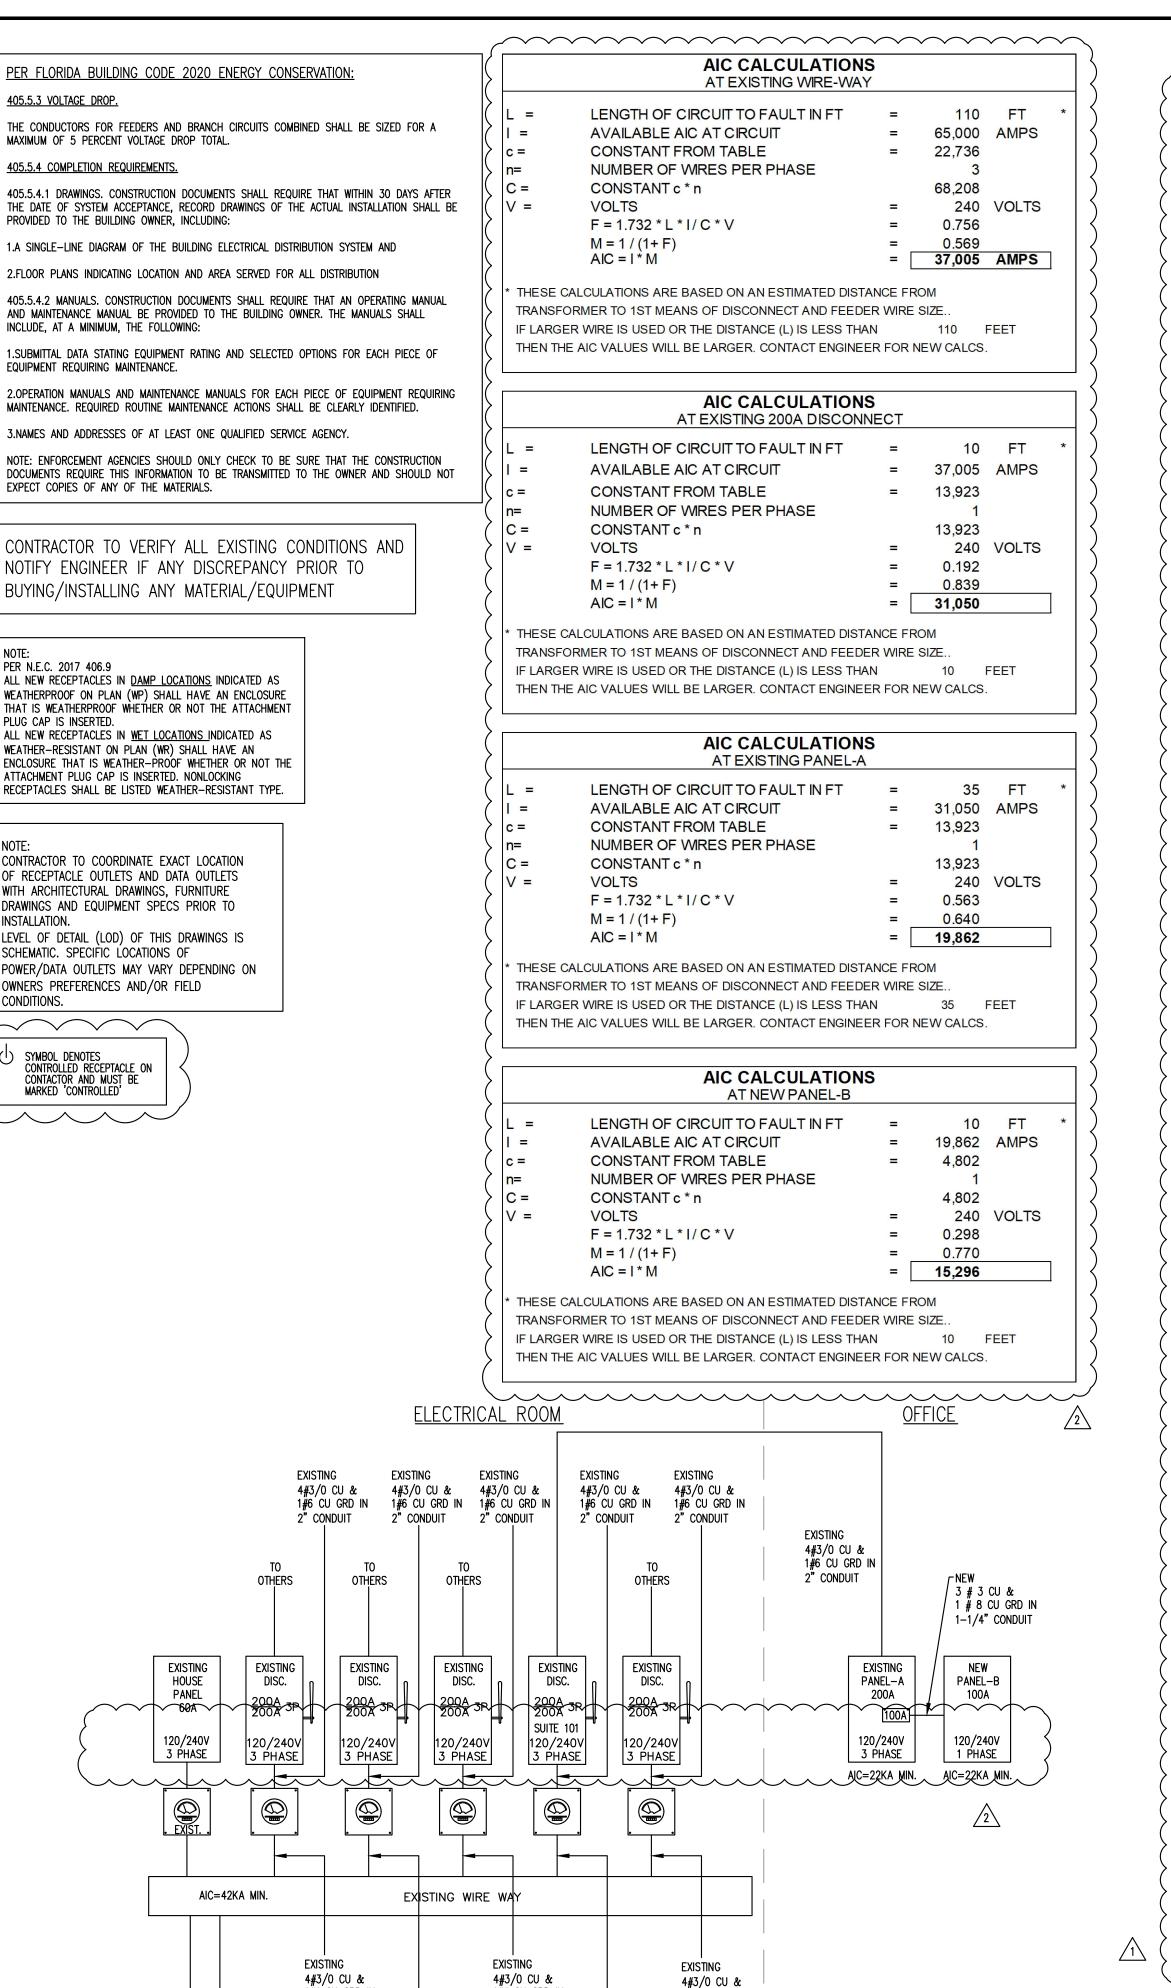

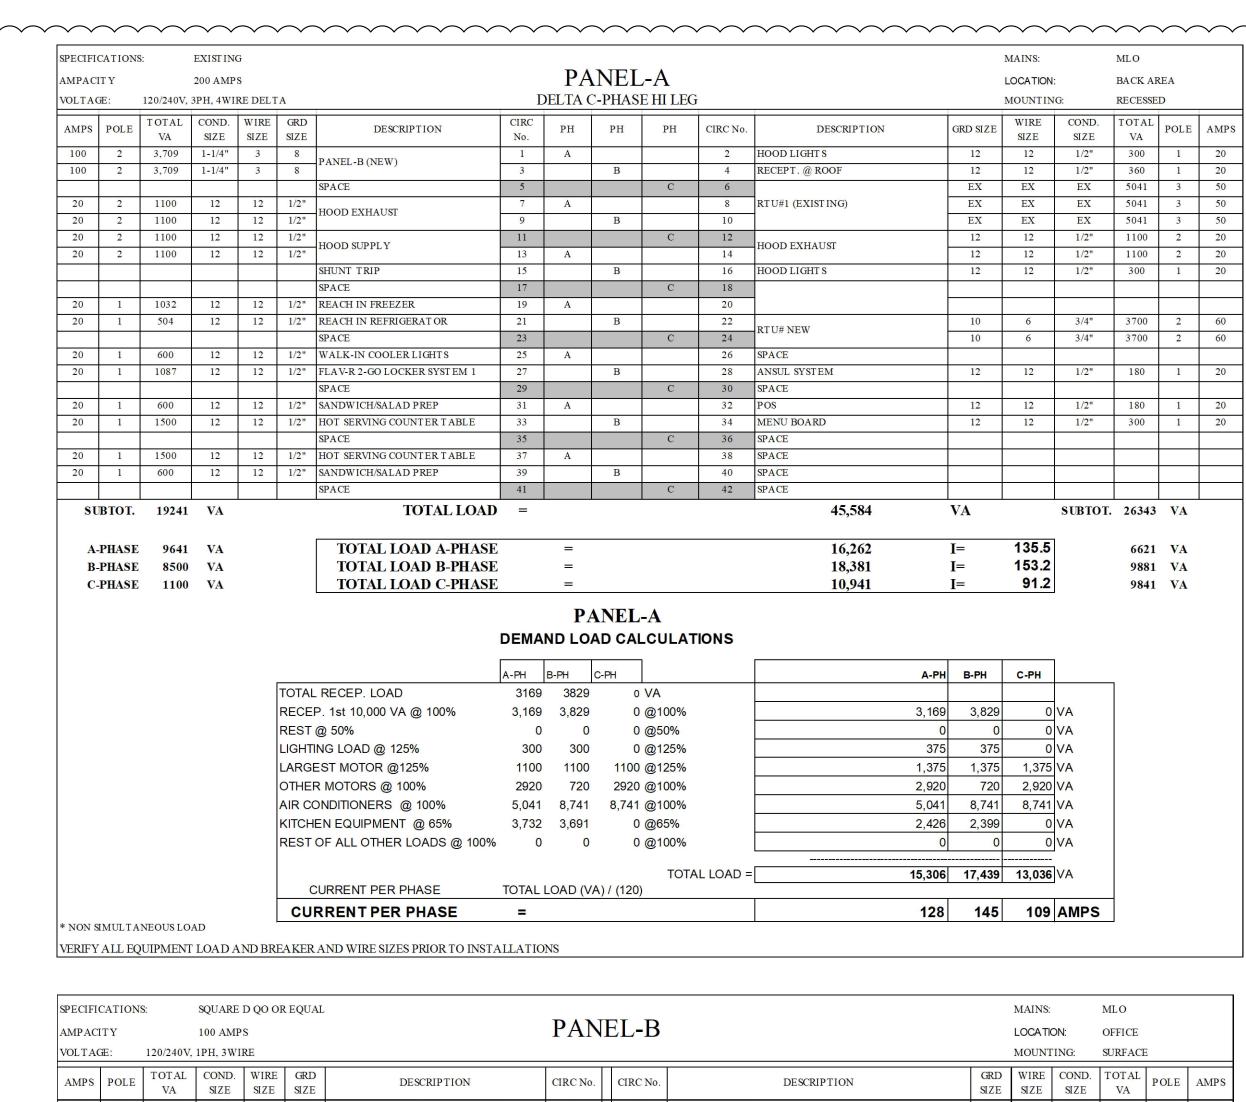

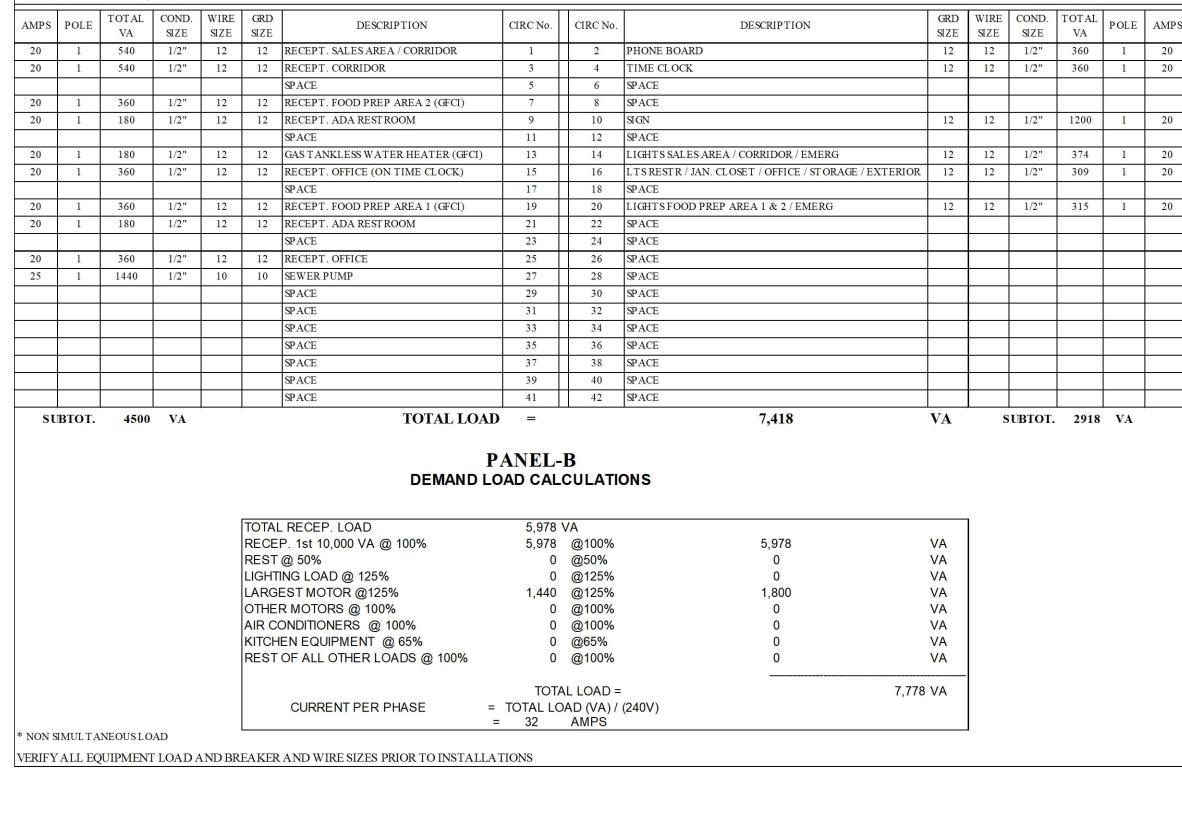

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BUCHANAN P.E CONSULTING INC. WHEN DIGITALLY SIGNED. ELECTRICAL * MECHANICAL * PLUMBING document are not considere signed and sealed and the signature must be verified on any electronic copies. ENGINEERING 6191 W. ATLANTIC BLVD, SUITE# 2 MARGATE, FL 33063 Ph: 954-590-3300 Fax: 954-590-2232 Email: BUCHANAN@MEPENGINEERS.COM CERTIFICATE OF AUTHORIZATION # 8842

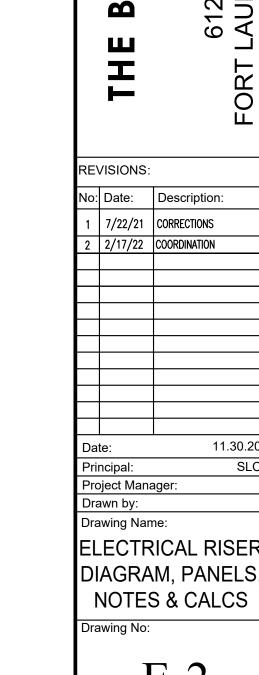RAJA BUCHANAN P.E # 48916

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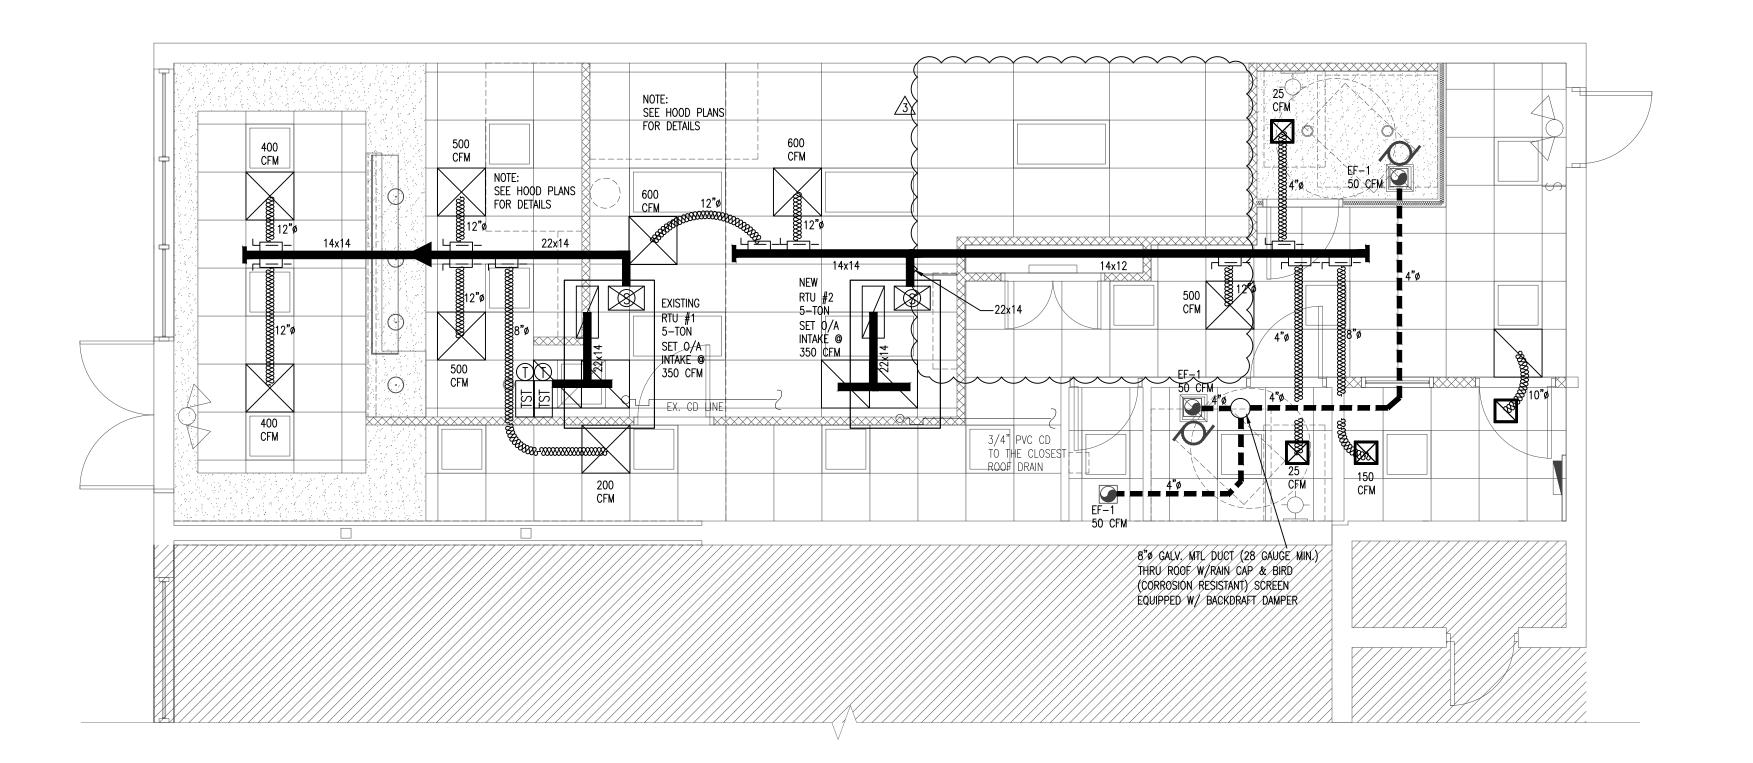
Page 3 of 7

CAM #22-0358 Exhibit 3

OA OUTSIDE AIR		
EXHAUST FAN		
HVAC DESIGN R	EQUIREME	NTS
DESIGN REQUIRMENT	YES	NO
DUCT SMOKE DETECTOR		X
FIRE DAMPERS(S)		X
SMOKE DAMPER(S)		Х
FIRE RATED ENCLOSURE		X
FIRE RATED ROOF/FLOOR		X
CEILING ASSEMBLY		X
FIRE STOPPING		X
SMOKE CONTROL		X

Ventilation per FBC-M 2020 Table 403.3.1	.1
Ventilation Zone Name	CAFÉ
1) Minimum O/A required at Supply Outlet Voz:	
Exhaust Required (CFM/ft²)	-1
a) Occupant Category (table 6-1): Occupant Rate Requirements Rp =	7.5
Building Rate Requirements Ra =	0.18
b) Estimated No. of Occupants in the Zone Pz =	15
c) Zone Net Occupied Area Az =	1100
d) O/A required in Breathing Zone (eq. 6-1 Vbz =RpPz + RaAz) Vbz =	311
e) Zone Air Distribution Effectiveness (table 6-2) <i>Ez =</i>	1
f) Min. O/A required at Supply Oultelts (Eq. 6-2 Voz = Vbz/Ez) Voz =	311
SET O/A INTAKE FOR EXISTING RTU-1 AT:	350 CFM
SET O/A INTAKE FOR NEW RTU-2 AT:	350 CFM
NOTE: PROVIDE MOTORIZED DAMPER FOR ALL AIR CONDITIONER'S O/A INTAKE.	

RTU SPECS: CARRIER OR EQUAL ((208/1/60)
TAG	RTU #2
NOM TONS	5.0
SEER	16.0
MODEL NO:	50GC*M06-3
CFM	1900
REFRIGERANT	R-410A
AMBIENT	95
CAP (MBH) @ 80/67 (TC/SC)	63.0 / 46.3
COMPRESSOR QTY / STAGES	1/2
COMPRESSOR RLA - LRA	22.9 - 147.0
COND. FAN QTY / FLA - HP	1 / 1.5 - 1/4
EVAP. FAN FLA - BHP	8.6 - 1.4
HEATER KW	6.5
MCA	50
MOCP	60
DIMENSIONS (LxWxH) (IN)	75 x 47 x 42
STD WEIGHT (LBS)	614





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612 NW 9TH AVENUE, LAUDERDALE, FLORID, REVISIONS: No: Date: Description: 3. 02-09-22 OWNER CHANGES

ARCHITECTS - INTERIOR DESIGNERS
CENTER ROAD, SUITE 202
A RATON, FLORIDA 33486
PHONE (954) 971-1010
ARCHIRES. NO. 6819 CORP. NO. AAZGOO1647

3331


Principal: Project Manager: Drawn by:


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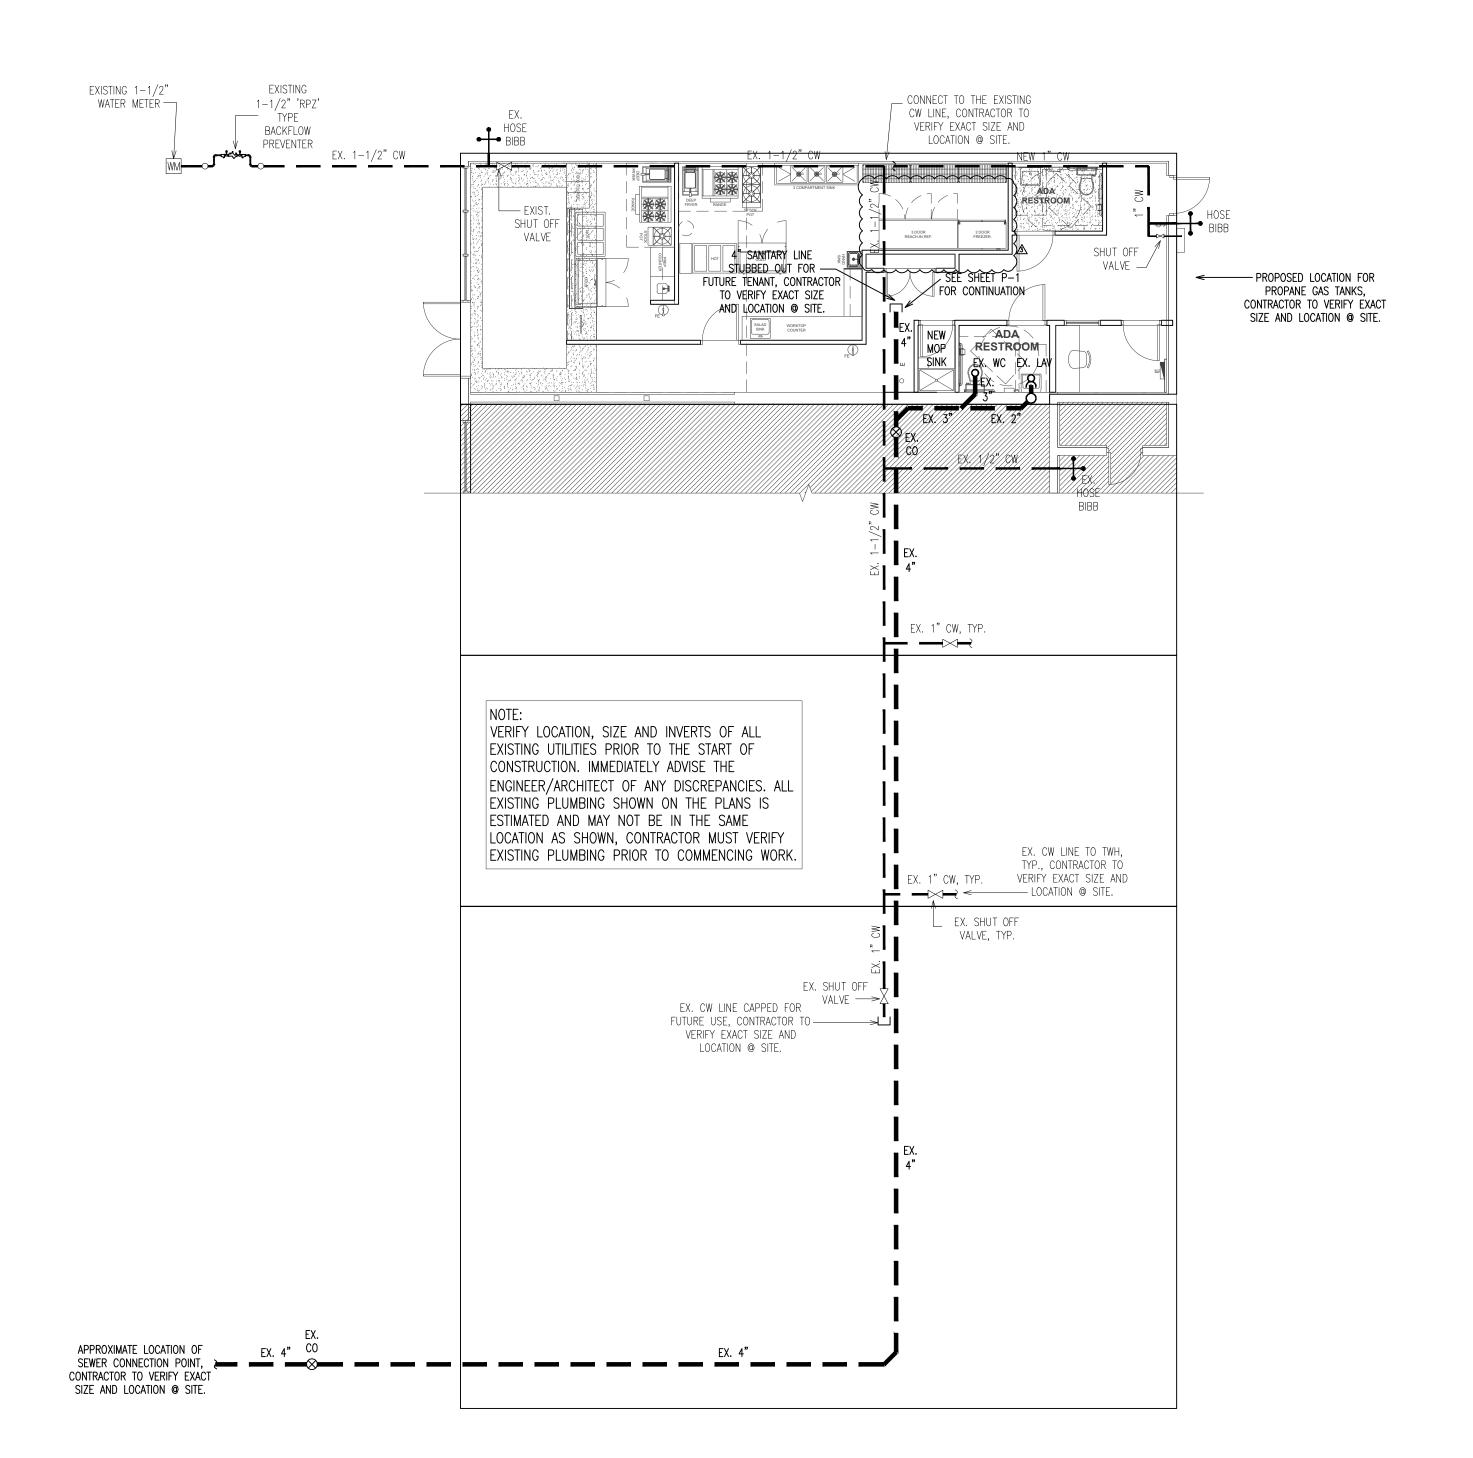
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PLUMBING SITE PLAN

SCALE: 1/8" = 1'-0"

BUCHANAN P.E CONSULTING INC.

ELECTRICAL * MECHANICAL * PLUMBING

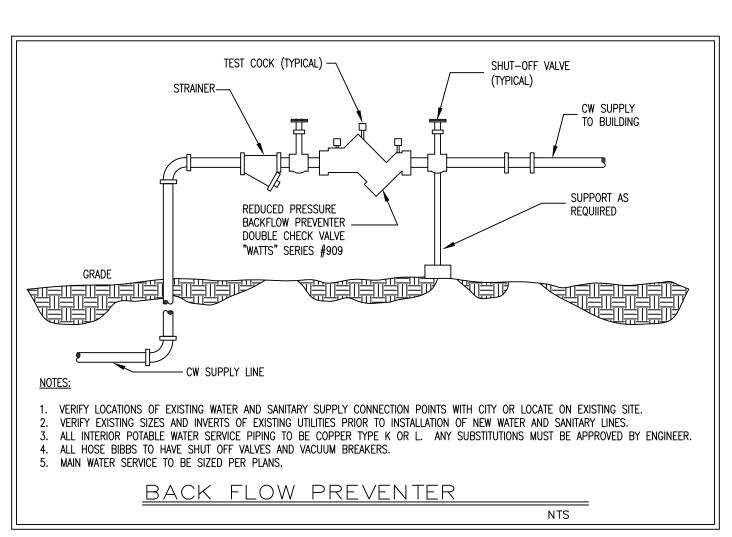ENGINEERING

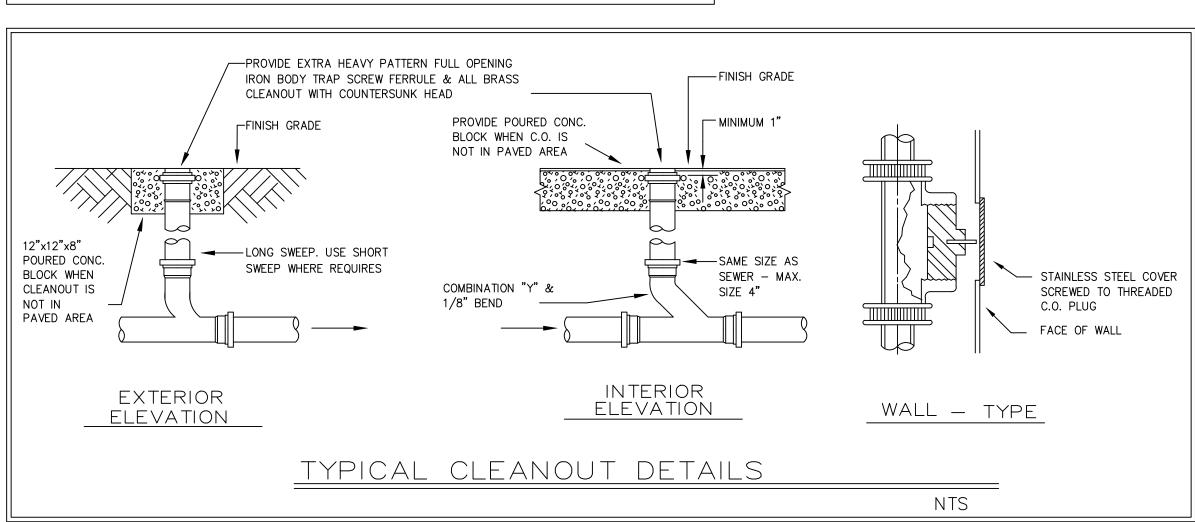6191 W. ATLANTIC BLVD, SUITE# 2 MARGATE, FL 33063

Ph: 954-590-3300 Fax: 954-590-2232

Email: BUCHANAN@MEPENGINEERS.COM

CERTIFICATE OF AUTHORIZATION # 8842

RAJA BUCHANAN P.E # 48916

STEVEN L. COHEN
AND ASSOCIATES, P.A
ARCHITECTS - INTERIOR DESIGNER
S295 TOWN CENTER ROAD, SUITE 20;
BOCA RATON, FLORIDA 3348(
PHONE (954) 971-101(

IREE CAFE

THE BLUE TREE CAF
612 NW 9TH AVENUE,
FORT LAUDERDALE, FLORIDA 3

REVISIONS:

No: Date: Description:

3. 02-09-22 OWNER CHANGES


Date: 1.08.21
Principal:
Project Manager:
Drawn by: RAB


Drawing Name:
PLUMBING
SITE PLAN

Total Sheets: Issue Date:

Drawing No:

Project No:

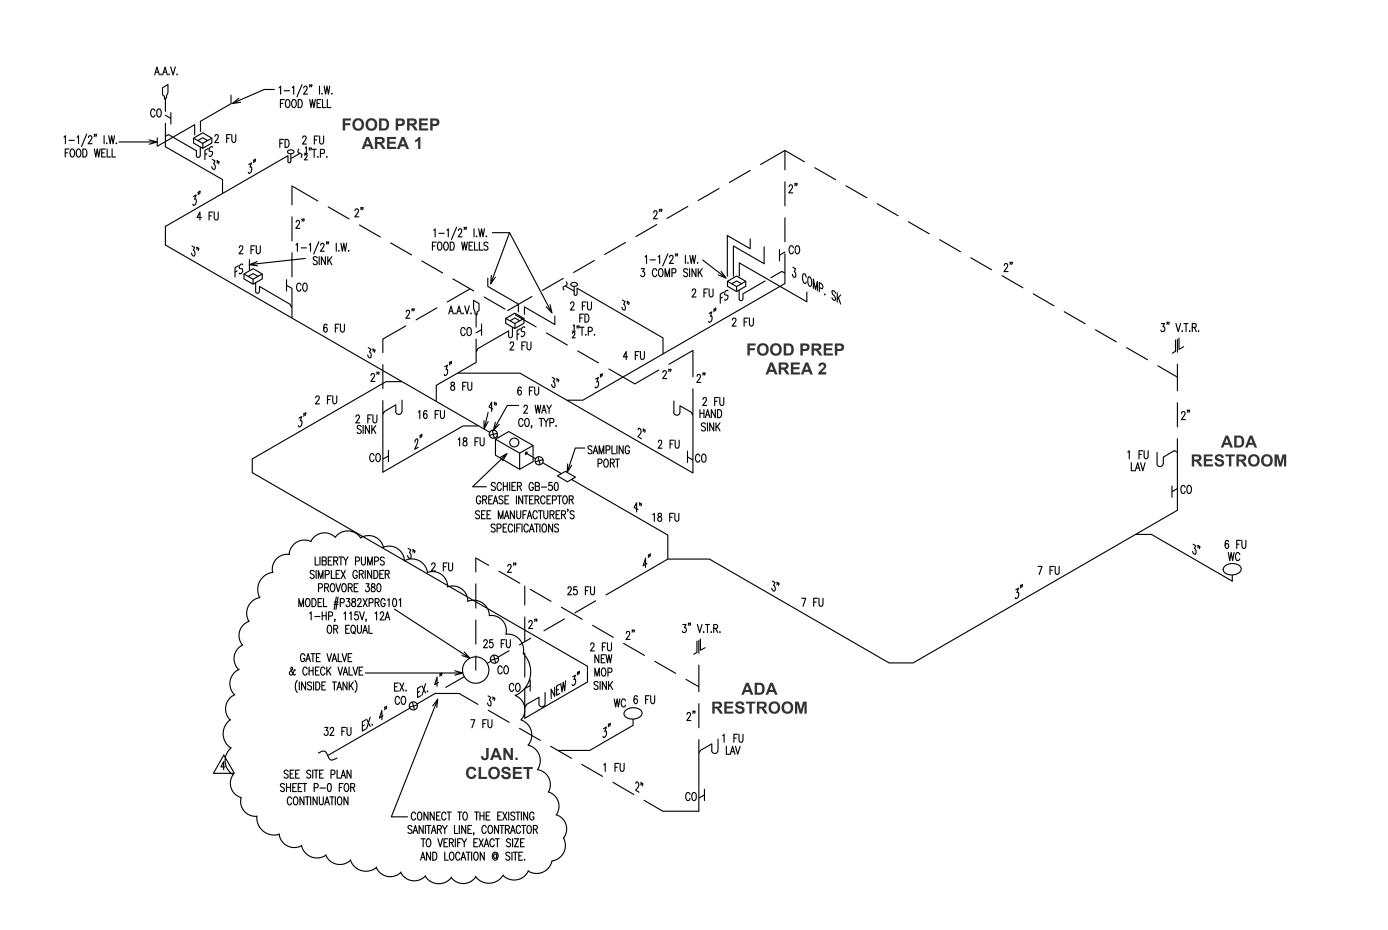

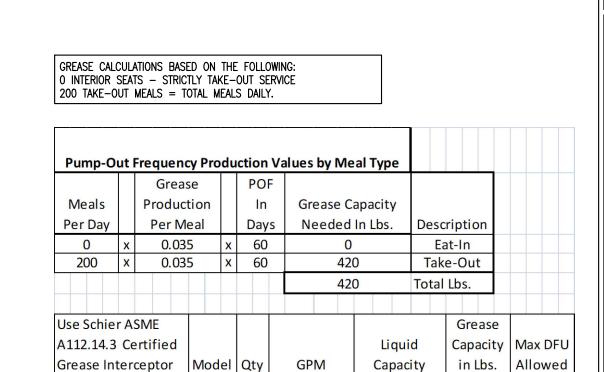

GB-50 1 50 65 GALLONS 439.5 32

 $\frac{3 \text{ COMPARTMENT SINK}}{(16\text{"W X } 20\text{"L X } 12\text{"D}) / (231 \text{ CUBIC INCHES})} = 16.6 \text{ GALLONS}$ (16.6G X 3COMP) X 75% = 37.4 G.P.M. $\frac{\text{HAND SINK}}{\text{(10"W X 14"L X 6"D) / (231 CUBIC INCHES)}} = 3.6 \text{ GALLONS}$ $(3.6G \times 2 \text{ SINKS}) \times 75\% = 5.4 \text{ G.P.M.}$ $\frac{\text{MOP SINK}}{(20\text{"W X }20\text{"L X }6\text{"D})}$ / (231 CUBIC INCHES) = 10.4 GALLONS 10.4G X 75% = 7.8 G.P.M. FLOOR SINKS (12"W X 12"L X 6"D) / (231 CUBIC INCHES) = 3.7 GALLONS $(3.7G \times 3 DRAINS) \times 75\% = 8.3 G.P.M.$ FLOOR DRAINS $(6^{"}W \ X \ 6^{"}L \ X \ 6^{"}D) \ / \ (231 \ CUBIC \ INCHES) = 1 \ GALLONS$ (1G X 2 DRAINS) X 75% = 1.5 G.P.M.TOTAL FLOW THRU RATE FOR TWO MINUTE PERIOD (37.4 + 5.4 + 7.8 + 8.3 + 1.5) / 2 = 32.1 G.P.M.PROVIDE SCHIER 50 G.P.M. /439.5 LBS. CAPACITY GREASE TRAP. USE GB-50. SEE MANUFACTURER'S SPECIFICATIONS,

SIZING FORMULA FOR GREASE TRAP PER PDI-G 101 8.3.2


PROVIDE A SAMPLING PORT ON THE EFFLUENT SIDE OF THE GREASE TRAP. (SAMPLING PORT SHALL BE INSTALLED IN AN APPROVED LOCATION TO ALLOW SAMPLING BY THE UTILITY & THE USER

SAMPLING PORT SHALL HAVE MIN. 4" DIAMETER (WITH CAP ON BOTTOM & CLEANOUT CAP ON TOP) OR GREATER AND/OR EQUAL TO 6" UNOBSTRUCTED

SAMPLING POINT SHALL BE ACCESSIBLE ALL TIMES, WITHOUT HAVING TO REMOVE ANY MERCHANDISE AND A MINIMUM 36 INCHES HORIZONTAL CLEARANCE FROM ANY WALL, FIXED EQUIPMENT OR MATERIALS AND A MINIMUM 48 INCHES VERTICAL CLEARANCE FROM ANY FIXED EQUIPMENT OR STORED MATERIALS.

NOTE: GREASE TRAP SHALL BE ACCESSIBLE AT ALL TIMES SO AS TO ALLOW FOR MAINTENANCE AND CLEANING WITHOUT GREASE TRAP PUMP OUT FREQUENCY = 60 DAYS


> GREASE INTERCEPTOR INSTALLATION SHALL BE BELOW GROUND AND THAT THE INSTALLATION OF THE GREASE INTERCEPTOR SHALL BE IN A MANNER THAT ALL LABELS AND MARKINGS ON THE GREASE INTERCEPTOR REMAIN VISIBLE DURING AND AFTER INSTALLATION.

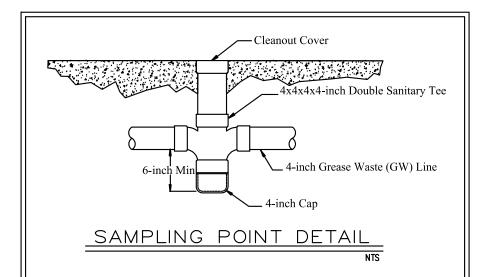


GREASE CALCULATIONS, NOTES & DETAILS

NOT TO SCALE



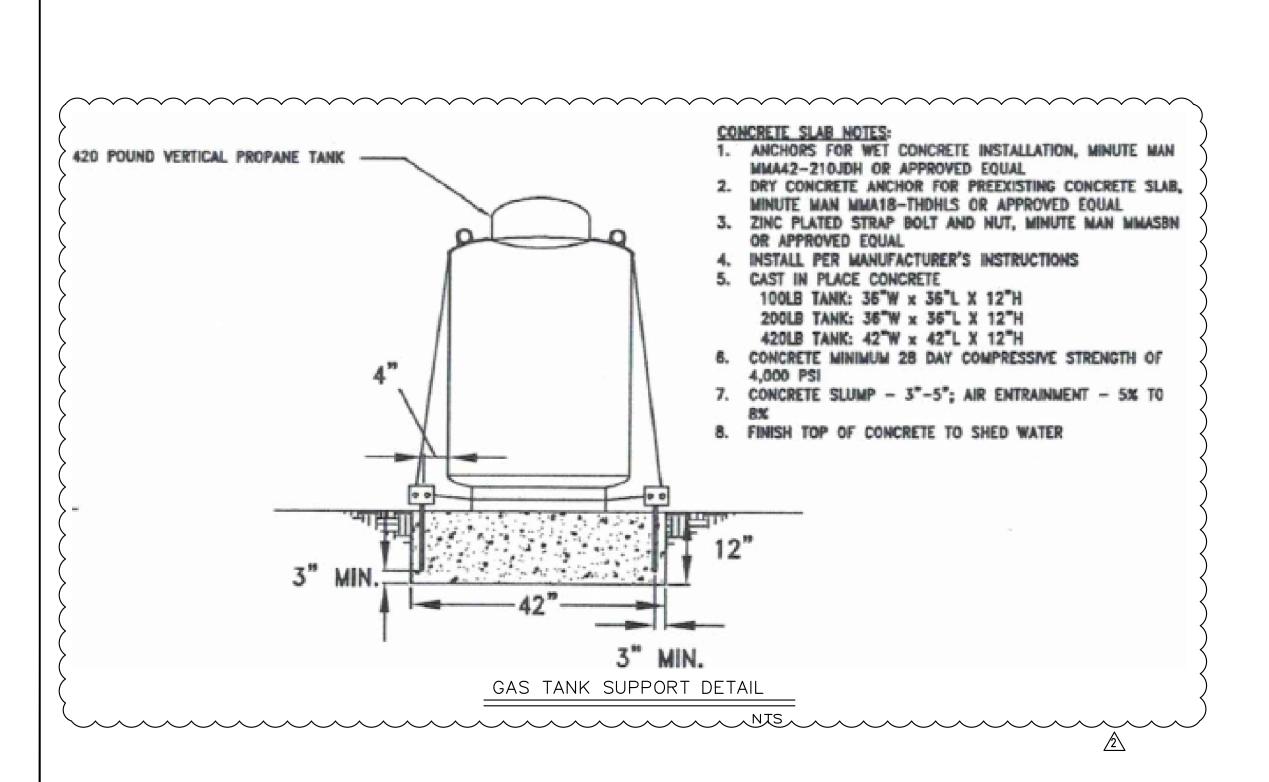

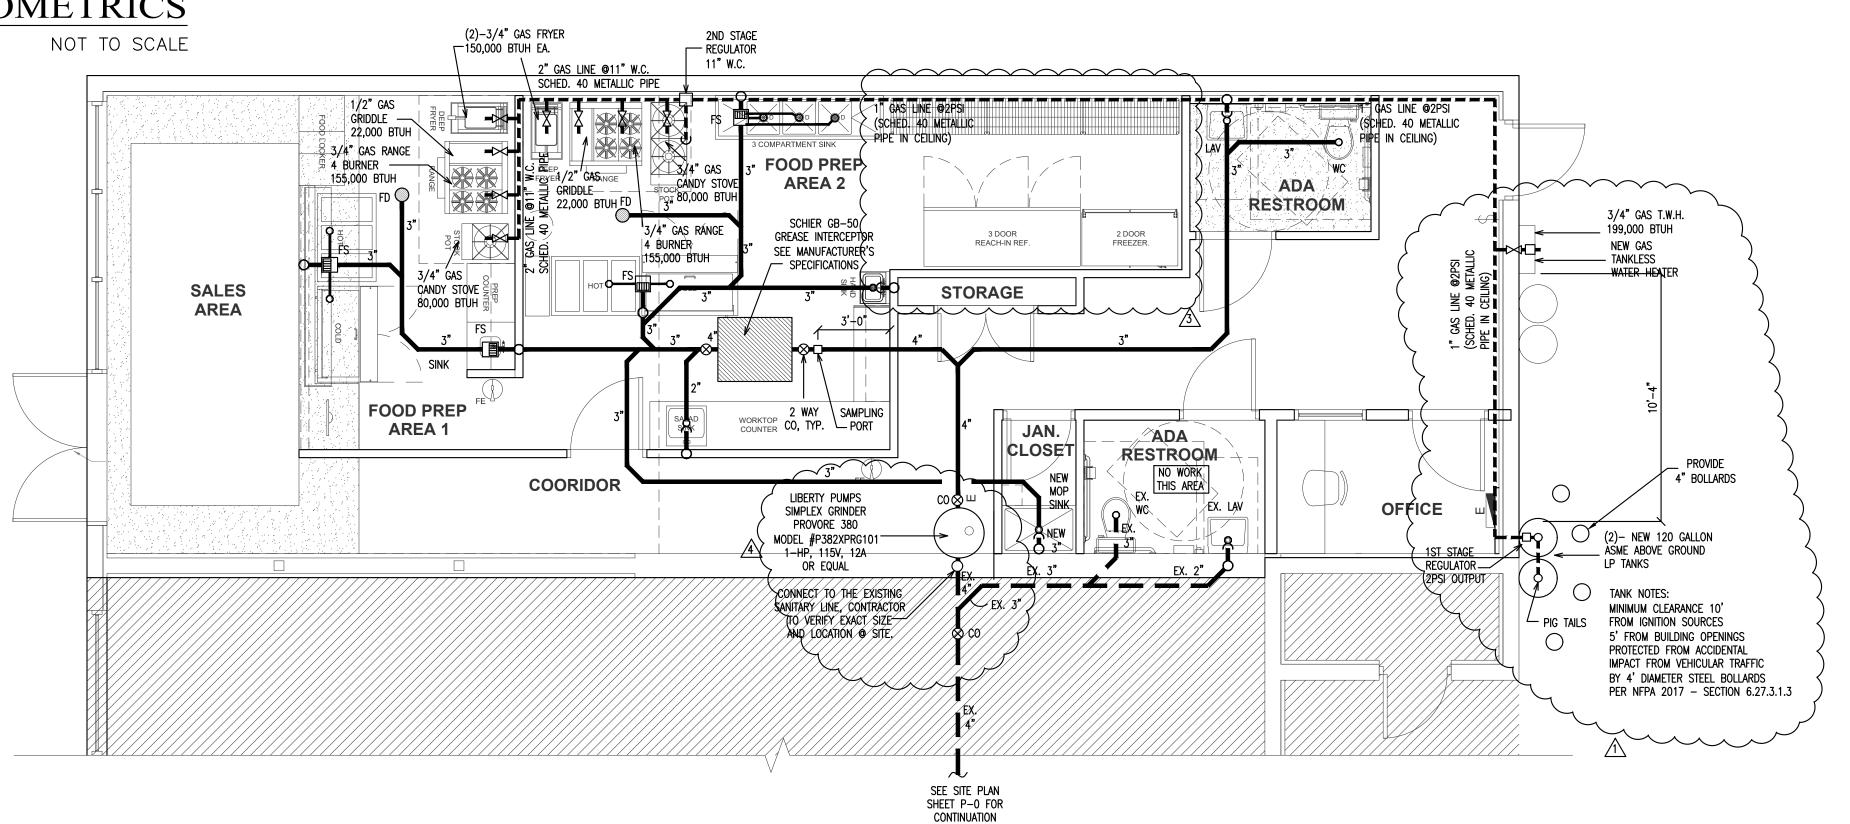

SANITARY, GREASE & GAS PLAN

SCALE: 1/4" = 1'-0"

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612 "A" NW 9TH AVENU FORT LAUDERDALE, FLORID, REVISIONS: No: Date: Description:

1. 08-02-21 CITY COMMENTS 2. 09-13-21 CITY COMMENTS 3. 02-09-22 OWNER CHANGES 4. 02-17-22 REVISION 11.30.20


roject Manager: Orawn by: Drawing Name:

SANITARY, GAS & GREASE PLAN


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Total Sheets: Issue Date:

roject No:

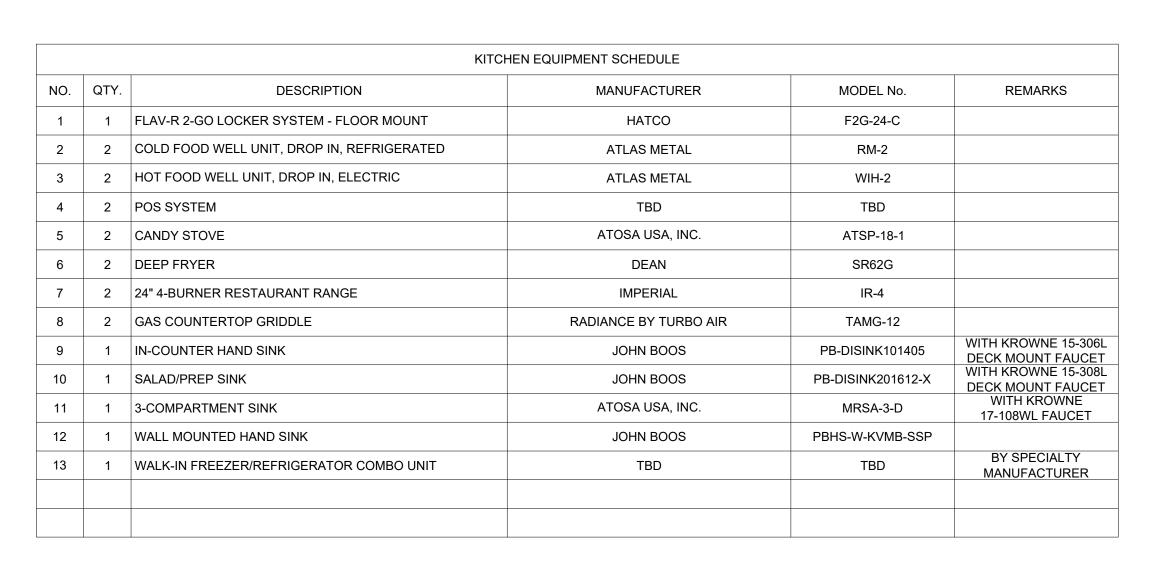

EQUIPMENT SCHEDULE

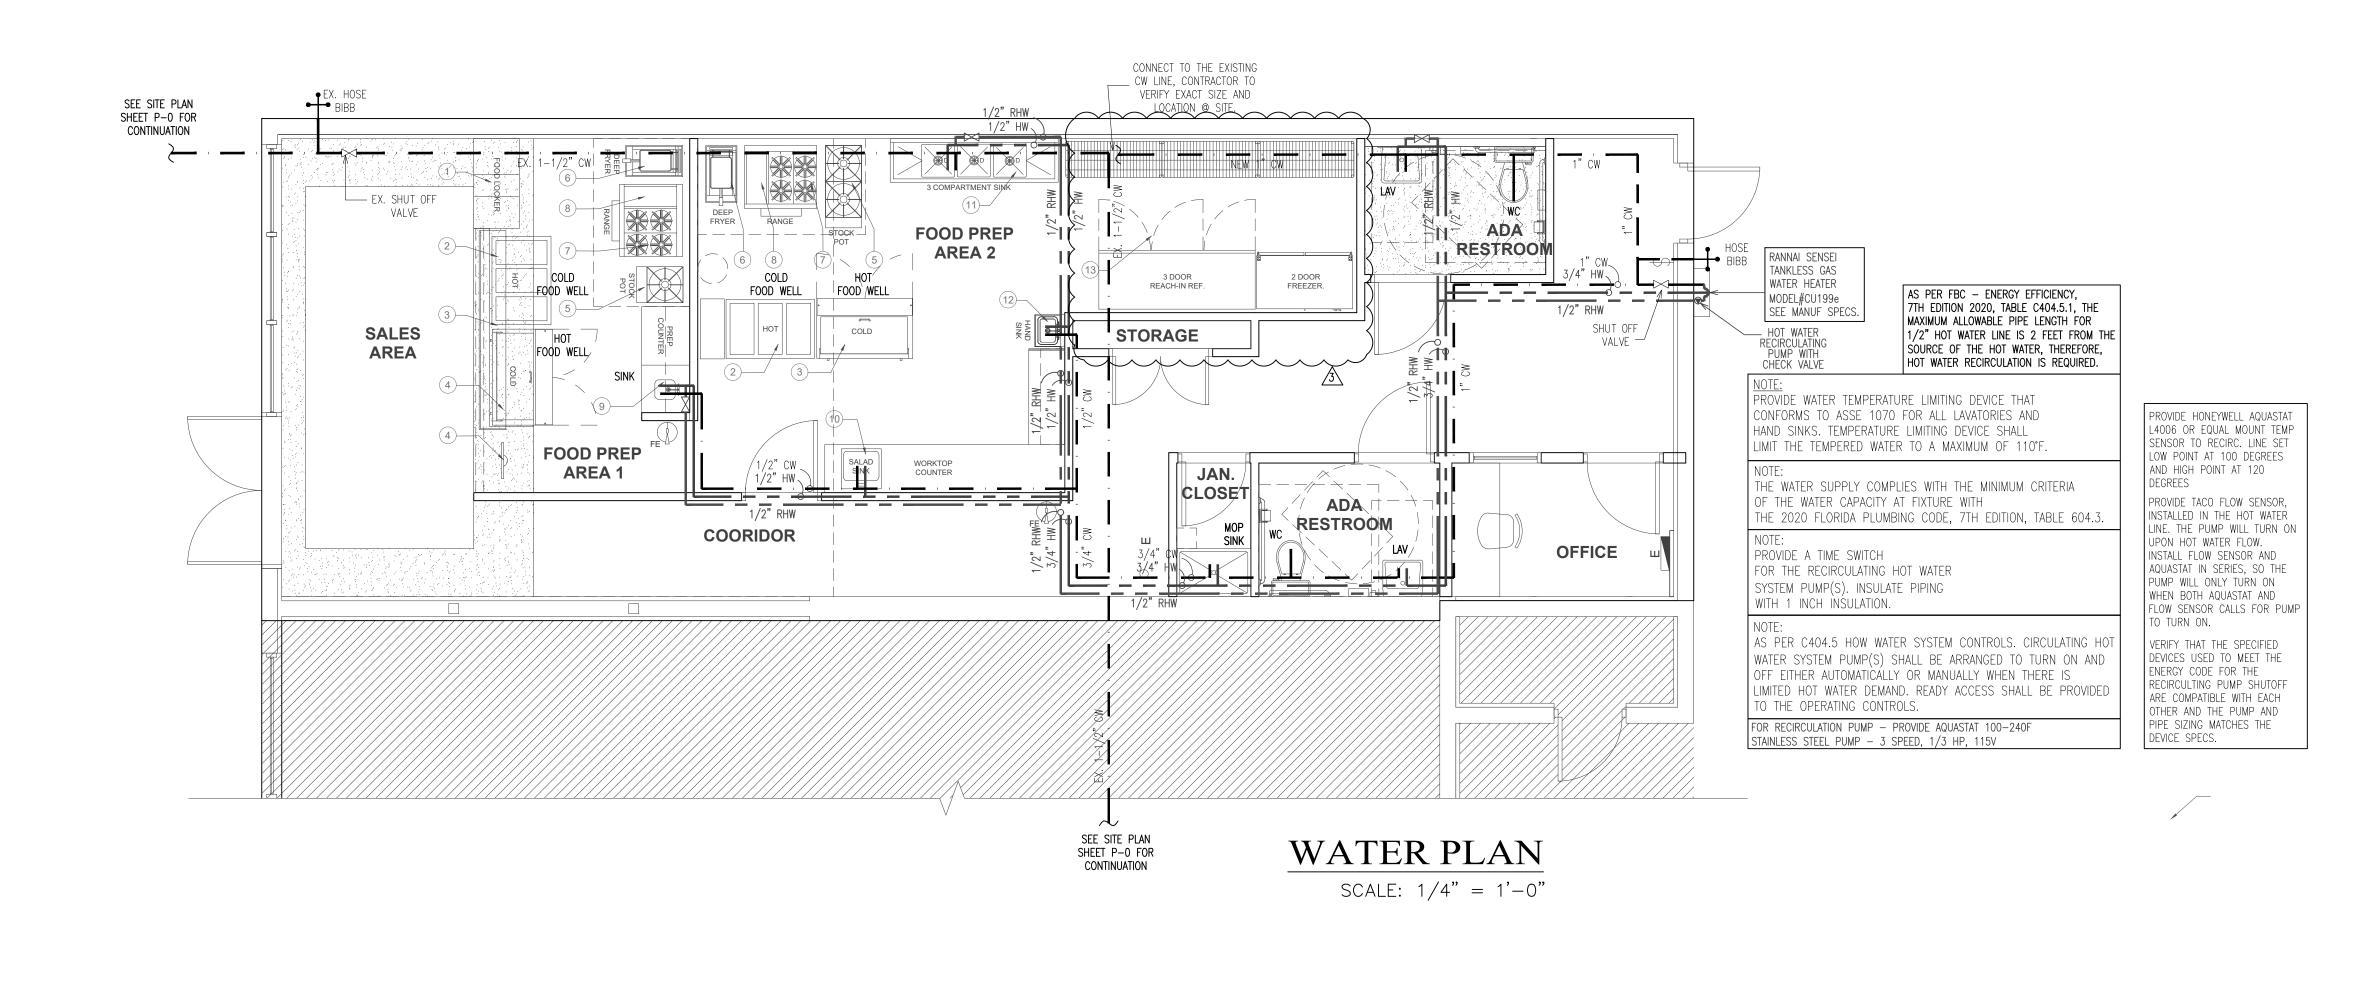

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612 NW 9TH AVENUE, LAUDERDALE, FLORID,

REVISIONS: No: Date: Description: 6. 02-09-22 OWNER CHANGES

Principal: Project Manager: Drawn by: Drawing Name:

WATER PLAN EQUIP. SCHEDULE

Drawing No:

SEAL

BUCHANAN P.E CONSULTING INC.

ELECTRICAL * MECHANICAL * PLUMBING ENGINEERING 6191 W. ATLANTIC BLVD, SUITE# 2 MARGATE, FL 33063

Ph: 954-590-3300 Fax: 954-590-2232 Email: BUCHANAN@MEPENGINEERS.COM CERTIFICATE OF AUTHORIZATION # 8842

☐ RAJA BUCHANAN P.E # 48916

P-2

Total Sheets: Issue Date: Project No: