



Plotted By: Marissa Street, Set: PUMP STATION A-16 DESIGN CRITERIA PACKAGE, Layout: 1, September 26, 2021, 04:12:29pm. K:\Ntl\chil\04-3 jobs\CAD\3184101.cad, 12464-416 ps -0-16 rev location: CAD\3184101.dwg, 12412-MULTI-NOTE.dwg. This document, together with the concepts and designs presented herein, as an instrument of service, is intended only for the specific purpose and client for which it was prepared. Release of and improper reliance on this document without written authorization and adaptation by Kimley-Horn and Associates, Inc. shall be without liability to Kimley-Horn and Associates, Inc.

GENERAL NOTES:

- 1. DESIGN BUILD FIRM SHALL MAINTAIN ACCESS TO PRIVATE PROPERTIES AT ALL TIMES.
2. REFER TO SPECIFICATION SECTION 0110 AND 15060 FOR DETAILED REQUIREMENTS FOR SEQUENCE OF CONSTRUCTION AND CONSTRUCTION CONSTRAINTS.
3. RECORD DRAWINGS USED FOR EXISTING FEATURES. RECORD DRAWINGS MAY BE OBTAINED FROM THE OWNER UPON REQUEST.
4. DESIGN BUILD FIRM SHALL PROVIDE ALL FIELD SURVEY AND GEOTECHNICAL SERVICES BEFORE COMMENCEMENT OF ANY CONSTRUCTION ACTIVITIES. DESIGN BUILD FIRM SHALL VERIFY EXISTING ELEVATIONS AND DIMENSIONS WHERE NEW WORK WILL MATCH EXISTING. DISCREPANCIES SHALL BE BROUGHT TO THE ATTENTION OF THE ENGINEER FOR RESOLUTION PRIOR TO THE COMMENCEMENT OF WORK.
5. DESIGN BUILD FIRM SHALL OBTAIN ALL THE NECESSARY PERMITS FROM THE APPROPRIATE AUTHORITIES, DEPARTMENTS, AND/OR AGENCIES HAVING JURISDICTION PRIOR TO COMMENCING WORK.
6. ALL PRACTICAL AND NECESSARY EFFORTS SHALL BE TAKEN DURING CONSTRUCTION TO PREVENT UNNECESSARY TREE REMOVAL AND/OR DAMAGE.
7. THE LOCATION OF EXISTING UTILITIES HAS BEEN PREPARED FROM THE MOST RELIABLE INFORMATION AVAILABLE TO THE ENGINEER. THE INFORMATION IS NOT GUARANTEED. THEREFORE THE DESIGN BUILD FIRM SHALL VERIFY THE LOCATION AND ELEVATION OF ALL UTILITIES IN THE FIELD PRIOR TO THE START OF ANY CONSTRUCTION ACTIVITIES.
8. UTILITIES HAVE BEEN PLOTTED FROM AVAILABLE SURVEY INFORMATION. IT IS THE DESIGN BUILD FIRM'S RESPONSIBILITY TO VERIFY THEIR EXACT LOCATION AND TO AVOID DAMAGE TO THEM. THE DESIGN BUILD FIRM SHALL CONTACT SUNSHINE 811 AT

- PHONE NUMBER 811 OR 1-800-432-4770 TO REQUEST UNDERGROUND UTILITY LOCATION MARK-OUT AT LEAST TWO (2) WORKING DAYS BUT NO MORE THAN TEN (10) WORKING DAYS PRIOR TO BEGINNING EXCAVATION AND UTILITIES THAT ARE NOT INDICATED BY THE DESIGN BUILD FIRM SHALL ALSO CONTACT AND REQUEST UTILITY LOCATION MARK-OUT FROM BURED UTILITY OWNERS WITH UTILITIES ON THE PROJECT SITE THAT ARE NOT PARTICIPANTS OF SUNSHINE 811.
9. THE DESIGN BUILD FIRM SHALL EXERCISE CAUTION WHEN WORKING IN OR AROUND EXISTING CITY-OWNED UTILITIES. THE DESIGN BUILD FIRM SHALL NOTIFY THE CITY AT LEAST TWO BUSINESS DAYS IN ADVANCE OF ANY EXCAVATION WITHIN TEN FEET OF A CITY-OWNED UTILITY SO THAT A CITY REPRESENTATIVE MAY BE PRESENT.
10. DESIGN BUILD FIRM SHALL TAKE CARE TO AVOID DAMAGE TO EXISTING UTILITIES (PAVEMENT SIGNALS WITHIN) AND UTILITIES THAT ARE NOT INDICATED TO BE DEMOLISHED OR REMOVED. ANY DAMAGE TO EXISTING PAVEMENT, STRUCTURES, AND UTILITIES NOT INDICATED TO BE DEMOLISHED OR REMOVED SHALL BE REPAIRED AT THE DESIGN BUILD FIRM'S EXPENSE.
11. WHERE PROPOSED WORK IS IN THE VICINITY OF UTILITY POLES, SUCH THAT SUPPORT OF THE POLE(S) WILL BE REQUIRED, THE DESIGN BUILD FIRM SHALL BE RESPONSIBLE FOR NOTIFYING THE UTILITY OF THE WORK. IT WILL BE THE RESPONSIBILITY OF THE DESIGN BUILD FIRM TO COORDINATE WITH THE UTILITY FOR SUPPORT OF THE POLE.
12. DURING EXCAVATION AND PLACEMENT OF UTILITIES THE DESIGN BUILD FIRM SHALL COMPLY WITH ALL APPLICABLE CITY, COUNTY, STATE, AND FEDERAL REGULATIONS AND SHALL SUBMIT TO THE ENGINEER FOR APPROVAL SHEET PILING, SHORING AND/OR BRACING DESIGNS AS MAY BE NECESSARY TO COMPLY WITH THESE REGULATIONS.

- 13. GROUNDWATER FROM ALL DETERIORATING OPERATIONS SHALL BE DISCHARGED TO AN ENVIRONMENTALLY ACCEPTABLE LOCATION IN ACCORDANCE WITH THE CONTRACT DOCUMENTS.
14. THE DESIGN BUILD FIRM SHALL REMOVE AND DISPOSE OF ALL DEBRIS GENERATED DURING THE PROJECT OFF SITE AT A PROPERLY PERMITTED DISPOSAL FACILITY.
15. ALL RESTORATION SHALL CONFORM TO THE STANDARDS AND REQUIREMENTS OF THE AGENCIES HAVING JURISDICTION OVER THE RIGHT-OF-WAY WHERE THE PROJECT IS CONSTRUCTED.
16. ALL LOOP DETECTORS, COMMUNICATION CABLES AND CONDUITS, IF DAMAGED BY THE DESIGN BUILD FIRM'S ACTIVITIES, SHALL BE REPAIRED AND/OR REPLACED IN ACCORDANCE WITH BCTED AND FDOT REQUIREMENTS.
17. PIPING, FITTINGS, AND APPURTENANCES FOR DUCTILE IRON, CP90 PVC, AND HDPE PIPE SHALL BE RESTRAINED JOINT AS SPECIFIED.
18. NO CONNECTIONS FOR THE PURPOSE OF OBTAINING WATER SUPPLY DURING CONSTRUCTION SHALL BE MADE TO ANY FIRE HYDRANT OR BLOW-OFF STRUCTURE WITHOUT FIRST OBTAINING PERMISSION AND A CONSTRUCTION METER FROM THE CITY OF FORT LAUDERDALE.
19. THE DESIGN BUILD FIRM WILL BE RESPONSIBLE FOR LOCATING, MOVING AND RELOCATING OR REPLACING ALL WATER SERVICES OR SEWER LATERALS WHICH ARE ENCOUNTERED DURING EXCAVATION. THE DESIGN BUILD FIRM SHALL SUBMIT A WRITTEN PLAN FOR WATER SERVICE AND WASTEWATER SERVICE DISRUPTION FOR APPROVAL AT LEAST SEVEN (7) WORKING DAYS PRIOR TO THE ANTICIPATED DISRUPTION. THE DESIGN BUILD FIRM SHALL NOTIFY THE SERVICE OWNERS 48 HOURS IN ADVANCE OF ANY WORK ON THEIR PROPERTIES. THIS WORK SHALL BE CONSIDERED INCIDENTAL.

- 20. IT WILL BE THE RESPONSIBILITY OF THE DESIGN BUILD FIRM TO NOTIFY THE UTILITIES DEPARTMENT OF THE CITY OF FORT LAUDERDALE AT LEAST TWO (2) BUSINESS DAYS IN ADVANCE TO COORDINATE ANY ACTIVITY TO BE PERFORMED BY THE CITY'S UTILITIES DEPARTMENT.
21. DESIGN BUILD FIRM SHALL NOT DISTURB AREAS OUTSIDE EXISTING RIGHTS-OF-WAY.
22. ALL WORK WITHIN STATE DEPARTMENT OF TRANSPORTATION (FDOT) RIGHT-OF-WAYS SHALL BE IN CONFORMANCE WITH FDOT SPECIFICATIONS AND PERMIT REQUIREMENTS.
23. ALL WORK WITHIN BROWARD COUNTY RIGHT-OF-WAYS SHALL BE IN CONFORMANCE WITH THE BROWARD COUNTY MINIMUM STANDARDS AND/OR REQUIREMENTS.
24. DESIGN BUILD FIRM SHALL COMPLY WITH ALL LOCAL CITY, COUNTY AND STATE REGULATIONS PERTAINING TO THE CLOSING OF PUBLIC STREETS FOR USE OF TRAFFIC DURING CONSTRUCTION.
25. DESIGN BUILD FIRM SHALL PREPARE AND SUBMIT MAINTENANCE OF TRAFFIC (MOT) PLANS TO FDOT, CITY OF FORT LAUDERDALE, BROWARD COUNTY AS REQUIRED FOR WORK TO BE DONE WITHIN THEIR R/W PRIOR TO COMMENCEMENT OF WORK. SPECIFIC AGENCY MOT REQUIREMENTS ARE THE SOLE RESPONSIBILITY OF THE DESIGN BUILD FIRM.
26. DESIGN BUILD FIRM SHALL SUBMIT MOT PLANS FOR APPROVAL BY THE CITY WHEN WORKING WITHIN THE PUBLIC RIGHT-OF-WAY.
27. ALL OPEN TRENCHES AND HOLES ADJACENT TO ROADWAY OR WALKWAY SHALL BE PROPERLY MARKED AND BARRICADED TO ASSURE THE SAFETY OF BOTH VEHICULAR AND PEDESTRIAN TRAFFIC.

- 28. TRENCHES OR HOLES NEAR WALKWAYS, IN ROADWAYS OR THEIR SHOULDERS SHALL NOT BE LEFT OPEN DURING NIGHT TIME HOURS WITHOUT ADEQUATE PROTECTION.
29. DESIGN BUILD FIRM SHALL PROMPTLY REPAIR AND RESTORE EXISTING PAVEMENT, SIDEWALKS, CURBS, DRIVEWAYS, PIPES, RESIDENTIAL AND COMMERCIAL SPRINKLER LINES, CONDUIT, CABLES, ETC. AND LANDSCAPE AREAS DAMAGED AS A RESULT OF CONSTRUCTION ACTIVITIES.
30. DESIGN BUILD FIRM SHALL PROVIDE TEMPORARY FENCING AS REQUIRED BY AGENCIES HAVING JURISDICTION OVER THE PROJECT AND/OR WHEN REQUIRED FOR PUBLIC SAFETY.
31. THE DESIGN BUILD FIRM SHALL BE RESPONSIBLE AT ALL TIMES THROUGHOUT THE DURATION OF CONSTRUCTION AND UNTIL ACCEPTANCE OF WORK, FOR THE PROTECTION OF EXISTING AND NEWLY INSTALLED UTILITIES FROM DAMAGE OR DISRUPTION OF SERVICE. THE DESIGN BUILD FIRM SHALL BE RESPONSIBLE FOR TACKLING SUCH MEASURES AS NECESSARY TO PROTECT THE HEALTH, SAFETY AND WELFARE OF THOSE PERSONS HAVING ACCESS TO THE WORK SITE.
32. DESIGN BUILD FIRM SHALL ADJUST TO GRADE ALL EXISTING UTILITY CASTINGS INCLUDING VALVE BOXES, MANHOLES, HAND HOLES, PULL BOXES, INLETS AND SIMILAR STRUCTURES IN CONSTRUCTION AREA TO BE OVERLAINED WITH ASPHALT.
33. EXISTING TRAFFIC SIGNS SHALL BE RESET UPON COMPLETION PER BROWARD COUNTY TRAFFIC ENGINEERING STANDARDS. COST SHALL BE CONSIDERED INCIDENTAL. DESIGN BUILD FIRM SHALL REPAIR OR REPLACE DAMAGED TRAFFIC SIGNAL LOOPS PER BROWARD COUNTY TRAFFIC ENGINEERING SPECIFICATIONS. COST SHALL BE INCIDENTAL.

- 34. DESIGN BUILD FIRM SHALL RESTORE EXISTING PAVEMENT AND PAVEMENT MARKINGS/SIGNAGE TO ORIGINAL PRE-CONSTRUCTION CONDITION OR AS OTHERWISE SPECIFIED IN CONTRACT DOCUMENTS. THIS WORK SHALL BE CONSIDERED INCIDENTAL.
35. ALL CONSTRUCTION WITHIN FDOT R/W MUST CONFORM WITH FDOT SPECIFICATIONS, STANDARDS, AND PERMIT REQUIREMENTS. NO WORK SHALL COMMENCE WITHIN FDOT R/W'S WITHOUT AN FDOT PERMIT. FULL LANE WIDTH RESTORATION TO MATCH EXISTING PAVEMENT SECTION IS REQUIRED IN ACCORDANCE WITH FDOT STANDARDS FOR PROPOSED WORK WITHIN FDOT R/W.
36. THE DESIGN BUILD FIRM SHALL SUBMIT ALL REQUIRED SHOP DRAWINGS FOR CITY APPROVAL PRIOR TO ORDERING MATERIALS AND INSTALLATION.
37. EXISTING GAS MAINS SHALL BE IDENTIFIED BY THE APPROPRIATE UTILITY, PRIOR TO START OF CONSTRUCTION.
38. REFER TO SECTION 02065 AND DEMOLITION PLANS FOR DEMOLITION DETAILS.
39. REFER TO DIVISIONS 2 AND 15 FOR UTILITY SPECIFICATIONS.

UTILITY CONTACTS:

TECO PEOPLES GAS 5101 NW 21ST AVENUE FORT LAUDERDALE, FL 33309 PHONE: (954)533-0784 CONTACT: DAVID RIVERA
FLORIDA POWER & LIGHT COMPANY 7201 CYPRESS ROAD, CSF-CB PLANTATION, FL 33317 PHONE: (954)717-2057 CONTACT: TROY LEWIS
AT&T FLORIDA 8601 WEST SUNRISE BOULEVARD PLANTATION, FL 33322 PHONE: (305)928-0501 CONTACT: OTIS T. KEVEE
CITY OF FORT LAUDERDALE 290 NE 3RD AVENUE FORT LAUDERDALE, FL 33301 PHONE: (954)928-3721 CONTACT: KRISTIN THOMPSON

ENGINEER: GARY R. RAY, P.E. REG. NO: 406892 DATE: 9/26/2021
DESIGNED BY: AL CR
CHECKED BY: CR
FIELD BOOK: (954) 438-5100 FAX:

CITY OF FORT LAUDERDALE PUBLIC WORKS DEPARTMENT ENGINEERING & ARCHITECTURE 100 North Andrews Avenue, Fort Lauderdale, Florida 33301

TRAFFIC CONTROL PLAN NOTES:

- 1. THE TRAFFIC CONTROL PLANS FOR THE PROJECT SHALL COMPLY WITH THE LATEST EDITION OF THE FLORIDA DEPARTMENT OF TRANSPORTATION ROADWAY AND TRAFFIC DESIGN STANDARDS, INDEX NO. 600-660, MUTCD AND THE STANDARD SPECIFICATIONS. THE CONTRACTOR'S RESPONSE TIME TO ALL REPORTED MALFUNCTIONS OF TRAFFIC SIGNALS SHALL BE NO MORE THAN TWO (2) HOURS AND SHALL RESTORE ALL MALFUNCTIONING TRAFFIC SIGNAL EQUIPMENT TO ITS LEVEL OF OPERATION PRIOR TO THE MALFUNCTIONING WITHIN TWENTY-FOUR (24) HOURS. DURING THIS TIME THE CONTRACTOR SHALL PROVIDE AT HIS EXPENSE TEMPORARY TRAFFIC CONTROL DEVICES, FLAGGER PERSONNEL AND LAW ENFORCEMENT PERSONNEL AS NECESSARY TO MAINTAIN A SAFE AND EFFICIENT FLOW OF TRAFFIC AT THE AFFECTED WORK ZONE. THE ENGINEER OR THE CITY OF FORT LAUDERDALE SHALL APPROVE ALL MODIFICATIONS PRIOR TO THEIR IMPLEMENTATION.
2. THE CONTRACTOR SHALL MAINTAIN PROPER OPERATION OF ALL TRAFFIC SIGNAL LOOP ASSEMBLIES AND LOOP DETECTORS WITHIN THE PROJECT LIMITS. THE CONTRACTOR SHALL CORRECT ALL LOOP ASSEMBLY DEFECTS OR MALFUNCTIONS WITHIN 24 HOURS OF NOTIFICATION OF SUCH MALFUNCTIONS BY THE ENGINEER.
3. THE AGENCY RESPONSIBLE FOR MAINTENANCE OF THE TRAFFIC SIGNALS AND RELATED EQUIPMENT IS BROWARD COUNTY TRAFFIC ENGINEERING.
4. A REGULATORY SPEED OF 25 MPH SHALL BE POSTED WITHIN THE LIMITS OF THE WORK ZONE.
5. EXISTING SIGNS AND PAVEMENT MARKINGS THAT CONFLICT WITH CONSTRUCTION SIGNS AND MARKINGS SHALL BE REMOVED DURING CONSTRUCTION. ALL EXISTING SIGNS THAT ARE REMOVED SHALL BE STOCKPILED IN A SECURE PLACE AND REINSTALLED AFTER CONSTRUCTION. REMOVE AND REPLACE ANY GROUND MOUNT SIGN BY USE OF INDEX NO. 811.
6. THE CONTRACTOR SHALL MAINTAIN EXISTING DRAINAGE PATTERNS AND PREVENT ADVERSE FLOODING OF THE TRAVEL LANES DURING CONSTRUCTION.
7. THE CONTRACTOR SHALL OBTAIN WRITTEN AUTHORIZATION FROM THE CITY OF FORT LAUDERDALE FOR ANY AND ALL CONSTRUCTION ACTIVITIES TO BE PERFORMED AT NIGHT. NO LANE CLOSURE SHALL BE ALLOWED BETWEEN THE HOURS OF 6:00 AM TO 9:00 AM AND 4:00 PM TO 7:00 PM, MONDAY THROUGH FRIDAY UNLESS APPROVED BY THE ENGINEER.
8. THE CONTRACTOR SHALL NOTIFY THE APPROPRIATE UTILITY COMPANY TWO (2) BUSINESS DAYS IN ADVANCE OF ANY EXCAVATION WITHIN ITS UTILITY SO THAT A COMPANY REPRESENTATIVE CAN BE PRESENT. THE LOCATION OF THE UTILITIES SHOWN IN THE PLANS ARE APPROXIMATE ONLY. THE EXACT LOCATION SHALL BE DETERMINED BY THE CONTRACTOR DURING CONSTRUCTION. SEE SPECS FOR LIST OF UTILITY COMPANIES.
9. TRAFFIC CONTROL ON ALL COUNTY RIGHTS-OF-WAY SHALL MEET THE ADDITIONAL REQUIREMENTS OF THE BROWARD COUNTY ENGINEERING DEPARTMENT.
10. CONTRACTOR SHALL PREPARE AND SUBMIT MAINTENANCE OF TRAFFIC PLAN (MOT) WHERE REQUIRED BY FEDERAL, STATE, COUNTY, OR LOCAL AGENCIES HAVING JURISDICTION. CONTRACTOR SHALL OBTAIN ALL REQUIRED APPROVALS AND PERMITS ASSOCIATED WITH THE MOT'S. ALL MOT'S TO BE AT CERTIFIED.
11. THE CONTRACTOR SHALL ALSO COORDINATE THE CONSTRUCTION SCHEDULE WITH FDOT, BROWARD COUNTY AND THE CITY OF FORT LAUDERDALE TO AVOID LANE CLOSURES WHICH WOULD ADVERSELY AFFECT TRAFFIC DURING RUSH HOUR.

CITY OF FORT LAUDERDALE PUBLIC WORKS DEPARTMENT ENGINEERING DETAILS SHEET: TRAFFIC CONTROL PLAN NOTES GNRL 002

BROWARD COUNTY SCHOOL MAINTENANCE OF TRAFFIC NOTES:

- 1. THE MAINTENANCE OF TRAFFIC PLAN, PROVIDED BY THE CONTRACTOR, SHALL INCLUDE PROVISIONS FOR PEDESTRIAN AND VEHICULAR TRAFFIC AS WELL AS VEHICULAR TRAFFIC. THE FOLLOWING ARE MINIMUM REQUIREMENTS:
2. THE SAFE WALK ROUTE FOR ALL SCHOOL STUDENTS WITHIN THE VICINITY OF THE CONSTRUCTION ZONE SHALL BE MAINTAINED DURING STUDENT ARRIVAL AND DISMISSAL TIMES. IF THE CURRENT WALKING SURFACE CANNOT BE MAINTAINED, THEN A TEMPORARY WALKABLE SURFACE SHALL BE CREATED. THE SAFE WALK ROUTE SHALL BE SEPARATED FROM THE CONSTRUCTION ACTIVITY DURING THE ENTIRE LENGTH OF THE PROJECT ENCOMPASSING THE ENTIRE WALK ROUTE WITH PROPER PEDESTRIAN OPENINGS AT DESIGNATED CROSSINGS IN COMPLIANCE WITH FDOT DESIGN STANDARDS INDEX NO. 600 AS WELL AS MEETING ALL ADA REQUIREMENTS.
3. ALL CONSTRUCTION EQUIPMENT ACTIVITY AROUND ANY DESIGNATED CROSSWALK SHALL CEASE TO OPERATE DURING THE STUDENT ARRIVAL AND DISMISSAL TIMES. ALL CONSTRUCTION EQUIPMENT ACTIVITY ADJACENT TO A DESIGNATED WALK ROUTE SHALL CEASE OPERATING UNLESS SAFELY FACTORILY BARRICADED FROM THE WALK ROUTE.
4. IN THE CASE THAT A DESIGNATED CROSSING OR ANY PORTION OF THE DESIGNATED WALK ROUTE CANNOT BE MAINTAINED, THE CONTRACTOR SHALL NOTIFY THE SPECIAL PROJECTS COORDINATOR AT BROWARD COUNTY TRAFFIC ENGINEERING DIVISION, (954) 847-2600, A MINIMUM OF TEN (10) WORKING DAYS PRIOR TO CLOSING THAT ROUTE IN ORDER TO ESTABLISH AN ALTERNATE CROSSING ROUTE.
5. IT SHALL BE THE CONTRACTOR'S RESPONSIBILITY TO INSTALL ANY NECESSARY PAVEMENT, ROAD ROCK, PAVEMENT MARKINGS AND SIGNAGE AND/OR ANY PEDESTRIAN SIGNALIZATION AND/OR SIGNAL MODIFICATION TO ACCOMMODATE AN EXISTING OR ALTERNATE WALK ROUTE THROUGHOUT THE ENTIRE LENGTH OF THE PROJECT.
6. IT SHALL BE THE CONTRACTOR'S RESPONSIBILITY TO PROVIDE STATE CERTIFIED SCHOOL CROSSING GUARDS OR OFF DUTY POLICE OFFICERS TO CROSS STUDENTS AT ALL LOCATIONS OTHER THAN THOSE PREVIOUSLY DESIGNATED. THE CONTRACTOR MAY USE FLAGMEN, BUT ONLY IF THEY ARE STATE CERTIFIED AS A SCHOOL CROSSING GUARD.
7. THIRTY (30) DAYS PRIOR TO THE BEGINNING OF CONSTRUCTION THE CONTRACTOR SHALL NOTIFY THE SPECIAL PROJECTS COORDINATOR AT BROWARD COUNTY TRAFFIC ENGINEERING DIVISION, (954) 847-2600 OR AT BROWARD@TRAFFIC.ORG TO DISCUSS ALL NECESSARY SAFETY MEASURES.
8. IT SHALL BE THE CONTRACTOR'S RESPONSIBILITY TO NOTIFY THE FOLLOWING BROWARD COUNTY SCHOOL BOARD PUPIL TRANSPORTATION DEPARTMENT PERSONNEL IF CONSTRUCTION WILL IMPACT ANY BUS ROUTES:

Table with columns: NAME, SECTION, PHONE, EMAIL. Rows include RUTH MASTERS, VINCENT HARRELL, MARY TOCHTERMANN.

CITY OF FORT LAUDERDALE PUBLIC WORKS DEPARTMENT ENGINEERING DETAILS SHEET: BROWARD COUNTY SCHOOL MOT NOTES GNRL 005

- 9. UPON COORDINATION WITH THE AFOREMENTIONED PERSONNEL, AND IF DEEMED NECESSARY, A PRE-CONSTRUCTION MEETING WILL BE HELD TO DETERMINE ALL BUS ROUTES AND TO MAKE ANY NECESSARY ARRANGEMENTS FOR REROUTING. THE SPECIAL PROJECTS COORDINATOR FROM THE BROWARD COUNTY TRAFFIC ENGINEERING DIVISION, (954) 847-2600, WILL BE NOTIFIED AND MAY ATTEND THE PRE-CONSTRUCTION MEETING.
10. THE CONTRACTOR SHALL BE RESPONSIBLE FOR OBTAINING AN APPROVED MAINTENANCE OF TRAFFIC PLAN (MOT), SPECIFYING THE ABOVE SCHOOL/PEDESTRIAN CONDITIONS, THROUGH THE BROWARD COUNTY TRAFFIC ENGINEERING DIVISION OR THE LOCAL MUNICIPALITY, DEPENDING ON THE ROADWAY JURISDICTION. THE CONDITIONS OUTLINED IN THE MOT ARE FULLY EFFECTIVE AS PART OF THE PROPOSED IMPROVEMENTS. THE CONTRACTOR SHALL BE RESPONSIBLE FOR ENSURING THAT ALL WORK ASSOCIATED WITH THE PROJECT IS IN COMPLIANCE WITH ALL THE REQUIREMENTS OF THE APPROVED MOT.
11. THE CONTRACTOR SHALL ENSURE THAT THERE ARE NO SPEED LIMIT SIGNS INSTALLED WITHIN THE DESIGNATED REDUCED SPEED SCHOOL ZONE AT ANY TIME THROUGHOUT THE PROJECT.

CITY OF FORT LAUDERDALE PUBLIC WORKS DEPARTMENT ENGINEERING DETAILS SHEET: BROWARD COUNTY SCHOOL MOT NOTES GNRL 005

LEGEND

Table with columns: ABBREVIATIONS, C.L.F., CMP, CONC., F.H., GAS, INV., OHW, R/W, RCP, SAN, SMH, S.V., T.O.P., UNK., U.T.O., U.V., W.V., B.C.H.C.E.D., B.C.T.E.D.

BROWARD COUNTY COMMUNICATION NOTES:

- 1. THE AGENCY RESPONSIBLE FOR MAINTENANCE OF THE TRAFFIC SIGNALS AND RELATED EQUIPMENT IS BROWARD COUNTY TRAFFIC ENGINEERING DIVISION (BCTED). ALL SYSTEM COMMUNICATIONS EQUIPMENT, CABLEING AND RELATED MATERIAL SHALL COMPLY WITH BROWARD COUNTY'S LATEST EDITION OF THE MINIMUM STANDARDS AS EXPRESSED IN THE "STANDARDS AND SPECIFICATIONS - COMMUNICATION INFRASTRUCTURE" DOCUMENT. PLEASE REFER TO (BCTED)'S COMMUNICATIONS POLICIES AND PROCEDURES FOR ADDITIONAL INFORMATION. BROWARD COUNTY TRAFFIC ENGINEERING DIVISION WILL NOT ACCEPT ANY PROJECTS THAT DO NOT MEET THESE STANDARDS AND SPECIFICATIONS. IF FIBER OPTIC PULL BOXES ALREADY EXIST AT AN INTERSECTION, NO ADDITIONAL FIBER OPTIC PULL BOXES WILL NEED TO BE INSTALLED. FOR A COPY OF THESE STANDARDS REFER TO THE BROWARD COUNTY WEB SITE AT: WWW.BROWARD.ORG/TRAFFIC UNDER PUBLICATIONS.
2. IF THERE ARE COPPER INTERCONNECT CABLES WITHIN YOUR PROJECT LIMITS OR WITHIN 1,500 FEET OF YOUR PROJECT LIMITS, CONTACT THE COMMUNICATIONS MANAGER AT TECOMMUNICATIONS@BROWARD.ORG OR 954-847-2745.
3. IF THERE ARE FIBER OPTIC CABLES WITHIN YOUR PROJECT LIMITS OR WITHIN 1,500 FEET OF YOUR PROJECT LIMITS, CONTACT THE COMMUNICATIONS MANAGER AT TECOMMUNICATIONS@BROWARD.ORG OR 954-847-2745.
4. IF THERE ARE CELLULAR COMMUNICATIONS WITHIN YOUR PROJECT LIMITS, CONTACT THE COMMUNICATIONS MANAGER AT TECOMMUNICATIONS@BROWARD.ORG OR 954-847-2745.
5. ALL BCTED COMMUNICATIONS CABLES/CONDUIT SHALL BE LOCATED A MINIMUM OF 48 HOURS IN ADVANCE.

BROWARD COUNTY TRAFFIC ENGINEERING DIVISION PROCEDURE FOR NOTIFICATION OF COMMUNICATION DISRUPTION. COPPER INTERCONNECT CABLE NOTIFICATION CONTACT PERSON: WHEN COMMUNICATIONS TO AN INTERSECTION MUST BE INTERRUPTED BY A CONTRACTOR TO PERFORM WORK, THE CONTRACTOR SHALL PROVIDE TWO DAY ADVANCE NOTICE IN WRITING TO THE BROWARD COUNTY TRAFFIC ENGINEERING DIVISION. THIS NOTIFICATION SHALL BE CONVEYED VIA ELECTRONIC MAIL (EMAIL) TO THE COMMUNICATIONS MANAGER AT TECOMMUNICATIONS@BROWARD.ORG. NOTIFICATION SHALL INCLUDE CONTACT PERSON, TELEPHONE NUMBER, PURPOSE, LOCATION AND DURATION. THE DISRUPTION SHALL LAST FOR NO MORE THAN 3 CONSECUTIVE BUSINESS DAYS. WHERE POSSIBLE, THE DISRUPTION SHALL BE DURING OFF PEAK HOURS BEGINNING AT 1:00 AM AND ENDING AT 3:00 PM. FIBER OPTIC CABLE NOTIFICATION CONTACT PERSON: WHEN COMMUNICATIONS TO AN INTERSECTION MUST BE INTERRUPTED BY A CONTRACTOR TO PERFORM WORK, THE CONTRACTOR SHALL PROVIDE TWO DAY ADVANCE NOTICE IN WRITING TO THE BROWARD COUNTY TRAFFIC ENGINEERING DIVISION. THIS NOTIFICATION SHALL BE CONVEYED VIA ELECTRONIC MAIL (EMAIL) TO THE COMMUNICATIONS MANAGER AT TECOMMUNICATIONS@BROWARD.ORG. NOTIFICATION SHALL INCLUDE CONTACT PERSON, TELEPHONE NUMBER, PURPOSE, LOCATION AND DURATION. THE DISRUPTION SHALL LAST FOR NO MORE THAN 3 CONSECUTIVE BUSINESS DAYS. WHERE POSSIBLE, THE DISRUPTION SHALL BE DURING OFF PEAK HOURS BEGINNING AT 1:00 AM AND ENDING AT 3:00 PM. UTILITY OWNER CONTACT PERSON: INTERCONNECT COMMUNICATIONS CABLES - (ROBERT BLOUNT) BROWARD COUNTY TRAFFIC ENGINEERING DIVISION (BCTED) 954-847-2745

CITY OF FORT LAUDERDALE PUBLIC WORKS DEPARTMENT ENGINEERING DETAILS SHEET: BROWARD COUNTY COMMUNICATION NOTES GNRL 006

SCHOOL ZONE INSTALLATION REQUIREMENTS WITHIN BROWARD COUNTY:

- 1. THE CONTRACTOR SHALL BE GOVERNED BY THE LATEST EDITIONS OF THE FOLLOWING MANUALS:
A. THE FDOT DESIGN STANDARDS
B. THE FDOT STANDARD SPECIFICATIONS FOR ROAD AND BRIDGE CONSTRUCTION
C. THE BROWARD COUNTY MINIMUM STANDARDS APPLICABLE TO PUBLIC RIGHTS-OF-WAY
2. FOR THE LATEST EDITION OF SCHOOL FLASHER DETAIL SHEETS AND MAINTENANCE OF TRAFFIC SCHOOL PEDESTRIAN NOTES, SEE THE BROWARD COUNTY TRAFFIC ENGINEERING DIVISION'S WEB SITE AT: HTTP://WWW.BROWARD.ORG/TRAFFIC/PAGES/PUBLICATIONS.ASPX.
3. THE "MAINTENANCE OF TRAFFIC SCHOOL PEDESTRIAN" NOTES SHALL APPEAR ON THE PLAN AS INDICATED. DEPENDING ON THE JURISDICTION OF THE ROADWAY THE CONTRACTOR WILL UTILIZE EITHER THE BCTED OR FDOT VERSION, WHICH WILL BE DETERMINED BY THE SCHOOL SAFETY PROGRAM SPECIAL PROJECTS COORDINATOR AT BCTED.
4. SCHOOL FLASHER PLANS ARE VALID FOR EIGHTEEN (18) MONTHS FROM DATE OF APPROVAL. AFTER THAT DATE, PLANS SHALL BE RESUBMITTED FOR APPROVAL.
5. NO SCHOOL FLASHER AND/OR ASSOCIATED EQUIPMENT SHALL BE PLACED OUTSIDE OF THE PUBLIC RIGHT-OF-WAY OR ON PRIVATE PROPERTY WITHOUT THE PRIOR ACQUISITION OF THE NECESSARY TRAFFIC ENGINEERING EASEMENTS BY THE CONSULTANT/CONTRACTOR. THESE EASEMENTS SHALL BE LARGE ENOUGH TO ALLOW ACCESS TO THE TRAFFIC ENGINEERING EQUIPMENT BY TECHNICIANS AND BY LARGER VEHICLES WHO MAY REQUIRE ACCESS TO THE EQUIPMENT. THE SIZE AND LOCATION OF THE EASEMENTS WILL BE DETERMINED ON A CASE-BY-CASE BASIS. THE EASEMENTS SHALL BE RECORDED DOCUMENTS AND A COPY OF THE FULLY EXECUTED RECORDED EASEMENT SHALL BE PROVIDED TO THE SCHOOL SAFETY PROGRAM SPECIAL PROJECTS COORDINATOR PRIOR TO INSTALLATION.
6. PRIOR TO ANY EQUIPMENT ORDER, THE CONTRACTOR SHALL SUBMIT TO THE SCHOOL SAFETY PROGRAM SPECIAL PROJECTS COORDINATOR AT BCTED FOR APPROVAL, ALL OF THE EQUIPMENT SPECIFICATIONS (I.E. SHOP DRAWINGS) FOR ALL MATERIALS PROPOSED FOR THE PROJECT. SEE SECTION 604 OF THE FDOT STANDARD SPECIFICATIONS FOR ROAD AND BRIDGE CONSTRUCTION FOR SUBMITTAL DATA REQUIREMENTS. INCLUDED IN THE SUBMITTAL SHALL BE SHOP DRAWINGS FOR GROUND MOUNT AND/OR MAST ARM DETAILS, AS APPLICABLE.
7. IF ELECTRICAL SERVICE IS REQUIRED, THE CONTRACTOR SHALL MAKE WRITTEN REQUEST TO BCTED, SYSTEMS SECTION - DESIGN ENGINEER, TO PROVIDE BILLING AUTHORIZATION TO FPL. THIS IS REQUIRED BEFORE ELECTRICAL SERVICE CAN BE OBTAINED. THE REQUEST SHALL INCLUDE A STATEMENT CERTIFYING THAT THIS ELECTRICAL INSTALLATION MEETS OR EXCEEDS ALL APPLICABLE REQUIREMENTS OF ALL APPLICABLE CODES AND IS NOW READY FOR CONNECTION TO FPL FACILITIES. ALSO INCLUDE THE DATE SERVICE IS REQUIRED BY THE REQUEST.
8. THE CONTRACTOR SHALL MAKE WRITTEN REQUEST TO THE SCHOOL SAFETY PROGRAM SPECIAL PROJECTS COORDINATOR AT BCTED EITHER BY FAX: 954-847-2700 OR E-MAIL: TRAFFIC@BROWARD.ORG TO SCHEDULE AN INSPECTION OF THE COMPLETE INSTALLATION, INCLUDING THE INTERIOR SIGNING AND PAVEMENT MARKING PLAN. ACTIVATION OF THE FLASHERS SHALL ONLY BE PERMITTED AFTER SAID INSPECTION.

CITY OF FORT LAUDERDALE PUBLIC WORKS DEPARTMENT ENGINEERING DETAILS SHEET: SCHOOL ZONE INSTALLATION REQUIREMENTS GNRL 007

- 9. THE CONTRACTOR SHALL PROVIDE SIX (6) SETS OF MARKED UP (AS-BUILT) CONSTRUCTION PLANS TO THE ENGINEER AND BCTED AS DEFINED IN FDOT STANDARD SPECIFICATIONS FOR ROAD AND BRIDGE CONSTRUCTION SECTION 611. SEVEN (7) DAYS PRIOR TO SCHOOL FLASHER CONDITIONAL ACCEPTANCE INSPECTION BY BCTED, THE CONTRACTOR SHALL ALSO PROVIDE TWO SETS OF AS-BUILT PLANS TO BCTED SIGNAL TECHNICIAN AT THE TIME OF INSPECTION. TWO COPIES PER CABINET PRINTS, TWO SETS OF CABINET KEYS AND PAGETIME SWITCH OPERATION MANUALS FOR EACH LOCATION SHALL ALSO BE TURNED OVER AT THIS TIME.
10. THE CONTRACTOR IS ADVISED THAT THE PRESENCE OF OVERHEAD ELECTRICAL CONDUCTORS IN CLOSE PROXIMITY TO THE LOCATIONS OF PROPOSED SCHOOL FLASHERS MAY LIMIT THE TYPE OF EQUIPMENT THAT CAN BE USED IN CONSTRUCTION OF THE SCHOOL FLASHER. THE CONTRACTOR SHALL COORDINATE WITH FPL TO DEACTIVATE LINES IF NECESSARY.
11. ALL SIGN ASSEMBLIES SHOWN OR NOTED ON THE PLAN SHEETS FOR REMOVAL SHALL BE DELIVERED TO THE BCTED OPERATIONS BUILDING, 200 WEST COMMERCIAL BLVD., FORT LAUDERDALE. EXISTING FLASHERS ARE NOT TO BE REMOVED UNTIL AFTER THE NEW UNIT HAS PASSED ITS FINAL INSPECTION.
12. SIGN LOCATIONS MAY BE VARIED IN THE FIELD AS NECESSARY IN ORDER TO AVOID CONFLICTS WITH UNFORESEEN OBSTACLES, DRIVEWAYS, ETC. ANY SIGN LOCATION VARIATIONS SHALL BE APPROVED BY THE ENGINEER OF RECORD AND SHOWN ON THE AS-BUILTS.

CITY OF FORT LAUDERDALE PUBLIC WORKS DEPARTMENT ENGINEERING DETAILS SHEET: SCHOOL ZONE INSTALLATION REQUIREMENTS GNRL 007

PREPARED BY: Kimley Horn


© 2021 KIMLEY-HORN AND ASSOCIATES, INC. 8201 PETERS ROAD, SUITE 2200, PLANTATION, FL 33324 PHONE: 954-535-5100 FAX: 954-739-2247 WWW.KIMLEY-HORN.COM REGISTRY No. 696

DESIGN CRITERIA PACKAGE


PROJECT # 12412 PUMP STATION A-16 UPGRADE WASTEWATER DESIGN CRITERIA PACKAGE GENERAL NOTES

SHEET NO. 1 OF 31 CAD FILE: 12412-MULTI-NOTE DRAWING FILE NO: 4-142-31


EXISTING PUMP STATION A-16 TO BE DEMOLISHED

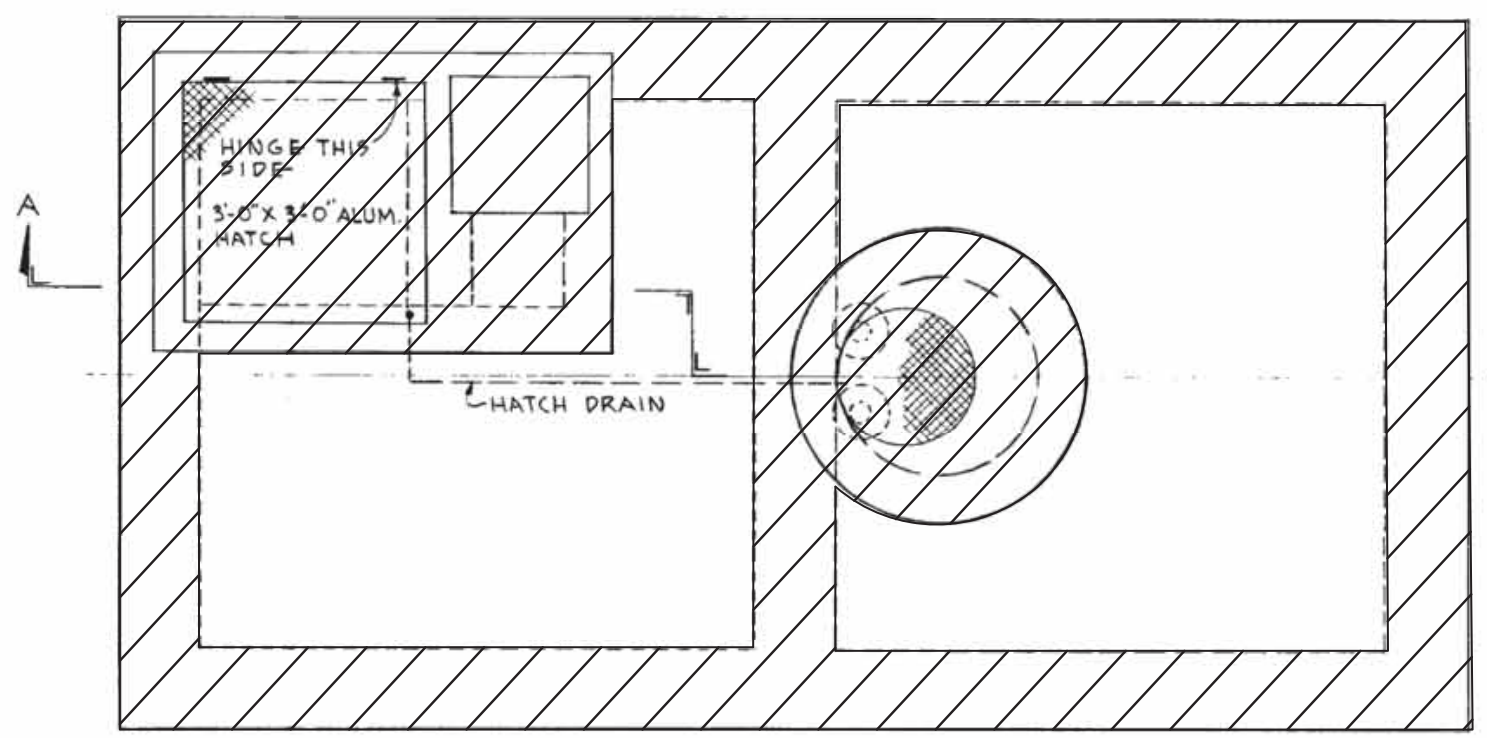


PLAN OF PUMPING STATION  
SCALE: 1/2" = 1'-0"

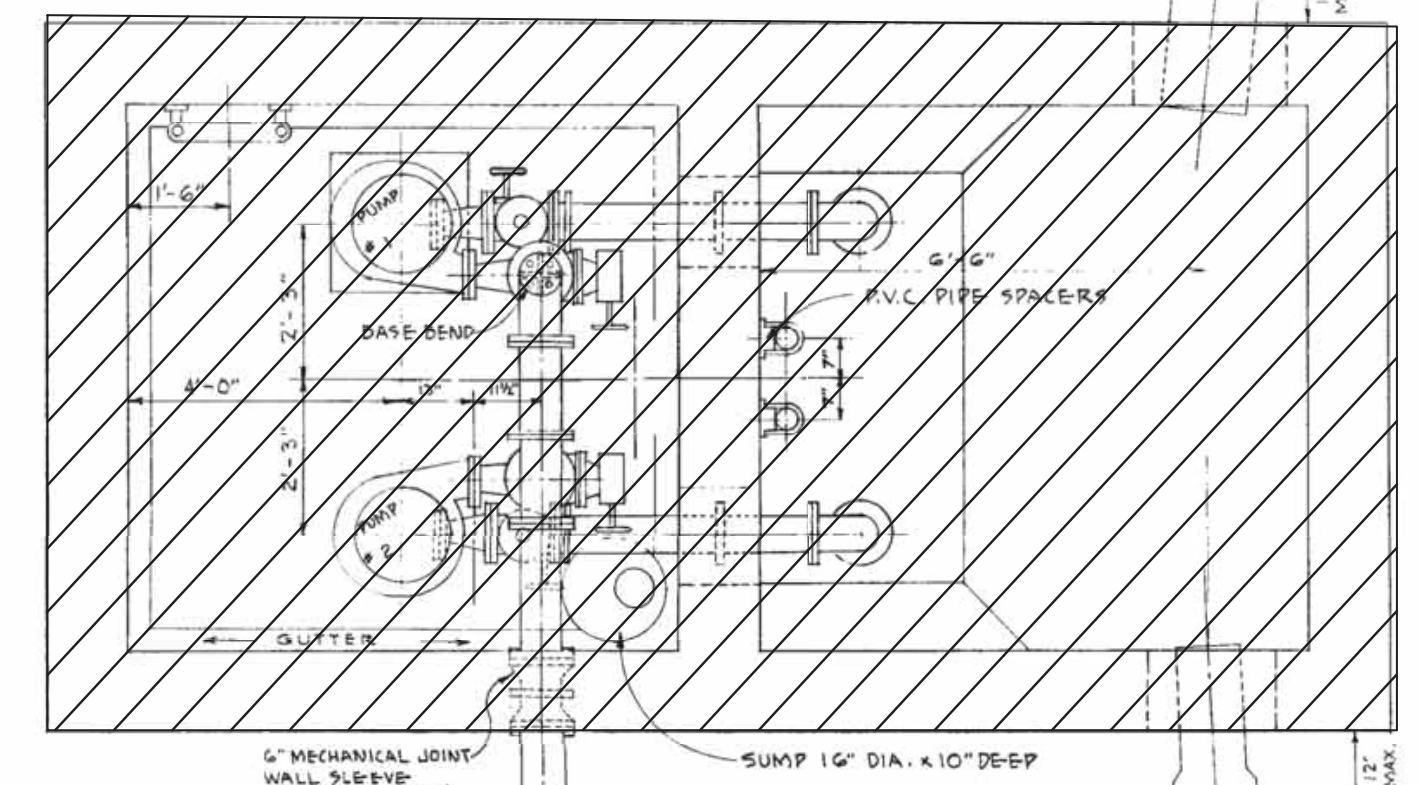


SECTION-B-B  
SCALE: 1/4" = 1'-0"

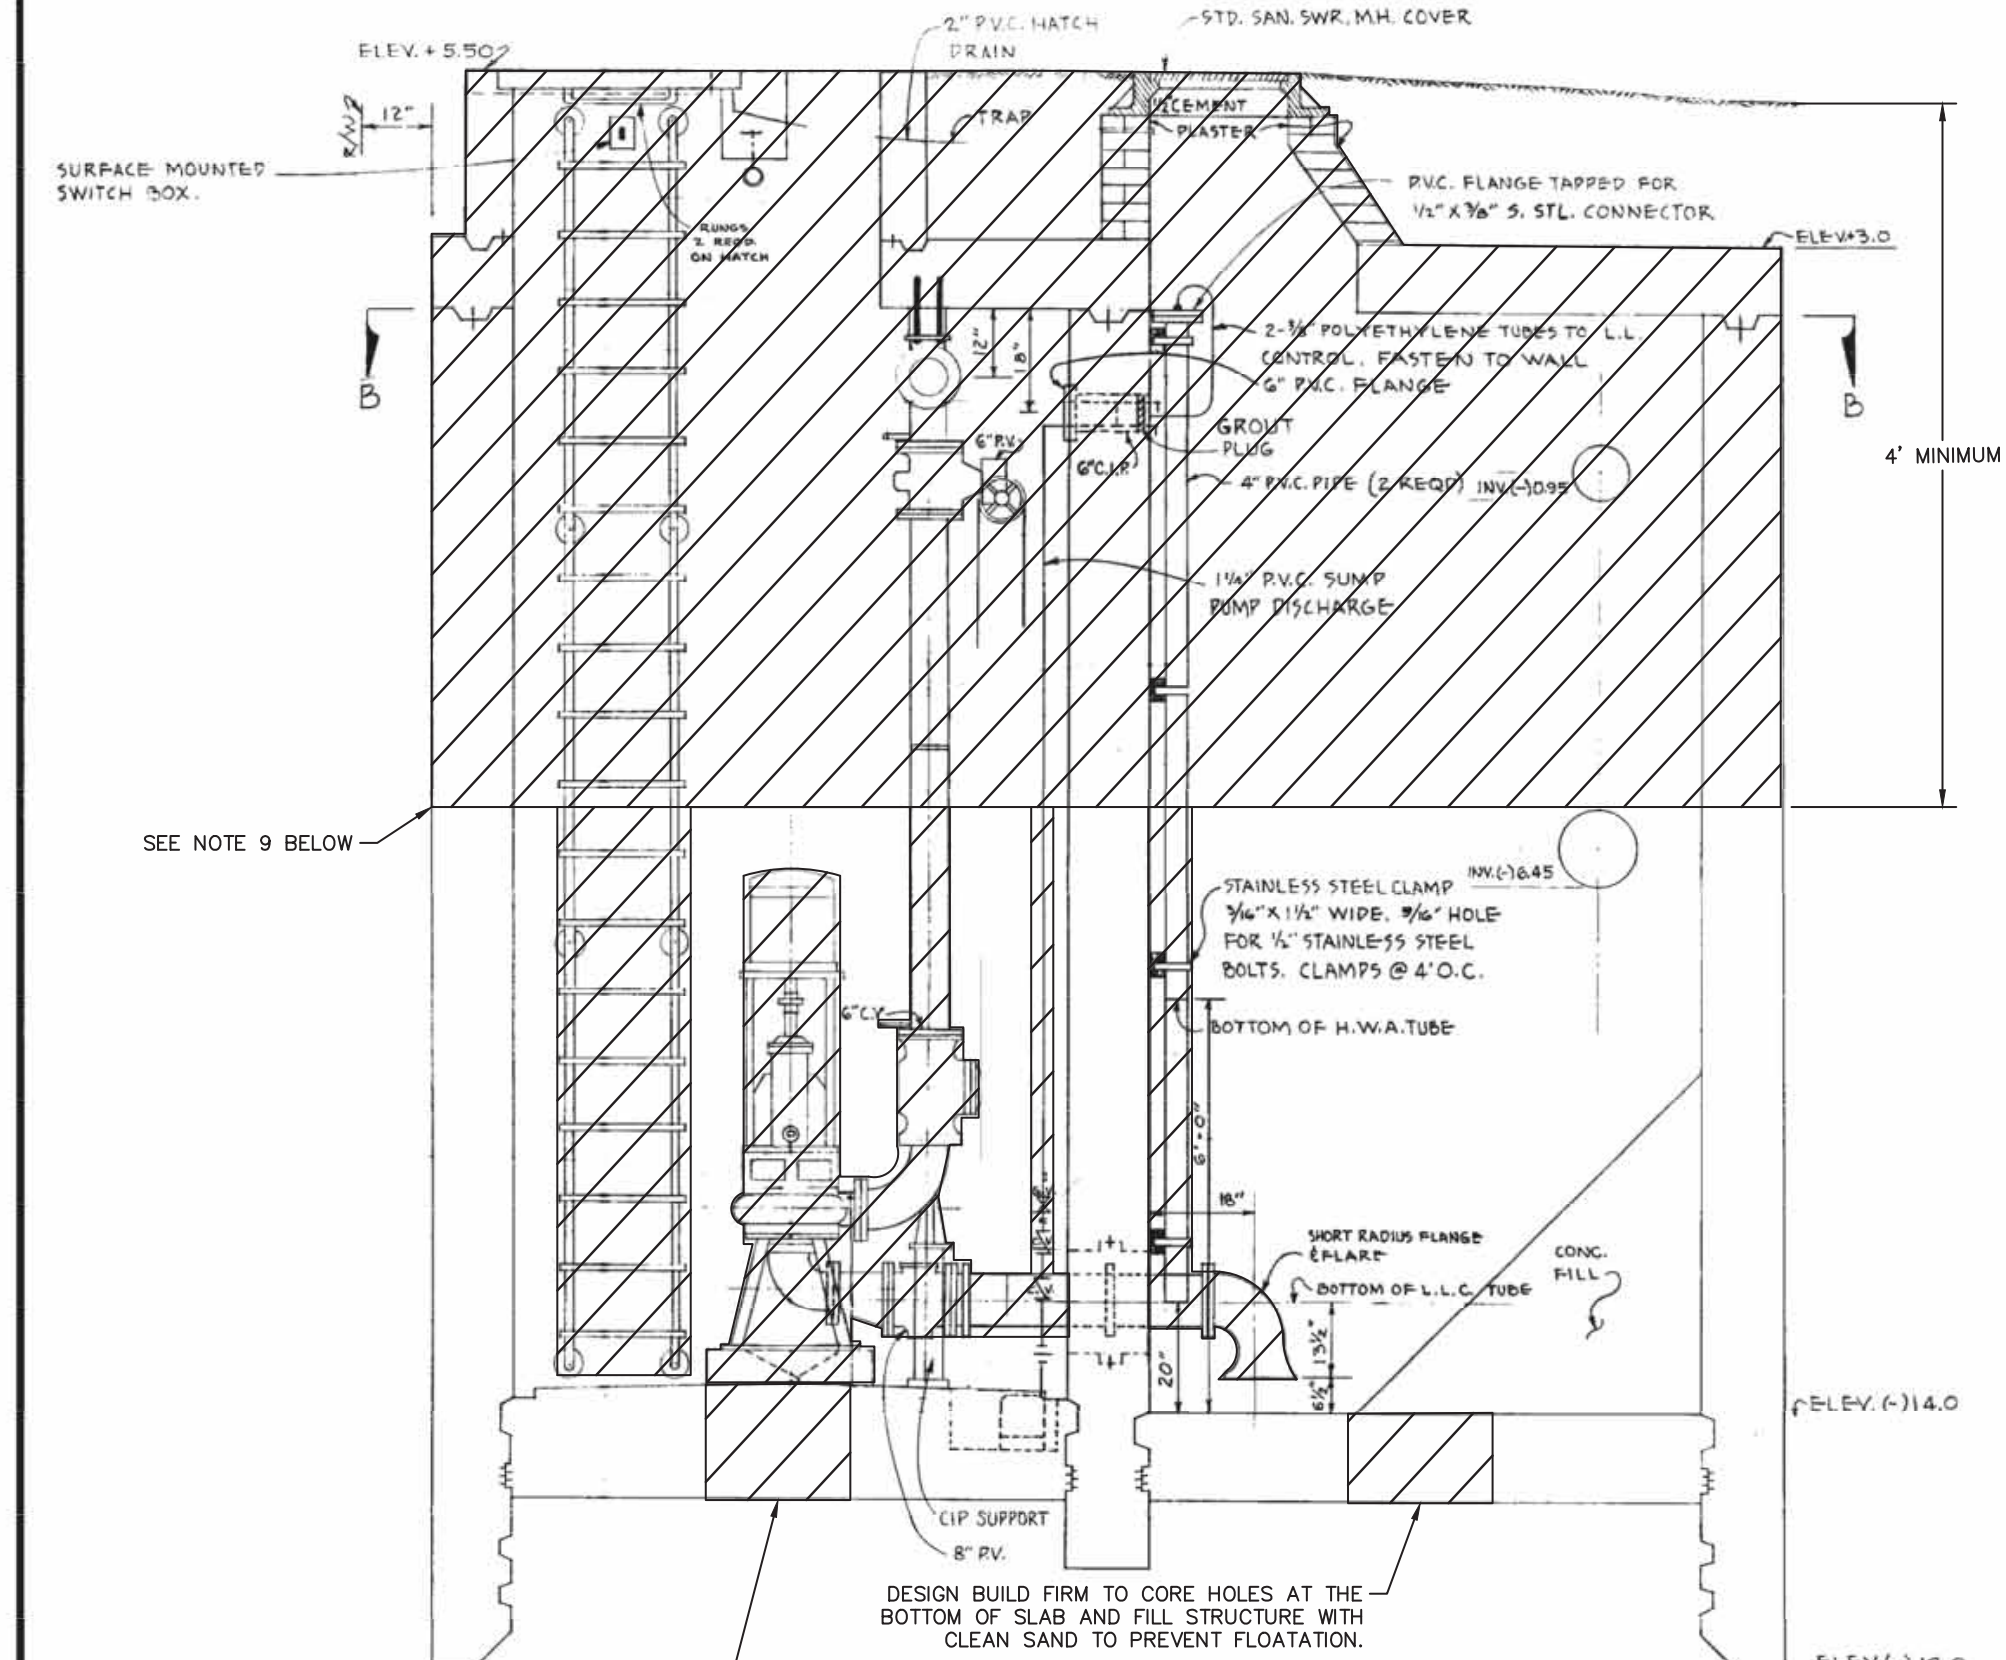


SECTION AA  
SCALE: 1/2" = 1'-0"

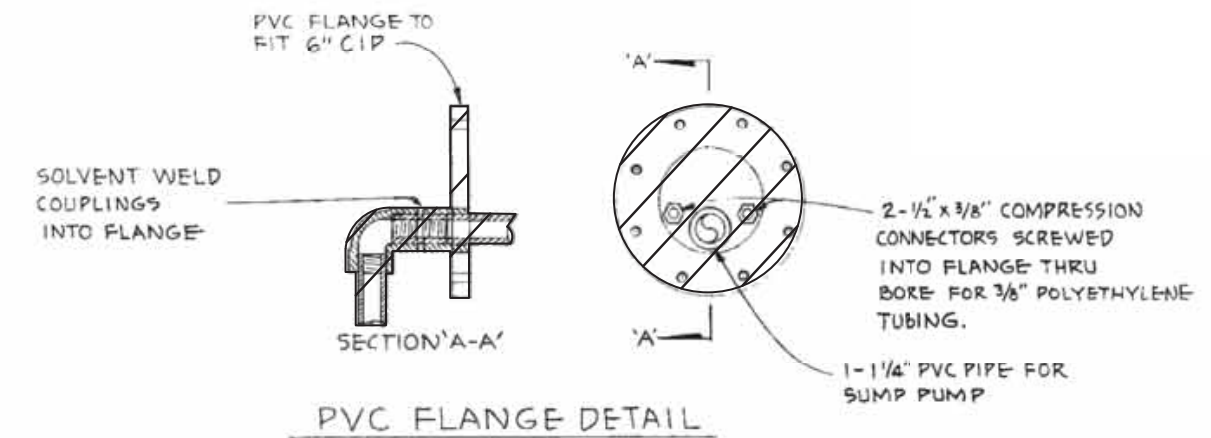

PVC FLANGE DETAIL

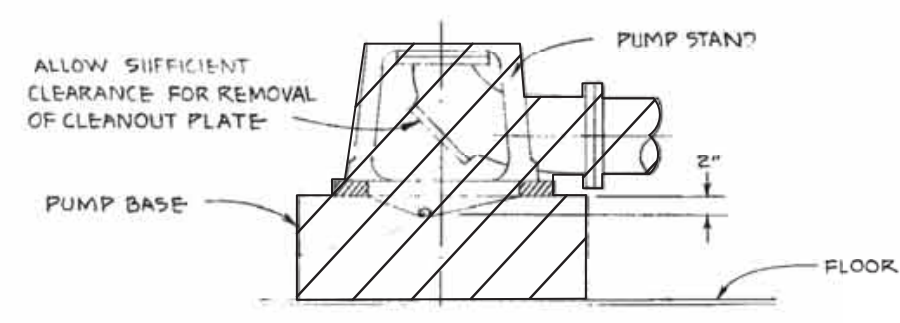

SECTION THRU PUMP BASE  
SCALE: 1" = 1'-0"

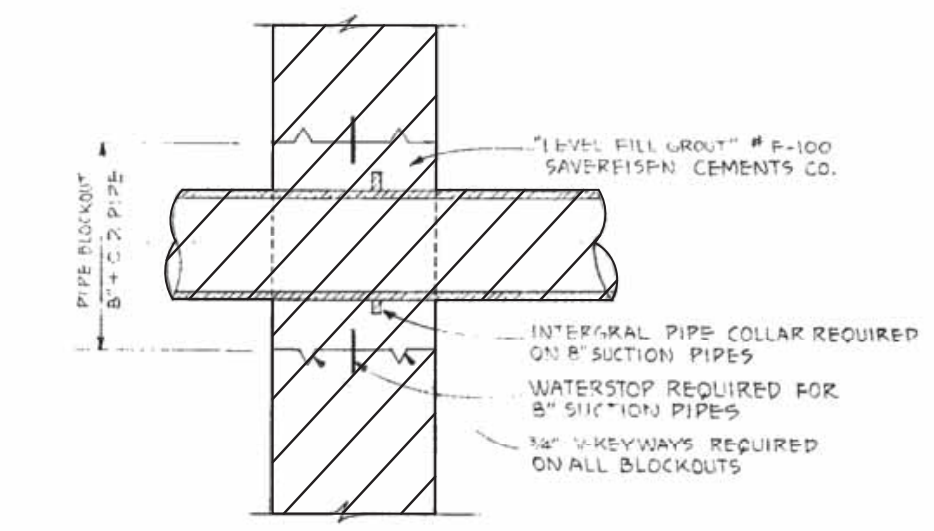

TYPICAL PIPE & CONDUIT BLOCKOUT DETAIL  
NG SCALE

- GENERAL NOTES**
- ELEVATIONS REFER TO M.S.L. + 0.00 (USCGS)
  - ALL PVC PIPE SHALL BE SCHEDULE 80 TYPE II WITH SOLVENT WELDED OR SCREWED JOINTS.
  - CONCRETE SHALL BE CLASS 'A' WITH AIR ENTRAINMENT.
  - ALL BRACKETS SHALL BE OF NON-FERROUS METAL OR PLASTIC WITH TYPE 316 STAINLESS STEEL FASTENERS.

- LEGEND**
- X - GATE VALVE (UNLESS SPECIFIED OTHERWISE)
  - Z - SWING CHECK VALVE
  - U - UNION
  - PV - PLUG VALVE
  - CV - CHECK VALVE

**LEGEND:**  
 TO BE DECOMMISSIONED/DEMOLISHED

- NOTES:**
- THIS PREVIOUS DESIGN PLAN IS INCLUDED FOR INFORMATIONAL PURPOSES. ALL EQUIPMENT IS NOT INSTALLED EXACTLY AS SHOWN. PLANS NOT TO SCALE.
  - ELEVATIONS PROVIDED ON THIS PREVIOUS DESIGN PLAN ARE ASSUMED TO REFERENCE THE NATIONAL GEODETIC VERTICAL DATUM OF 1929 (NGVD 29).
  - FLOOD ZONE: AH.
  - BASE FLOOD ELEVATION (BFE): 6.0' NAVD 1988.
  - THE ITEMS DEPICTED FOR DEMOLITION ARE GENERAL ONLY. ALL ANCILLARY STRUCTURES, PIPING AND OTHER ASSOCIATED EQUIPMENT ARE TO BE INCLUDED IN THE DEMOLITION WORK.
  - AFTER DEMOLITION, ALL DEBRIS IS TO BE REMOVED AND LEGALLY DISPOSED BY THE DESIGN BUILD FIRM IN ACCORDANCE WITH ALL LOCAL, STATE, AND FEDERAL REGULATIONS.
  - AFTER DISPOSAL OF MATERIAL, THE DESIGN BUILD FIRM SHALL RE-GRADE THE AREA TO MATCH SURROUNDING GRADE AND DRAINAGE PATTERNS. DESIGN BUILD FIRM TO OBTAIN REQUIRED FILL NEEDED TO LEVEL AREAS WHERE STRUCTURES PREVIOUSLY EXISTED.
  - DESIGN BUILD FIRM SHALL BACKFILL, COMPACT AND RESTORE SURFACE CONDITIONS AT ALL AREAS OF PIPE/STRUCTURE DEMOLITION AND REMOVAL COMPACT TO 98% ASTM D-1557, IN 12" LIFTS.
  - DESIGN BUILD FIRM SHALL REMOVE ALL PIPING, VALVES, AND APPURTENANCES FROM STRUCTURES TO FIRST BEND BELOW GRADE OR MINIMUM OF 4 FEET BELOW GRADE WITHIN 50 FEET OF THE LOCATION. ALL PIPING TO BE DISPOSED OF IN ACCORDANCE WITH ALL LOCAL, STATE, AND FEDERAL REGULATIONS. DESIGN BUILD FIRM TO VERIFY WITH CITY THAT ANY SYSTEM TO BE REMOVED IS OUT OF SERVICE BEFORE DEMOLITION.

CITY OF FORT LAUDERDALE, FLORIDA  
 PROJECT 3129  
 SEWAGE PUMPING STATION  
 A-16  
 MECHANICAL

(PUMP STA. A-16 TO SERVE IMP 1244)

NO.	DATE	BY	CHK.	REMARKS

V.A.S. DRAWN BY  
 #22 CHECKED BY  
 NONE FIELD BOOK

OFFICE OF CITY ENGINEER

17 DEC 09 DATE  
 AS NOTED SCALE  
 2 OF 4 SHEET

FILE NO. 4-65-32

DESIGN CRITERIA PACKAGE

PROJECT # 12412  
 PUMP STATION A-16 UPGRADE  
 WASTEWATER DESIGN CRITERIA PACKAGE  
 DEMOLITION PLAN

SHEET NO.	OF
2	31
CAD FILE:	12412-MULTI-DEMO
DRAWING FILE NO.	4-142-31

ENGINEER:  
 GARY E. RATAV, P.E.  
 REG. NO. 46682  
 DATE: 9/26/2021

DESIGNED BY: AL  
 CHECKED BY: CR  
 SCALE: AS NOTED

CITY OF FORT LAUDERDALE  
 PUBLIC WORKS DEPARTMENT  
 ENGINEERING & ARCHITECTURE  
 100 North Andrews Avenue, Fort Lauderdale, Florida 33301


NO.	DATE	BY	CHKD	DESCRIPTION

Plotted By: Marissa  
 Sheet: Sew-PUMP STATION A-16 DESIGN CRITERIA PACKAGE  
 Layout: 2-MULTI-DEMO  
 September 28, 2021 04:12:46pm  
 K:\HLS\1043\_jpas\043184401\_cano 12464-416 ps a-16 rev location\CAD\plansheets\12412-MULTI-DEMO.dwg  
 This document, together with the concepts and designs presented herein, as an instrument of service, is intended only for the specific purpose and client for which it was prepared. Reuse of and improper reliance on this document without written authorization and adaptation by Kimley-Horn and Associates, Inc. shall be without liability to Kimley-Horn and Associates, Inc.



PREPARED BY:  
**Kimley»Horn**  
 © 2021 KIMLEY-HORN AND ASSOCIATES, INC.  
 8201 PETERS ROAD, SUITE 2200, PLANTATION, FL 33324  
 PHONE: 954-535-5100 FAX: 954-739-2247  
 WWW.KIMLEY-HORN.COM REGISTRY No. 696

# EXISTING PUMP STATION A-16 TO BE DEMOLISHED

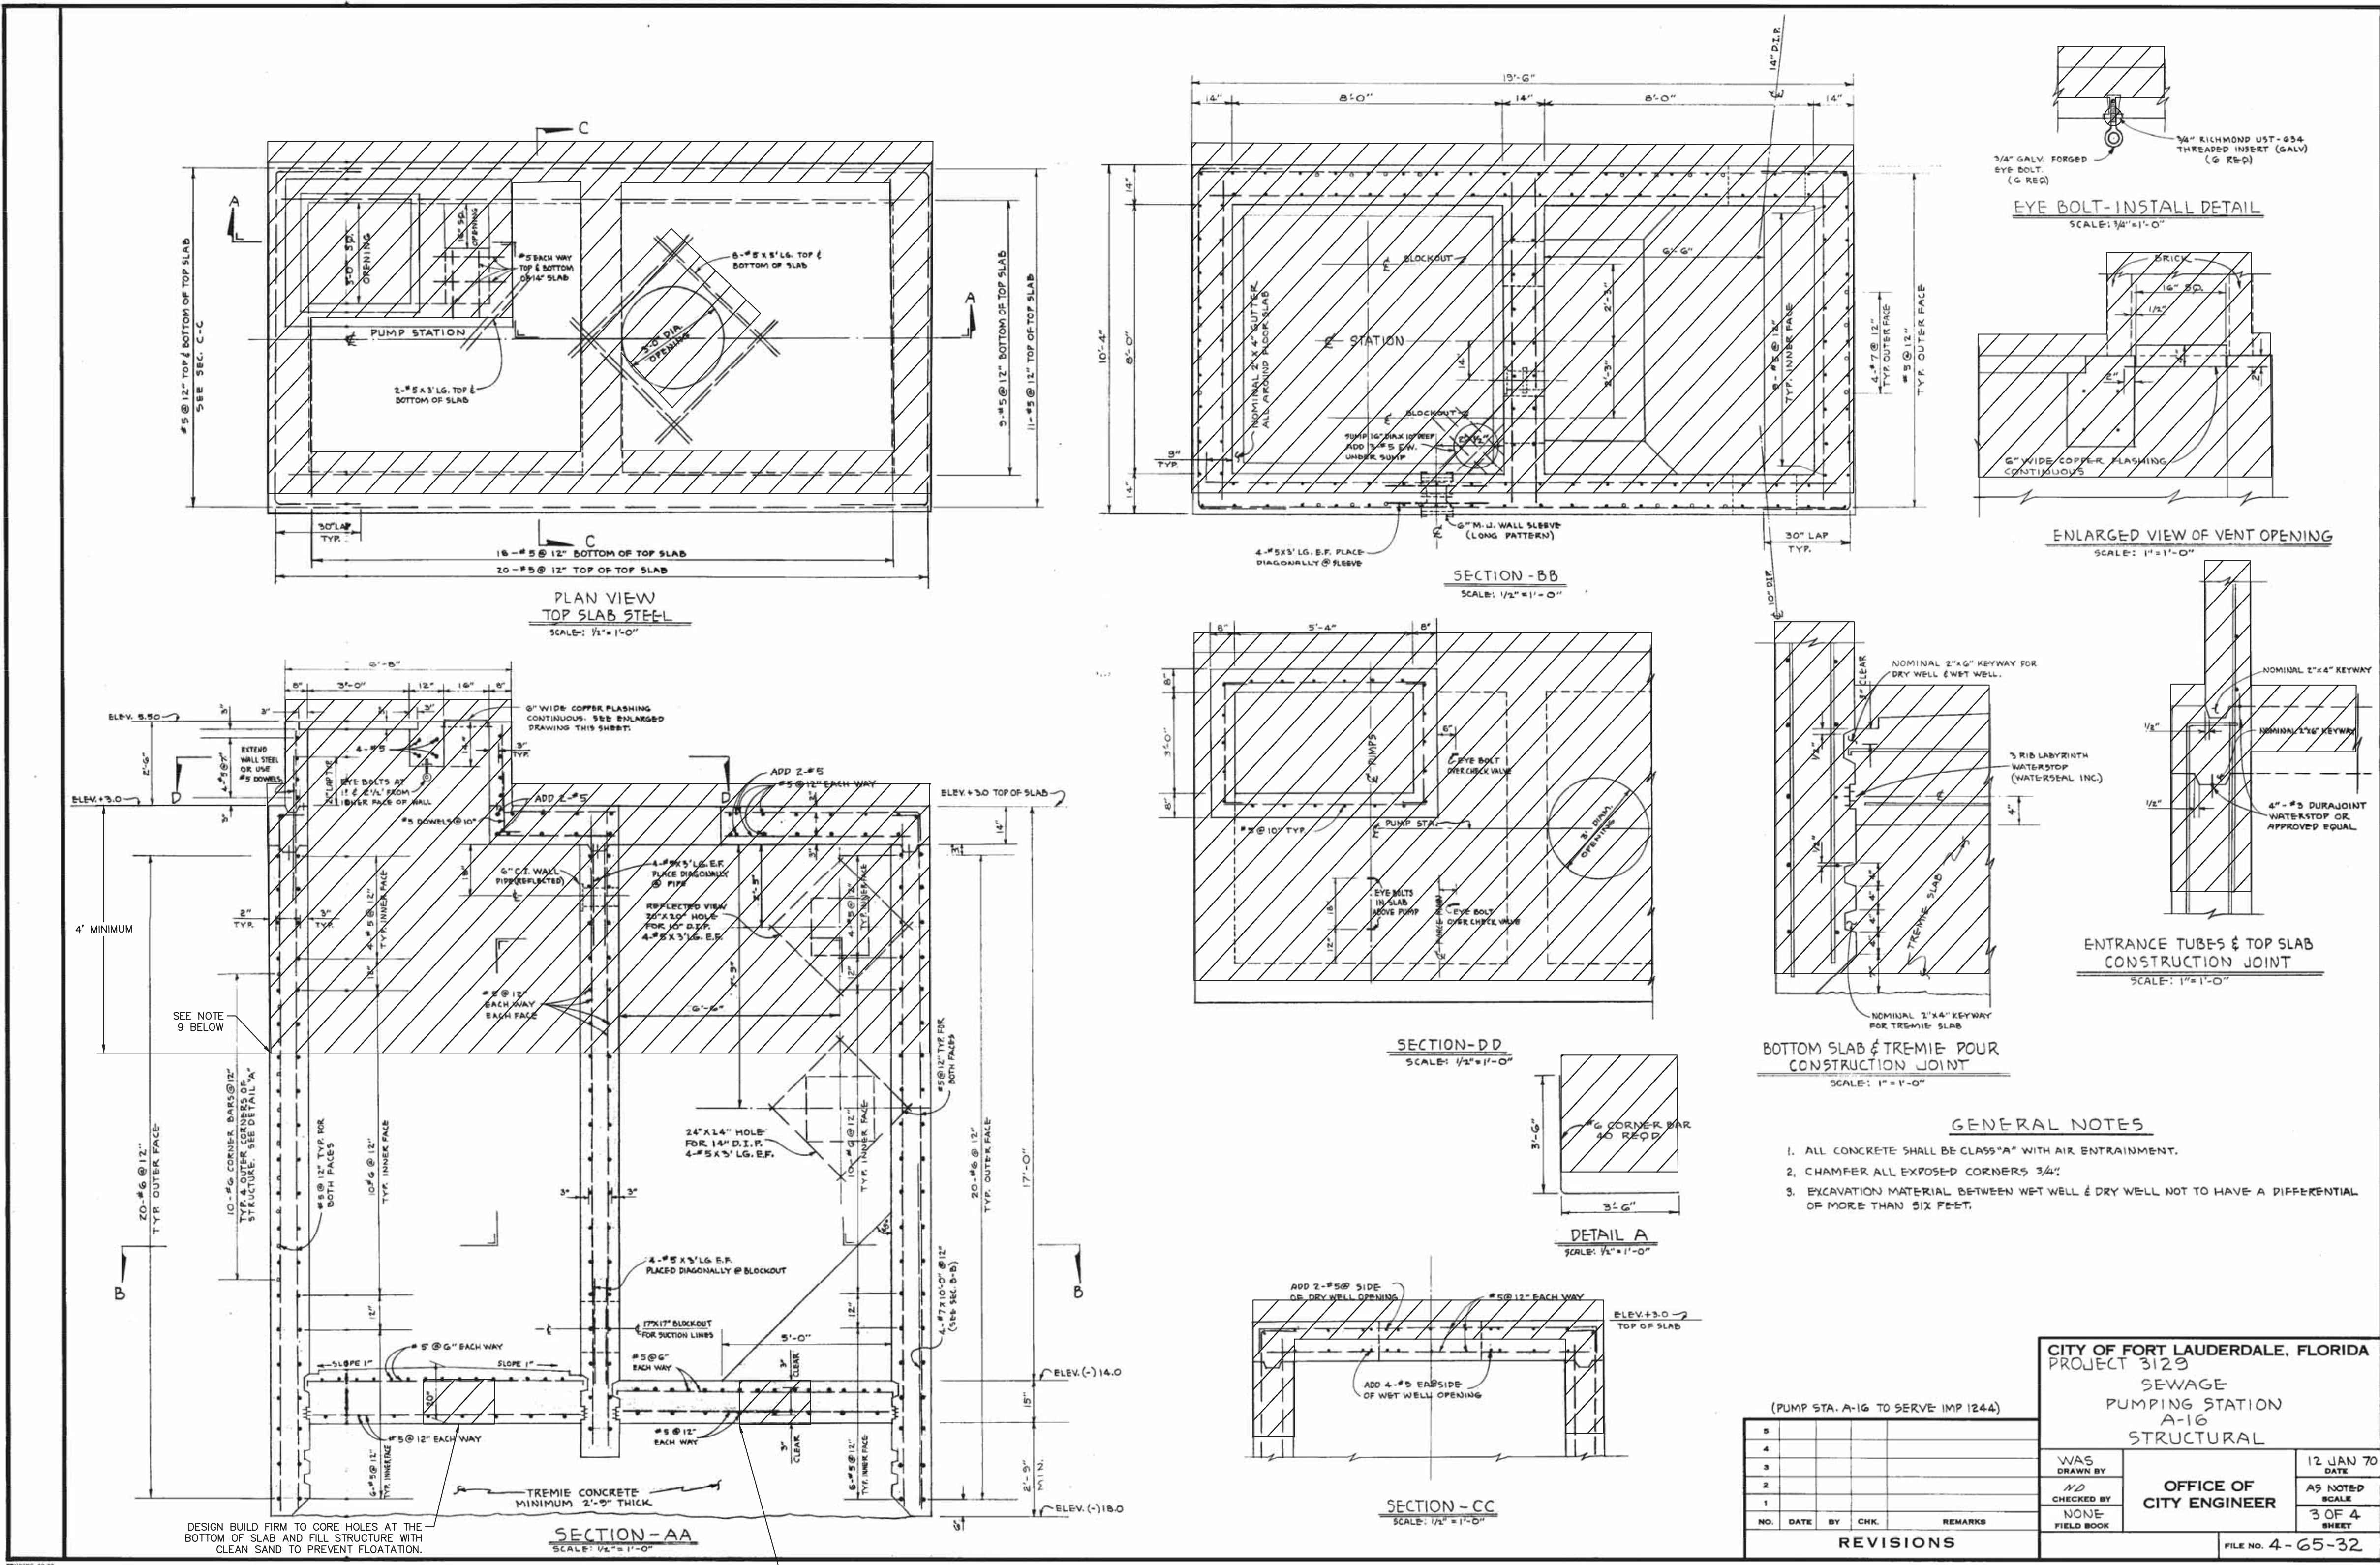

**GENERAL NOTES**

- ALL CONCRETE SHALL BE CLASS "A" WITH AIR ENTRAINMENT.
- CHAMFER ALL EXPOSED CORNERS 3/4".
- EXCAVATION MATERIAL BETWEEN WET WELL & DRY WELL NOT TO HAVE A DIFFERENTIAL OF MORE THAN SIX FEET.

**REVISIONS**

NO.	DATE	BY	CHK.	REMARKS

**CITY OF FORT LAUDERDALE, FLORIDA**  
**PROJECT 3129**  
**SEWAGE PUMPING STATION A-16**  
**STRUCTURAL**

DESIGNED BY: **OFFICE OF CITY ENGINEER**  
 DATE: 12 JAN 70  
 SCALE: AS NOTED  
 SHEET: 3 OF 4  
 FILE NO. 4-G5-32



**LEGEND:**

TO BE DECOMMISSIONED/DEMOLISHED

**NOTES:**

- THIS PREVIOUS DESIGN PLAN IS INCLUDED FOR INFORMATIONAL PURPOSES. ALL EQUIPMENT IS NOT INSTALLED EXACTLY AS SHOWN. PLANS NOT TO SCALE.
- ELEVATIONS PROVIDED ON THIS PREVIOUS DESIGN PLAN ARE ASSUMED TO REFERENCE THE NATIONAL GEODETIC VERTICAL DATUM OF 1929 (NGVD 29).
- FLOOD ZONE: AH.
- BASE FLOOD ELEVATION (BFE): 6.0' NAVD 1988.
- THE ITEMS DEPICTED FOR DEMOLITION ARE GENERAL ONLY. ALL ANCILLARY STRUCTURES, PIPING AND OTHER ASSOCIATED EQUIPMENT ARE TO BE INCLUDED IN THE DEMOLITION WORK.
- AFTER DEMOLITION, ALL DEBRIS IS TO BE REMOVED AND LEGALLY DISPOSED BY THE DESIGN BUILD FIRM IN ACCORDANCE WITH ALL LOCAL, STATE, AND FEDERAL REGULATIONS.
- AFTER DISPOSAL OF MATERIAL, THE DESIGN BUILD FIRM SHALL RE-GRADE THE AREA TO MATCH SURROUNDING GRADE AND DRAINAGE PATTERNS. DESIGN BUILD FIRM TO OBTAIN REQUIRED FILL NEEDED TO LEVEL AREAS WHERE STRUCTURES PREVIOUSLY EXISTED.
- DESIGN BUILD FIRM SHALL BACKFILL, COMPACT AND RESTORE SURFACE CONDITIONS AT ALL AREAS OF PIPE/STRUCTURE DEMOLITION AND REMOVAL. COMPACT TO 98% ASTM D-1557, IN 12" LIFTS.
- DESIGN BUILD FIRM REMOVE ALL PIPING, VALVES, AND APPURTENANCES FROM STRUCTURES TO FIRST BEND BELOW GRADE OR MINIMUM OF 4 FEET BELOW GRADE WITHIN 50 FEET OF THE LOCATION. ALL PIPING TO BE DISPOSED OF IN ACCORDANCE WITH ALL LOCAL, STATE, AND FEDERAL REGULATIONS. DESIGN BUILD FIRM TO VERIFY WITH CITY THAT ANY SYSTEM TO BE REMOVED IS OUT OF SERVICE BEFORE DEMOLITION.

PREPARED BY:  
**Kimley»Horn**  
 © 2021 KIMLEY-HORN AND ASSOCIATES, INC.  
 8201 PETERS ROAD, SUITE 2200, PLANTATION, FL 33324  
 PHONE: 954-535-5100 FAX: 954-739-2247  
 WWW.KIMLEY-HORN.COM REGISTRY No. 696

DESIGN CRITERIA PACKAGE

PROJECT # 12412  
 PUMP STATION A-16 UPGRADE  
 WASTEWATER DESIGN CRITERIA PACKAGE  
 DEMOLITION PLAN

SHEET NO. **3** OF **31**

CAD FILE: 12412-MULTI-DEMO  
 DRAWING FILE NO. 4-142-31

NO.	DATE	BY	CHKD	DESCRIPTION

**CITY OF FORT LAUDERDALE**  
**PUBLIC WORKS DEPARTMENT**  
**ENGINEERING & ARCHITECTURE**  
 100 North Andrews Avenue, Fort Lauderdale, Florida 33301

ENGINEER: GARY E. RATAV, P.E.  
 REG. NO: 46682  
 DATE: 9/29/2021  
 DESIGNED BY: AL  
 CHECKED BY: CR  
 SCALE: AS NOTED  
 FIELD BOOK:

DRAWN BY: AL  
 DATE: MAR 2021  
 PROJECT: 12412  
 SHEET: 3 OF 4  
 FILE NO: 4-G5-32

TEL: (954) 535-5100  
 FAX:

Plotted By: Marissa  
 Sheet: S:\PUMP STATION A-16 DESIGN CRITERIA PACKAGE - Layout\3-MULTI-DEMO - September 28, 2021 04:12:56pm  
 K:\MUL\043 jobs\043184401.cmn 12464-416 ps 0-16 rev location CAD\plan sheets\12412-MULTI-DEMO.dwg  
 This document, together with the concepts and designs presented herein, is intended only for the specific purpose and client for which it was prepared. Reuse of any information on this document without written authorization and adaptation by Kimley-Horn and Associates, Inc. shall be without liability to Kimley-Horn and Associates, Inc.

Plotted By: Marissa Street, Pump Station A-16 Design Criteria Package, Layout: Multi-Upgrade, September 28, 2021, 04:13:03pm. K:\MUL\043\_jas\043164401\_cmo\_12464-416\_pis-16\_rev location CAD\plansheets\12412-MULTI-DEM.DWG. This document, together with the concepts and designs presented herein, is an instrument of service, is intended only for the specific purpose and client for which it was prepared. Reuse of and improper reliance on this document without written authorization and adaptation by Kimley-Horn and Associates, Inc. shall be without liability to Kimley-Horn and Associates, Inc.

**DEMOLITION NOTES:**  
GENERAL DEMOLITION SPECIFICATIONS:  
1. THE LOCATIONS, ELEVATIONS AND DIMENSIONS OF ALL EXISTING UTILITIES SHOWN ON THE DRAWINGS HAVE BEEN DETERMINED FROM THE BEST INFORMATION AVAILABLE AND ARE GIVEN FOR THE CONVENIENCE OF THE CONTRACTOR. THE ENGINEER ASSUMES NO RESPONSIBILITY FOR THEIR ACCURACY.  
2. PRIOR TO THE START OF ANY CONSTRUCTION ACTIVITY, THE CONTRACTOR SHALL VERIFY THE LOCATION, ELEVATIONS, AND DIMENSIONS OF ALL EXISTING UTILITIES AND OTHER FEATURES AFFECTING THE WORK. THE CONTRACTOR SHALL IMMEDIATELY NOTIFY THE ENGINEER OF ANY DISCREPANCIES THAT MIGHT IMPACT THE WORK.  
3. CHAPTER 353.551 OF THE FLORIDA STATUTES REQUIRES THAT AN EXCAVATOR NOTIFY ALL UTILITIES A MINIMUM OF TWO (2) WORKING DAYS PRIOR TO EXCAVATING.  
4. THE CONTRACTOR SHALL LOCATE ALL UNDERGROUND UTILITIES BEFORE EXCAVATION.  
5. THE CONTRACTOR SHALL FURNISH ALL MATERIALS, LABOR, SUPERVISION, AND EQUIPMENT REQUIRED FOR THE ORDERLY DEMOLITION AND REMOVAL OF EXISTING STRUCTURES, PAVEMENT AND UTILITIES AS SHOWN ON THE DRAWINGS AND DESCRIBED HEREIN.  
6. THE CONTRACTOR IS REQUIRED TO FAMILIARIZE HIMSELF WITH THE STRUCTURES TO BE DEMOLISHED.  
7. THE FOLLOWING LIST OF STRUCTURES REQUIRING DEMOLITION IS INCLUDED FOR THE CONTRACTOR'S CONVENIENCE ONLY. THE DRAWINGS INDICATE THE SCOPE OF DEMOLITION WHERE DEMOLITION IS REQUIRED.  
7.1. DEMOLITION AND REMOVAL OF A 9' MIN x 4' STRIP OF EXISTING ON-SITE ASPHALT, CONCRETE AND CURBING AROUND THE PERIMETER OF THE EXISTING STRUCTURES AND UTILITIES BEING DEMOLISHED.  
7.2. REMOVAL OF EXISTING ON-SITE ABOVEGROUND AND UNDERGROUND UTILITIES, INCLUDING REMOVAL OR PLUGGING OF EXISTING UTILITIES AS SHOWN ON PLANS.  
8. PRIOR TO REMOVAL OF ANY UNDERGROUND TANK AND OTHER COMPONENT, CONTRACTOR MUST COMPLETELY DRAIN THE SYSTEMS TO AN APPROVED SANITATION TANK FOR DISPOSAL TO AN APPROVED LOCATION, AS REQUIRED BY DISPOSAL PERMIT.  
9. PROTECT ALL UTILITIES, UNLESS OTHERWISE NOTED.  
10. ALL THE CONCRETE AND PAVEMENT TO BE REMOVED MUST BE SAW CUT CLEAN PRIOR TO REMOVAL.  
11. WET DOWN MASONRY WALLS AND DEBRIS DURING DEMOLITION AND LOADING OPERATIONS TO PREVENT THE SPREAD OF DUST (AS APPLICABLE TO PROJECT).  
12. ALL EXISTING STRUCTURES, PAVEMENTS, SLABS, FOUNDATIONS, STEPS AND OTHER ON-SITE EXISTING FEATURES INDICATED ON THE DRAWINGS TO BE DEMOLISHED SHALL BE DEMOLISHED AND REMOVED BY THE CONTRACTOR (AS APPLICABLE TO PROJECT).

**DEMOLITION PERMITTING:**  
1. IT IS THE CONTRACTOR'S RESPONSIBILITY TO OBTAIN ANY REQUIRED PERMITS FOR DEMOLITION FROM RESPONSIBLE REGULATORY AGENCIES WHILE FULLY ACKNOWLEDGING AND COMPLYING WITH ALL REQUIREMENTS PRIOR TO COMMENCING DEMOLITION WORK.  
2. IT IS THE CONTRACTOR'S SOLE RESPONSIBILITY TO DETERMINE THE EXTENT OF DEMOLITION, RECYCLING OR REUSE REQUIRED TO PERFORM THE CONTRACT WORK FOR THIS PROJECT. THE CONTRACTOR SHALL CONDUCT SITE VISITS AND SHALL EXAMINE ALL THE INFORMATION WITHIN THESE DOCUMENTS. ALL DISCREPANCIES AND/OR OMISSIONS SHALL BE BROUGHT TO THE ATTENTION OF THE ENGINEER PRIOR TO BID SUBMITTAL.  
3. THE CONTRACTOR SHALL COORDINATE WITH OWNER PRIOR TO COMMENCEMENT OF ANY WORK. ACTUAL REMOVAL AND/OR RELOCATION OF ALL EXISTING LANDSCAPING WITHIN DEMOLITION AREAS TO BE CONDUCTED BY A LANDSCAPE CONTRACTOR. IT IS THE RESPONSIBILITY OF THE SITEWORK DEMOLITION CONTRACTOR TO COORDINATE DEMOLITION ACTIVITIES WITH THE LANDSCAPE CONTRACTOR. THE CONTRACTOR IS RESPONSIBLE FOR REMOVING AND PRESERVING TREES AS INDICATED ON THE PLANS. THE CONTRACTOR IS RESPONSIBLE FOR OBTAINING A TREE REMOVAL PERMIT OR ANY OTHER APPLICABLE PERMIT TO REMOVE, RELOCATE OR PRESERVE EXISTING LANDSCAPE AND TREES.  
4. ANY TREES FOR REMOVAL FOUND TO BE GREATER THAN OR EQUAL TO THREE (3) INCHES IN DIAMETER AT BREAST HEIGHT (DBH) SHALL REQUIRE A PERMIT WITH THE BROWARD COUNTY ENVIRONMENTAL PROTECTION AND GROWTH MANAGEMENT DEPARTMENT (BCEGMD).  
5. SHOULD REMOVAL AND/OR RELOCATION ACTIVITIES DAMAGE THE LIGHTING, STORM INLET STRUCTURES, OR OTHER STRUCTURES DESIGNATED TO BE SAVED, THEN THE CONTRACTOR SHALL PROVIDE NEW MATERIALS/STRUCTURES IN ACCORDANCE WITH THE CONTRACT DOCUMENTS.

**INTERRUPTION OF EXISTING UTILITIES:**  
1. ANY DEMOLITION WORK THAT REQUIRES INTERRUPTION OF SERVICE TO ANY CUSTOMER SHALL BE DONE SO WITH A MINIMUM OF SEVENTY-TWO (72) HOUR WRITTEN NOTICE TO, AND WRITTEN APPROVAL BY, THE APPROPRIATE UTILITY COMPANY.  
2. THE CONTRACTOR SHALL ARRANGE A MEETING WITH THE LOCAL JURISDICTIONAL AGENCIES AND OTHER GOVERNING AGENCIES, AND OTHER AFFECTED UTILITIES PRIOR TO SCHEDULING THE SHUT-DOWN TO ASSESS THE SCOPE OF WORK.  
3. ALL SYSTEM SHUT-DOWNS SHALL BE SCHEDULED BY THE CONTRACTOR AT SUCH TIME THAT SYSTEM DEMAND IS LOW. THIS GENERALLY REQUIRES NIGHT-TIME WORK BY THE CONTRACTOR AND REQUIRES FULL-TIME INSPECTION BY A REPRESENTATIVE OF THE UTILITY. ALL COST FOR OVERTIME WORK BY THE REPRESENTATIVE OF THE UTILITY SHALL BE BORNE BY THE CONTRACTOR.  
4. EACH CUSTOMER AFFECTED BY THE SHUT-DOWN SHALL BE PROVIDED, MINIMUM, FORTY-EIGHT (48) HOURS WRITTEN NOTIFICATION BY THE CONTRACTOR.  
**TEMPORARY DEMOLITION FACILITIES:**  
1. IT SHALL BE THE CONTRACTOR'S RESPONSIBILITY TO ARRANGE OR SUPPLY TEMPORARY WATER SERVICE, SANITARY FACILITIES AND ELECTRICITY TO ITS EMPLOYEES AND SUBCONTRACTORS FOR THEIR USE DURING DEMOLITION.  
2. MAINTENANCE OF TRAFFIC (MOT) IN THE PUBLIC RIGHT-OF-WAY SHALL BE IN ACCORDANCE WITH THE MANUAL OF UNIFORM TRAFFIC CONTROL DEVICES AND FLORIDA DEPARTMENT OF TRANSPORTATION STANDARDS.  
3. ALL OPEN TRENCHES AND HOLES ADJACENT TO ROADWAYS OR WALWAYS SHALL BE PROPERLY MARKED AND BARRICADED TO ASSURE THE SAFETY OF BOTH VEHICULAR AND PEDESTRIAN TRAFFIC.  
4. NO TRENCHES OR HOLES NEAR WALKWAYS OR IN ROADWAYS OR THEIR SHOULDERS ARE TO BE LEFT OPEN DURING NIGHT-TIME HOURS WITHOUT EXPRESS WRITTEN PERMISSION OF THE CITY OR RESPECTIVE GOVERNING AGENCY.

13. ALL EXISTING SEWERS, PIPING AND UTILITIES SHOWN ON THE DRAWINGS ARE NOT TO BE INTERPRETED AS THE EXACT LOCATION, OR AS THE ONLY OBSTACLES THAT MAY OCCUR ON THE SITE. THE CONTRACTOR SHALL VERIFY EXISTING CONDITIONS AND PROCEED WITH CAUTION AROUND ANY ANTICIPATED FEATURES. GIVE NOTICE TO ALL UTILITY COMPANIES REGARDING DESTRUCTION AND REMOVAL OF ALL SERVICE LINES AND CAP ALL LINES BEFORE PROCEEDING WITH THE WORK.  
14. THE CONTRACTOR SHALL COORDINATE WITH THE APPROPRIATE UTILITY COMPANY PRIOR TO REMOVAL OR RELOCATION OF ANY ELECTRICAL, TELEPHONE, CABLE AND/OR GAS LINES. SUFFICIENT TIME SHALL BE PROVIDED FOR RELOCATION AND CLOSE COORDINATION WITH THE UTILITY COMPANY TO PROVIDE A SMOOTH TRANSITION IN UTILITY SERVICE.  
15. CONTRACTOR MUST STOP OPERATION AND NOTIFY THE OWNER/ENGINEER FOR PROPER DIRECTION IF ANY ENVIRONMENTAL OR HEALTH RELATED CONTAMINANT IS ENCOUNTERED DURING THE DEMOLITION/EXCAVATION PROCESS.  
16. FILL FOR LOWER LEVELS OF DEMOLISHED STRUCTURES MAY INCLUDE CONCRETE OR MASONRY RUBBLE RESULTING FROM DEMOLITION, SUBJECT TO THE ENGINEER'S ARCHITECT'S APPROVAL. RUBBLE SHALL PASS THROUGH A THREE-INCH RING.  
17. REMOVE AND LEGALLY DISPOSE OF ALL OTHER RUBBLE, RUBBLE, AND DEBRIS. COMPLY WITH ALL APPLICABLE LAWS AND REGULATIONS GOVERNING DISPOSAL OF WASTES AND DEBRIS.  
18. MAINTAIN ACCESS TO SURROUNDING PROPERTIES AND BUILDINGS.  
19. PRIOR TO DEMOLITION OCCURRING ALL EROSION CONTROL DEVICES ARE TO BE INSTALLED.  
20. ALL TRAFFIC SIGNS OUTSIDE THE DEMOLITION AREA ARE TO REMAIN UNLESS OTHERWISE SPECIFIED.  
21. ANY MUCK ENCOUNTERED UNDER PROPOSED STRUCTURES SHALL BE REMOVED TO FIVE-FEET BEYOND THE FOOTPRINT OF THAT STRUCTURE. BACKFILL WITH APPROVED FILL MATERIAL SATISFYING ALL COMPACTION REQUIREMENTS.  
22. ALL EXISTING UTILITIES WITHIN THE DEMOLITION SITE AREA SHALL BE ADJUSTED, REMOVED OR RELOCATED AT THE CONTRACTOR'S EXPENSE. WORK SHALL BE COORDINATED BY THE CONTRACTOR DIRECTLY WITH THE APPROPRIATE UTILITY COMPANY. ALL EXPENSES SHALL BE INCLUDED IN THE CONTRACTOR'S BID.  
23. ALL TRASH, DEBRIS AND OTHER MATERIAL REMOVED FROM THE SITE SHALL BE PROPERLY DISPOSED OF BY THE CONTRACTOR IN ACCORDANCE WITH ALL LOCAL, STATE AND FEDERAL REGULATIONS.

**DEMOLITION EROSION AND SEDIMENT CONTROL NOTES:**  
1. THE SCHEDULING, SEQUENCING AND CONTROL MEASURES, WHICH ARE OUTLINED HEREIN, ARE SUBJECT TO THE FINAL DEFINITION BY THE CONTRACTOR WHO SHALL BE SELECTED TO PERFORM THE WORK AND SHALL BE RESPONSIBLE FOR IMPLEMENTATION AND COMPLIANCE.  
2. PRIOR TO DEMOLITION, THE CONTRACTOR SHALL BE REQUIRED TO SUBMIT A DEMOLITION SCHEDULE AND EACH PHASE OF THE WORK. THE CONTRACTOR SHALL ALSO BE REQUIRED TO SUBMIT AN EROSION AND SEDIMENT CONTROL PLAN ENCOMPASSING THE PRINCIPALS AND THE REQUIREMENTS DESCRIBED HEREIN AND A SCHEDULE FOR THEIR IMPLEMENTATION AND MAINTENANCE FOR THE PROJECT DURATION.  
3. DURING DEMOLITION, THE CONTRACTOR SHALL TAKE ALL REASONABLE MEASURES TO ENSURE AGAINST POLLUTING, SILTATION OR DISTURBANCE TO SUCH AN EXTENT AS TO CAUSE AN INCREASE IN TURBIDITY TO THE EXISTING DRAINAGE SYSTEMS AND ADJACENT WATER BODIES AND WETLANDS, IN COMPLIANCE WITH ALL PERMIT REQUIREMENTS RELATED TO SUCH MEASURES.  
4. METHODS MAY INCLUDE TEMPORARY EROSION AND SEDIMENT CONTROLS SUCH AS SEDIMENT BASINS, SEDIMENT CHECKS, SILT BARRIERS, SILT SCREENS, TURBIDITY BARRIERS OR THE BEST MANAGEMENT PRACTICES AVAILABLE TO THE INDUSTRY.  
5. EROSION AND SEDIMENT CONTROL INSTALLATIONS SHALL BE MAINTAINED THROUGHOUT THE DEMOLITION PERIOD AND UNTIL NEW VEGETATIVE GROWTH HAS BEEN ESTABLISHED.  
6. THROUGHOUT THE DEMOLITION PERIOD, THE CONTRACTOR SHALL INSPECT DAILY THE EROSION AND SEDIMENT CONTROL INSTALLATIONS FOR FAILURE OR SIGNS OF FAILURE OR MALFUNCTION. REPAIR OR REPLACE THE EROSION AND SEDIMENT CONTROL INSTALLATIONS IMMEDIATELY UPON DISCOVERY OF FAILURE OR MALFUNCTION.  
7. INLETS AND CATCH BASINS, EXISTING ON-SITE AND OFF-SITE, SHALL BE PROTECTED FROM SEDIMENT STORM RUNOFF.  
8. THE CONTRACTOR SHALL PROMPTLY REMOVE ALL MUD, DIRT OR OTHER MATERIALS TRACKED OR SPILLED ONTO EXISTING PUBLIC ROADS AND FACILITIES DUE TO DEMOLITION.  
9. DEWATERING ACTIVITIES SHALL NOT RESULT IN ANY DISCHARGE OF TURBID WATER FROM THE PROJECT SITE WITHOUT PROPER EROSION AND SEDIMENT CONTROL AND APPROVAL FROM ENGINEER.  
10. PHASING OF EROSION CONTROL DEMOLITION SHALL BE RECOMMENDED AS FOLLOWS:  
10.1. PLACEMENT OF PERIMETER PROTECTIVE MEASURES (SILT FENCE, HAY BALES, TURBIDITY BARRIERS, ETC.) AROUND ON-SITE FEATURES TO BE RETAINED, AT POINTS OF OFF-SITE DISCHARGE AND AROUND WORK AREAS TO BE EXCAVATED OR FILLED.  
10.2. REROUTE RUNOFF FROM AREAS OUTSIDE OF THE DEMOLITION AREA TO MINIMIZE FLOW THROUGH AREAS TO BE DISTURBED BY DEMOLITION. SWALES AND OTHER MEANS USED FOR SUCH CONVEYANCE SHALL BE REPAIRED AND MEASURES TAKEN TO PROVIDE PROTECTION UNTIL STABILIZATION OCCURS (AS APPLICABLE TO THE PROJECT).

**WASTE MANAGEMENT PLAN:**  
1. IMPLEMENT A WASTE MANAGEMENT PLAN FOR APPROVAL BY THE OWNER. PROVIDE HANDLING, CONTAINERS, STORAGE, SIGNAGE, TRANSPORTATION AND OTHER ITEMS AS NEEDED TO IMPLEMENT THE WASTE MANAGEMENT PLAN DURING THE ENTIRE DURATION OF THE CONTRACT.  
2. DESIGNATE A WASTE MANAGEMENT COORDINATOR TO BE RESPONSIBLE FOR IMPLEMENTING, MONITORING AND REPORTING STATUS OF WASTE MANAGEMENT WORK PLAN. COORDINATOR SHALL BE PRESENT AT PROJECT SITE FULL-TIME FOR DURATION OF PROJECT.  
3. TRAIN WORKERS, SUBCONTRACTORS AND SUPPLIERS ON PROPER WASTE MANAGEMENT PROCEDURES, AS APPROPRIATE FOR THE WORK AT THE PROJECT SITE.  
4. DISTRIBUTE A WASTE MANAGEMENT PLAN BEFORE WORK BEGINS. REVIEW PLAN PROCEDURES AND LOCATION ESTABLISHED FOR SALVAGE, RECYCLING AND DISPOSAL.  
**RECYCLING DEMOLITION WASTE:**  
1. SEPARATE RECYCLABLE WASTE FROM OTHER WASTE MATERIALS, TRASH AND DEBRIS. SEPARATE RECYCLABLE WASTE BY TYPE AT THE PROJECT SITE TO THE MAXIMUM EXTENT PRACTICAL.  
2. PROVIDE APPROPRIATELY MARKED CONTAINERS OR BINS FOR CONTROLLING RECYCLABLE WASTE UNTIL THEY ARE REMOVED FROM THE PROJECT SITE. INCLUDE A LIST OF ACCEPTABLE AND UNACCEPTABLE MATERIALS AT EACH CONTAINER AND BIN.  
3. INSPECT CONTAINERS AND BINS FOR CONTAMINATION AND REMOVE CONTAMINATED MATERIALS IF FOUND.  
4. STOCKPILE PROCESSED MATERIALS ON-SITE WITHOUT INTERMIXING WITH OTHER MATERIALS. PLACE, GRADE AND SHAPE STOCKPILES TO DRAIN SURFACE WATER. COVER TO PREVENT WIND-BLOWN DUST.  
5. STOCKPILE MATERIALS AWAY FROM DEMOLITION AREA. DO NOT STORE WITHIN DRP LINE OF REMAINING TREES.  
6. STORE COMPONENTS OFF THE GROUND AND PROTECT FROM THE WEATHER.  
7. REMOVE RECYCLABLE WASTE OFF THE OWNER'S PROPERTY AND TRANSPORT TO RECYCLING RECEIVER OR PROCESSOR.  
8. ASPHALTIC CONCRETE PAVING: BREAK UP AND TRANSPORT PAVING TO ASPHALT RECYCLING FACILITY.  
9. CONCRETE: REMOVE REINFORCEMENT AND OTHER METALS FROM CONCRETE AND SORT WITH OTHER METALS.  
10. MASONRY: MASONRY WASTE SHALL INCLUDE WHOLE OR BROKEN BRICK AND CONCRETE MASONRY UNITS. WHOLE MASONRY UNITS SHALL BE CLEANED AND REUSED OR DONATED. BROKEN MASONRY SHALL BE CRUSHED AND USED AS FILL FOR OFFSITE AREAS. REMOVE METAL REINFORCEMENT, ANCHORS AND TIES FROM MASONRY AND SORT WITH OTHER METALS.

**PRE-DEMOLITION RESPONSIBILITIES:**  
1. UPON RECEIPT OF NOTICE OF AWARD, THE CONTRACTOR SHALL ARRANGE A PRE-DEMOLITION CONFERENCE TO INCLUDE ALL INVOLVED GOVERNMENT AGENCIES, ALL AFFECTED UTILITY OWNERS, THE OWNER, THE ENGINEER AND THE CONTRACTOR.  
2. PRIOR TO DEMOLITION, THE CONTRACTOR SHALL BE REQUIRED TO SUBMIT A DEMOLITION SCHEDULE DESCRIBING EACH PHASE OF THE WORK.  
3. PRIOR TO DEMOLITION, CONTRACTOR TO PROVIDE FOR THE OWNER A LISTING OF THE FACILITIES THE CONTRACTOR SHALL UTILIZE FOR RECYCLING AND DISPOSAL OF SPECIAL MATERIALS. CONTRACTOR TO INDICATE THE MATERIALS INTENDED FOR RECYCLING AND THE MATERIALS INTENDED FOR DISPOSAL FOR OWNERS' APPROVAL.  
4. PRIOR TO DEMOLITION, CONTRACTOR TO PROVIDE THE OWNER SKETCHES SHOWING PROPOSED HAULING ROUTES TO RECYCLING AND DISPOSAL FACILITIES FOR APPROVAL.  
5. PRIOR TO DEMOLITION, THE CONTRACTOR SHALL VERIFY THE SIZE, LOCATION, ELEVATION, AND MATERIAL OF ALL EXISTING UTILITIES WITHIN THE AREA OF DEMOLITION.  
6. EXISTING UTILITY LOCATIONS SHOWN ON THESE PLANS ARE APPROXIMATE. THE CITY AND THE ENGINEER ASSUMES NO RESPONSIBILITY FOR THE ACCURACY OF EXISTING UTILITIES SHOWN OR FOR ANY EXISTING UTILITIES NOT SHOWN.  
7. THE CONTRACTOR SHALL BE RESPONSIBLE FOR DAMAGE TO ANY EXISTING UTILITIES FOR WHICH IT FAILS TO REQUEST LOCATIONS FROM THE UTILITY OWNER. THE CONTRACTOR IS RESPONSIBLE AS WELL FOR DAMAGE TO ANY EXISTING UTILITIES WHICH ARE PROPERLY LOCATED.  
8. THE LOCATIONS OF EXISTING UTILITIES AND STORM DRAINAGE SHOWN ON THE PLANS HAVE BEEN DETERMINED FROM THE BEST INFORMATION AVAILABLE AND ARE GIVEN FOR THE CONVENIENCE OF THE CONTRACTOR. ENGINEER ASSUMES NO RESPONSIBILITY FOR ACCURACY.  
9. PRIOR TO THE START OF ANY DEMOLITION ACTIVITY, THE CONTRACTOR SHALL FIELD LOCATE EXISTING UNDERGROUND UTILITIES WITH THE UTILITY OWNERS.  
10. THE CONTRACTOR IS RESPONSIBLE FOR RELOCATIONS OF THE VARIOUS EXISTING UTILITIES WITH THE UTILITY OWNERS, WHICH SHALL BE DONE IN A TIMELY MANNER TO MINIMIZE IMPACT ON DEMOLITION SCHEDULE. ANY DELAY CAUSED BY THE CONTRACTOR BY THE RELOCATION OF UTILITIES SHALL BE INCIDENTAL TO THE CONTRACT AND EXTRA COMPENSATION WILL BE ALLOWED.  
11. SUNSHINE STATE ONE CALL OF FLORIDA, INC. REQUIRES THE CONTRACTOR TO CALL TWO (2) FULL BUSINESS DAYS (BUT NOT MORE THAN FIVE) PRIOR TO BREAKING GROUND TO FIND OUT WHERE BURIED FACILITIES (ELECTRICAL, GAS, TELEPHONE, CABLE, WATER) ARE LOCATED.

10.1. SELECT LOCATIONS FOR PLACEMENT OF EXCAVATED MATERIAL, WHERE SUITABLE FOR FILL OR UNSUITABLE MATERIAL, AND CONSTRUCT CONTAINMENT BERM'S AROUND THE AREA. THE USE OF STRIPING FOR THIS PURPOSE MAY ACCELERATE BERM VEGETATION. CONSTRUCT TEMPORARY OUTLETS FOR CONTAMINANT AREAS WITH SCREENS, HAY BALES, SETTLING BASINS OR OTHER MEASURES TO PREVENT SILT TRANSPORT.  
10.4. SELECT DESIGNATE ACCESS ROUTING FOR DEMOLITION EQUIPMENT AND VEHICLES AND PROVIDE PERIMETER PROTECTIVE MEASURES WHERE EXISTING TERRAIN SHALL BE SUBJECT TO DISRUPTION BY SUCH TRAFFIC.  
10.5. CONSTRUCT ABOVE GROUND OR OTHER CONTAINMENT AREAS FOR DEMOLITION AREA RUNOFF. PROVIDE SCREENS, HAY BALES, ETC. TO FILTER DISCHARGE FROM THOSE AREAS.  
10.6. SPOIL MOUNDS SHALL NOT BE LEFT FOR MORE THAN ONE WEEK PRIOR TO REPLACEMENT UNLESS PROTECTIVE CONTAINMENT MEASURES IN THE WORK AREA ARE APPLIED.  
10.7. GRASSING, SOODING, ETC. SHALL BE IN PLACE IMMEDIATELY UPON COMPLETION OF REGRADING, SWALE SLOPES AND THE CONSTRUCTION OR DISTURBED AREAS.  
11. THE CONTRACTOR IS REQUIRED TO ADHERE TO THE REQUIREMENT OF THE NATIONAL POLLUTION DISCHARGE ELIMINATION SYSTEM (NPDES). THE CONTRACTOR SHALL INSTITUTE BEST MANAGEMENT PRACTICES (BMPs) TO ENSURE COMPLIANCE WITH THE NPDES PROGRAM AND TO MINIMIZE THE IMPACT TO PUBLIC STORMWATER FACILITIES. A NOTICE OF INTENT (NOI) SHALL BE FILED BY THE CONTRACTOR PRIOR TO BEGINNING CONSTRUCTION ACTIVITIES.  
12. THE CONTRACTOR SHALL PREPARE A STORMWATER POLLUTION PREVENTION PLAN (SWPPP) AND MAINTAIN ALL RECORDS REQUIRED BY ITS NPDES STORMWATER PERMIT FOR ITS CONSTRUCTION ACTIVITIES.  
13. PRIOR TO CONSTRUCTION, A SILT FENCE IN ACCORDANCE WITH CITY'S DETAIL SHALL BE ERRECTED AS NOTED ON PLANS. ALL PROPOSED CATCH BASINS SHALL HAVE THEIR INLETS PROTECTED BY THE INSTALLATION OF FILTER INLET INSERTS INTO THE FRAME AND GRATE. SILT FENCES AND FILTER INLET INSERTS SHALL REMAIN IN PLACE DURING THE ENTIRE DURATION OF CONSTRUCTION.  
14. CONTRACTOR SHALL BRACE ALL EXISTING LANDSCAPING TO REMAIN PRIOR TO BEGINNING ANY WORK AND SHALL ENSURE ITS STABILIZATION THROUGHOUT THE ENTIRE CONSTRUCTION PROCESS. EXISTING SOIL DISTURBED BY CONSTRUCTION THAT IS NOT AFFECTED BY PROPOSED GRADING SHALL BE RESTORED TO NEW CONDITION UPON COMPLETION OF CONSTRUCTION. SLOPED SLOPES STEEPER THAN FOUR HORIZONTAL TO ONE VERTICAL SHALL BE REPOSED.  
15. ALL WASTE GENERATED FROM THE CONSTRUCTION SHALL BE DISCARDED IN ACCORDANCE WITH ALL APPLICABLE STATE, LOCAL AND FEDERAL REGULATIONS. CONTRACTOR SHALL OBTAIN ALL APPLICABLE CODES AND BECOME FAMILIAR WITH STATE, LOCAL AND FEDERAL REGULATIONS PRIOR TO BEGINNING CONSTRUCTION.  
16. TO ENSURE THAT OFF-SITE VEHICLE TRACKING OF SEDIMENTS AND THE GENERATION OF DUST IS MINIMIZED, CONTRACTOR SHALL PUT INTO PRACTICE THE METHODS DETAILED IN FLORIDA DEPARTMENT OF TRANSPORTATION INDEX 100 (2010 DESIGN STANDARDS) AND BMPs.

11. METALS: METALS FROM REINFORCED CONCRETE, REINFORCED MASONRY, STRUCTURAL STEEL MEMBERS, FLASHING AND SHEET METAL, CONDUT PIPE, SOUND, PIPING AND WIRING SHALL BE SEPARATED BY TYPE.  
12. STRUCTURAL STEEL: STAKE MEMBERS ACCORDING TO THEIR SIZE, TYPE AND LENGTH.  
13. NUTS AND BOLTS: REMOVE BOLTS, NUTS, WASHERS AND OTHER ROUGH HARDWARE.  
14. SITE-CLEARING WASTE SHALL BE RECYCLED BY CHIPPING BRUSH, BRANCHES AND TREES, THEN HAUL TO WOOD RECYCLING CENTER.  
**DISPOSAL OF WASTE:**  
1. GENERAL: EXCEPT FOR ITEMS OR MATERIALS TO BE SALVAGED, RECYCLED OR OTHERWISE REUSED, REMOVE WASTE MATERIALS FROM PROJECT SITE AND LEGALLY DISPOSE OF THEM IN A LANDFILL OR OTHER PERMITTED DISPOSAL FACILITY.  
2. EXCEPT AS OTHERWISE SPECIFIED, DO NOT ALLOW WASTE MATERIALS THAT ARE TO BE DISPOSED OF TO ACCUMULATE ON-SITE.  
3. REMOVE AND TRANSPORT DEBRIS IN A MANNER THAT SHALL PREVENT SPILLAGE ON ADJACENT SURFACES AND AREAS.  
4. BURNING: DO NOT BURN WASTE MATERIALS.  
5. DISPOSAL: TRANSPORT WASTE MATERIALS OFF THE OWNER'S PROPERTY AND LEGALLY DISPOSE OF THEM.

**DEMOLITION SAFETY:**  
1. ALL DEMOLITION SHALL BE DONE IN A SAFE MANNER, SPECIFICALLY, THE RULES AND REGULATIONS OF THE OCCUPATIONAL SAFETY AND HEALTH ADMINISTRATION (OSHA), THE FLORIDA DEPARTMENT OF TRANSPORTATION (FDOT) AND THE MANUAL OF UNIFORM TRAFFIC CONTROL DEVICES (MUTCD) SHALL BE STRICTLY OBSERVED.  
2. PROVIDE ADEQUATE PROTECTION FOR PERSONS AND PROPERTY AT ALL TIMES. EXECUTE THE WORK IN A MANNER TO AVOID HAZARDS TO PERSONS AND PROPERTY AND PREVENT INTERFERENCE WITH THE USE OF AND ACCESS TO ADJACENT BUILDINGS, STREETS AND SIDEWALKS SHALL NOT BE UNNECESSARILY BLOCKED BY DEBRIS AND EQUIPMENT.  
3. BUILDING MATERIALS TO BE REMOVED SHALL BE TESTED FOR ASBESTOS AND LEAD PAINT.  
4. IF PETROLEUM PRODUCTS ARE FOUND WHILE DEMOLISHING, DISPOSE OF PETROLEUM WASTE IN ACCORDANCE WITH ALL LOCAL, STATE AND FEDERAL REGULATIONS.  
**PAVEMENT DEMOLITION:**  
1. WHERE EXISTING PAVEMENT IS TO BE REMOVED, SAW-CUT THE SURFACING LEAVING A UNIFORM AND STRAIGHT EDGE WITH MINIMUM DISTANCE TO THE REMAINING ADJACENT SURFACING. IF DEMOLITION RESULTS IN RAVELING OF SAW CUT SURFACE, RE-CUT BACK FROM THE RAVELED EDGE PRIOR TO RESTORATION.  
2. WHERE EXISTING PAVEMENT, CURB, CURB AND GUTTER, SIDEWALK, DRIVEWAY, OR VALLEY GUTTER IS REMOVED FOR INLETS, MANHOLES, APPURTENANCES, FACILITIES OR STRUCTURES, SAND PAVEMENT, ETC. SHALL BE REPLACED WITH NEW PAVEMENT, ETC. CONTRACTOR SHALL PROVIDE ALL NECESSARY LABOR, MATERIALS, EQUIPMENT, TOOLS, SUPPLIES, AND OTHER EQUIPMENT AS REQUIRED.  
3. CONTRACTOR MAY LIMIT SAW-CUT AND PAVEMENT REMOVAL TO ONLY THOSE AREAS WHERE IT IS REQUIRED AS SHOWN ON THE DRAWINGS. HOWEVER, IF ANY DAMAGE IS INCURRED ON ANY OF THE SURROUNDING PAVEMENT, SIDEWALK, BUILDINGS, UTILITIES, ETC., THEN THE CONTRACTOR SHALL BE RESPONSIBLE FOR ITS REMOVAL AND REPLACEMENT, REPLACEMENT PAVEMENT, SIDEWALK, ETC., SHALL BE NEW.

17. DUST GENERATED FROM CONSTRUCTION SHALL BE MINIMIZED BY DAILY WATERING OF THE SITE.  
18. AT ANY TIME DURING CONSTRUCTION THAT THE SILT FENCING IS DISTURBED, THE SILT FENCING SHALL BE RESTORED TO ITS ORIGINAL STATE WITHIN 24 HOURS. AT NO TIME DURING CONSTRUCTION SHALL WORK BE PERFORMED WITHOUT THE INTEGRITY OF THE SILT FENCING SECURED.  
19. A QUALIFIED INSPECTOR, PROVIDED BY THE CONTRACTOR, SHALL INSPECT ALL POINTS OF DISCHARGE INTO NEARBY SURFACE WATER. THE INSPECTOR SHALL OCCUR AT LEAST ONCE EVERY SEVEN CALENDAR DAYS AND WITHIN 24 HOURS OF THE END OF A STORM THAT IS 0.5 INCHES OR GREATER. INSPECTION INCLUDES THE WRITTEN RECORDING OF THE CONDITION OF ALL DISCHARGE POINTS, INTEGRITY OF SILT FENCING, DAILY DUST CONTROL MEASURES, VEHICULAR TRAFFIC AND CONSTRUCTION MATERIAL STORAGE AND DISPOSAL. WRITTEN RECORD OF ALL INSPECTIONS SHALL BE STORED BY THE CONTRACTOR.  
20. THE INSPECTION REPORT SHALL INCLUDE, BUT IS NOT LIMITED TO, THE FOLLOWING INFORMATION: NAME AND QUALIFICATION OF PERSONNEL MAKING THE INSPECTION, DATE OF INSPECTION, RAINFALL DATE, MAJOR OBSERVATIONS RELATIVE TO THE SWPPP, ACTIONS TAKEN BY CONTRACTOR AND ANY INCIDENT OF NONCOMPLIANCE WITH PERMIT. WHERE AN INSPECTION DOES NOT IDENTIFY ANY INCIDENT OF NONCOMPLIANCE, THE REPORT SHALL CONTAIN A CERTIFICATION THAT THE FACILITY IS IN COMPLIANCE WITH THE SWPPP AND THE PERMIT.  
21. THE CONTRACTOR SHALL RETAIN A COPY OF THE SWPPP AND ALL REPORTS, RECORDS AND DOCUMENTATION REQUIRED BY THE PERMIT AT THE CONSTRUCTION SITE, OR AN APPROPRIATE ALTERNATIVE LOCATION AS SPECIFIED IN THE NOTICE OF INTENT, FROM THE DATE OF PROJECT INITIATION TO THE DATE OF FINAL STABILIZATION.  
22. THE CONTRACTOR SHALL RETAIN THE SWPPP, NOI AND ALL RECORDS ASSOCIATED THEREWITH FOR A PERIOD OF AT LEAST THREE (3) YEARS FROM THE DATE THAT THE SITE IS FINALLY STABILIZED.  
23. SEE LANDSCAPE PLANS FOR TREE REMOVAL AND LANDSCAPE DEMOLITION.  
24. CONTRACTOR SHALL COORDINATE THROUGH CITY'S CONSTRUCTION DIVISION AND CITY'S PARKS DEPARTMENT ON HOW TO STOCK AND RE-USE EXCAVATED SOIL FROM SITE (AS APPLICABLE TO THE PROJECT).

**MINIMUM DENSITY REQUIREMENTS**

LOCATION	MATERIAL	MINIMUM DENSITY (% OF MAX)	TESTING FREQUENCY
ROADS (INCLUDES SIDEWALKS, ASPHALT PATHS)	BACKFILL	98%	VERTICAL DISTRIBUTION: ONE TEST AT EVERY LIFT STARTING AT TOP OF FIRST LIFT AND PROCEEDING UPWARD TO GRADE.
	SUBGRADE	98%	HORIZONTAL DISTRIBUTION: TESTS SHALL BE PERFORMED AT RANDOMLY SELECTED LOCATIONS WITH EACH 500 FOOT INTERVAL (MAXIMUM) ALONG THE LENGTH OF ROADWAY, SIDEWALK OR PATHWAY.
MANHOLES AND VAULTS (IN ROADS AND PARKING AREAS)	BACKFILL AROUND STRUCTURES	98%	VERTICAL DISTRIBUTION: ONE TEST AT EVERY LIFT STARTING AT THE BOTTOM OF THE STRUCTURE AND PROCEEDING UPWARD TO GRADE.
	CRUSHED STONE BENEATH STRUCTURES	NOTE 6	
PARKING AREAS	BACKFILL	98%	VERTICAL DISTRIBUTION: ONE TEST AT EVERY LIFT STARTING AT TOP OF FIRST LIFT AND PROCEEDING UPWARD TO GRADE.
	SUBGRADE	98%	HORIZONTAL DISTRIBUTION: TESTS SHALL BE PERFORMED EVERY 6,000 SQUARE FEET OF PARKING AREA.
UTILITY TRENCH BACKFILL	BEDDING AND BACKFILL	98%	VERTICAL DISTRIBUTION: ONE TEST AT EVERY LIFT STARTING AT THE SPRING LINE AND PROCEEDING UPWARD TO GRADE.
	ASPHALT	98%	HORIZONTAL DISTRIBUTION: TESTS SHALL BE PERFORMED AT RANDOMLY SELECTED LOCATIONS WITHIN EACH 500 FOOT INTERVAL (MAXIMUM) ALONG THE LENGTH OF A PIPE INSTALLATION, AND BETWEEN EACH SET OF STRUCTURES SEPARATED BY LESS THAN 500 FEET.
ROADS AND PARKING	ASPHALT	98%	ASPHALT TESTING MAY BE DONE BY CORE SAMPLING OR CAR LAUGE DENSITY TESTING. ASPHALT TESTING SHALL BE AT MAXIMUM 300 LINEAR FEET ALONG ROADWAYS AND 6,000 SQUARE FOOT INTERVALS FOR PARKING AREAS.

**NOTES:**  
1. THE DENSITY REQUIREMENTS PRESENTED ASSUME DRY TRENCH CONDITIONS.  
2. UNLESS INDICATED OTHERWISE IN THE SPECIFICATIONS, TESTING SHALL COMPLY WITH THE REQUIREMENTS PRESENTED IN THIS TABLE.  
3. LIFT THICKNESSES FOR BASE, SUBGRADE AND BACKFILL SHALL BE AS INDICATED ON THE DETAILS OR DESCRIBED IN THE SPECIFICATIONS.  
4. MAXIMUM DENSITY SHALL BE DETERMINED BY ASTM D 1557 OR ASTM D 1557 (MODIFIED) PROCEDURES.  
5. FIELD DENSITY TESTS SHALL BE PERFORMED IN ACCORDANCE WITH ASTM D 1557 OR D 1557.  
6. THE AGRAGATE SHALL BE COMPACTED TO A DEGREE ACCEPTABLE TO THE ENGINEER BY USE OF A VIBRATORY COMPACTOR AND/OR CRAWLER TRACTOR.

DESIGN CRITERIA PACKAGE  
PROJECT # 12412  
PUMP STATION A-16 UPGRADE  
WASTEWATER DESIGN CRITERIA PACKAGE  
DEMOLITION NOTES

PREPARED BY:  
**Kimley-Horn**  
© 2021 KIMLEY-HORN AND ASSOCIATES, INC.  
8201 PETERS ROAD, SUITE 2200, PLANTATION, FL 33324  
PHONE: 954-535-5100 FAX: 954-739-2247  
WWW.KIMLEY-HORN.COM REGISTRY No. 696



CITY OF FORT LAUDERDALE  
PUBLIC WORKS DEPARTMENT  
ENGINEERING & ARCHITECTURE  
100 North Andrews Avenue, Fort Lauderdale, Florida 33301

DESIGN CRITERIA PACKAGE  
SHEET NO. 4 OF 31  
CAD FILE: 12412-MULTI-DEMO  
DRAWING FILE NO. 4-142-31

ENGINEER: GARY R. RAY, P.E.  
REG. NO.: 46682  
DATE: 9/29/2021

DESIGNED BY: AL CR  
CHECKED BY: CR  
FIELD BOOK: (954) 636-9100

Plotted By: Moring, Marissa Sheet Set: PUMP STATION A-16 DESIGN CRITERIA PACKAGE Layout: 5 KEY MAP September 28, 2021 04:13:13pm K:\V\civil\043 jobs\043184401 cnao 12464-416 ps a-16 rev location\CAD\plansheets\12412-KEY-MAP.dwg  
 This document, together with the concepts and designs presented herein, as an instrument of service, is intended only for the specific purpose and client for which it was prepared. Reuse of any information or adaptation by Kimley-Horn and Associates, Inc. shall be without liability to Kimley-Horn and Associates, Inc.

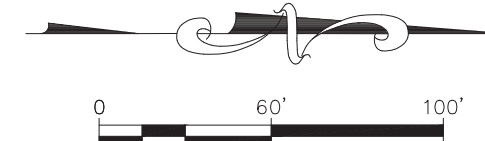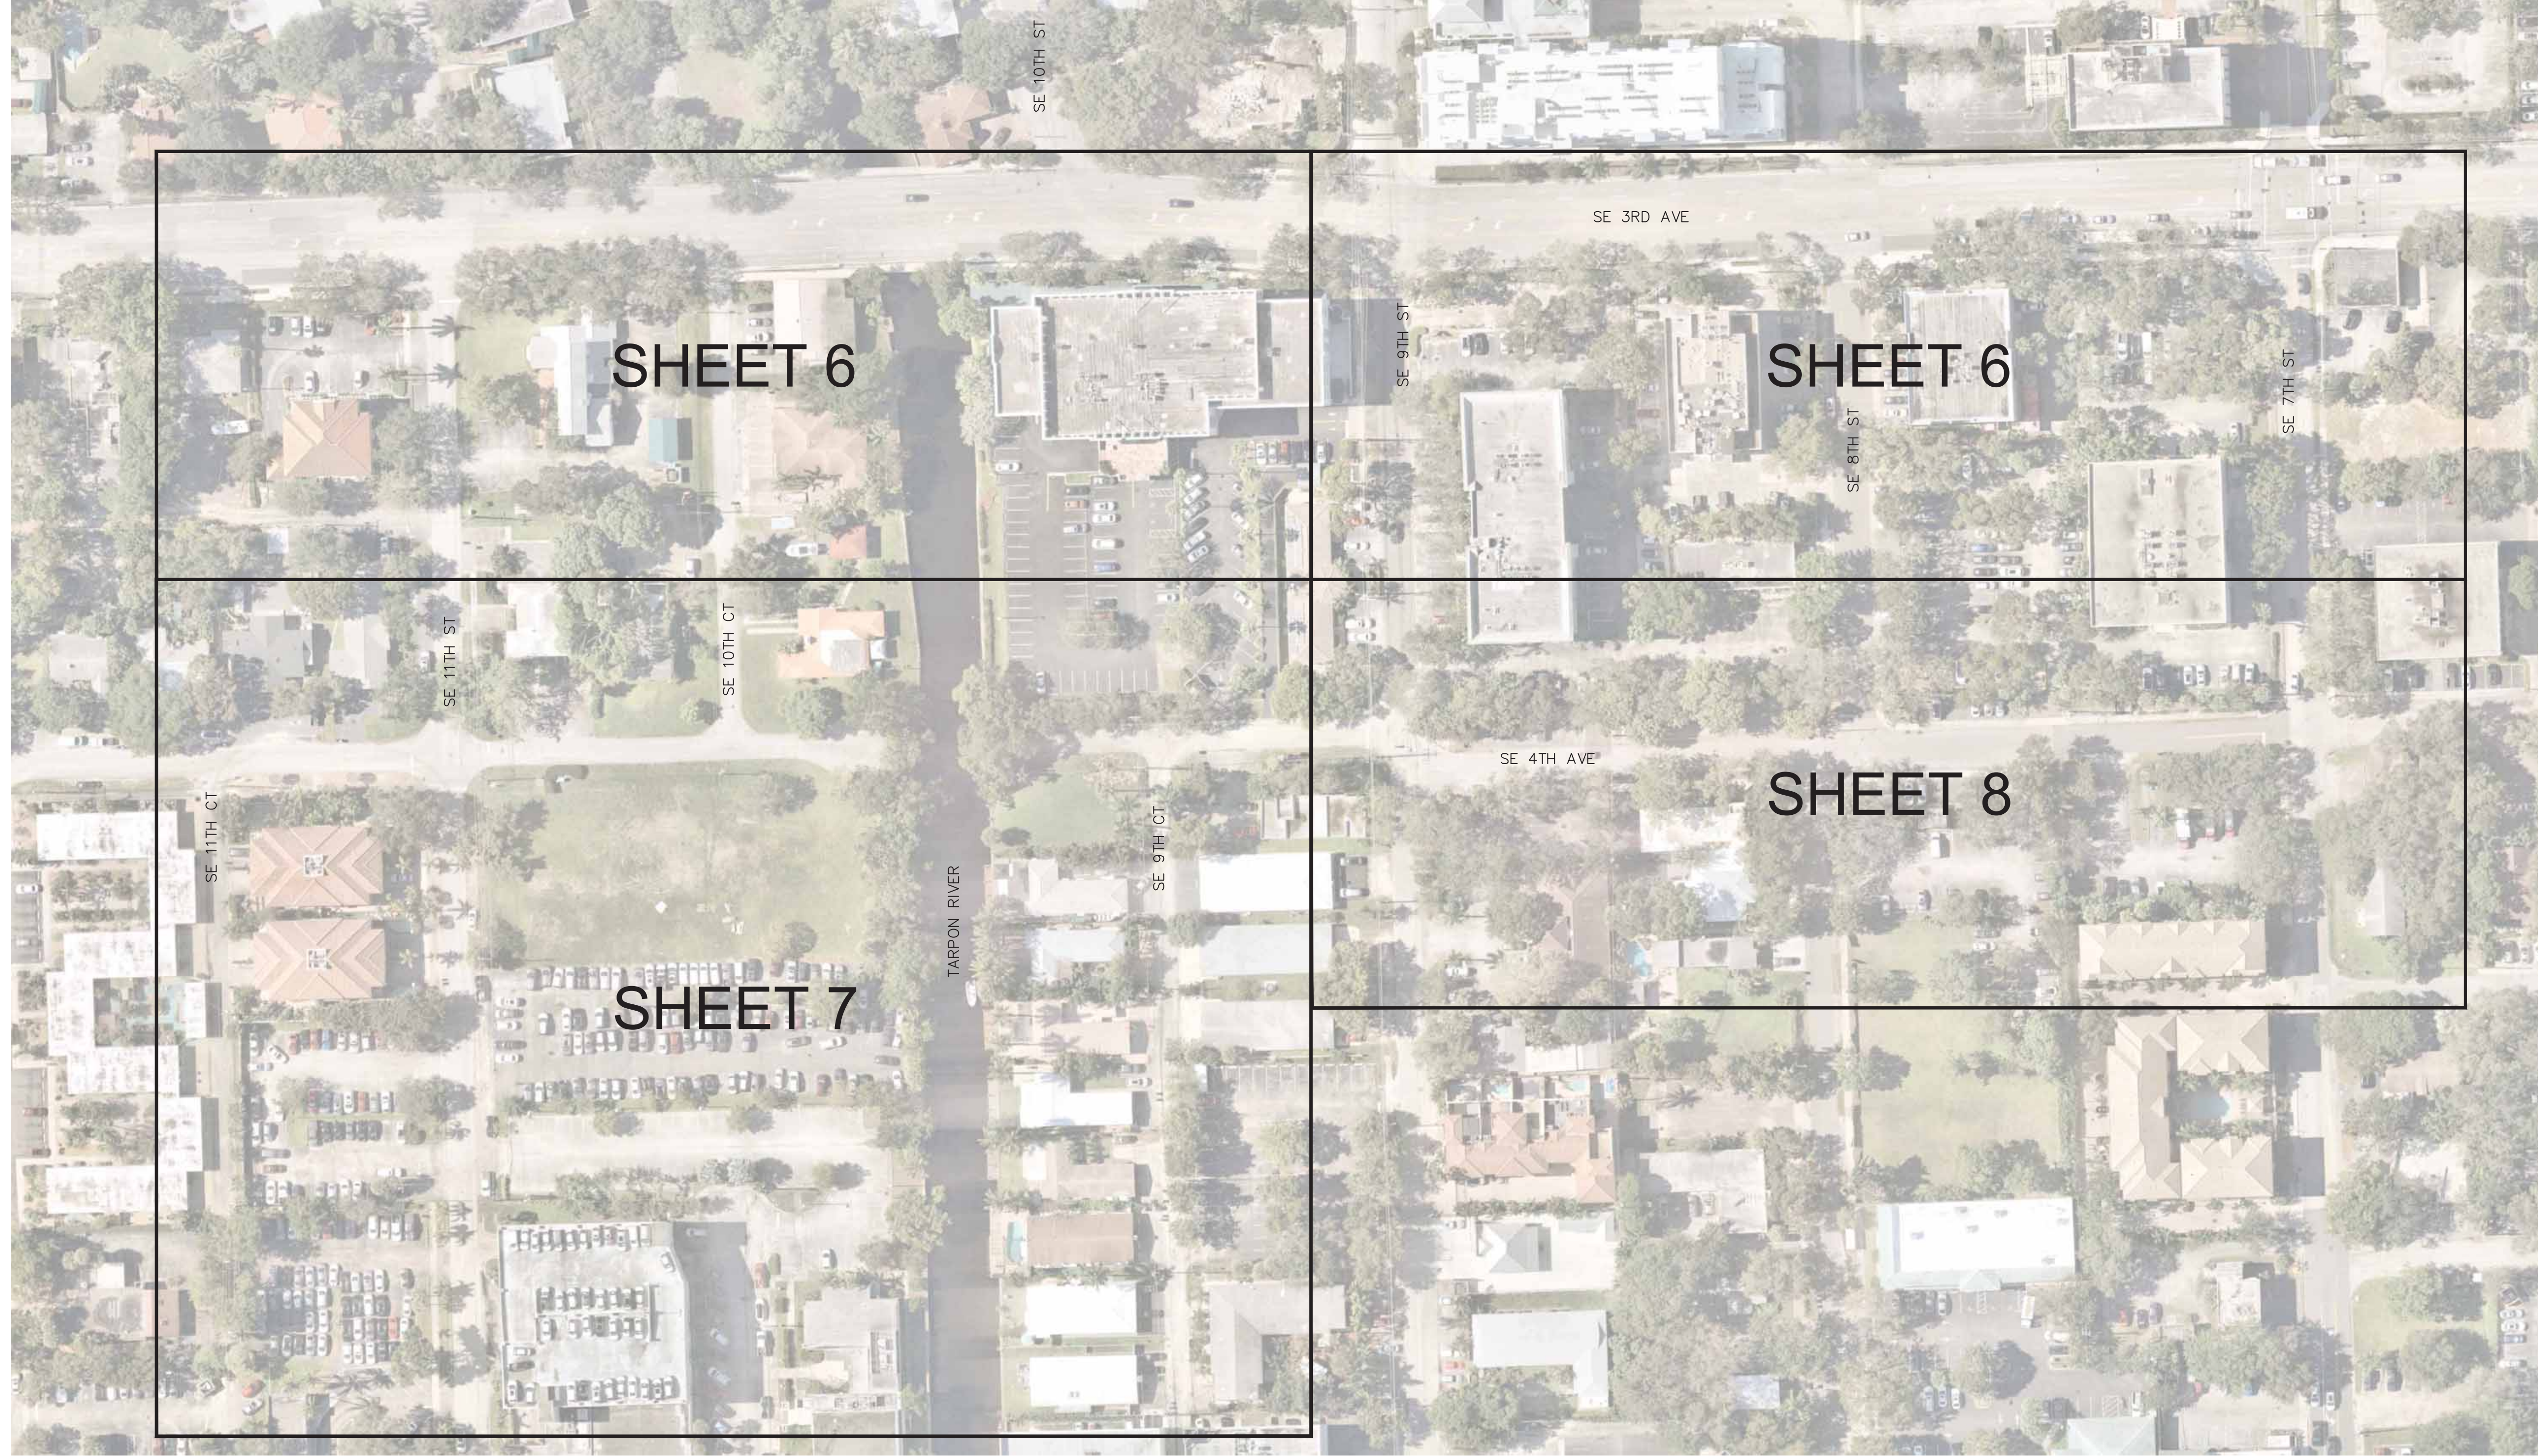

PREPARED BY:  
**Kimley»Horn**  
 © 2021 KIMLEY-HORN AND ASSOCIATES, INC.  
 8201 PETERS ROAD, SUITE 2200, PLANTATION, FL 33324  
 PHONE: 954-535-5100 FAX: 954-739-2247  
 WWW.KIMLEY-HORN.COM REGISTRY No. 696


**DESIGN CRITERIA PACKAGE**

**PROJECT # 12412  
 PUMP STATION A-16 UPGRADE  
 WASTEWATER DESIGN CRITERIA PACKAGE  
 KEY MAP**

SHEET NO.	OF
5	31
CAD FILE: 12412-KEY-MAP	
DRAWING FILE NO. 4-142-31	

REVISIONS		DESCRIPTION
NO.	DATE	BY (CHKD)

**CITY OF FORT LAUDERDALE**  
 PUBLIC WORKS DEPARTMENT  
 ENGINEERING & ARCHITECTURE



100 North Andrews Avenue, Fort Lauderdale, Florida 33301

DESIGNED BY:	GR	AS NOTED
CHECKED BY:	GR	
DATE:	MAR 2021	
SCALE:	AS NOTED	
FIELD BOOK:		

ENGINEER:  
 GARY E. RATAV, P.E.  
 REG. NO: 46682  
 DATE: 9/28/2021  
 TEL: (954) 535-5100  
 FAX:













Plotted By: Marissa, Marissa - Sheet Set: PUMP STATION A-16 DESIGN CRITERIA PACKAGE Layout: DETAIL-9 September 28, 2021 04:13:55pm K:\N\civil\043 jba\043184401.cmn 12464-416 ps a-16 rev location\CAD\plant\sheet\12412-MULTI-DET.dwg  
 This document, together with the concepts and designs presented herein, is an instrument of service, and its use is limited to the specific project and client for which it was prepared. Reuse of any part of this document without written authorization and adaptation by Kimley-Horn and Associates, Inc. shall be without liability to Kimley-Horn and Associates, Inc.

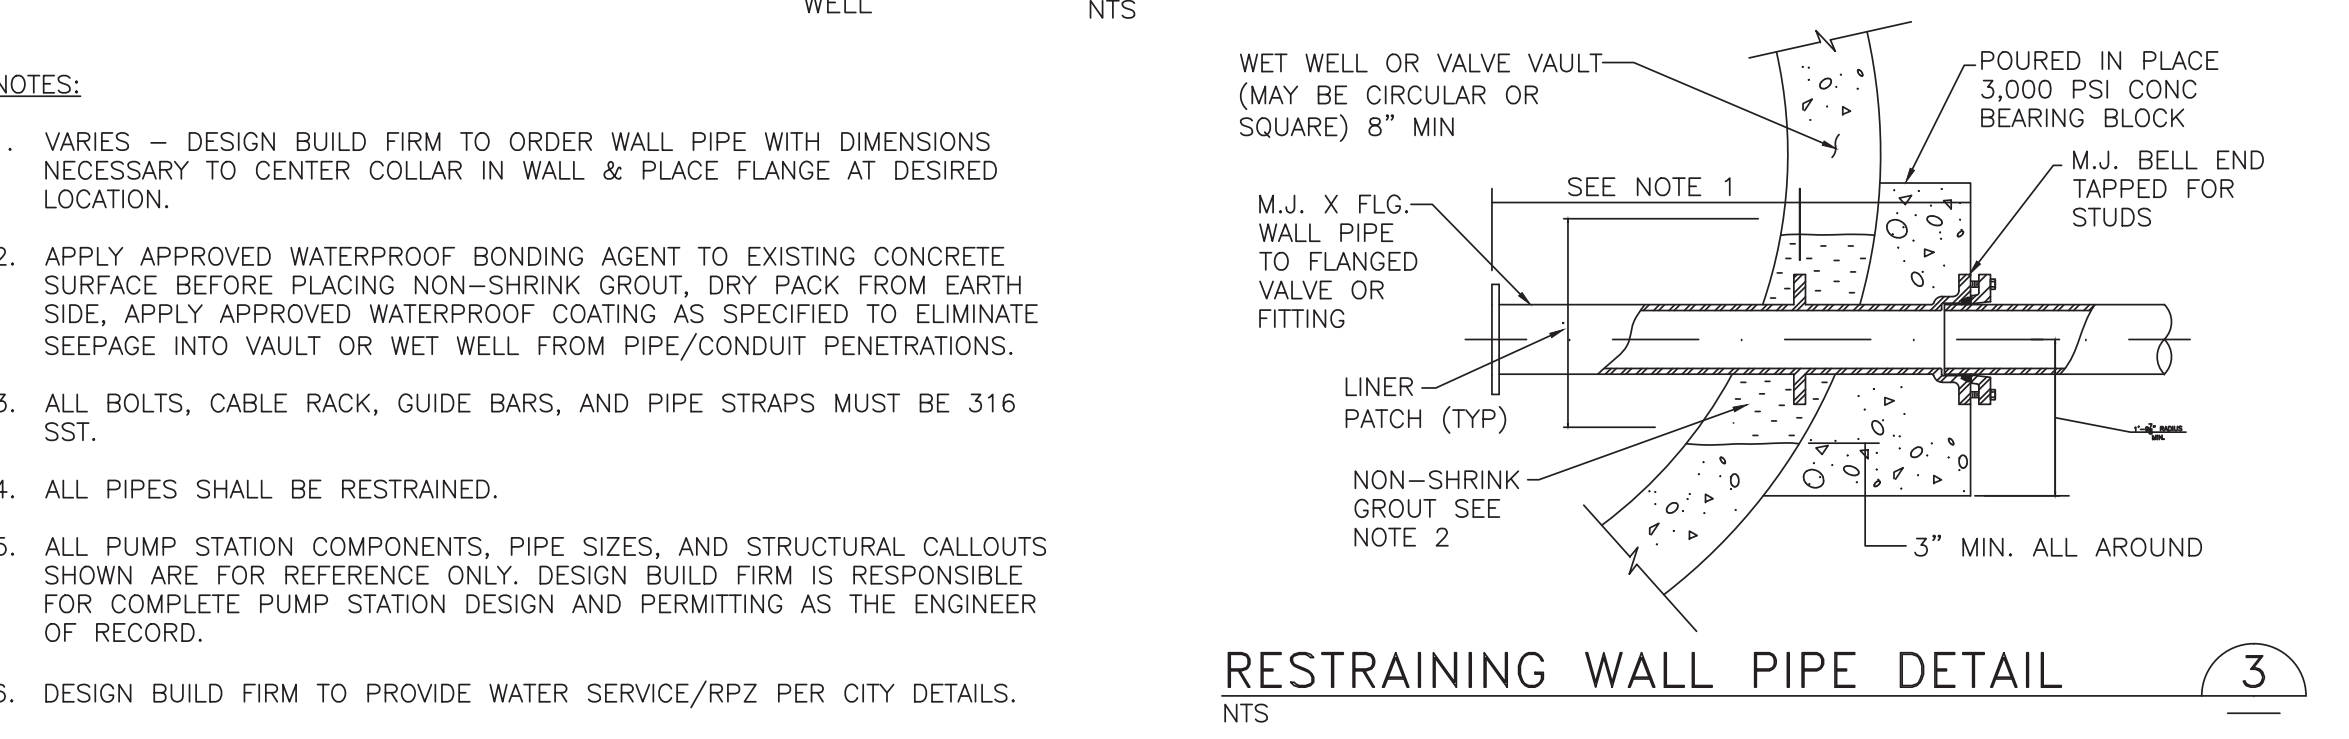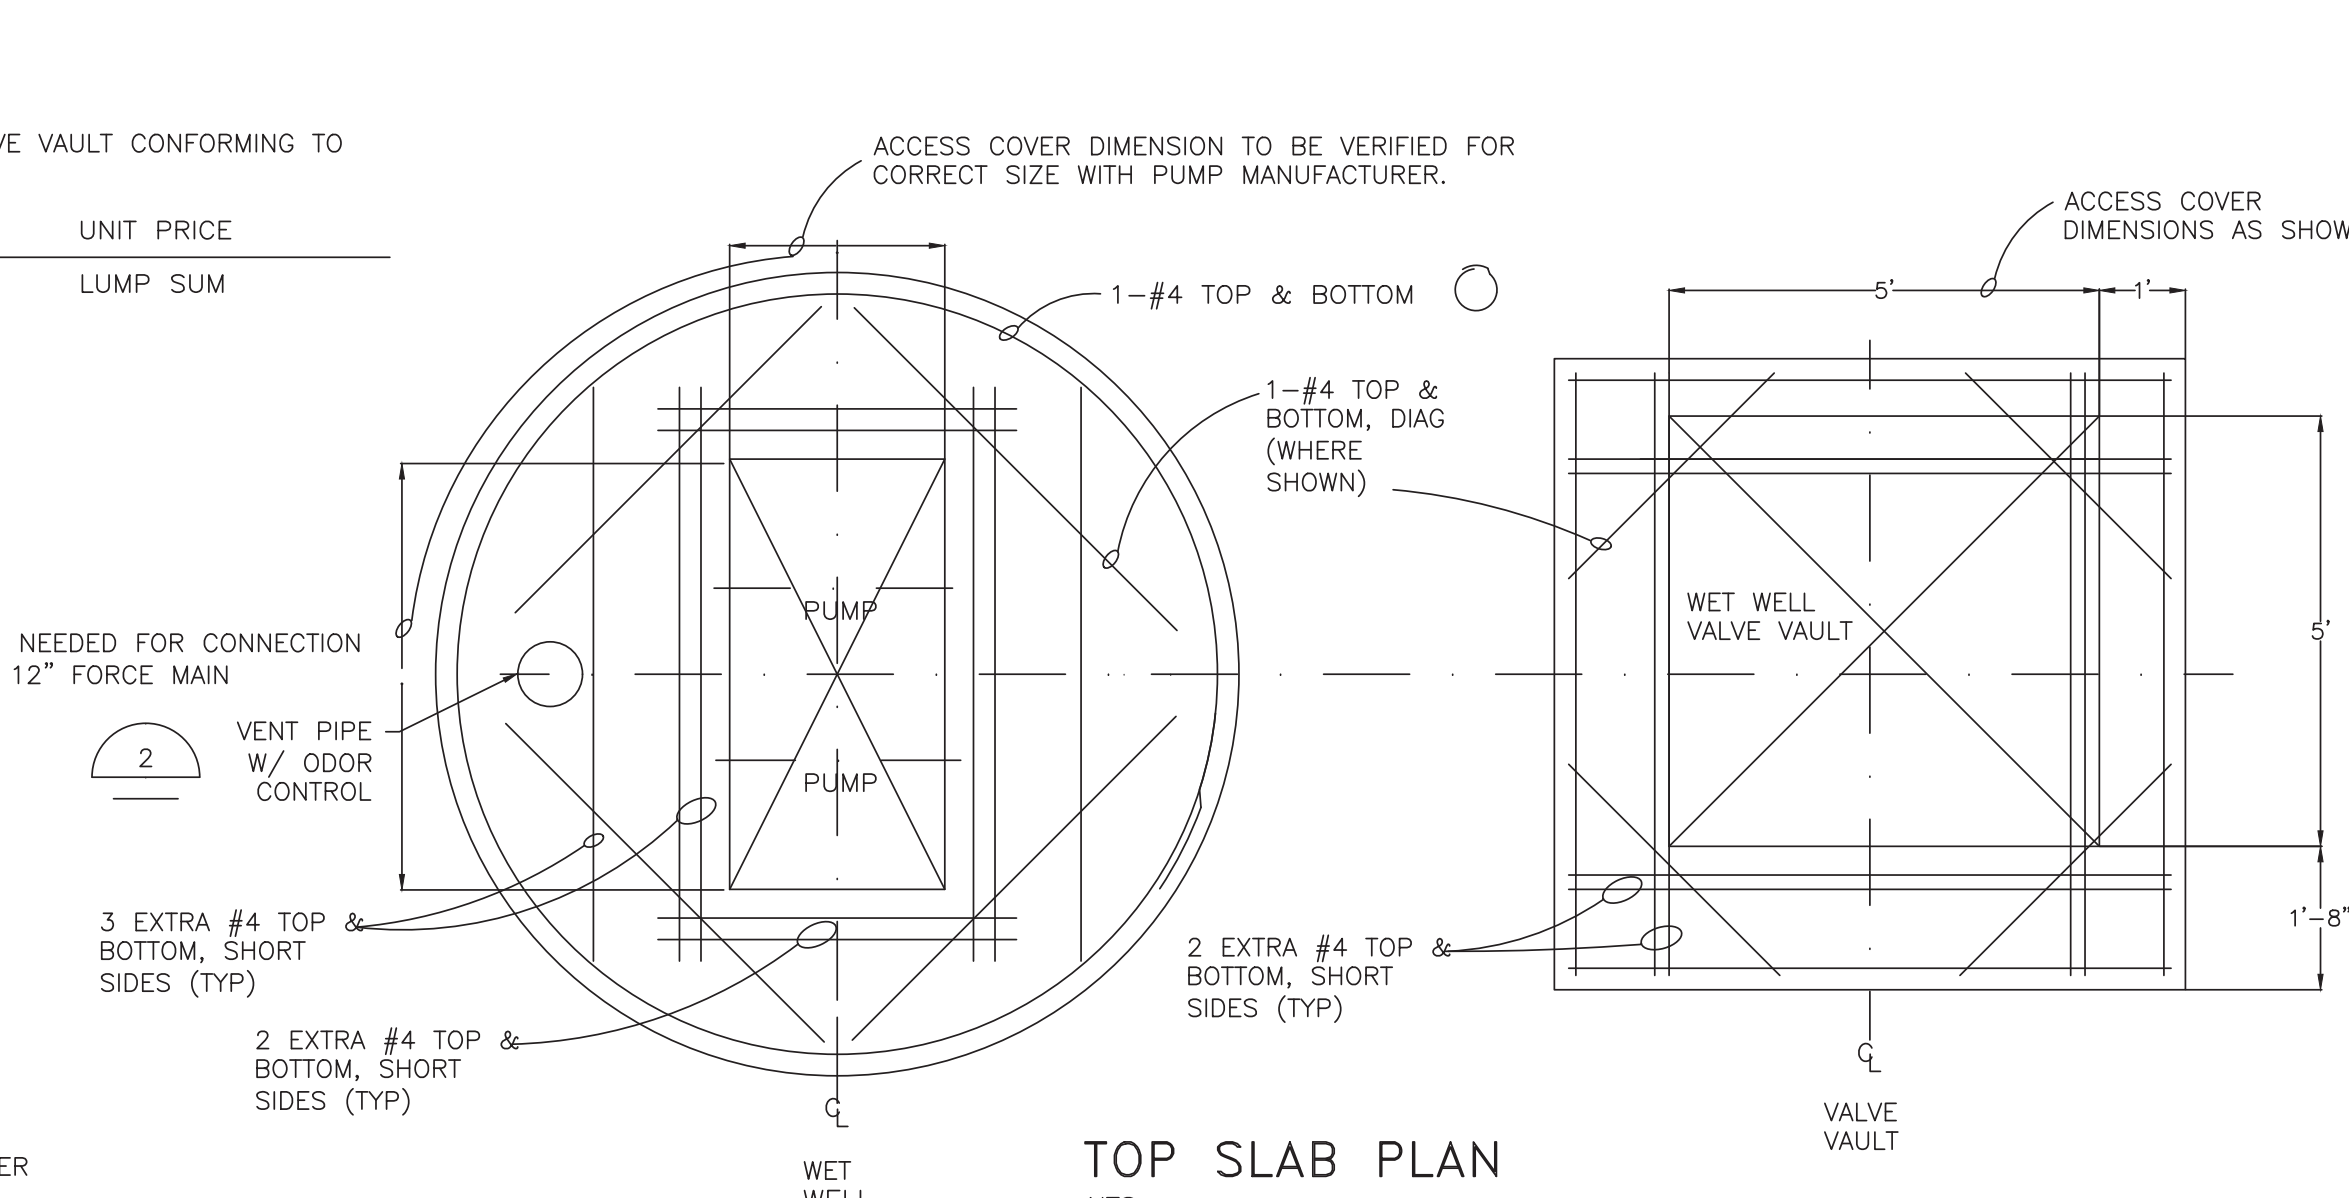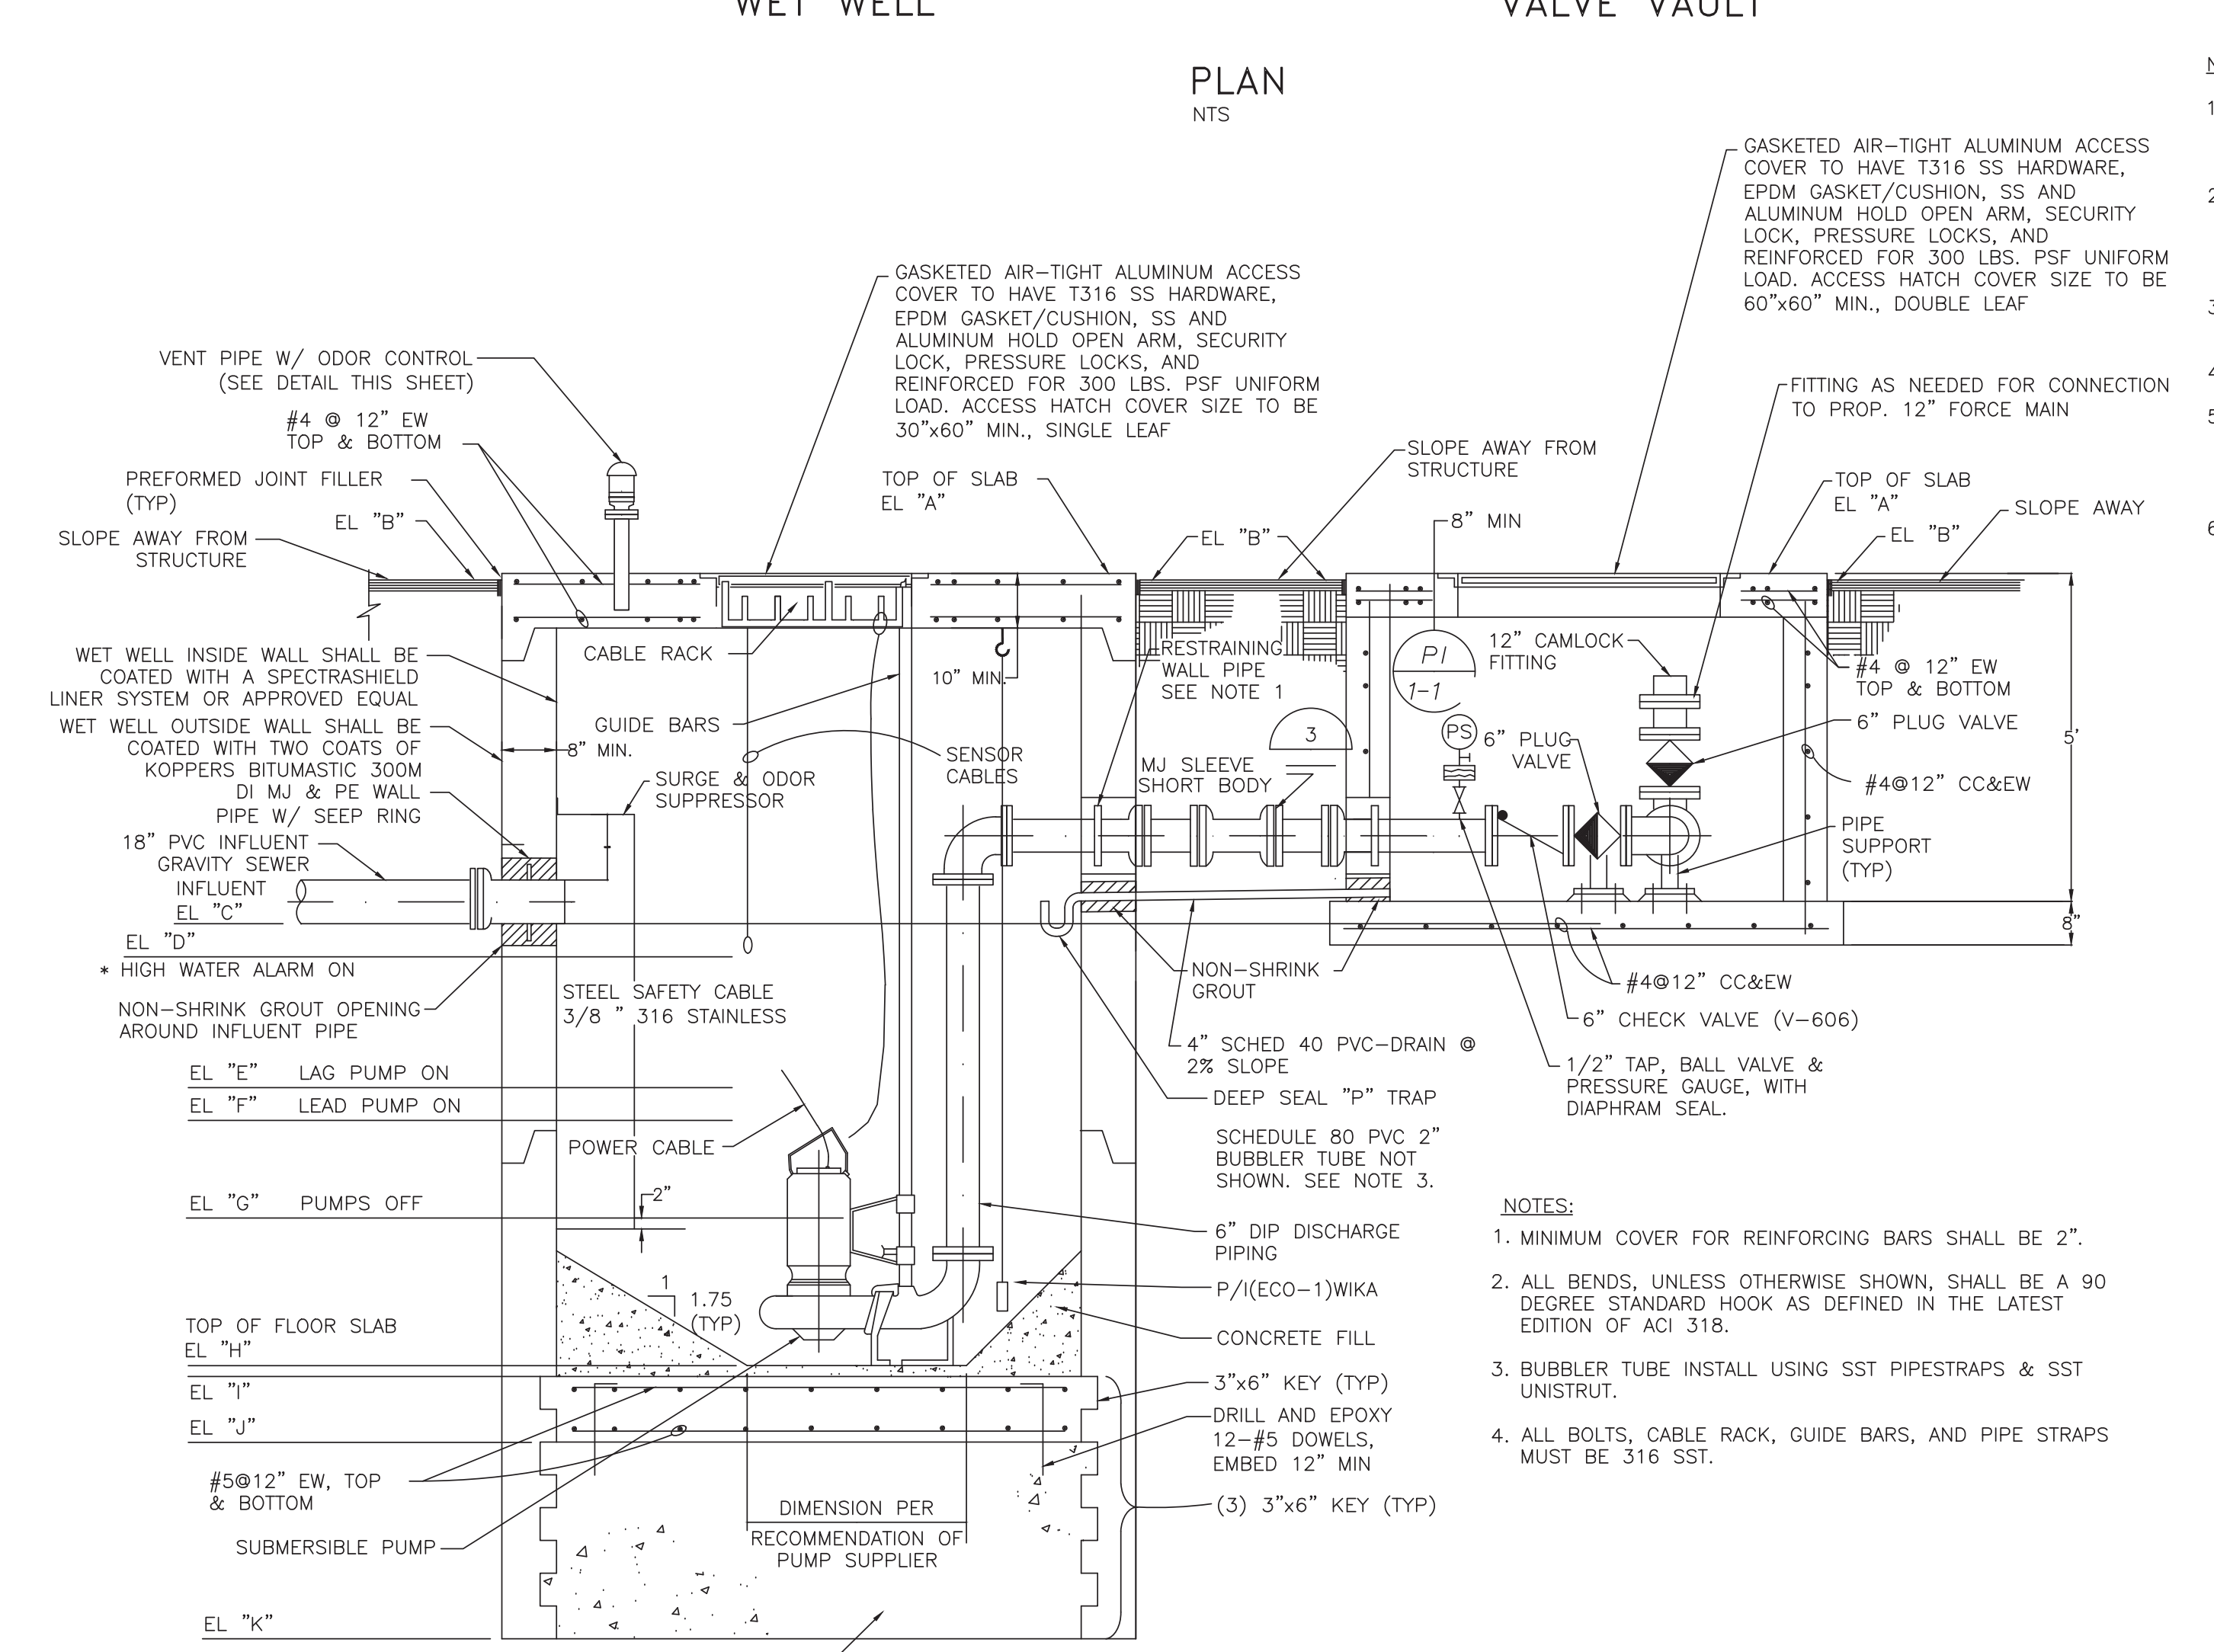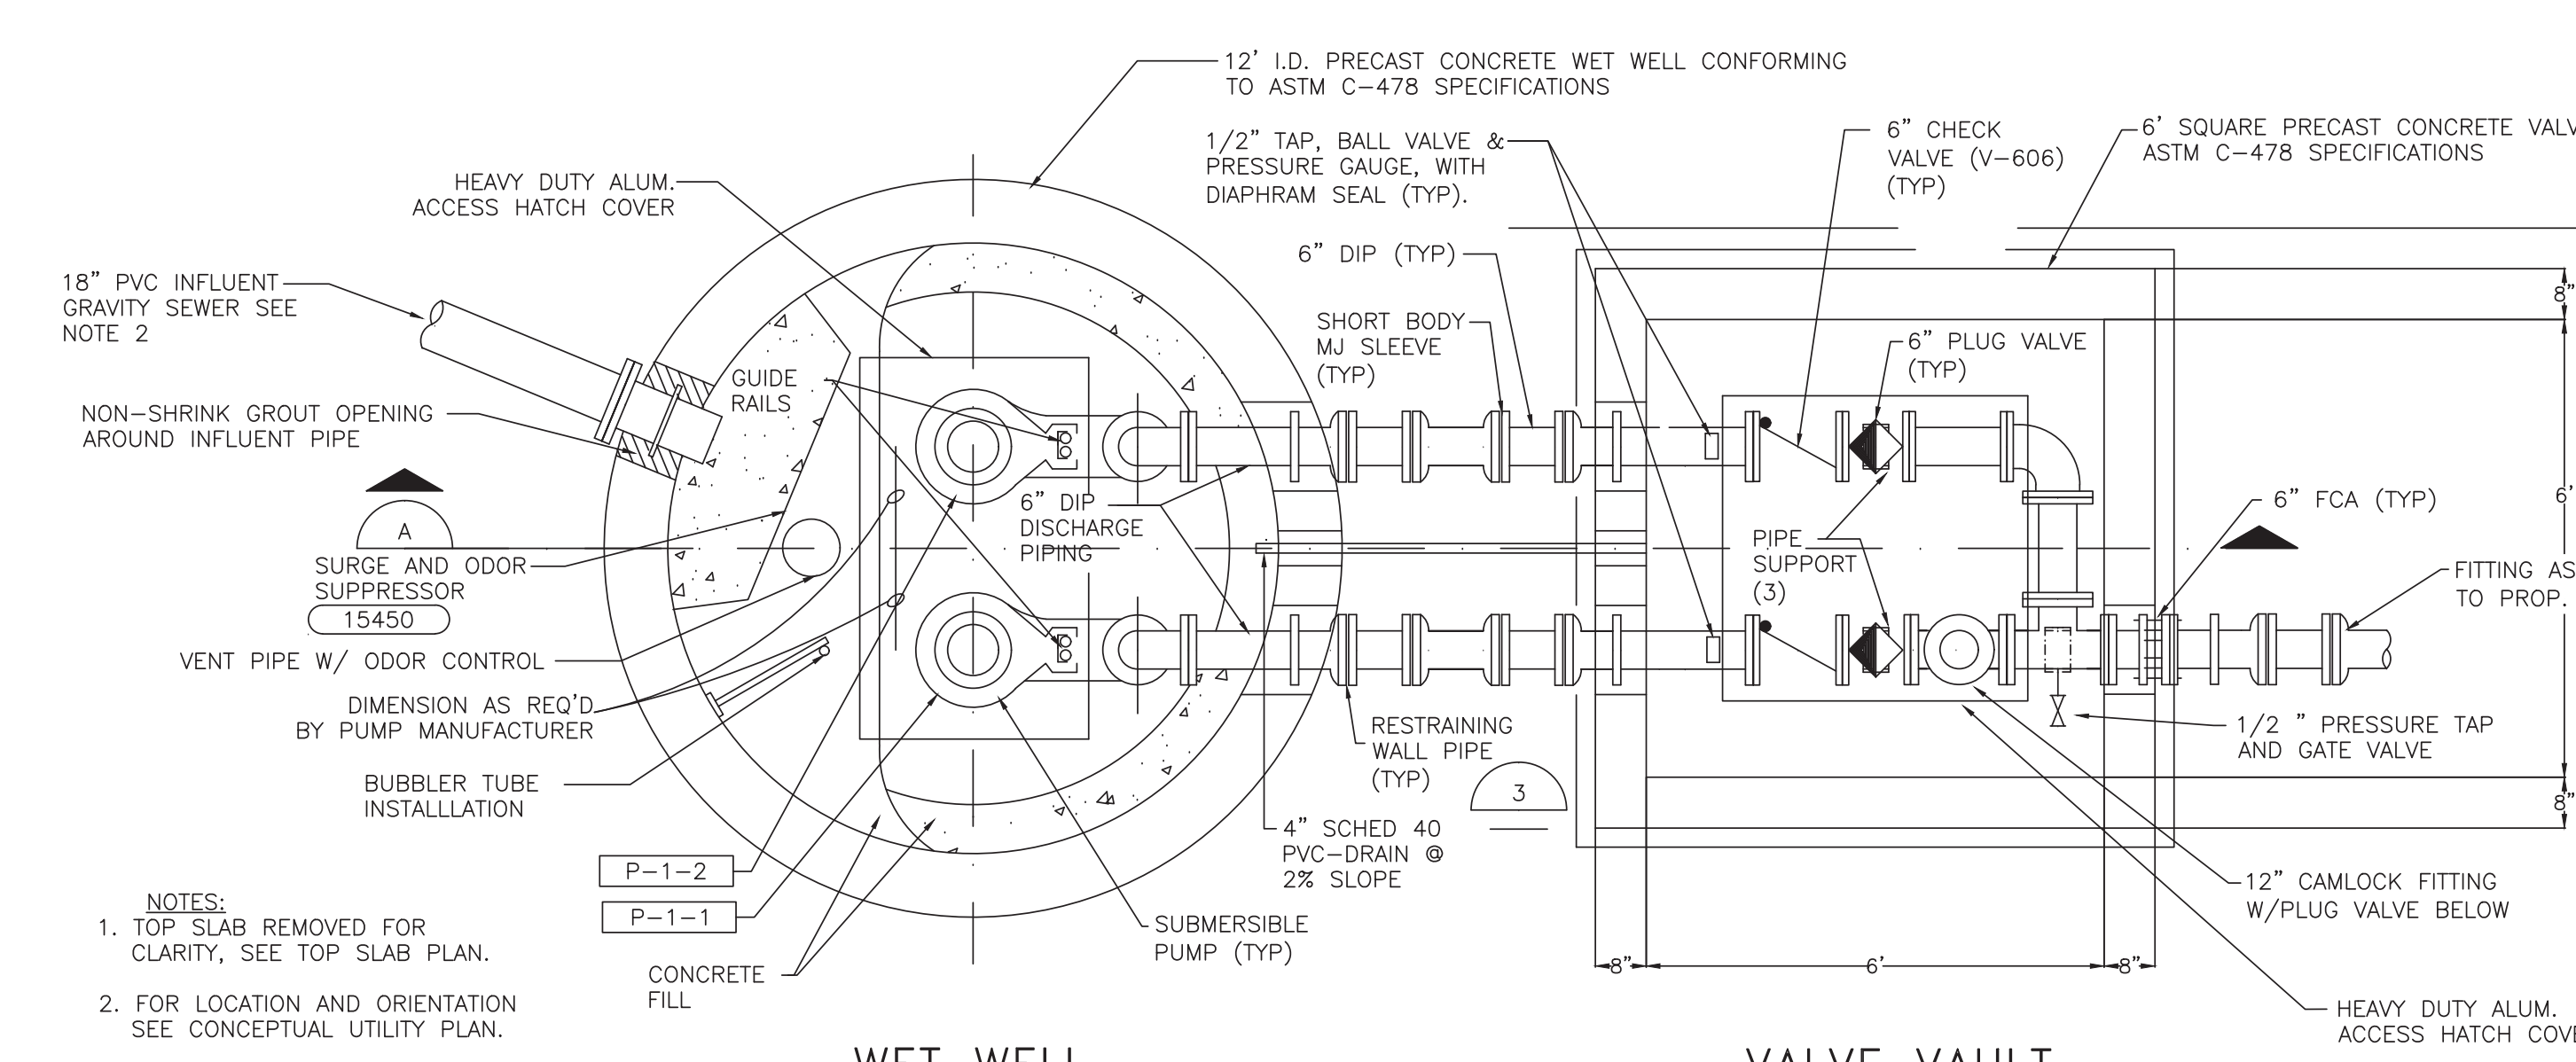

SCHEDULE OF ELEVATIONS (FEET MSL)

LETTER	LEVEL DESCRIPTION	A-16
A	TOP OF PUMP STATION & VAULT SLABS	4.20
B	FINISH GRADE ADJACENT SLAB	3.70
C	INFLUENT GRAVITY SEWER INVERT	(-)8.61
D	HIGH WATER ALARM	(-)9.60
E	LAG PUMP ON	(-)11.60
F	LEAD PUMP ON	(-)12.60
G	PUMPS OFF	(-)14.60
H	TOP OF FLOOR SLAB	(-)16.60
I	TOP OF KEY	(-)16.90
J	BOTTOM OF KEY	(-)17.90
K	BOTTOM OF TREMIE PLUG	(-)24.50
	INSIDE DIAMETER PUMP STATION	12'
	FORCE MAIN PIPING (D.I.P.)	12"
	PUMP OPERATION REQUIREMENTS	750 gpm @ 107' 45 HP

NOTES:  
 1. ELEVATIONS INDICATED HEREON ARE IN FEET AND DECIMALS, RELATIVE TO THE NORTH AMERICAN VERTICAL DATUM OF 1988 (NAVD 1988), AND ARE FOR REFERENCE ONLY. PUMP STATION/WETWELL DESIGN IS THE RESPONSIBILITY OF THE DESIGN BUILD FIRM. THE PRESENCE OF GROUNDWATER SHOULD BE ANTICIPATED. DESIGN BUILD FIRM'S BID SHALL INCLUDE CONSIDERATION FOR ADDRESSING THIS ISSUE AND OBTAINING ALL NECESSARY PERMITS.  
 2. FLOOD ZONE: AH  
 3. BASE FLOOD ELEVATION (BFE): 6.0' NAVD 1988

NOTES:  
 1. TOP SLAB REMOVED FOR CLARITY, SEE TOP SLAB PLAN.  
 2. FOR LOCATION AND ORIENTATION SEE CONCEPTUAL UTILITY PLAN.

NOTES:  
 1. VARIES - DESIGN BUILD FIRM TO ORDER WALL PIPE WITH DIMENSIONS NECESSARY TO CENTER COLLAR IN WALL & PLACE FLANGE AT DESIRED LOCATION.  
 2. APPLY APPROVED WATERPROOF BONDING AGENT TO EXISTING CONCRETE SURFACE BEFORE PLACING NON-SHRINK GROUT, DRY PACK FROM EARTH SIDE, APPLY APPROVED WATERPROOF COATING AS SPECIFIED TO ELIMINATE SEEPAGE INTO VAULT OR WET WELL FROM PIPE/CONDUIT PENETRATIONS.  
 3. ALL BOLTS, CABLE RACK, GUIDE BARS, AND PIPE STRAPS MUST BE 316 SST.  
 4. ALL PIPES SHALL BE RESTRAINED.  
 5. ALL PUMP STATION COMPONENTS, PIPE SIZES, AND STRUCTURAL CALLOUTS SHOWN ARE FOR REFERENCE ONLY. DESIGN BUILD FIRM IS RESPONSIBLE FOR COMPLETE PUMP STATION DESIGN AND PERMITTING AS THE ENGINEER OF RECORD.  
 6. DESIGN BUILD FIRM TO PROVIDE WATER SERVICE/RPZ PER CITY DETAILS.

NOTES:  
 1. MINIMUM COVER FOR REINFORCING BARS SHALL BE 2".  
 2. ALL BENDS, UNLESS OTHERWISE SHOWN, SHALL BE A 90 DEGREE STANDARD HOOK AS DEFINED IN THE LATEST EDITION OF ACI 318.  
 3. BUBBLER TUBE INSTALL USING SST PIPESTRAPS & SST UNISTRUT.  
 4. ALL BOLTS, CABLE RACK, GUIDE BARS, AND PIPE STRAPS MUST BE 316 SST.



\* (ALARM HAS LIGHT, AUDIBLE ALARM, AND DIALER RTU TO CITY. ALARM WILL BE DEACTIVATED BY A MANUAL SWITCH)

ENGINEER:  
 GARY E. RAY, P.E.  
 REG. No: 46682  
 DATE: 9/28/2021

DESIGNED BY:  
 GR AS NOTED

CHECKED BY:  
 GR

CITY OF FORT LAUDERDALE  
 PUBLIC WORKS DEPARTMENT  
 ENGINEERING & ARCHITECTURE

100 North Andrews Avenue, Fort Lauderdale, Florida 33301

REVISIONS

NO.	DATE	BY (CHK)	DESCRIPTION

DESIGN CRITERIA PACKAGE

PROJECT # 12412  
 PUMP STATION A-16 UPGRADE  
 WASTEWATER DESIGN CRITERIA PACKAGE  
 CONCEPTUAL PUMP STATION DETAILS

SHEET NO. 9 OF 31

CAD FILE: 12412-MULTI-DET  
 DRAWING FILE NO. 4-142-31

PREPARED BY:  
**Kimley-Horn**

© 2021 KIMLEY-HORN AND ASSOCIATES, INC.  
 8201 PETERS ROAD, SUITE 2200, PLANTATION, FL 33324  
 PHONE: 954-535-5100 FAX: 954-739-2247  
 WWW.KIMLEY-HORN.COM REGISTRY No. 696





Plotted By: Marissa Street, Set: PUMP STATION A-16 DESIGN CRITERIA PACKAGE, Layout: DET-12 - September 28, 2021 04:14:11pm K:\1\civil\043 jba\043184\01 cna.12464-4-16 ps a-16 rev location\CAD\plansheets\12412-MUL-1-DET1.dwg  
 This document, together with the concepts and designs presented herein, as an instrument of service, is intended only for the specific purpose and client for which it was prepared. Reuse of and improper reliance on this document without written authorization and adaptation by Kimley-Horn and Associates, Inc. shall be without liability to Kimley-Horn and Associates, Inc.

**WATER MAIN SEPARATION IN ACCORDANCE WITH F.A.C. RULE 62-555.314**

OTHER PIPE	HORIZONTAL SEPARATION	CROSSINGS (NOTE 1)	JOINT SPACING AT CROSSINGS (FULL JOINT CENTERED)
STORM SEWER, STORM WATER FORCE MAIN, RECLAIMED WATER (NOTE 2)			NOTE 4 WATER MAIN JOINT (TYP.)
VACUUM SANITARY SEWER			NOTE 4 WATER MAIN JOINT (TYP.)
GRAVITY SANITARY SEWER (NOTE 3) SANITARY SEWER FORCE MAIN, RECLAIMED WATER			NOTE 4 WATER MAIN JOINT (TYP.)
ON-SITE SEWAGE TREATMENT & DISPOSAL SYSTEM	10 FT. MINIMUM		


**NOTES:**

- WATER MAIN SHOULD CROSS ABOVE OTHER PIPE. WHEN WATER MAIN MUST BE BELOW OTHER PIPE, THE MINIMUM SEPARATION IS 12 INCHES.
- RECLAIMED WATER REGULATED UNDER PART III OF CHAPTER 62-610, F.A.C.
- 3 FT. FOR GRAVITY SANITARY SEWER WHERE THE BOTTOM OF THE WATER MAIN IS LAID AT LEAST 6 INCHES ABOVE THE TOP OF THE GRAVITY SANITARY SEWER.
- ONE FULL LENGTH OF WATER MAIN PIPE SHALL BE CENTERED ABOVE OR BELOW THE OTHER PIPE SO THAT THE WATER MAIN JOINTS WILL BE AS FAR AS POSSIBLE FROM THE OTHER PIPELINE. ALTERNATE JOINT LOCATIONS ALLOWED UNDER FAC 62-555.314 WILL ONLY BE ALLOWED BY THE ENGINEER ON A CASE-BY-CASE BASIS.

CITY OF FORT LAUDERDALE  
PUBLIC WORKS DEPARTMENT  
ENGINEERING DETAILS

**WATER MAIN SEPARATION**


WATR 001  
2016/09/01

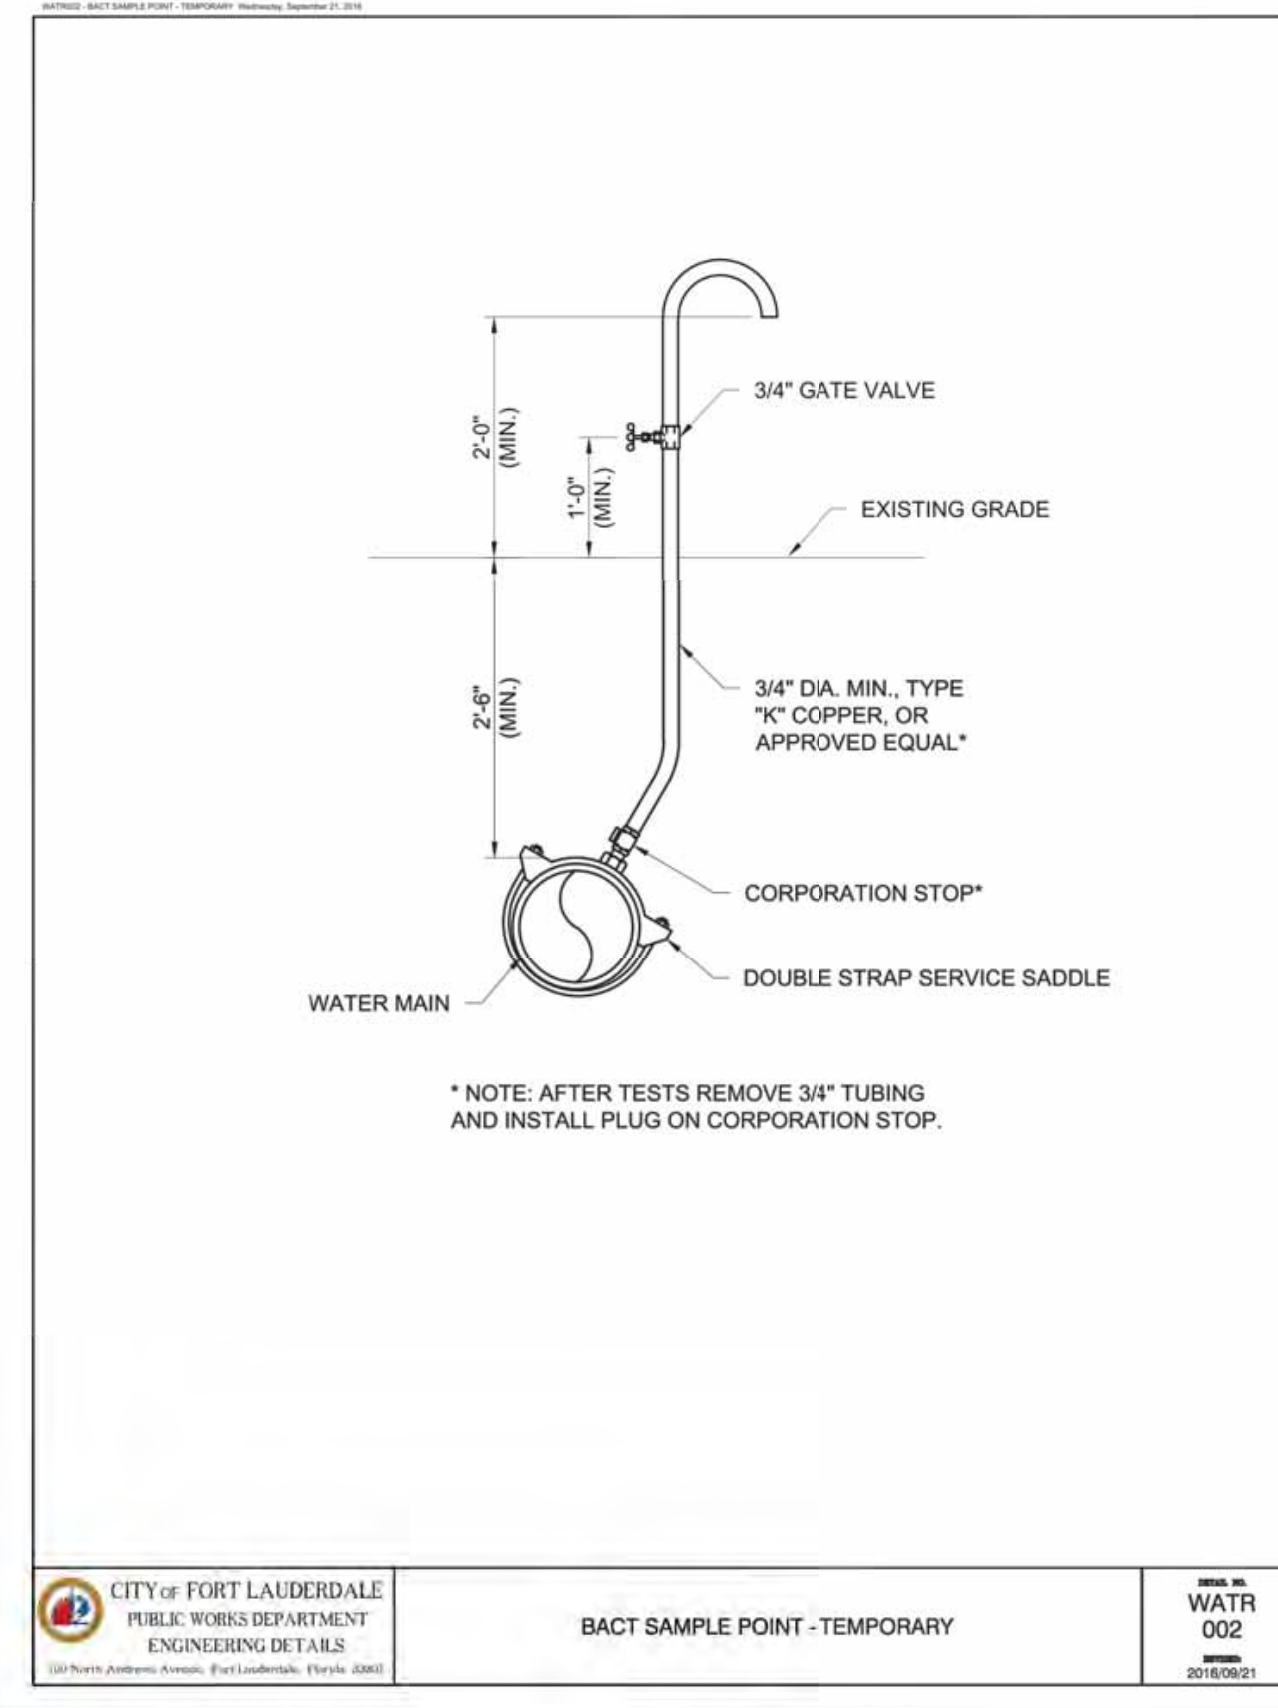

CITY OF FORT LAUDERDALE  
PUBLIC WORKS DEPARTMENT  
ENGINEERING DETAILS

**BACT SAMPLE POINT - TEMPORARY**


WATR 002  
2016/09/01

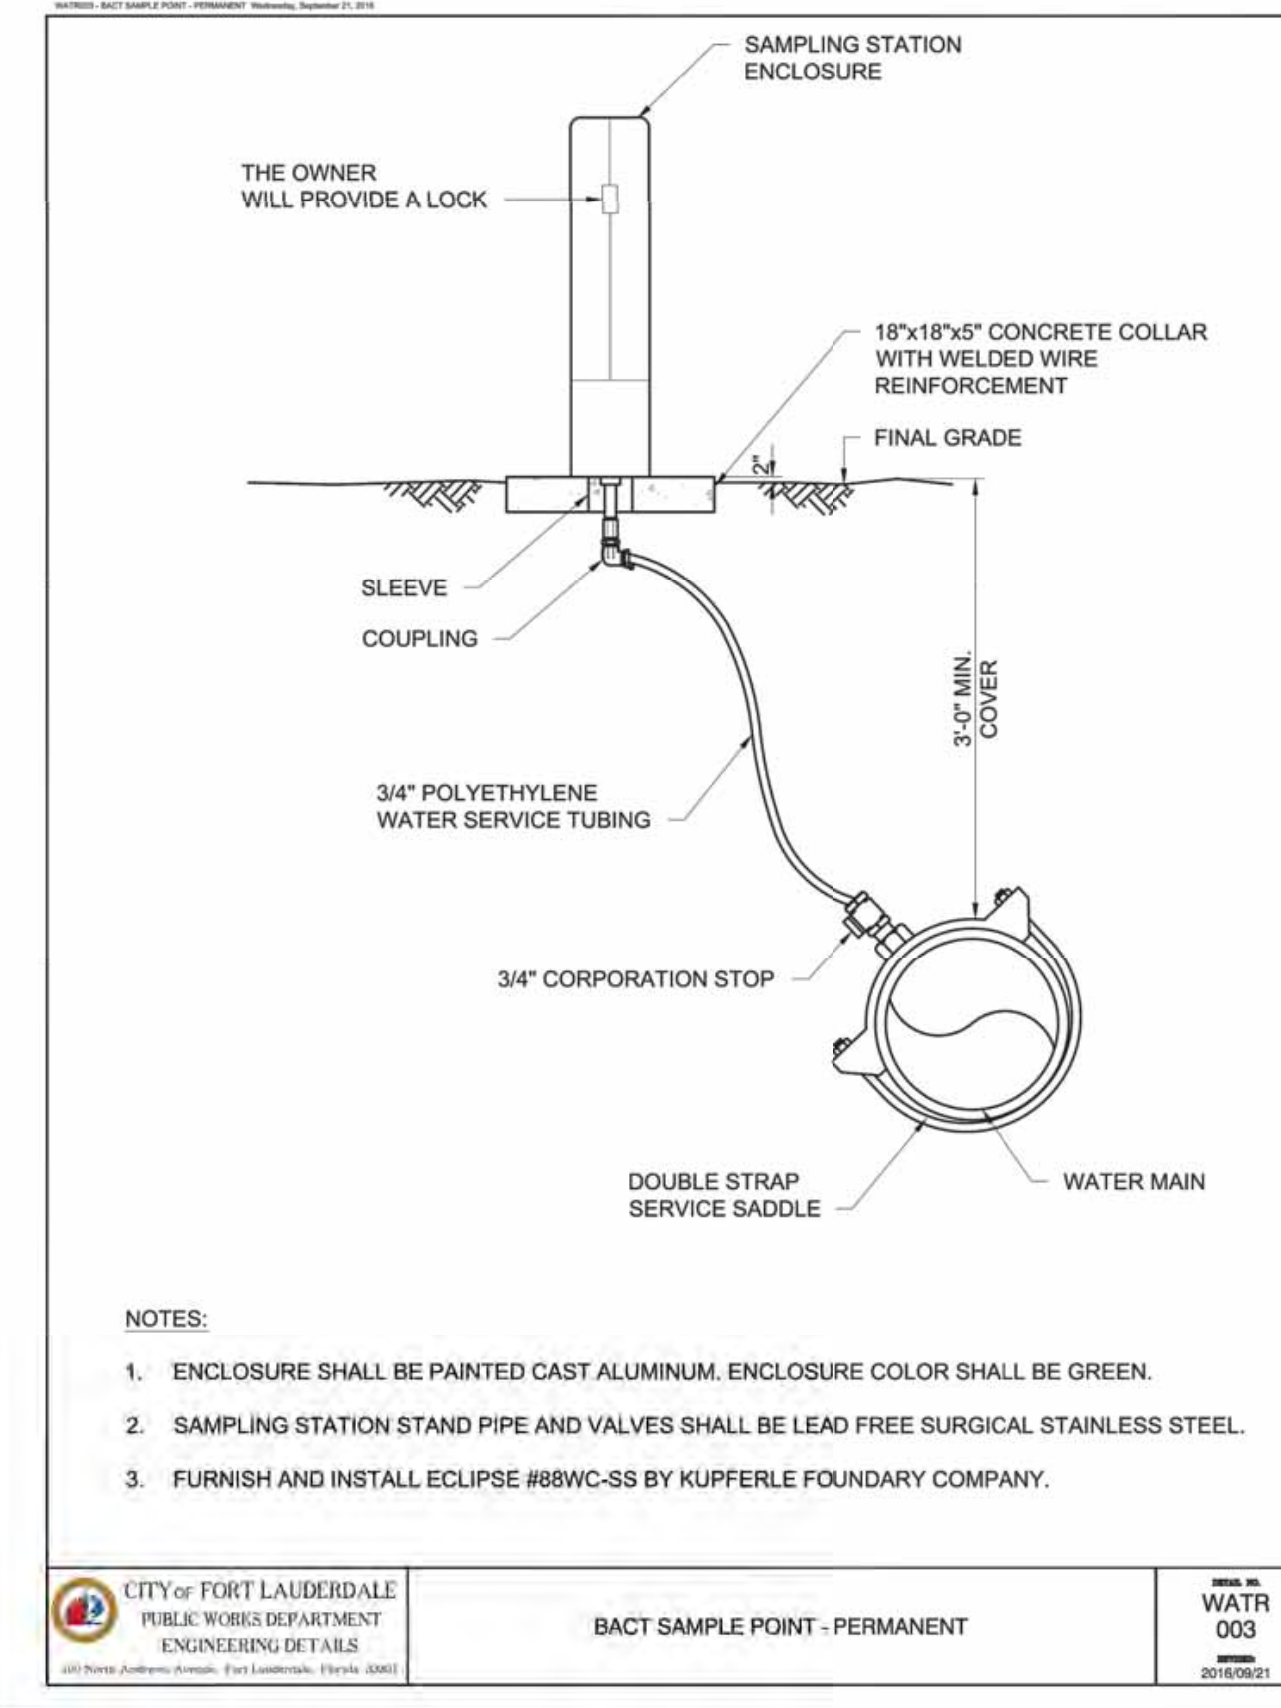

CITY OF FORT LAUDERDALE  
PUBLIC WORKS DEPARTMENT  
ENGINEERING DETAILS

**BACT SAMPLE POINT - PERMANENT**


WATR 003  
2016/09/01

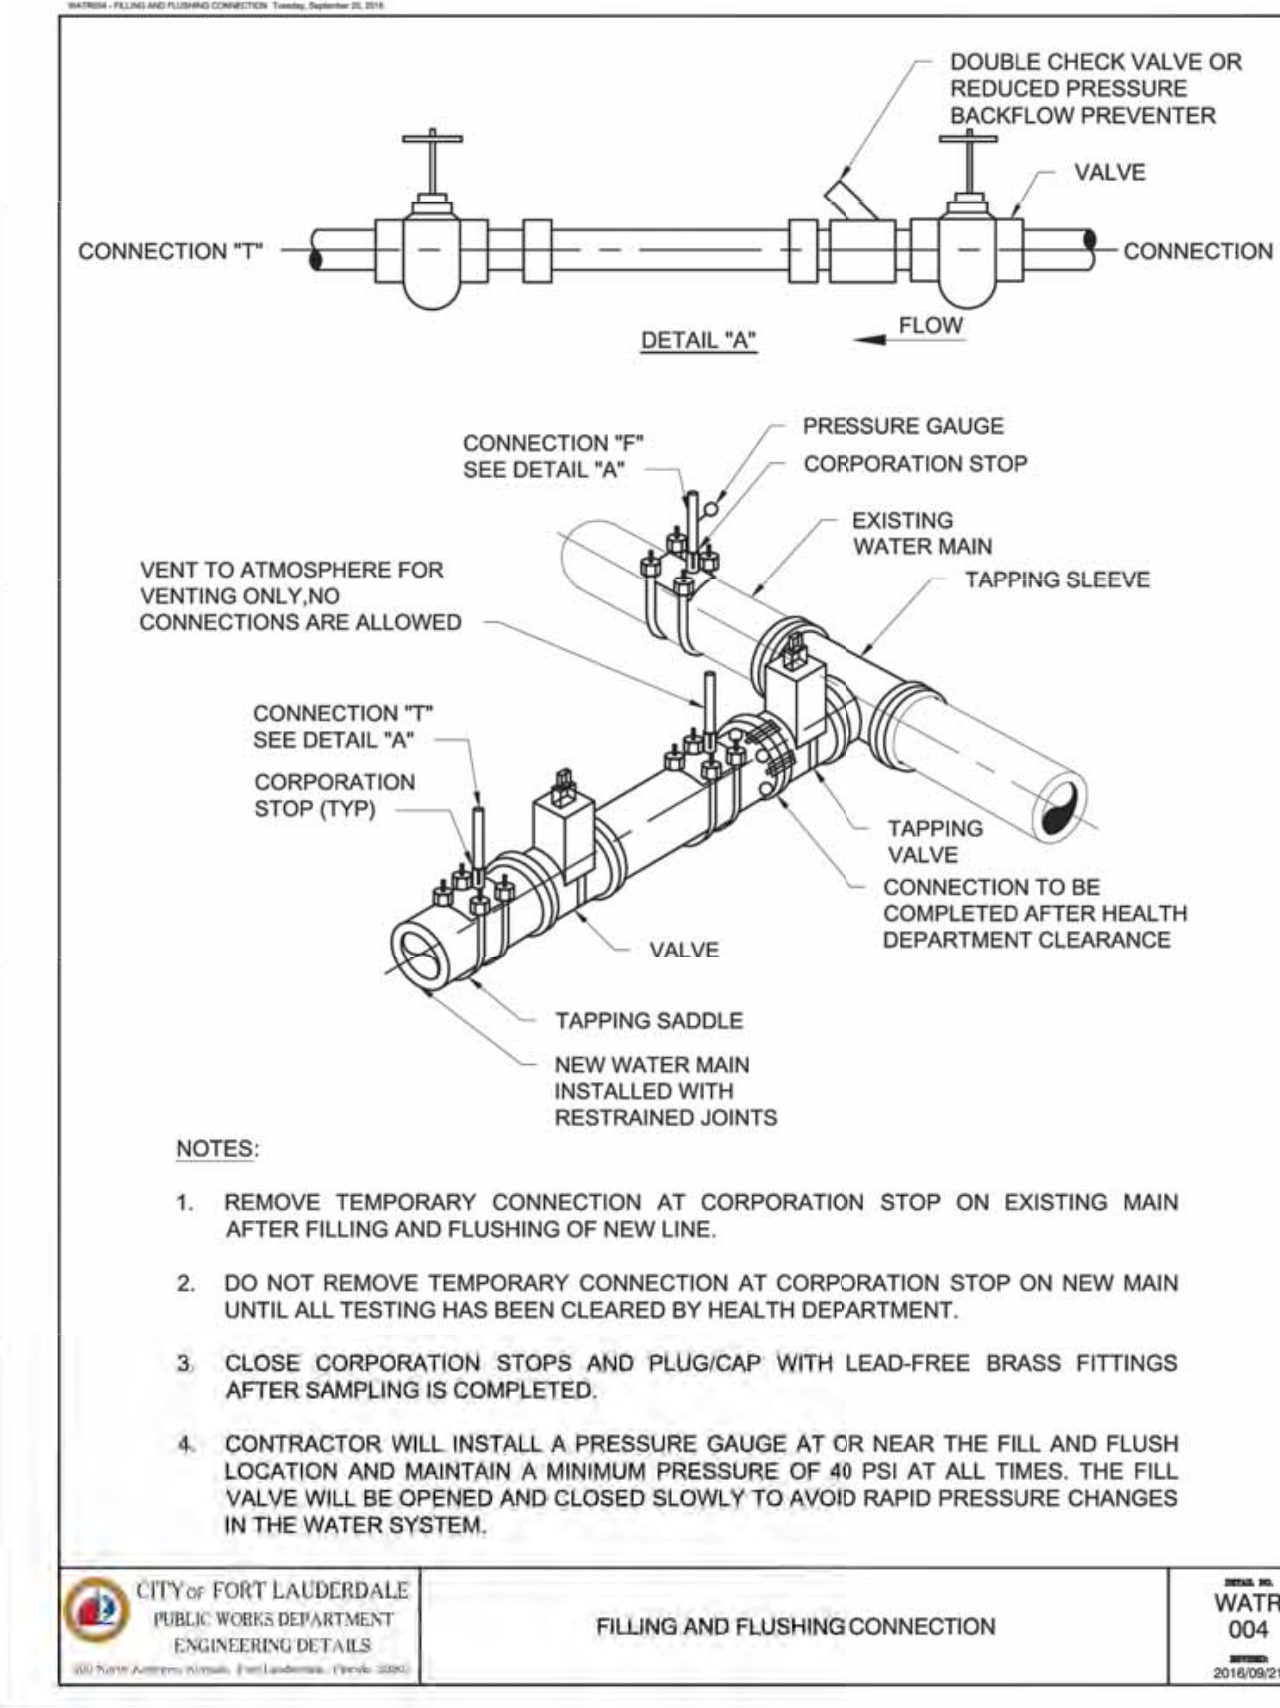

CITY OF FORT LAUDERDALE  
PUBLIC WORKS DEPARTMENT  
ENGINEERING DETAILS

**FILLING AND FLUSHING CONNECTION**


WATR 004  
2016/09/01

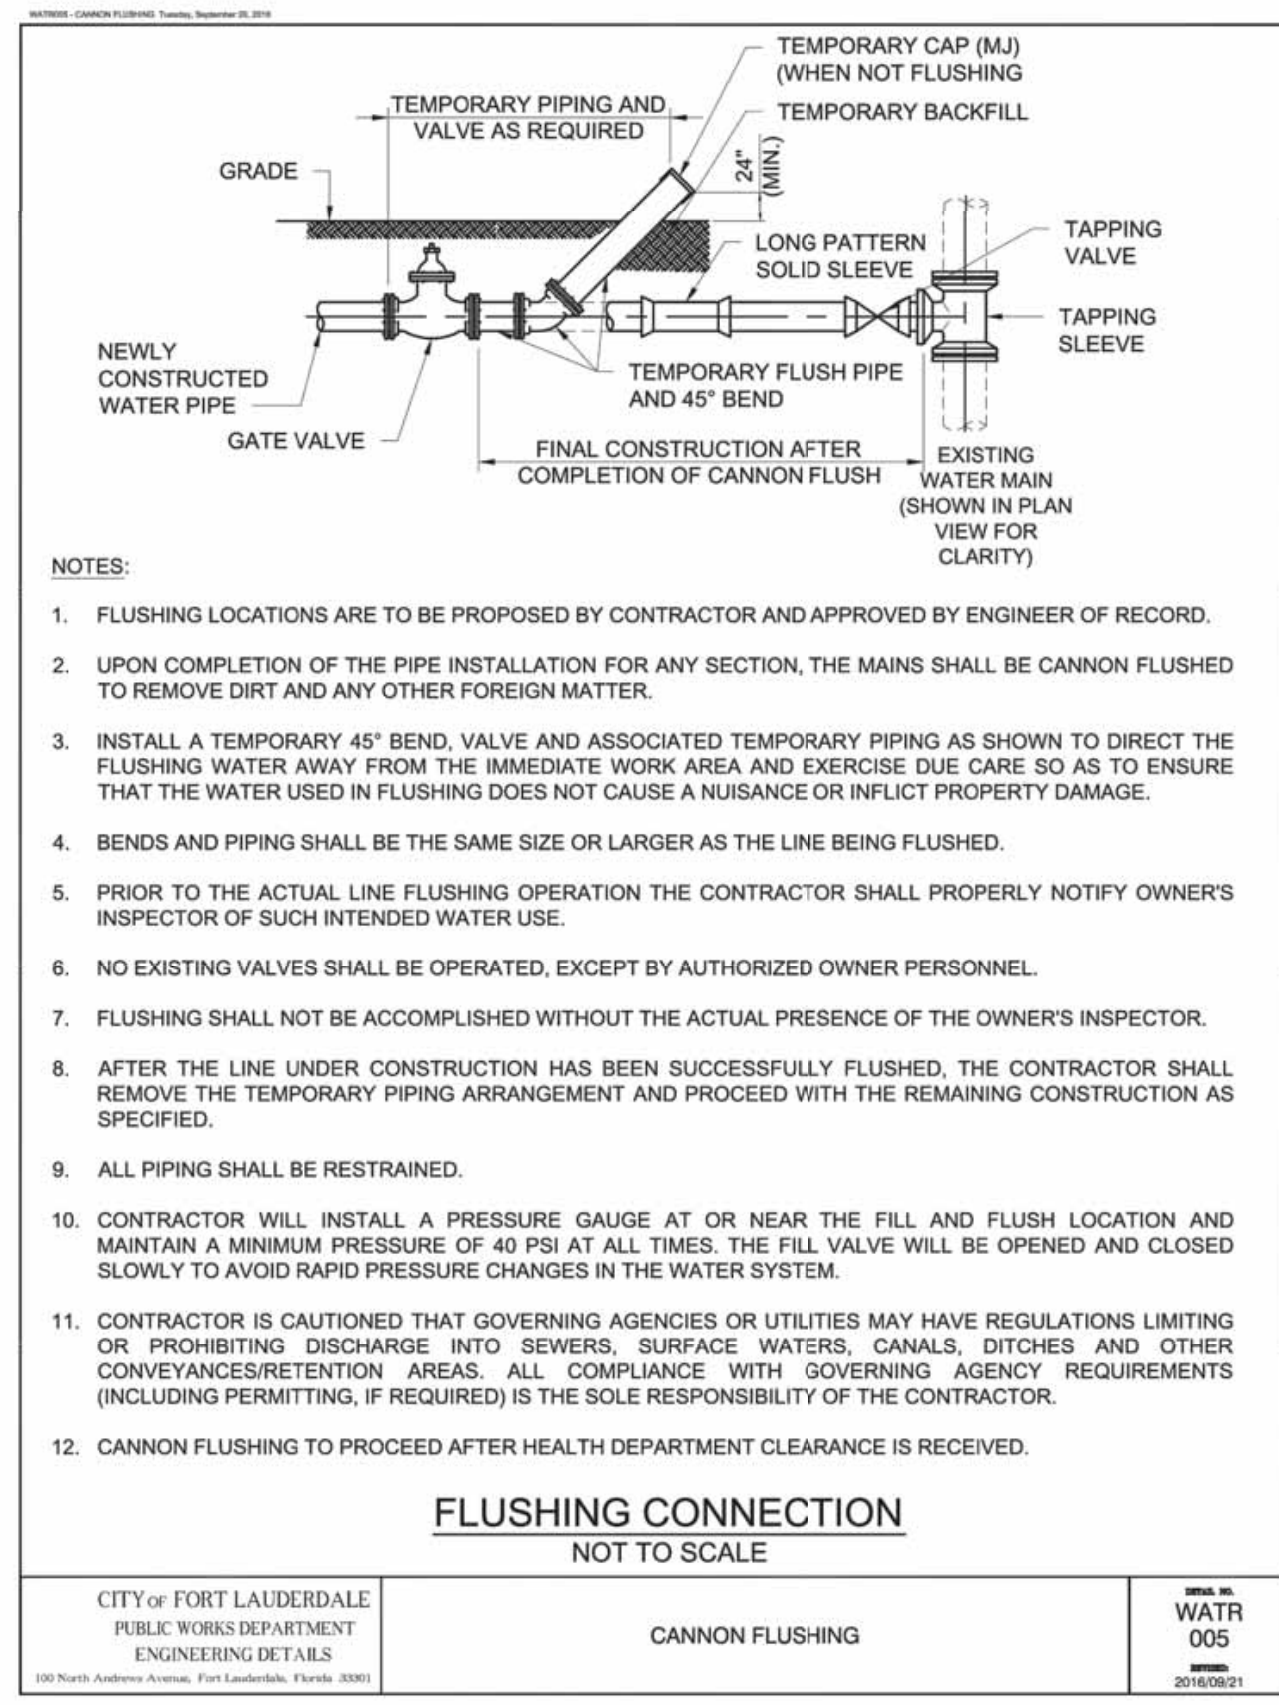

CITY OF FORT LAUDERDALE  
PUBLIC WORKS DEPARTMENT  
ENGINEERING DETAILS

**CANNON FLUSHING**


WATR 005  
2016/09/01

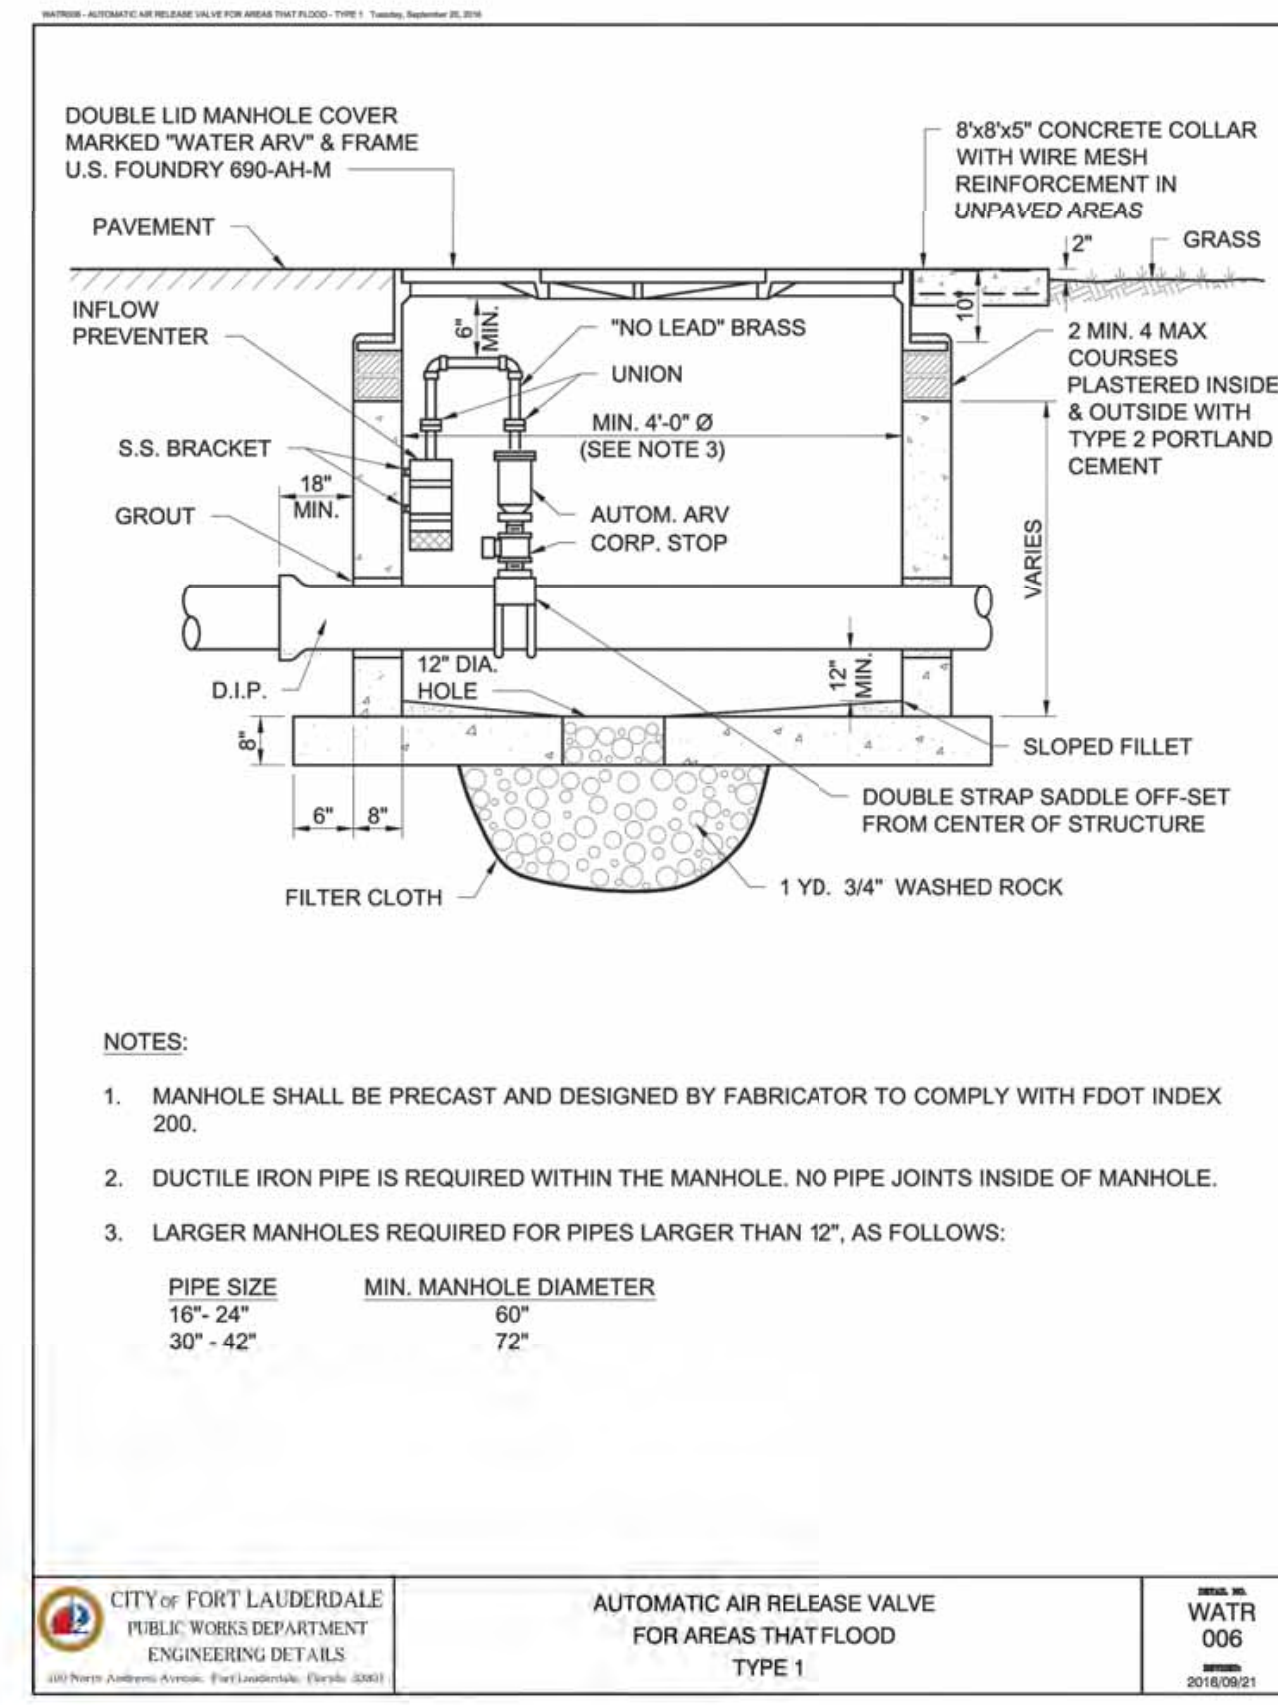

CITY OF FORT LAUDERDALE  
PUBLIC WORKS DEPARTMENT  
ENGINEERING DETAILS

**AUTOMATIC AIR RELEASE VALVE  
FOR AREAS THAT FLOOD  
TYPE 1**


WATR 006  
2016/09/01

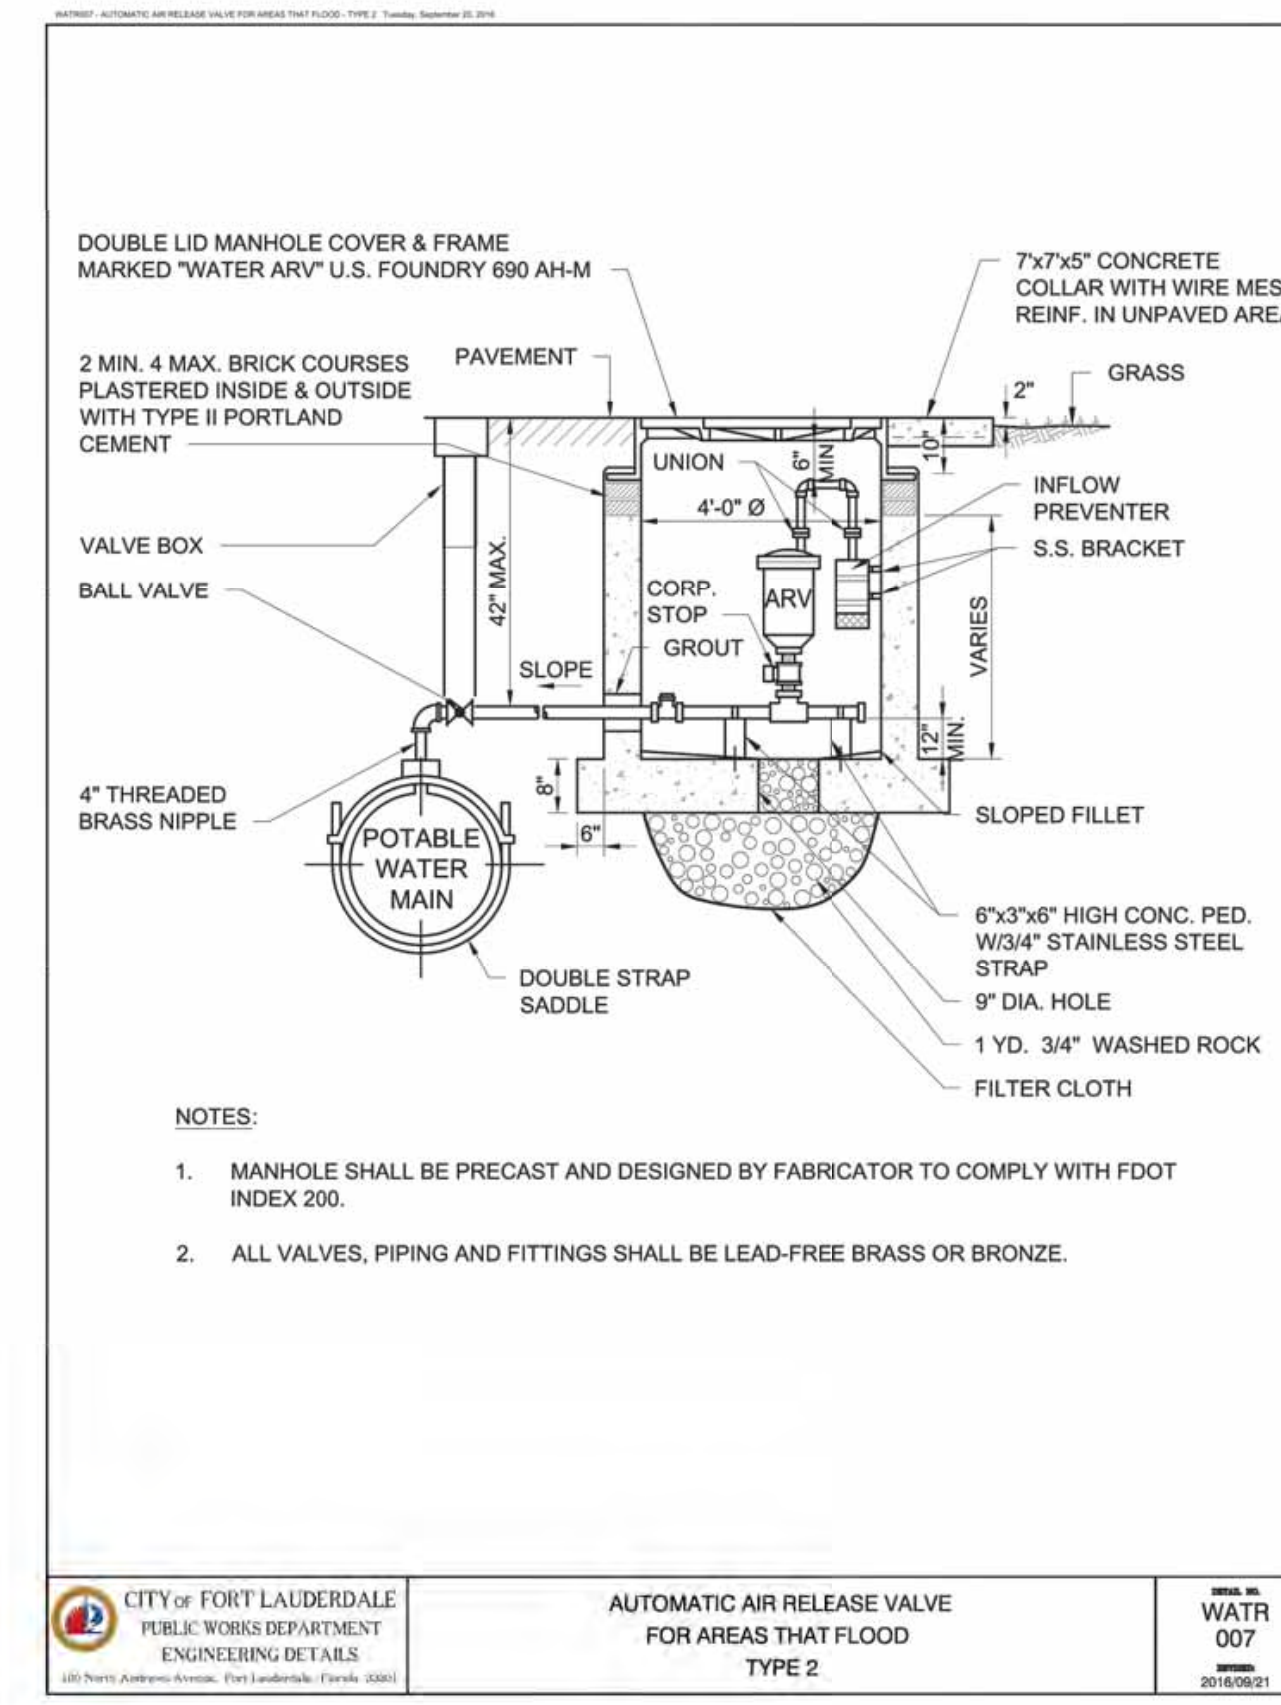

CITY OF FORT LAUDERDALE  
PUBLIC WORKS DEPARTMENT  
ENGINEERING DETAILS

**AUTOMATIC AIR RELEASE VALVE  
FOR AREAS THAT FLOOD  
TYPE 2**

WATR 007  
2016/09/01

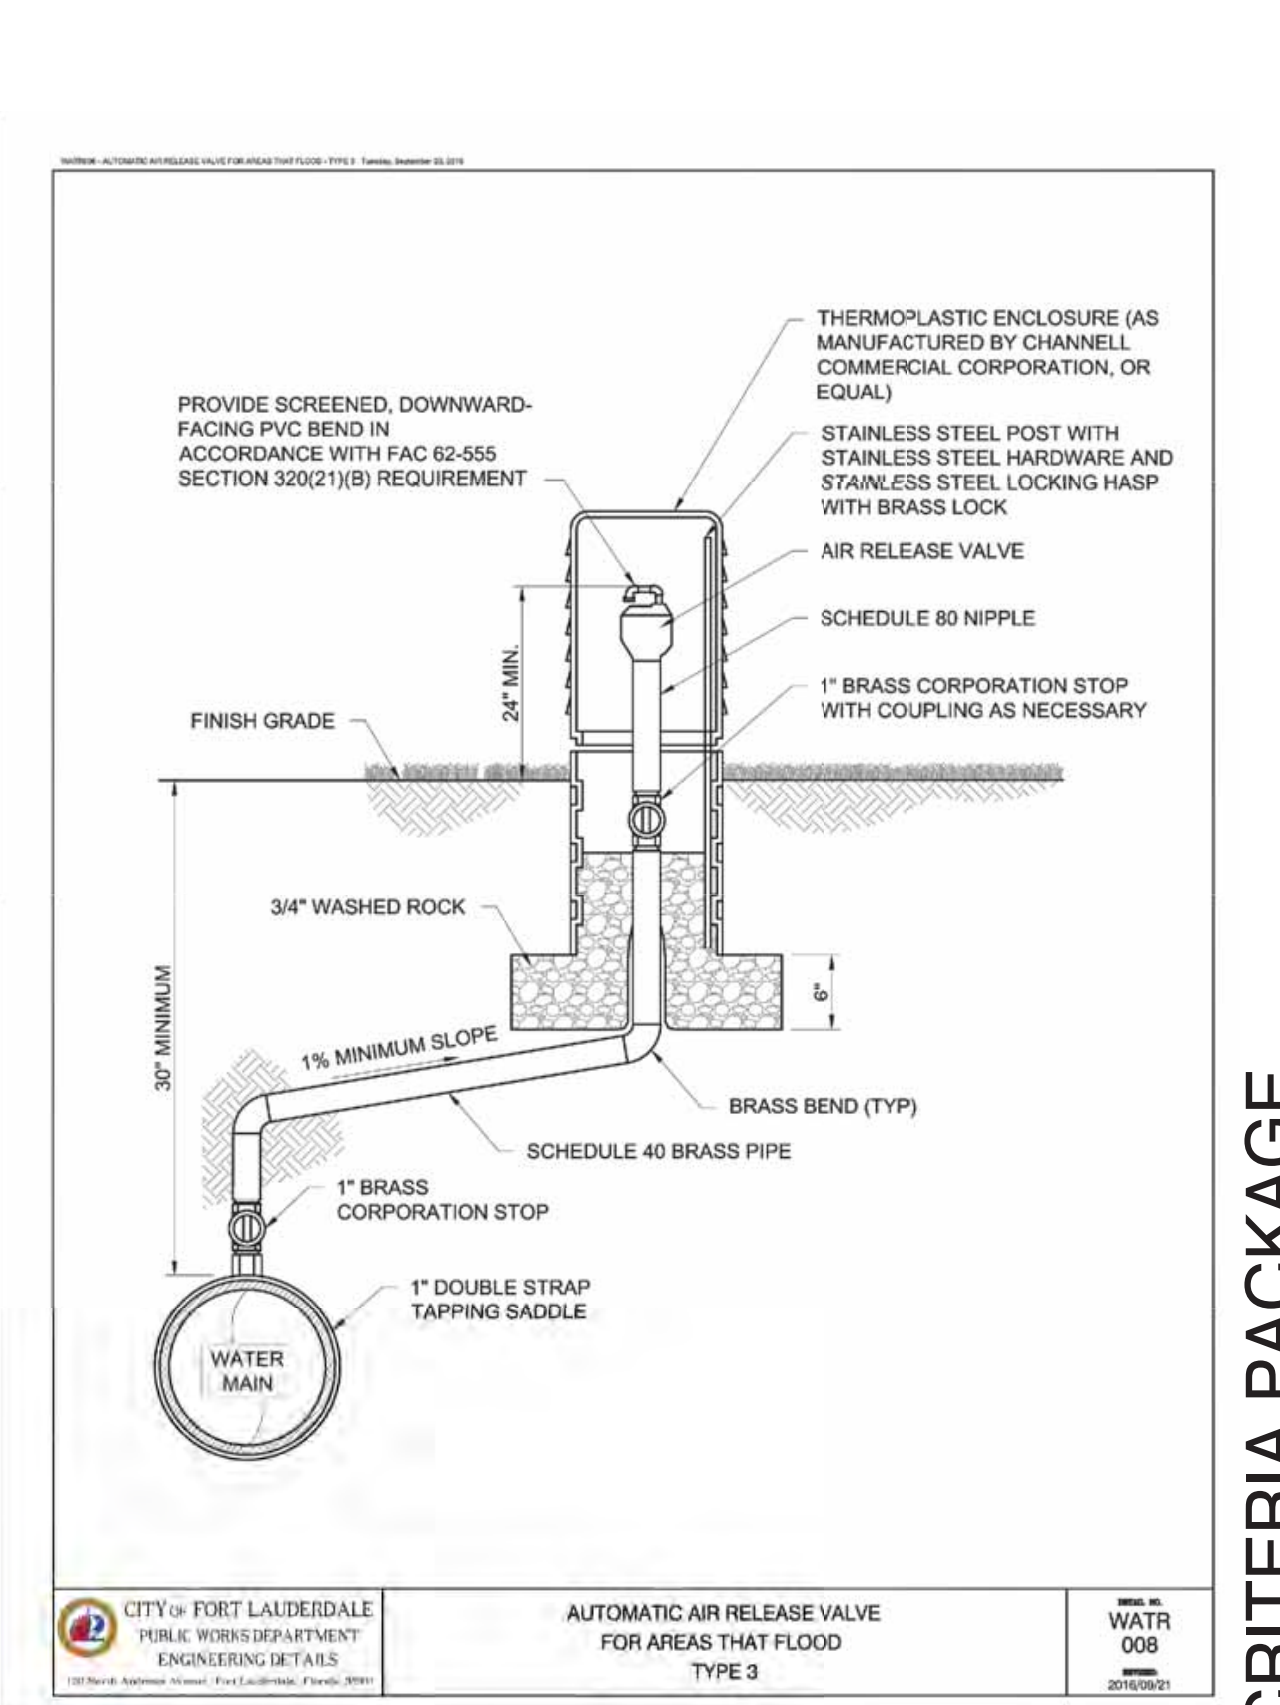

CITY OF FORT LAUDERDALE  
PUBLIC WORKS DEPARTMENT  
ENGINEERING DETAILS

**AUTOMATIC AIR RELEASE VALVE  
FOR AREAS THAT FLOOD  
TYPE 3**

WATR 008  
2016/09/01

PREPARED BY:  
**Kimley-Horn**

© 2021 KIMLEY-HORN AND ASSOCIATES, INC.  
8201 PETERS ROAD, SUITE 2200, PLANTATION, FL 33324  
PHONE: 954-535-5100 FAX: 954-739-2247  
WWW.KIMLEY-HORN.COM REGISTRY No. 696

**DESIGN CRITERIA PACKAGE**

**PROJECT # 12412**  
**PUMP STATION A-16 UPGRADE**  
**WASTEWATER DESIGN CRITERIA PACKAGE**  
**STANDARD DETAILS**

SHEET NO. **12** OF **31**

CAD FILE: 12412-MUL-1-DET1  
DRAWING FILE NO. 4-142-31

**CITY OF FORT LAUDERDALE**  
**PUBLIC WORKS DEPARTMENT**  
**ENGINEERING & ARCHITECTURE**  
 100 North Andrews Avenue, Fort Lauderdale, Florida 33301


ENGINEER: GARY B. RAY, P.E.  
 REG. NO: 46682  
 DATE: 9/29/2021

GRAN BY: AL  
 DESIGNED BY: CR  
 CHECKED BY: CR  
 FIELD BOOK:

TEL: (954) 535-5100  
 FAX:

NO.	DATE	BY	DESCRIPTION

Plotted By: Marissa Street, Set: PUMP STATION A-16 DESIGN CRITERIA PACKAGE, Layout: DET-13, September 28, 2021 04:14:16pm, K:\V\_L\civil\043 jobs\043184401.cad, c:\arc12464-416.pst, a-16 rev location\CAD\plant\043\043184401.dwg, This document, together with the concepts and designs presented herein, is intended only for the specific purpose and client for which it was prepared. Reuse of and improper reliance on this document without written authorization and adaptation by Kimley-Horn and Associates, Inc. shall be without liability to Kimley-Horn and Associates, Inc.

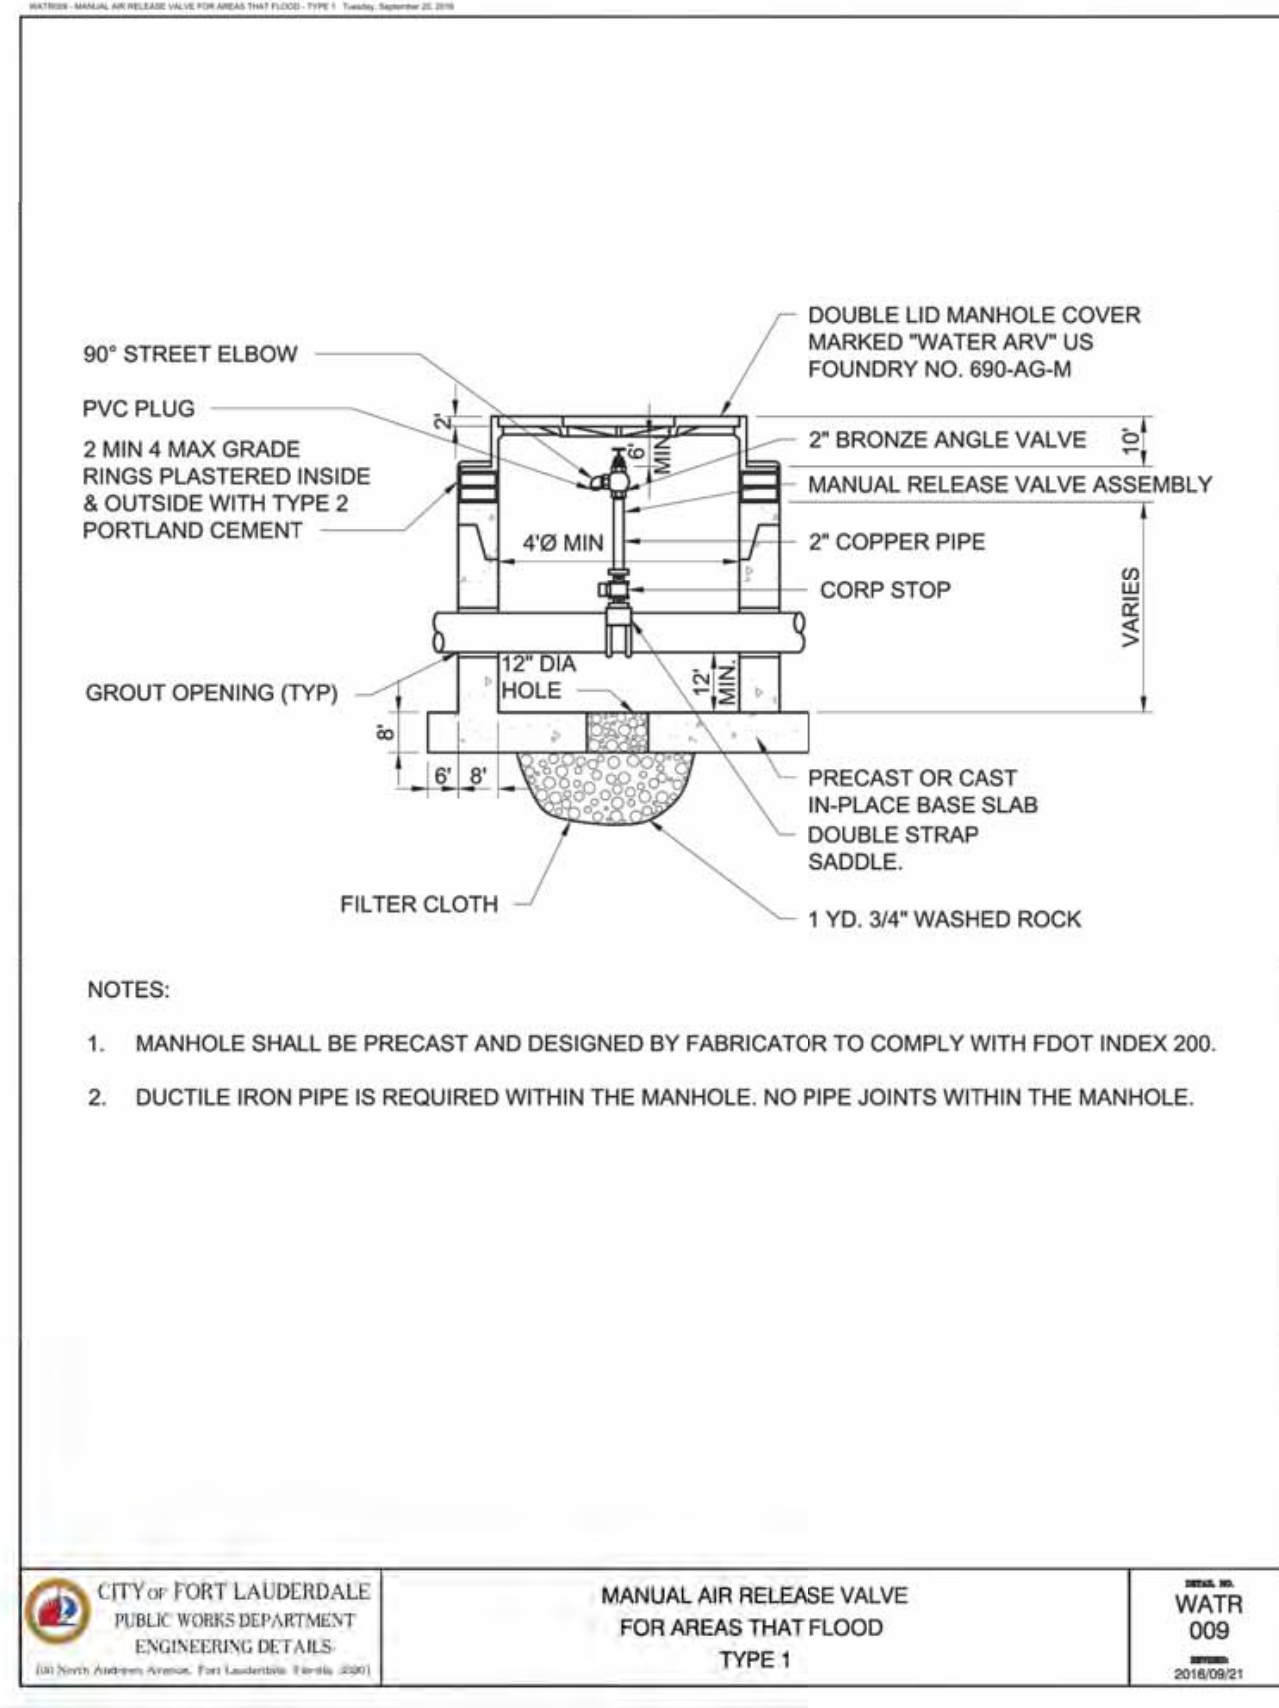


- NOTES:
- MANHOLE SHALL BE PRECAST AND DESIGNED BY FABRICATOR TO COMPLY WITH FDOT INDEX 200.
  - DUCTILE IRON PIPE IS REQUIRED WITHIN THE MANHOLE. NO PIPE JOINTS WITHIN THE MANHOLE.

CITY OF FORT LAUDERDALE  
PUBLIC WORKS DEPARTMENT  
ENGINEERING DETAILS

MANUAL AIR RELEASE VALVE  
FOR AREAS THAT FLOOD  
TYPE 1

DATE: WATR 009  
2018/09/21

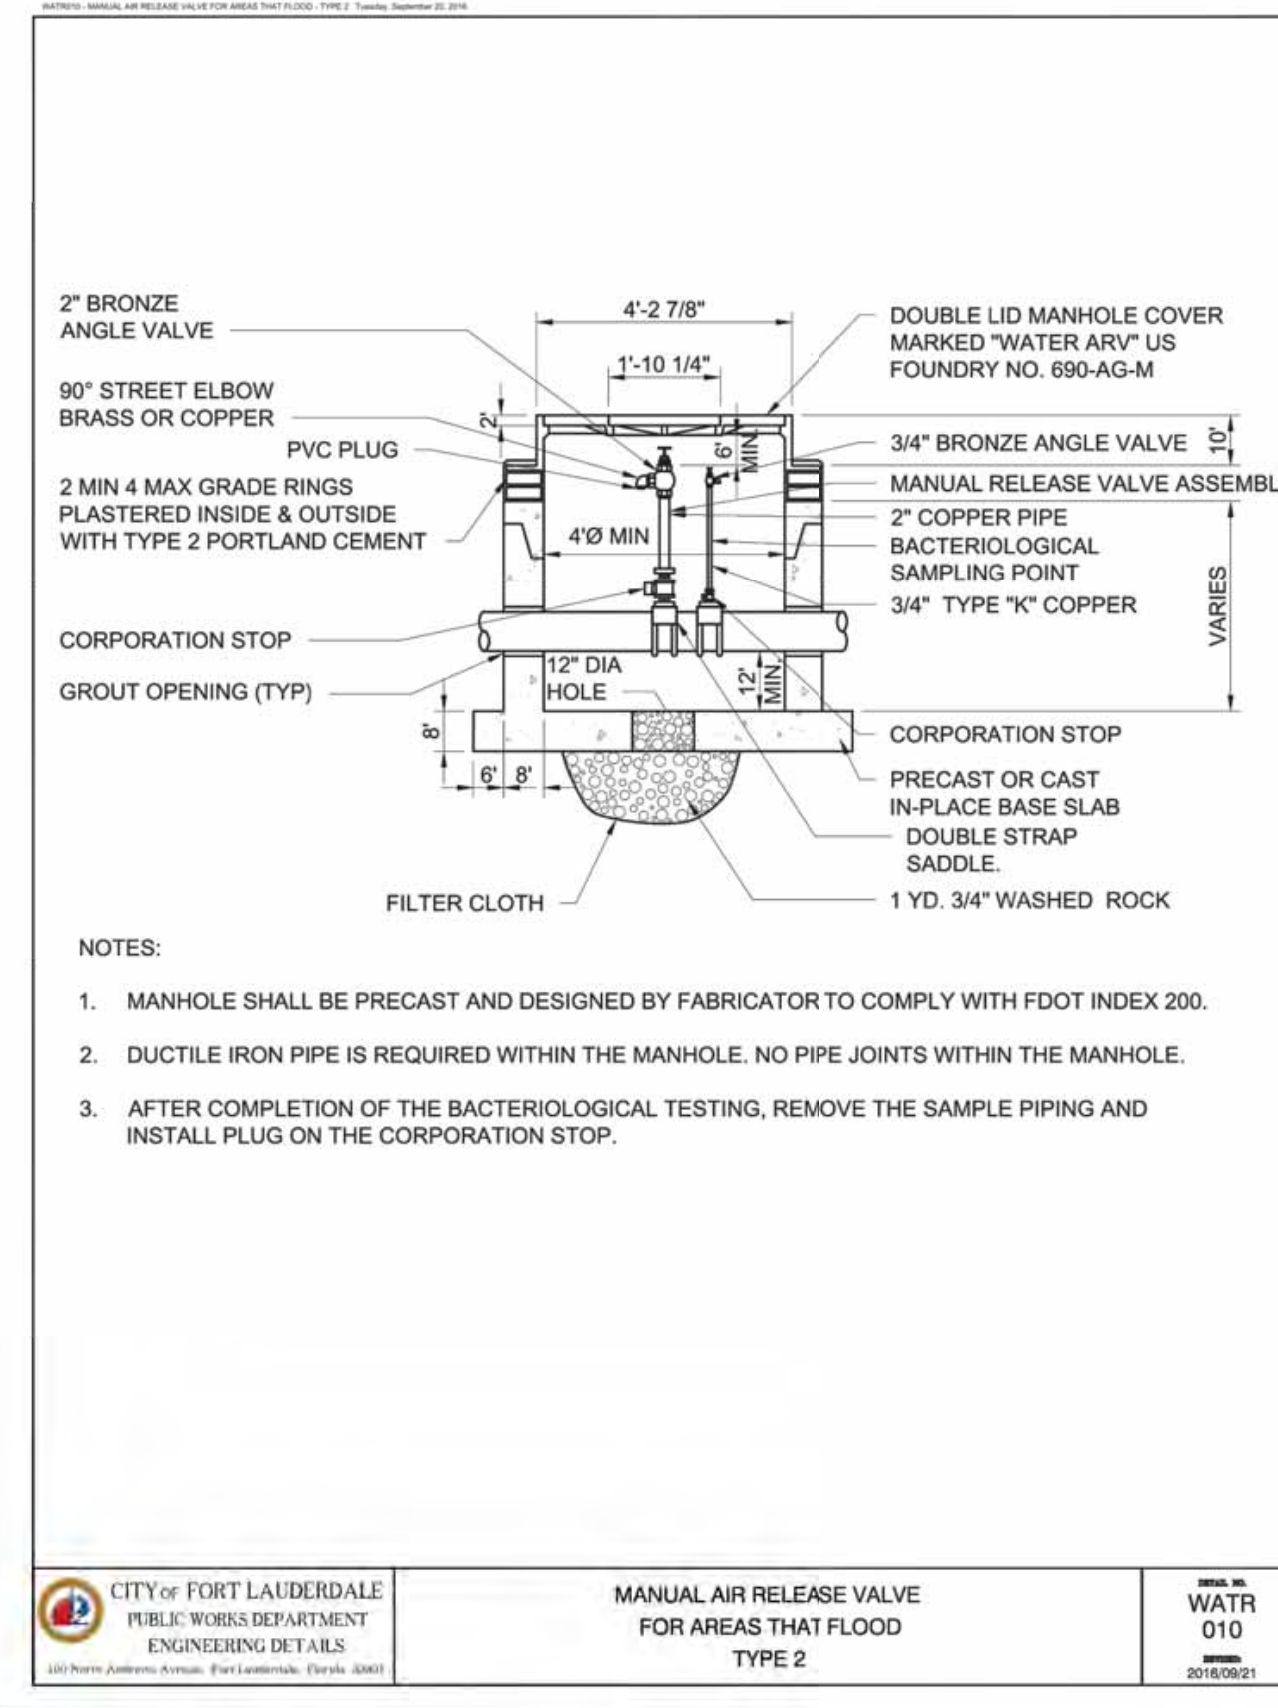


- NOTES:
- MANHOLE SHALL BE PRECAST AND DESIGNED BY FABRICATOR TO COMPLY WITH FDOT INDEX 200.
  - DUCTILE IRON PIPE IS REQUIRED WITHIN THE MANHOLE. NO PIPE JOINTS WITHIN THE MANHOLE.
  - AFTER COMPLETION OF THE BACTERIOLOGICAL TESTING, REMOVE THE SAMPLE PIPING AND INSTALL PLUG ON THE CORPORATION STOP.

CITY OF FORT LAUDERDALE  
PUBLIC WORKS DEPARTMENT  
ENGINEERING DETAILS

MANUAL AIR RELEASE VALVE  
FOR AREAS THAT FLOOD  
TYPE 2


DATE: WATR 010  
2018/09/21

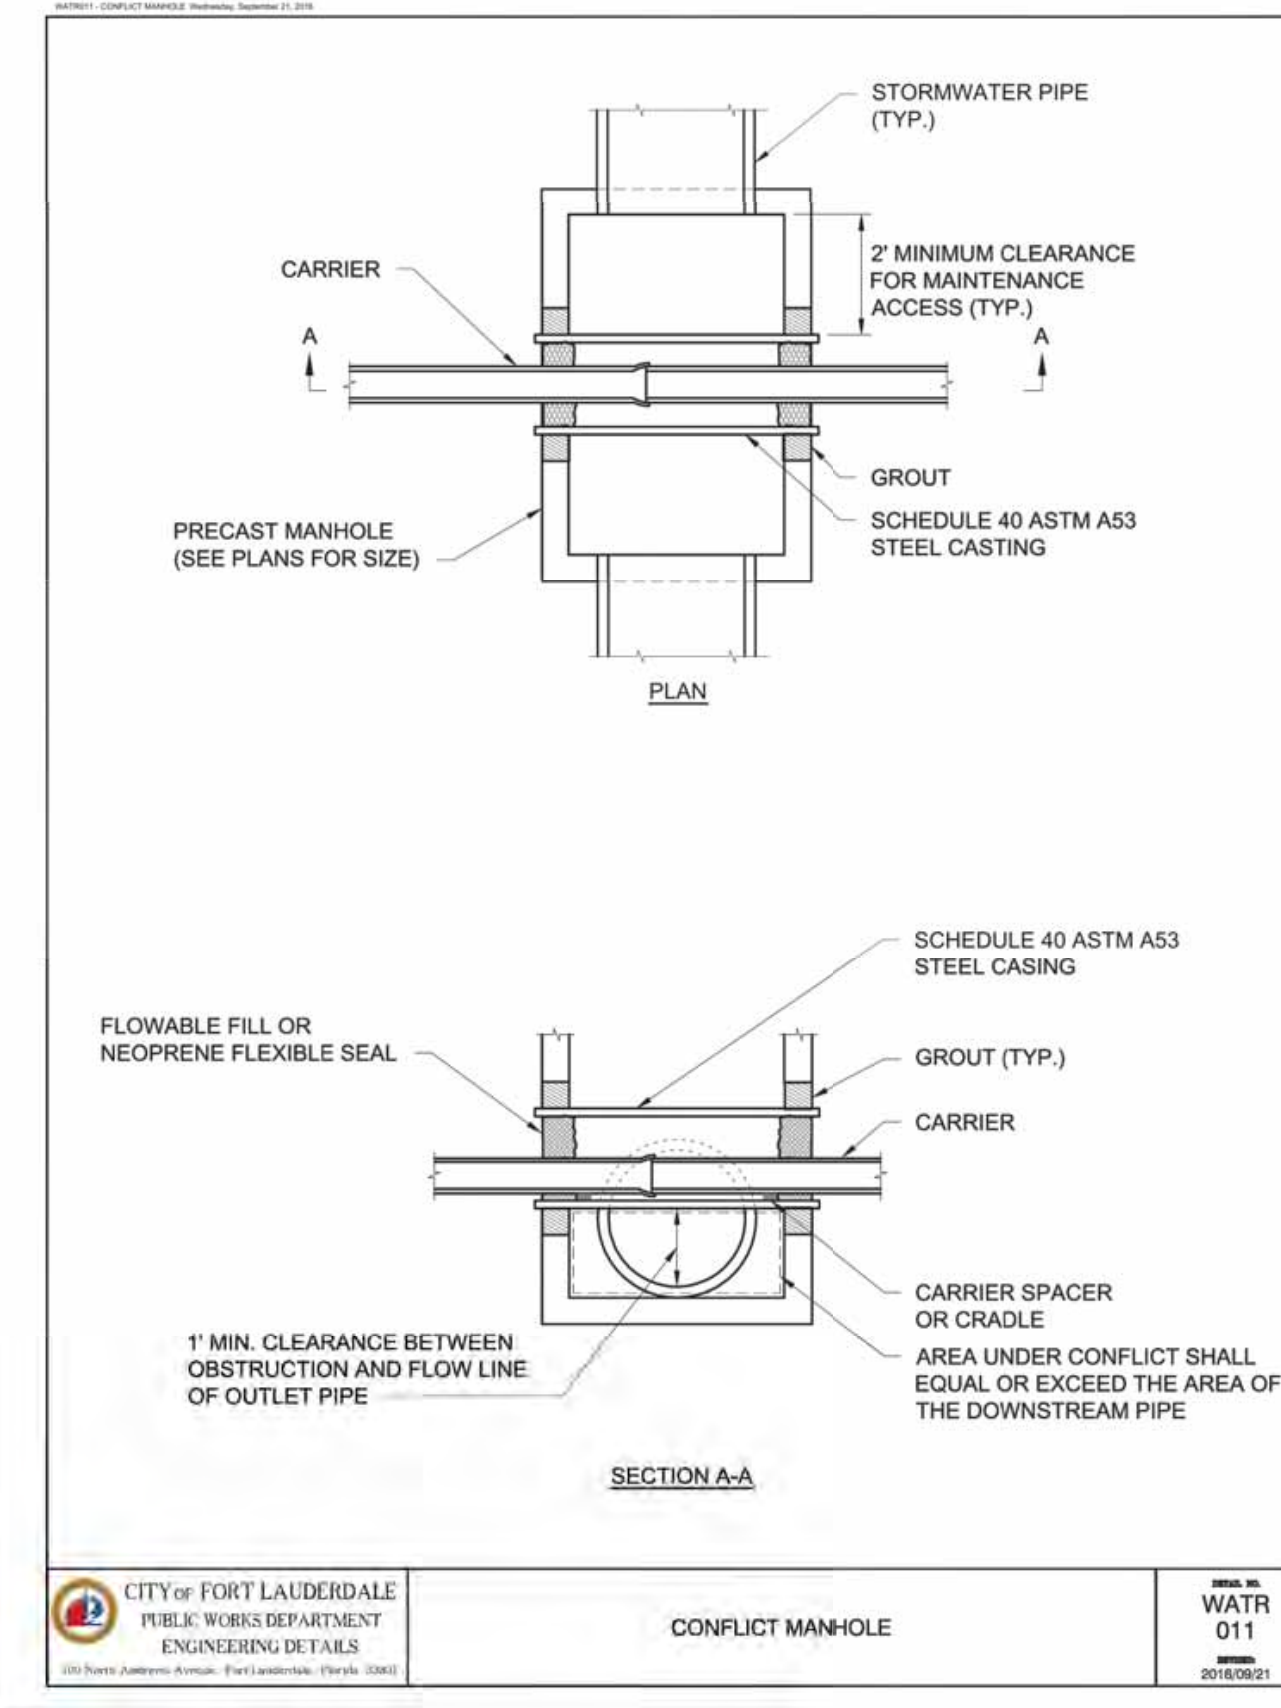

CITY OF FORT LAUDERDALE  
PUBLIC WORKS DEPARTMENT  
ENGINEERING DETAILS

CONFLICT MANHOLE


DATE: WATR 011  
2018/09/21

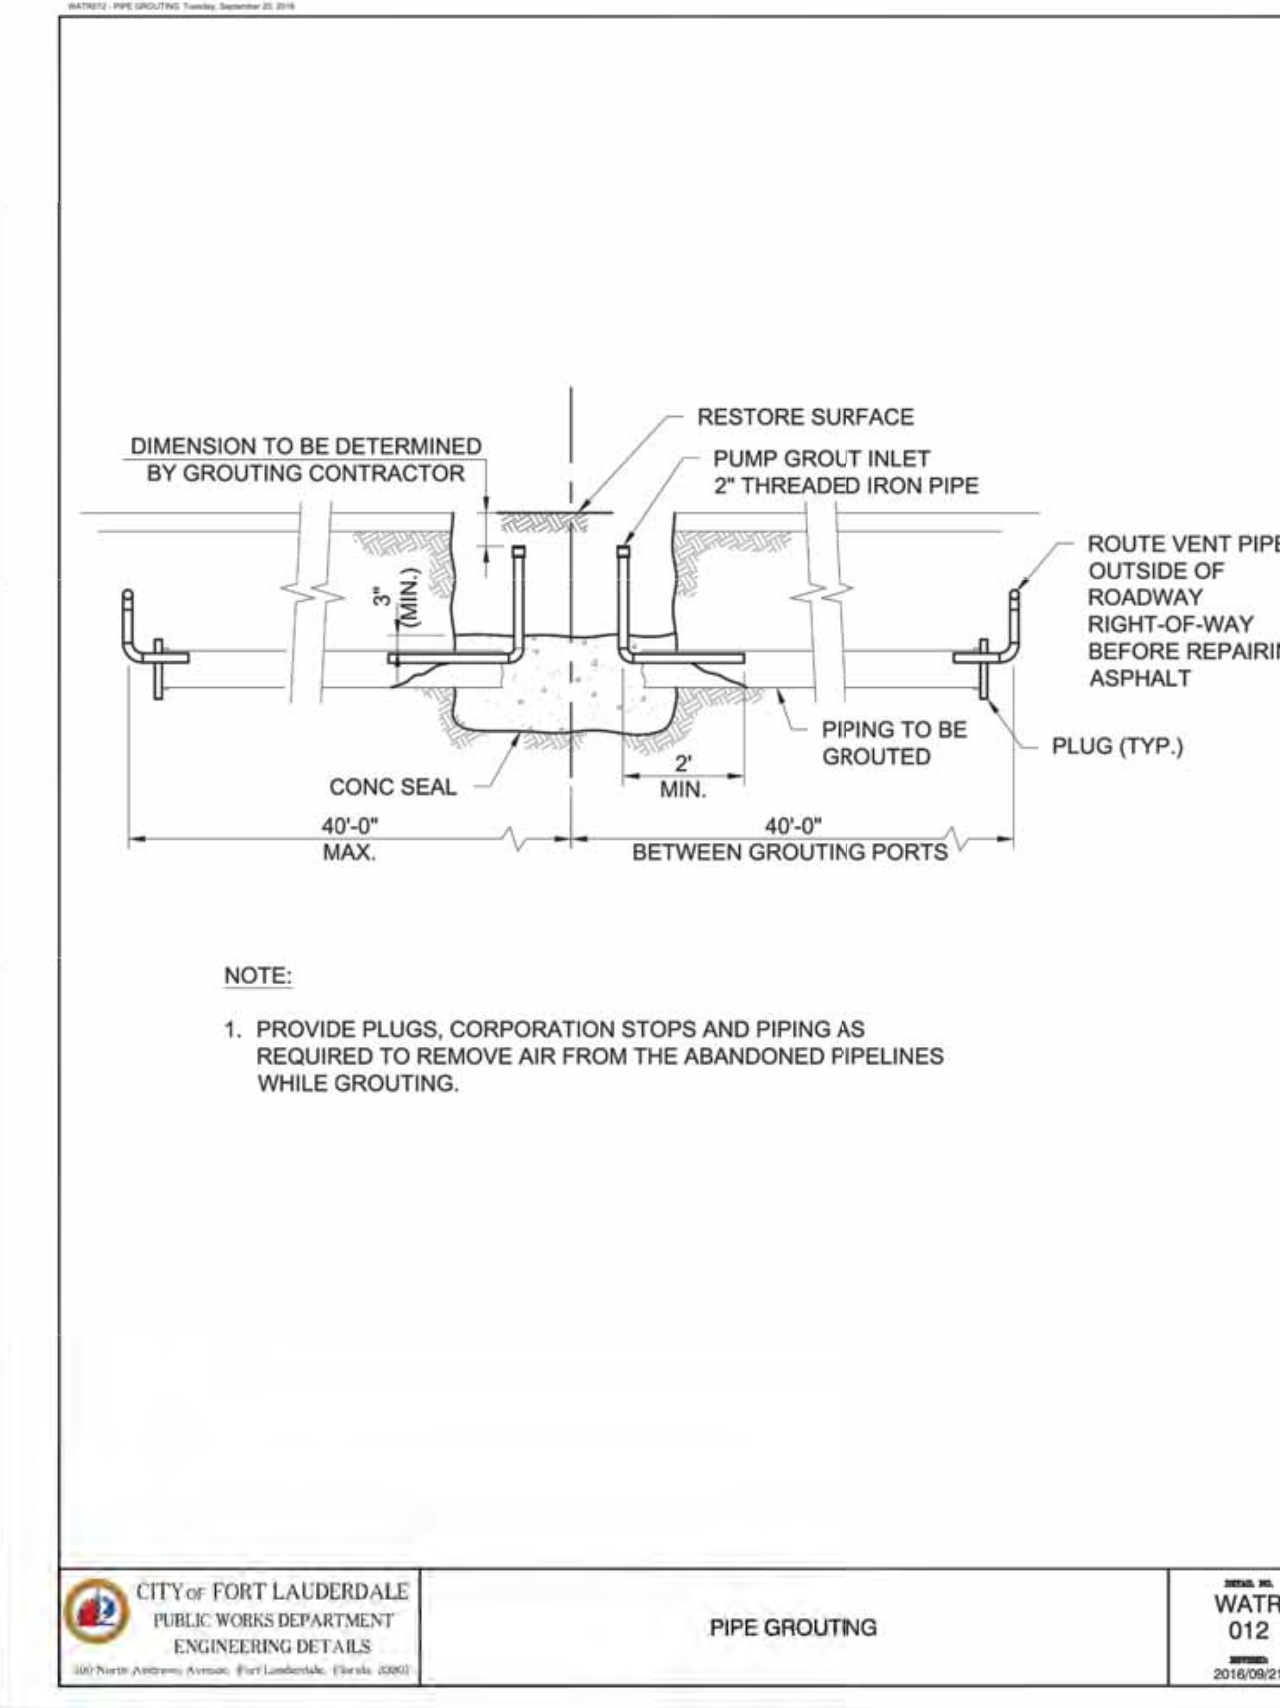

CITY OF FORT LAUDERDALE  
PUBLIC WORKS DEPARTMENT  
ENGINEERING DETAILS

PIPE GROUTING

DATE: WATR 012  
2018/09/21

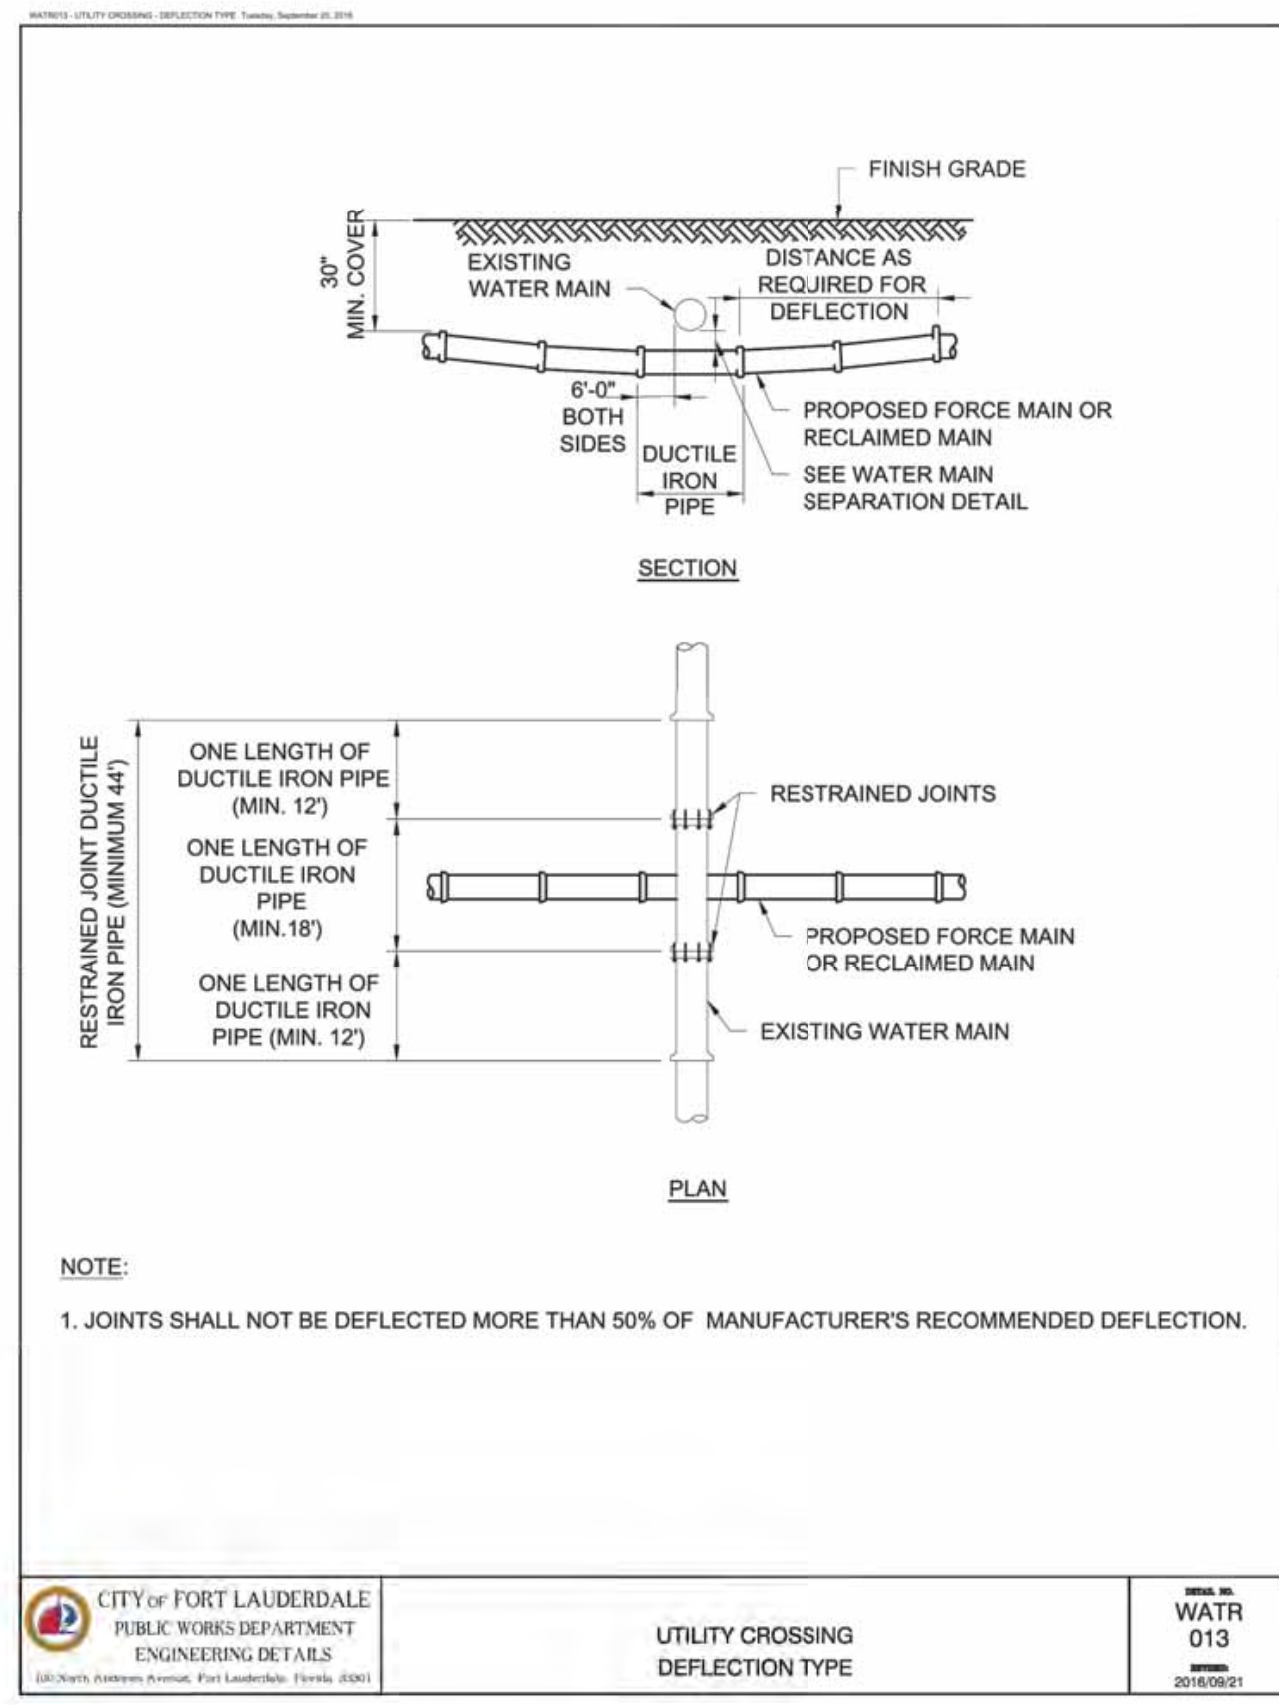


- NOTE:
- JOINTS SHALL NOT BE DEFLECTED MORE THAN 50% OF MANUFACTURER'S RECOMMENDED DEFLECTION.

CITY OF FORT LAUDERDALE  
PUBLIC WORKS DEPARTMENT  
ENGINEERING DETAILS

UTILITY CROSSING  
DEFLECTION TYPE

DATE: WATR 013  
2018/09/21

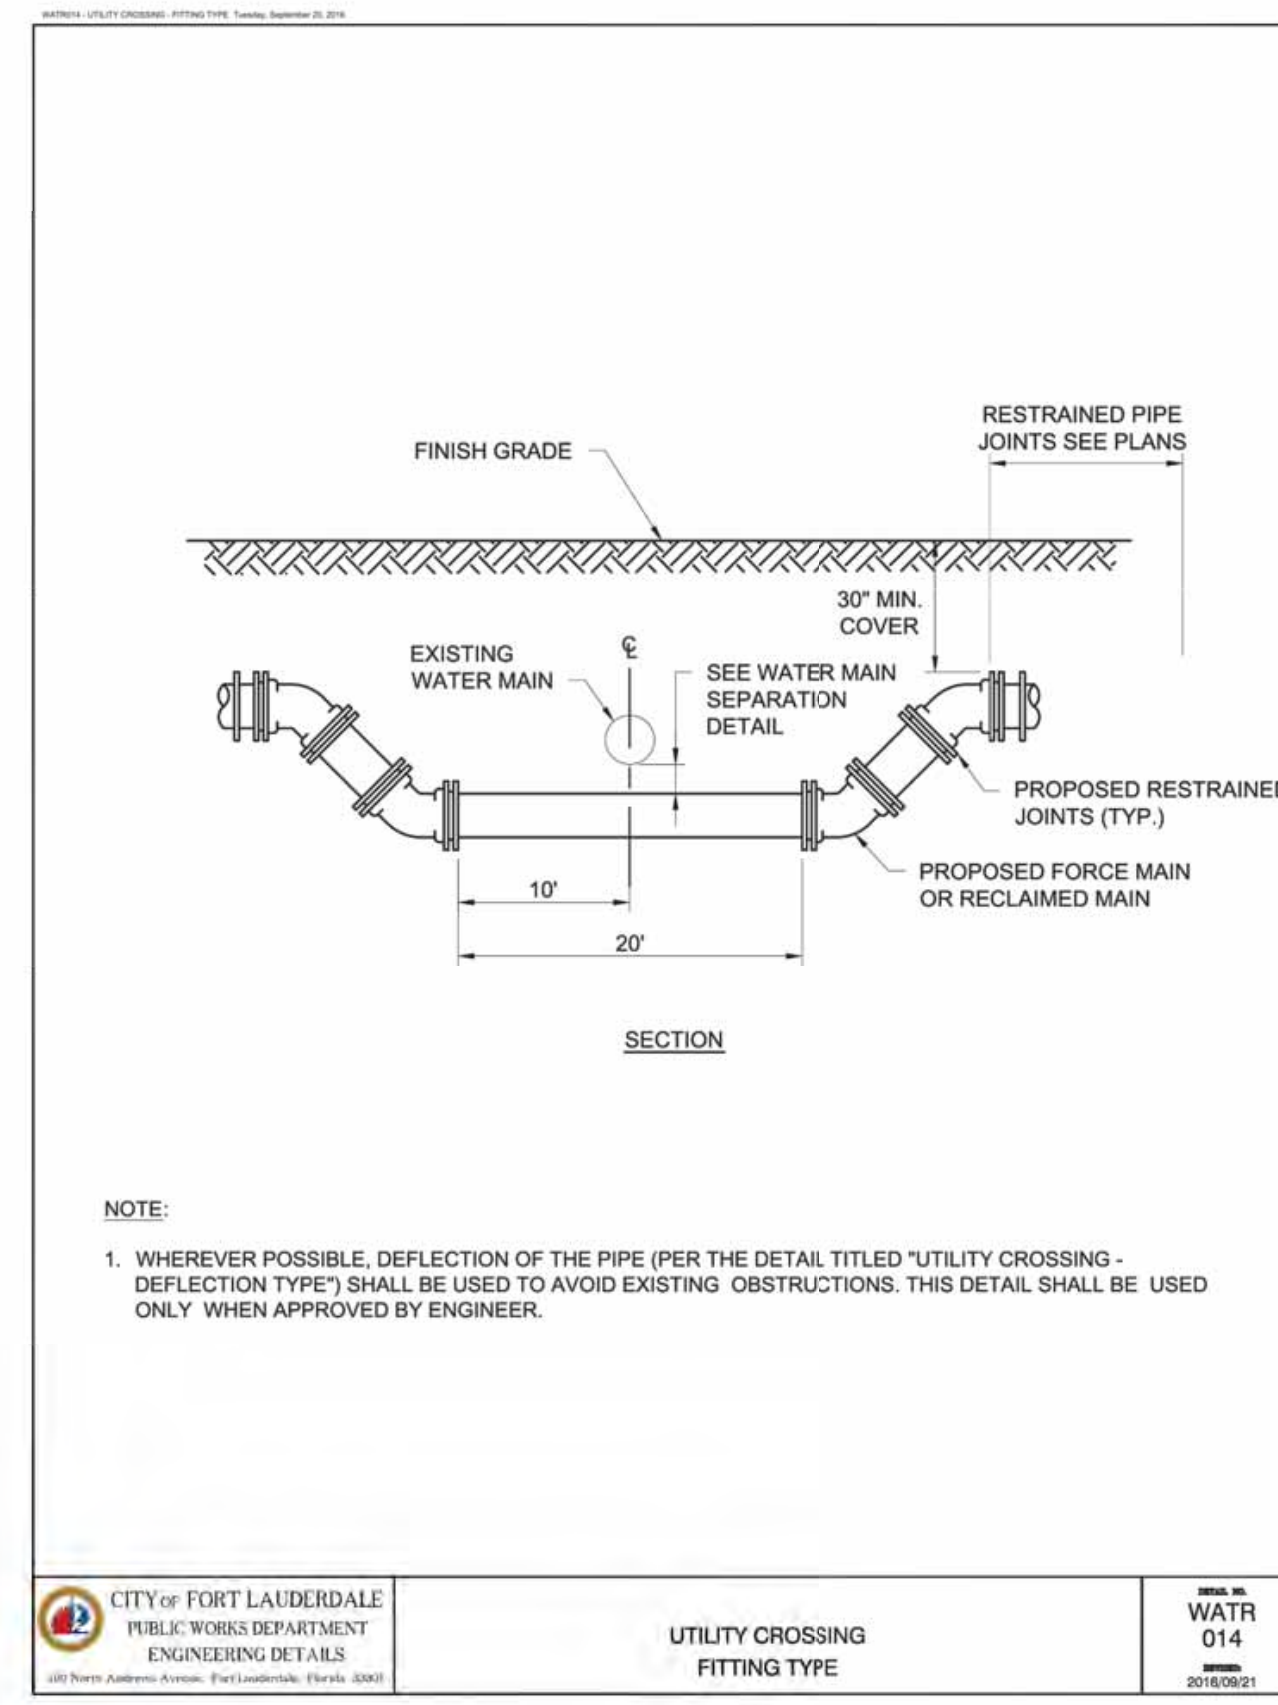


- NOTE:
- WHEREVER POSSIBLE, DEFLECTION OF THE PIPE (PER THE DETAIL TITLED 'UTILITY CROSSING - DEFLECTION TYPE') SHALL BE USED TO AVOID EXISTING OBSTRUCTIONS. THIS DETAIL SHALL BE USED ONLY WHEN APPROVED BY ENGINEER.

CITY OF FORT LAUDERDALE  
PUBLIC WORKS DEPARTMENT  
ENGINEERING DETAILS

UTILITY CROSSING  
FITTING TYPE


DATE: WATR 014  
2018/09/21

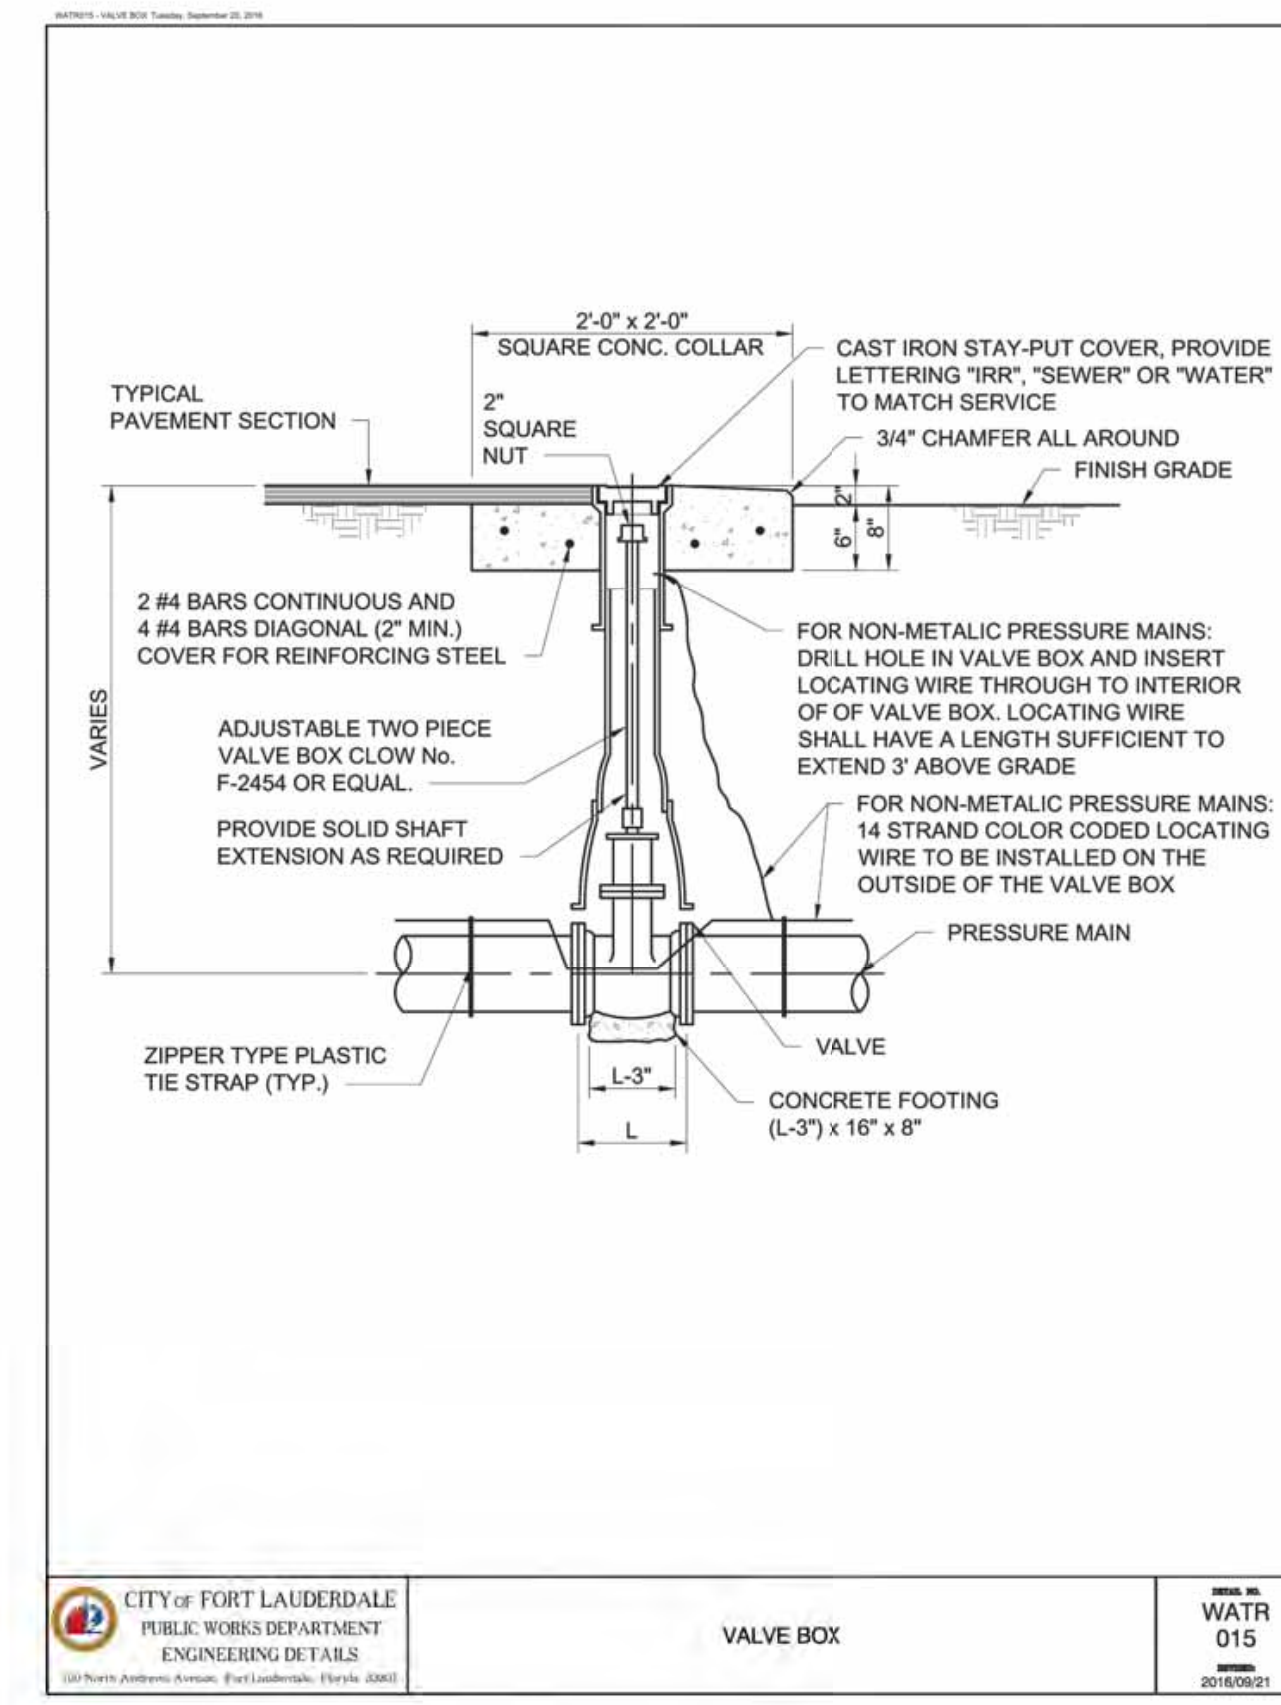

CITY OF FORT LAUDERDALE  
PUBLIC WORKS DEPARTMENT  
ENGINEERING DETAILS

VALVE BOX

DATE: WATR 015  
2018/09/21

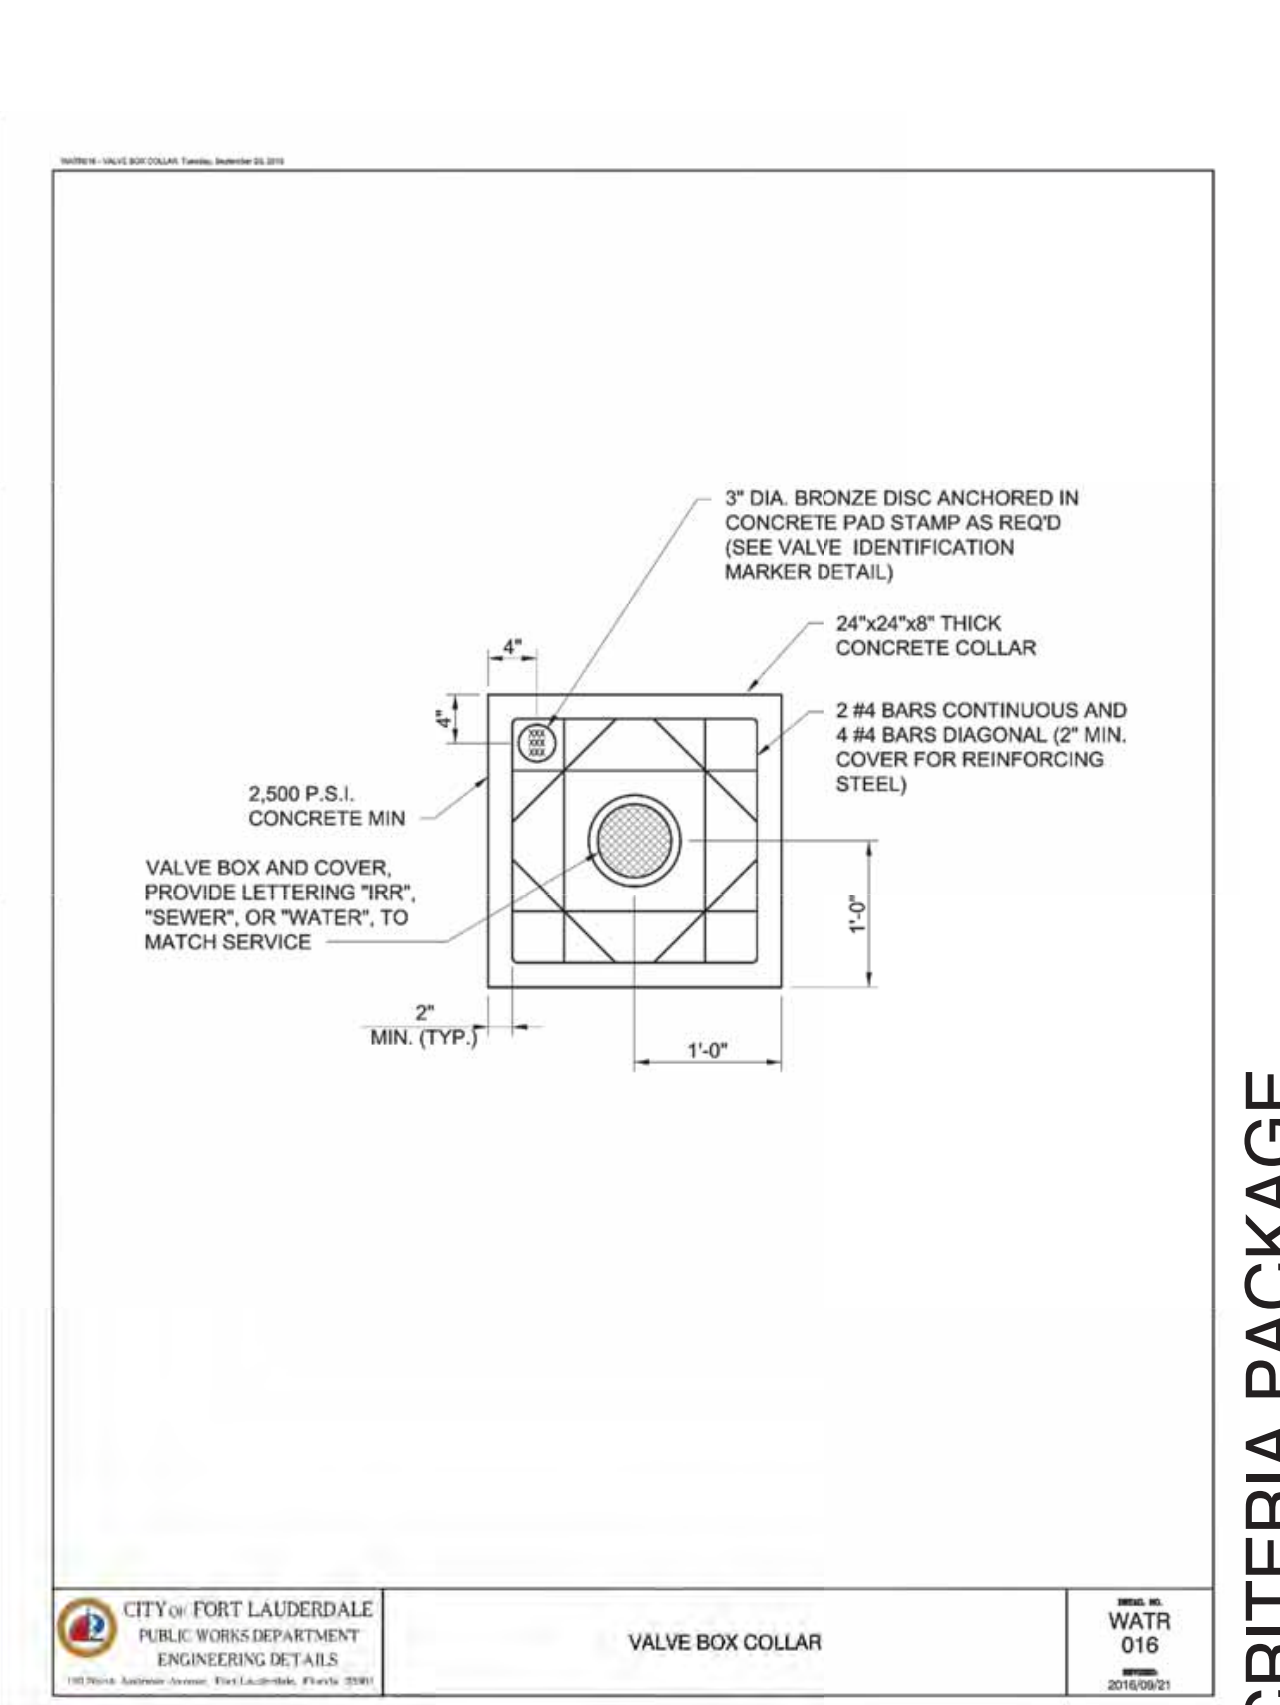

CITY OF FORT LAUDERDALE  
PUBLIC WORKS DEPARTMENT  
ENGINEERING DETAILS

VALVE BOX COLLAR

DATE: WATR 016  
2018/09/21

ENGINEER: GARY E. RAY, P.E.  
REG. NO: 46682  
DATE: 9/26/2021

DESIGNED BY: AL GR  
CHECKED BY: CR GR

FIELD BOOK: 100 North Andrews Avenue, Fort Lauderdale, Florida 33301

CITY OF FORT LAUDERDALE  
PUBLIC WORKS DEPARTMENT  
ENGINEERING & ARCHITECTURE

NO.	DATE	BY (CHKD)	DESCRIPTION

PROJECT # 12412  
PUMP STATION A-16 UPGRADE  
WASTEWATER DESIGN CRITERIA PACKAGE  
STANDARD DETAILS

SHEET NO. 13 OF 31

CAD FILE: 12412-MULTI-DET1  
DRAWING FILE NO. 4-142-31



PREPARED BY:  
**Kimley-Horn**  
© 2021 KIMLEY-HORN AND ASSOCIATES, INC.  
8201 PETERS ROAD, SUITE 2200, PLANTATION, FL 33324  
PHONE: 954-535-5100 FAX: 954-739-2247  
WWW.KIMLEY-HORN.COM REGISTRY NO. 696

DESIGN CRITERIA PACKAGE



Plotted By: Marissa, Marissa - Sheet: PUMP STATION A-16 DESIGN CRITERIA PACKAGE - Layout: DETAIL-15 - September 28, 2021 04:14:27pm - K:\V\U\043 jobs\043184407\_cans 12464-416 ps a-16 rev location\CAD\Drawings\043184407\12412-MULTI-DETL.dwg  
 This document, together with the concepts and designs presented herein, as an instrument of service, is intended only for the specific purpose and client for which it was prepared. Reuse of and improper reliance on this document without written authorization and adaptation by Kimley-Horn and Associates, Inc. shall be without liability to Kimley-Horn and Associates, Inc.

**CITY OF FORT LAUDERDALE**  
OFFICE OF THE CITY ENGINEER

**FORCE MAIN ENTERING MANHOLE**

DATE: FEB'06 SCALE: N.T.S. **P**  
 REVISION: MARCH '09 DRAWN BY: R.C. **408**

NOTES:  
 1. FORCE MAIN TO ENTER MANHOLE AS CLOSE AS POSSIBLE TO 180° TO GRAVITY OUTLET.  
 2. THE INVERT LEVEL OF FORCE MAIN AT POINT OF ENTRY SHALL BE 6" ABOVE INVERT OF MANHOLE.  
 3. CORE ENTRY ONLY INTO EXISTING MANHOLES.  
 4. TRAP TO BE LOCATED PRIOR TO DROP INTO MANHOLE.  
 5. USE TWO 45° ELBOWS PAST TRAP IF ELEVATION DROP IS REQUIRED TO ENTER MANHOLE.  
 6. FLOW CHANNEL REQUIRED.  
 7. MANHOLE TO BE COATED AS SPECIFIED.

**CITY OF FORT LAUDERDALE**  
OFFICE OF THE CITY ENGINEER

**DEAD ENDS**

SIZE	A & B	C	D
4"	18	18	54
6"	18	18	72
8"	18	36	90
10"	18	36	108
12"	18	36	126
14"	18	54	144
16"	18	54	162
18"	18	54	180
20"	18	72	198
24"	18	72	216

NOTE:  
 1. FOR PIPE SIZE OVER 24" SEE SPECIFICATIONS  
 2. ALL JOINTS WITHIN THE CALCULATED LENGTH PLUS THE NEXT JOINT BEYOND THE CALCULATED LENGTH MUST BE RESTRAINED.  
 3. IF THE DISTANCE BETWEEN FITTINGS IS LESS THAN OR EQUAL TO THE CALCULATED RESTRAINT LENGTH, RESTRAIN ALL JOINTS BETWEEN THOSE FITTINGS.

DATE: FEB'06 SCALE: N.T.S. **P**  
 REVISION: MARCH '09 DRAWN BY: R.C. **409**

**MINIMUM RESTRAINED JOINT LENGTH FOR PRESSURE MAINS**

**CITY OF FORT LAUDERDALE**  
OFFICE OF THE CITY ENGINEER

**DEFLECTIONS**

DATE: FEB'06 SCALE: N.T.S. **P**  
 REVISION: MARCH '09 DRAWN BY: R.C. **409**

**MINIMUM RESTRAINED JOINT LENGTH FOR PRESSURE MAINS**

**CITY OF FORT LAUDERDALE**  
OFFICE OF THE CITY ENGINEER

**OFFSETS**

DATE: FEB'06 SCALE: N.T.S. **P**  
 REVISION: MARCH '09 DRAWN BY: R.C. **409**

**MINIMUM RESTRAINED JOINT LENGTH FOR PRESSURE MAINS**

**CITY OF FORT LAUDERDALE**  
OFFICE OF THE CITY ENGINEER

**PIPE SUPPORT**

DATE: FEB'06 SCALE: N.T.S. **PS**  
 REVISION: MARCH '09 DRAWN BY: R.C. **500**

NOTES:  
 1. PROVIDE HALF ROUND RIGID INSULATION AND INSULATION PROTECTION SHIELD, SIMILAR TO GRINNELL FIGURE 167 OR ELCCN FIGURE 219, WHERE PIPING IS INSULATED.  
 2. PROVIDE NEOPRENE WAFFLE ISOLATION PAD, SIMILAR TO MASON TYPE "W" OR KORFUND KORPAD 40, UNDER SUPPORT FOOT WHEN PIPING IS ISOLATED OR SUPPORT IS ADJACENT TO MECHANICAL EQUIPMENT.  
 3. FOR BASE, HEIGHT AND FLANGE DIMENSIONS, SEE TABLE.

PIPE SIZE	DIMENSION TABLE				MIN.	MAX.
	A	B	C	D		
4"	3"	4-1/4"	9"	2-1/2"	9-1/4"	14"
6"	3"	5-1/2"	9"	2-1/2"	10-1/2"	15-1/4"
8"	3"	6-7/8"	9"	2-1/2"	11-3/4"	16-1/2"
10"	3"	8-1/2"	9"	2-1/2"	13-1/2"	18-1/4"
12"	3"	9-15/16"	9"	2-1/2"	15"	19-3/4"

**CITY OF FORT LAUDERDALE**  
OFFICE OF THE CITY ENGINEER

**RESTRAINED COUPLING DETAILS**

TEST PRESSURE	TIE ROD SCHEDULE												
	25 PSI	50 PSI	100 PSI	150 PSI	225 PSI	375 PSI							
PIPE DIAMETER (IN.)	TIE RODS		TIE RODS		TIE RODS		TIE RODS		TIE RODS		TIE RODS		
PIPE WALL THICKNESS (IN.)	TIE RODS		TIE RODS		TIE RODS		TIE RODS		TIE RODS		TIE RODS		
	DIA. (IN.)	NO. REQ'D	DIA. (IN.)	NO. REQ'D	DIA. (IN.)	NO. REQ'D	DIA. (IN.)	NO. REQ'D	DIA. (IN.)	NO. REQ'D	DIA. (IN.)	NO. REQ'D	
6"	3/16	—	—	5/8	2	5/8	2	5/8	2	5/8	2	5/8	2
8"	3/16	—	—	5/8	2	5/8	2	5/8	2	3/4	2	3/4	2
10"	3/16	—	—	5/8	2	5/8	2	3/4	2	7/8	2	7/8	2
12"	3/16	5/8	2	5/8	2	5/8	2	5/8	2	3/4	2	7/8	4

DATE: FEB'06 SCALE: N.T.S. **PS**  
 REVISION: MARCH '09 DRAWN BY: R.C. **501**

**CITY OF FORT LAUDERDALE**  
OFFICE OF THE CITY ENGINEER

**GUARD POST**

DATE: FEB'06 SCALE: N.T.S. **PS**  
 REVISION: MARCH '09 DRAWN BY: R.C. **502**

**CITY OF FORT LAUDERDALE**  
OFFICE OF THE CITY ENGINEER

**PIPE CONCRETE ENCASEMENT**

DATE: FEB'06 SCALE: N.T.S. **PS**  
 REVISION: MARCH '09 DRAWN BY: R.C. **503**

NOTES:  
 1. WHERE MINIMUM COVER, 36", IS NOT AVAILABLE ENCASEMENT WILL BE REQUIRED.  
 2. ALL CONCRETE ENCASEMENTS MUST BE FORMED AND INSPECTED BY THE CITY'S INSPECTOR PRIOR TO PLACING CONCRETE AND BACKFILLING.  
 3. WRAP PIPE IN VISQUEEN PRIOR TO POURING ENCASEMENT.  
 4. AT CROSSINGS, ENCASEMENT SHALL EXTEND TEN FEET (10') ON EITHER SIDE OF CROSSING.  
 5. BEGINNING AND ENDING OF ENCASEMENTS SHALL NOT BE MORE THAN 6" FROM A PIPE JOINT.

**CITY OF FORT LAUDERDALE**  
PUBLIC WORKS DEPARTMENT  
ENGINEERING & ARCHITECTURE  
100 North Andrews Avenue, Fort Lauderdale, Florida 33301

ENGINEER: GARY E. RAY, P.E.  
 REG. NO: 46682  
 DATE: 9/26/2021

DESIGNED BY: AL GR  
 CHECKED BY: GR  
 FIELD BOOK:

DATE: MAR 2021  
 SCALE: AS NOTED

PROJECT # 12412  
 SHEET NO. 15 OF 31  
 CAD FILE: 12412-MULTI-DETL  
 DRAWING FILE NO. 4-142-31

NO.	DATE	BY (CHKD)	DESCRIPTION

**DESIGN CRITERIA PACKAGE**

PROJECT # 12412  
 PUMP STATION A-16 UPGRADE  
 WASTEWATER DESIGN CRITERIA PACKAGE  
 STANDARD DETAILS


SHEET NO. 15 OF 31

CAD FILE: 12412-MULTI-DETL  
 DRAWING FILE NO. 4-142-31


PREPARED BY:  
**Kimley»Horn**  
 © 2021 KIMLEY-HORN AND ASSOCIATES, INC.  
 8201 PETERS ROAD, SUITE 2200, PLANTATION, FL 33324  
 PHONE: 954-535-5100 FAX: 954-739-2247  
 WWW.KIMLEY-HORN.COM REGISTRY No. 696




Plotted By: Marissa, Marissa Street: PUMP STATION A-16 DESIGN CRITERIA PACKAGE Layout: DETAIL-16 September 28, 2021 04:14:32pm K:\V\civil\043 jobs\043184401.cad (12412-MULTI-DET-16) This document, together with the concepts and designs presented herein, is an instrument of service, and its use is limited to the project and site for which it was prepared. It is intended only for the specific purpose and client for which it was prepared. Reuse of any portion of this document without written authorization and adaptation by Kimley-Horn and Associates, Inc. shall be without liability to Kimley-Horn and Associates, Inc.

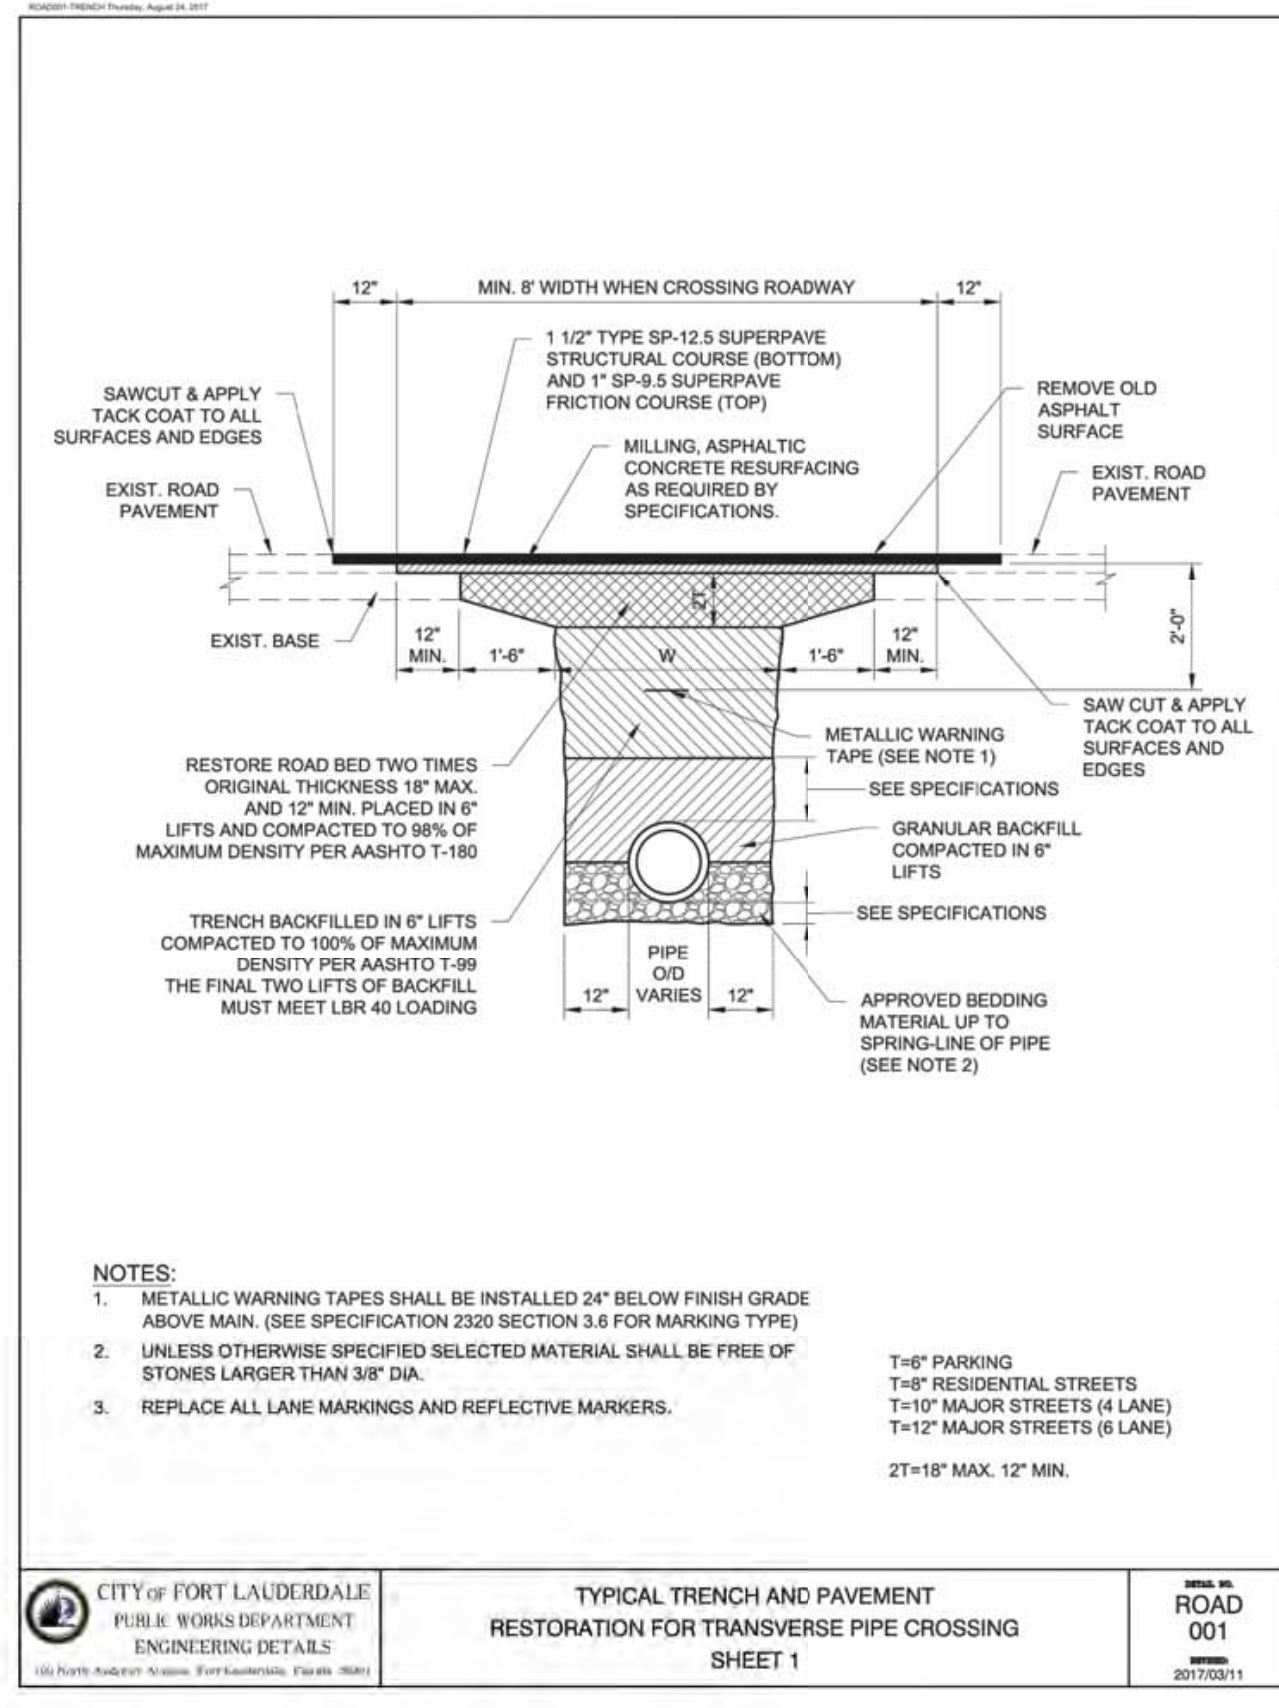


CITY OF FORT LAUDERDALE  
PUBLIC WORKS DEPARTMENT  
ENGINEERING DETAILS  
TYPICAL TRENCH AND PAVEMENT RESTORATION FOR TRANSVERSE PIPE CROSSING  
SHEET 1  
ROAD 001  
20170211

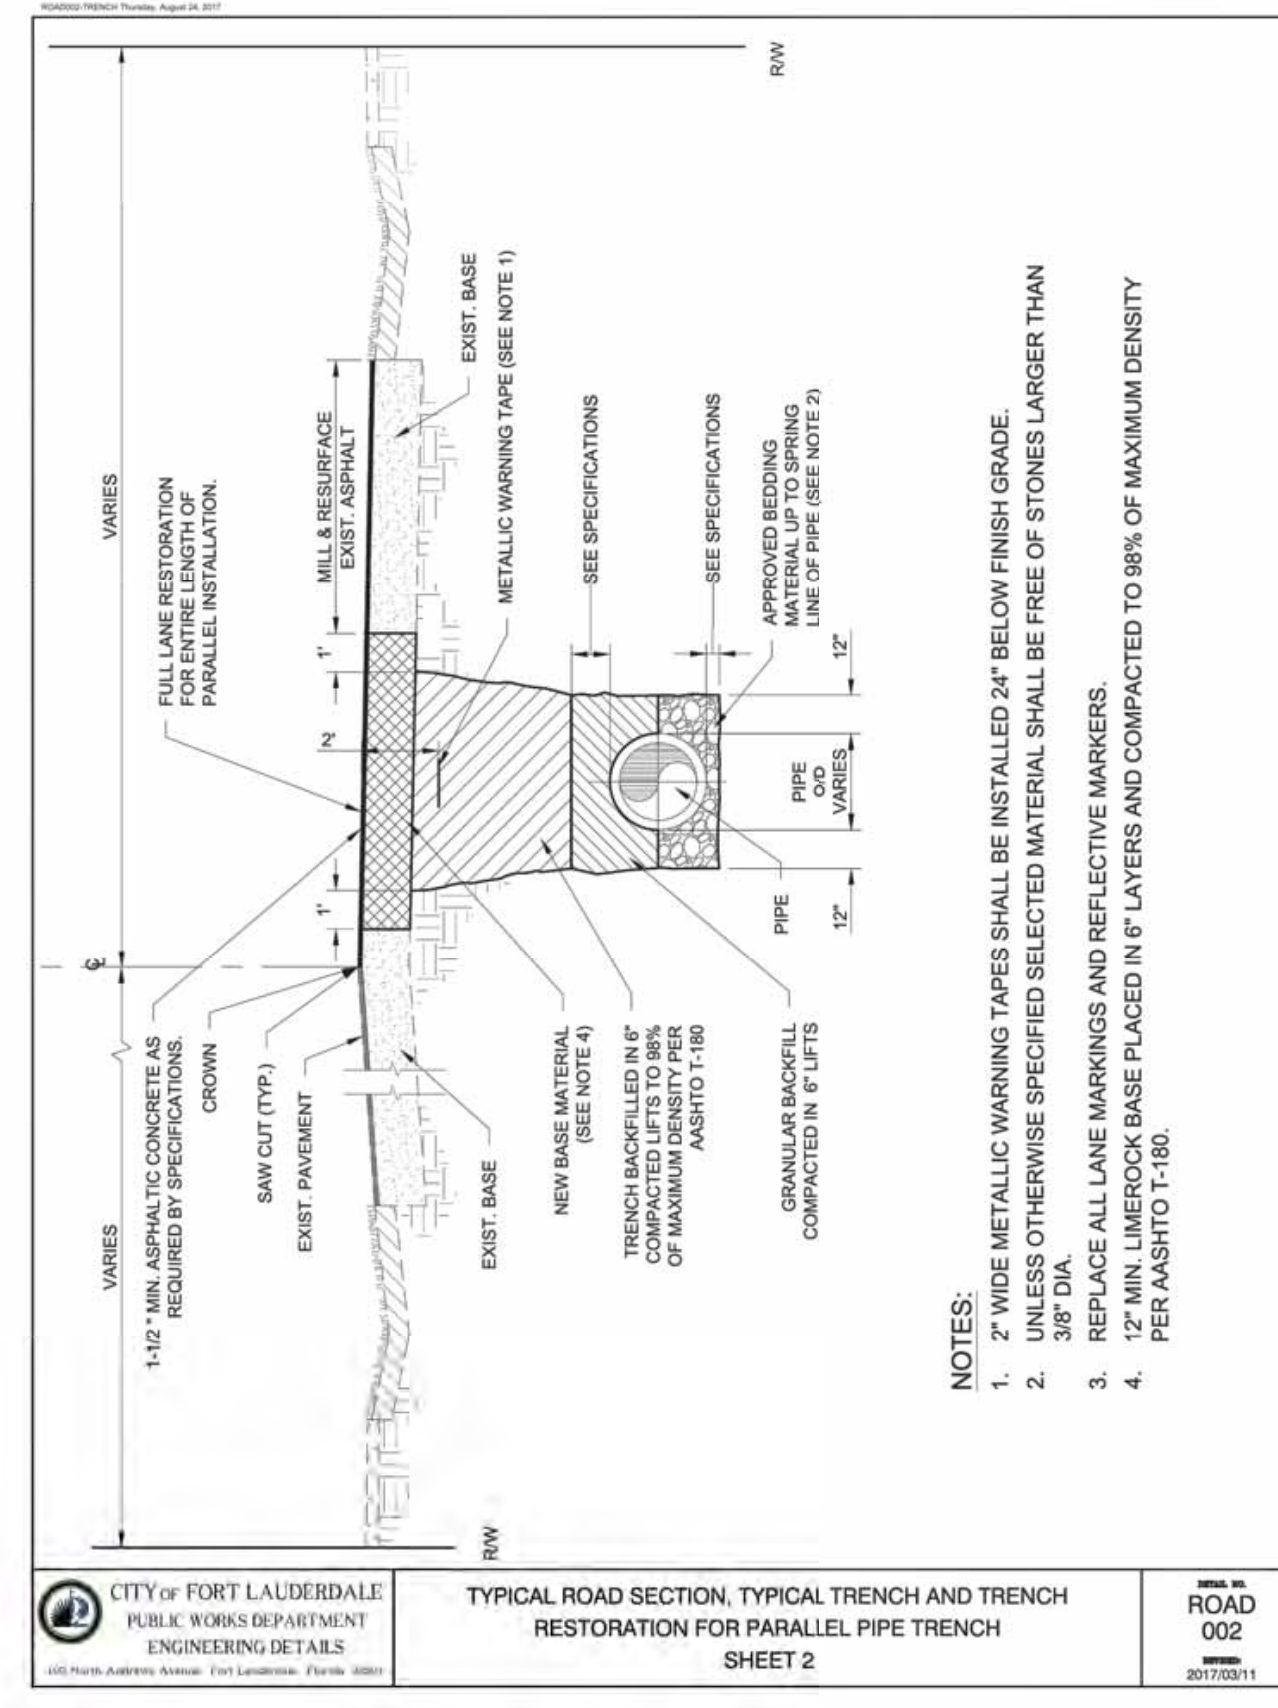


CITY OF FORT LAUDERDALE  
PUBLIC WORKS DEPARTMENT  
ENGINEERING DETAILS  
TYPICAL ROAD SECTION, TYPICAL TRENCH AND TRENCH RESTORATION FOR PARALLEL PIPE TRENCH  
SHEET 2  
ROAD 002  
20170211

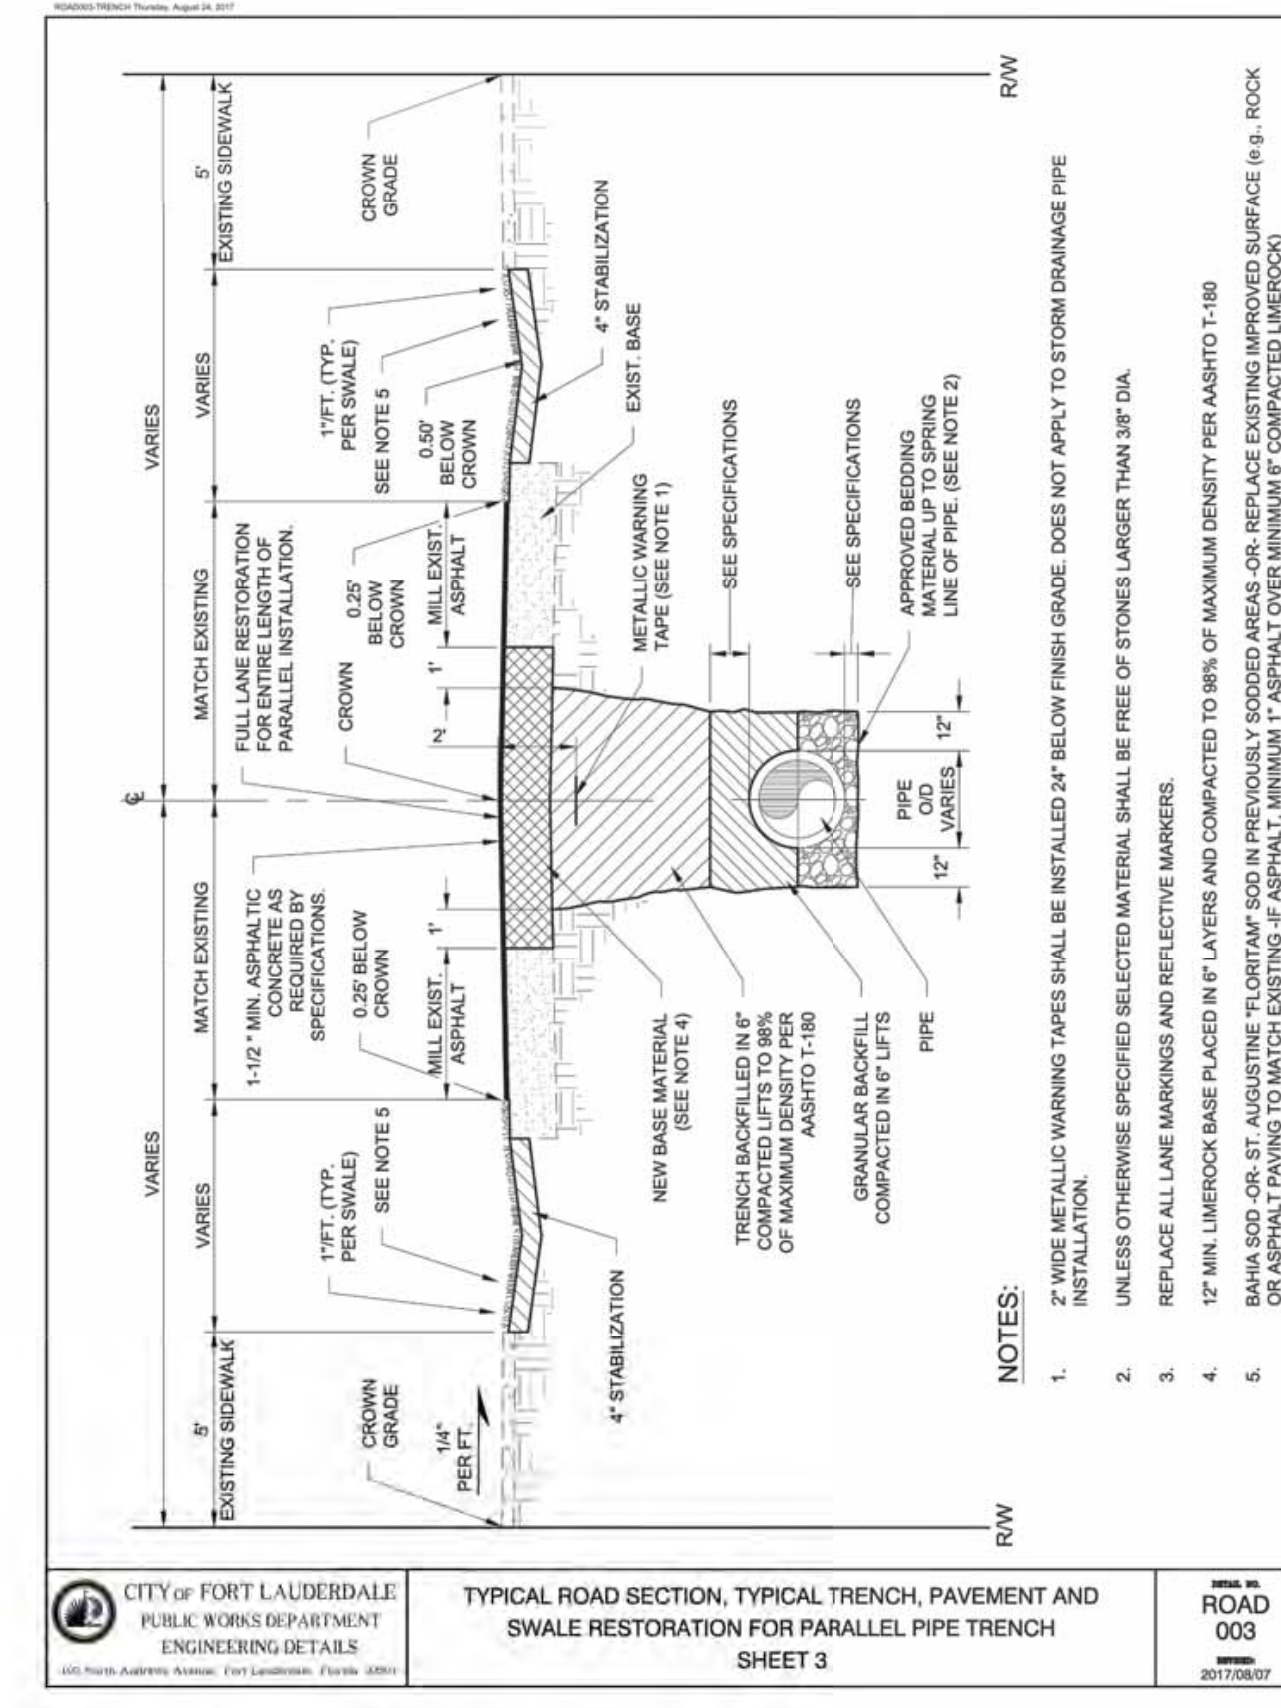


CITY OF FORT LAUDERDALE  
PUBLIC WORKS DEPARTMENT  
ENGINEERING DETAILS  
TYPICAL ROAD SECTION, TYPICAL TRENCH, PAVEMENT AND SWALE RESTORATION FOR PARALLEL PIPE TRENCH  
SHEET 3  
ROAD 003  
20170207

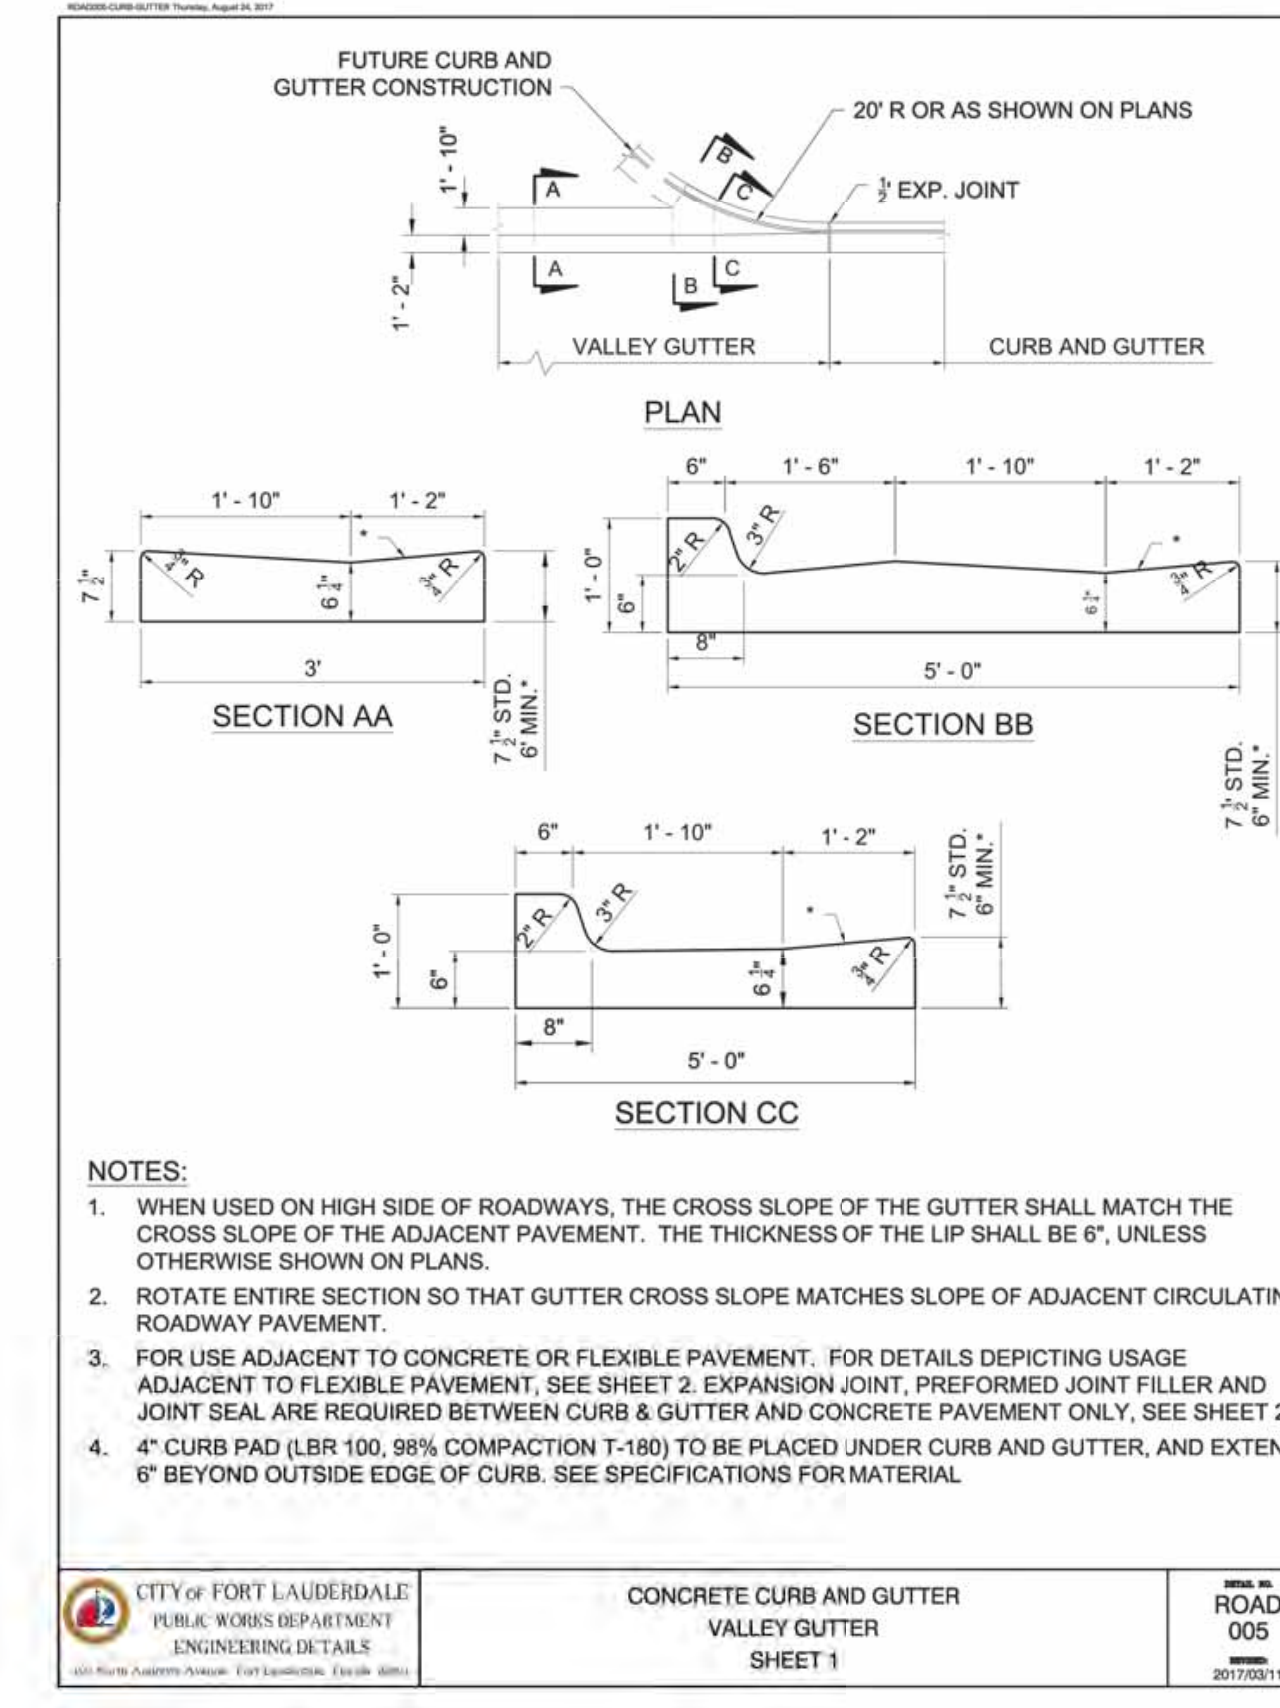


CITY OF FORT LAUDERDALE  
PUBLIC WORKS DEPARTMENT  
ENGINEERING DETAILS  
CONCRETE CURB AND GUTTER VALLEY GUTTER  
SHEET 1  
ROAD 005  
20170211

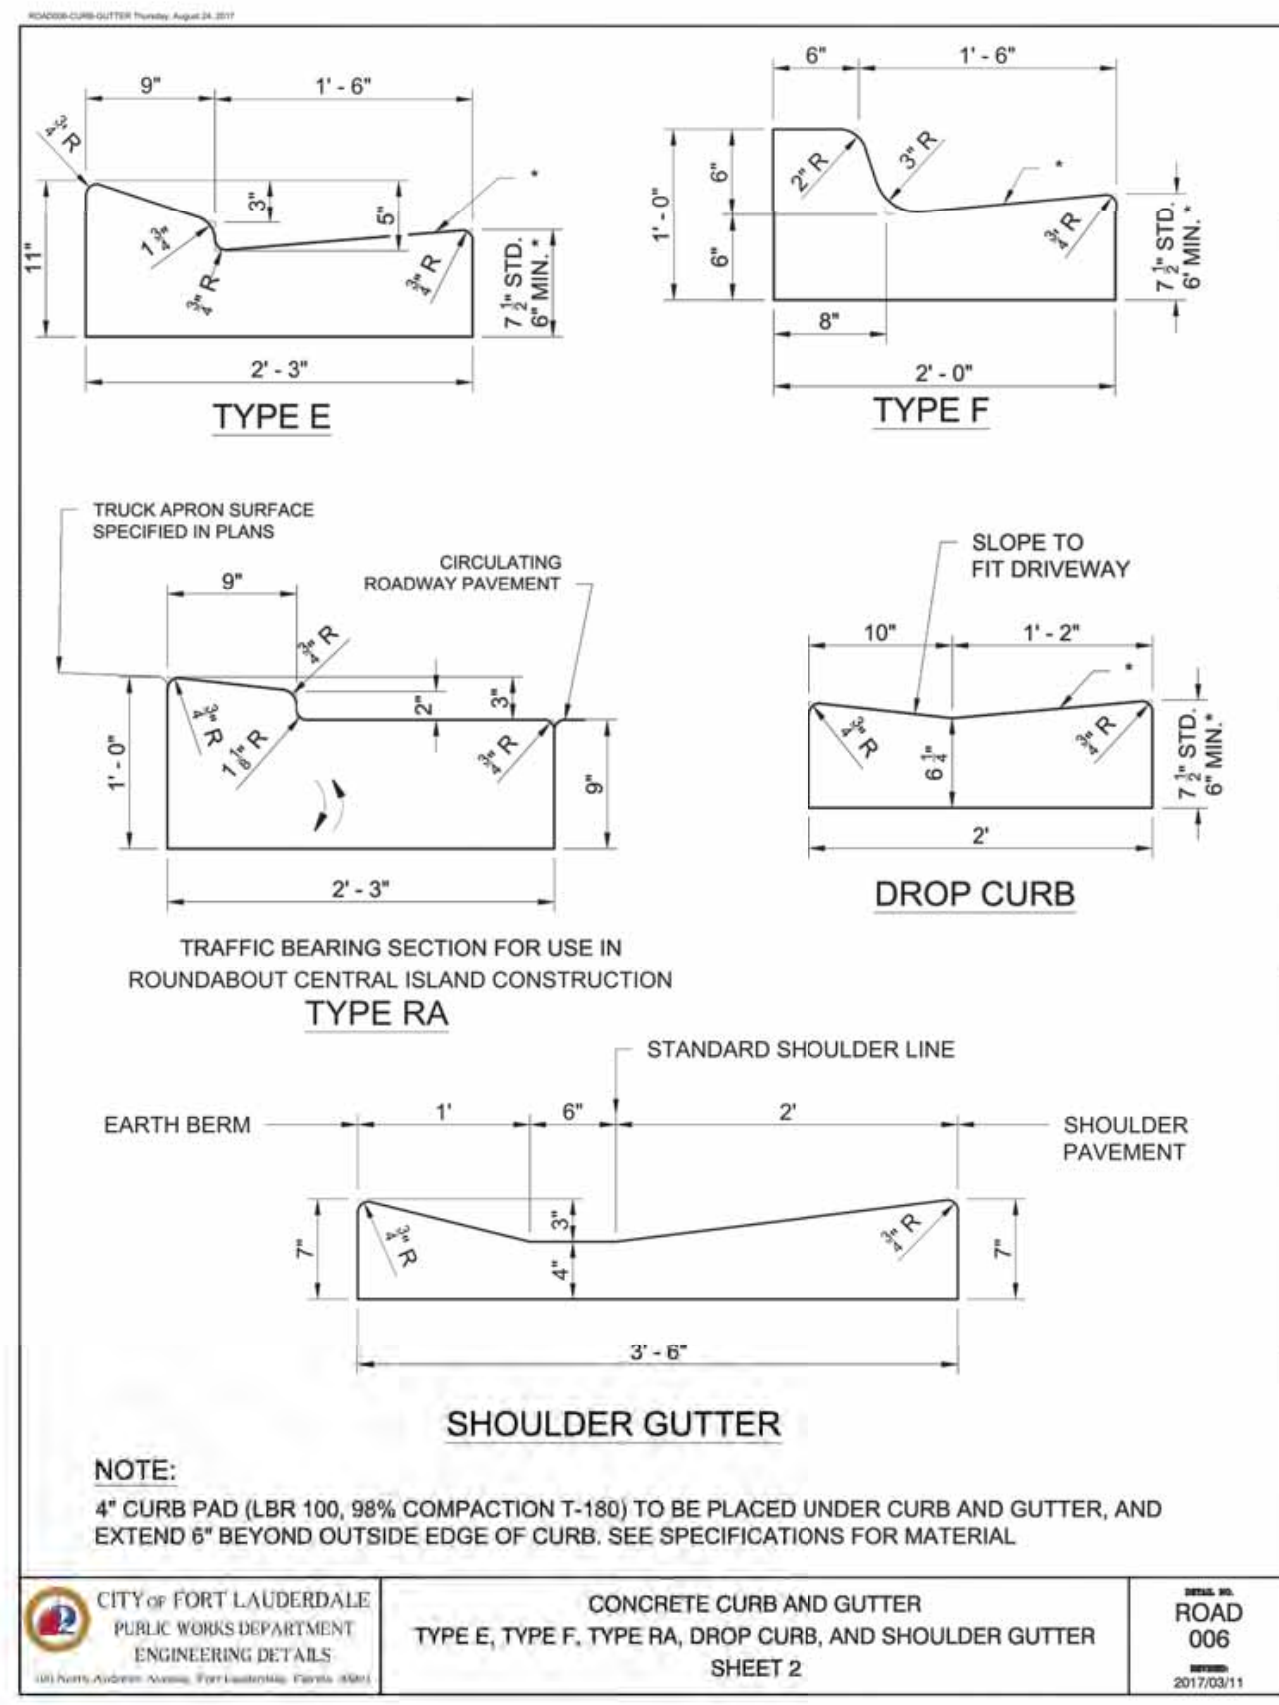


CITY OF FORT LAUDERDALE  
PUBLIC WORKS DEPARTMENT  
ENGINEERING DETAILS  
CONCRETE CURB AND GUTTER TYPE E, TYPE F, TYPE RA, DROP CURB, AND SHOULDER GUTTER  
SHEET 2  
ROAD 006  
20170211

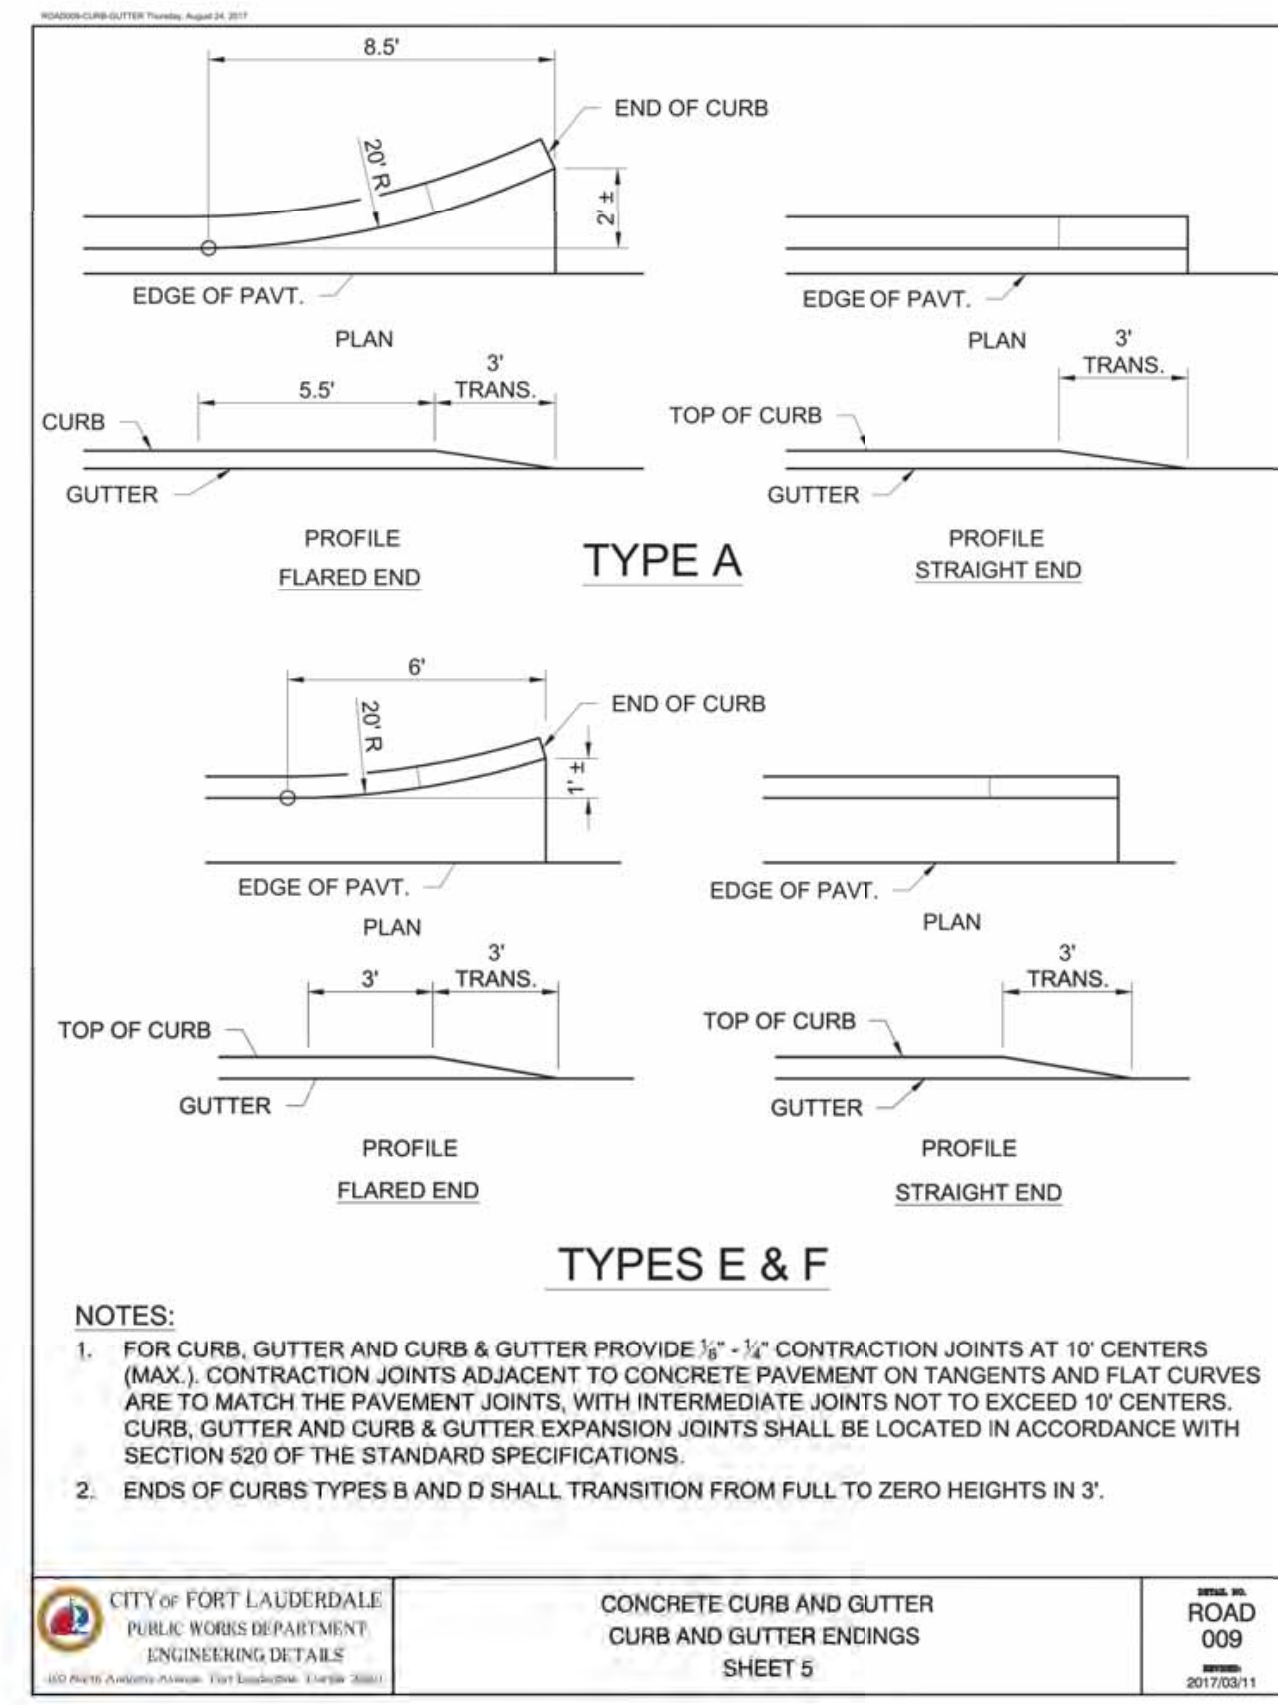

CITY OF FORT LAUDERDALE  
PUBLIC WORKS DEPARTMENT  
ENGINEERING DETAILS  
CONCRETE CURB AND GUTTER CURB AND GUTTER ENDINGS  
SHEET 5  
ROAD 009  
20170211

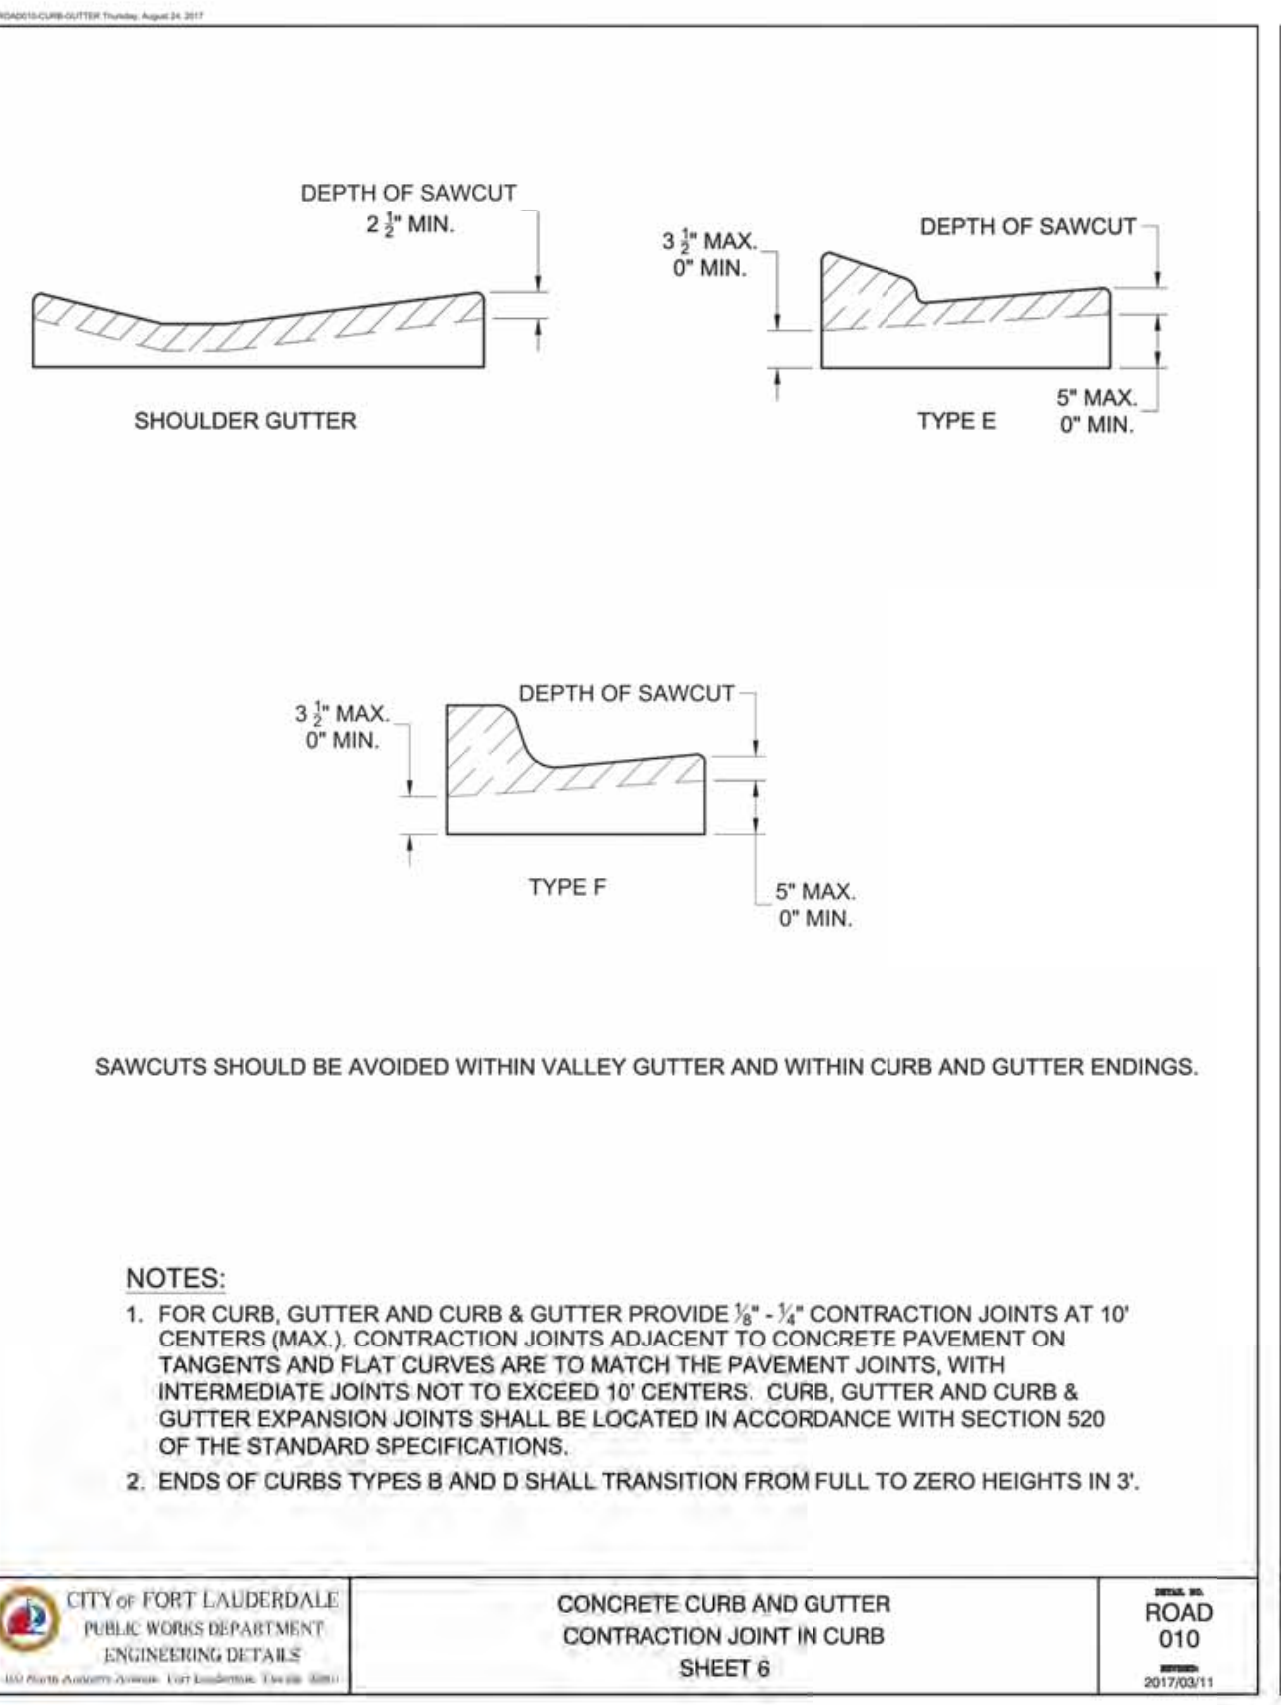

CITY OF FORT LAUDERDALE  
PUBLIC WORKS DEPARTMENT  
ENGINEERING DETAILS  
CONCRETE CURB AND GUTTER CONTRACTION JOINT IN CURB  
SHEET 6  
ROAD 010  
20170211

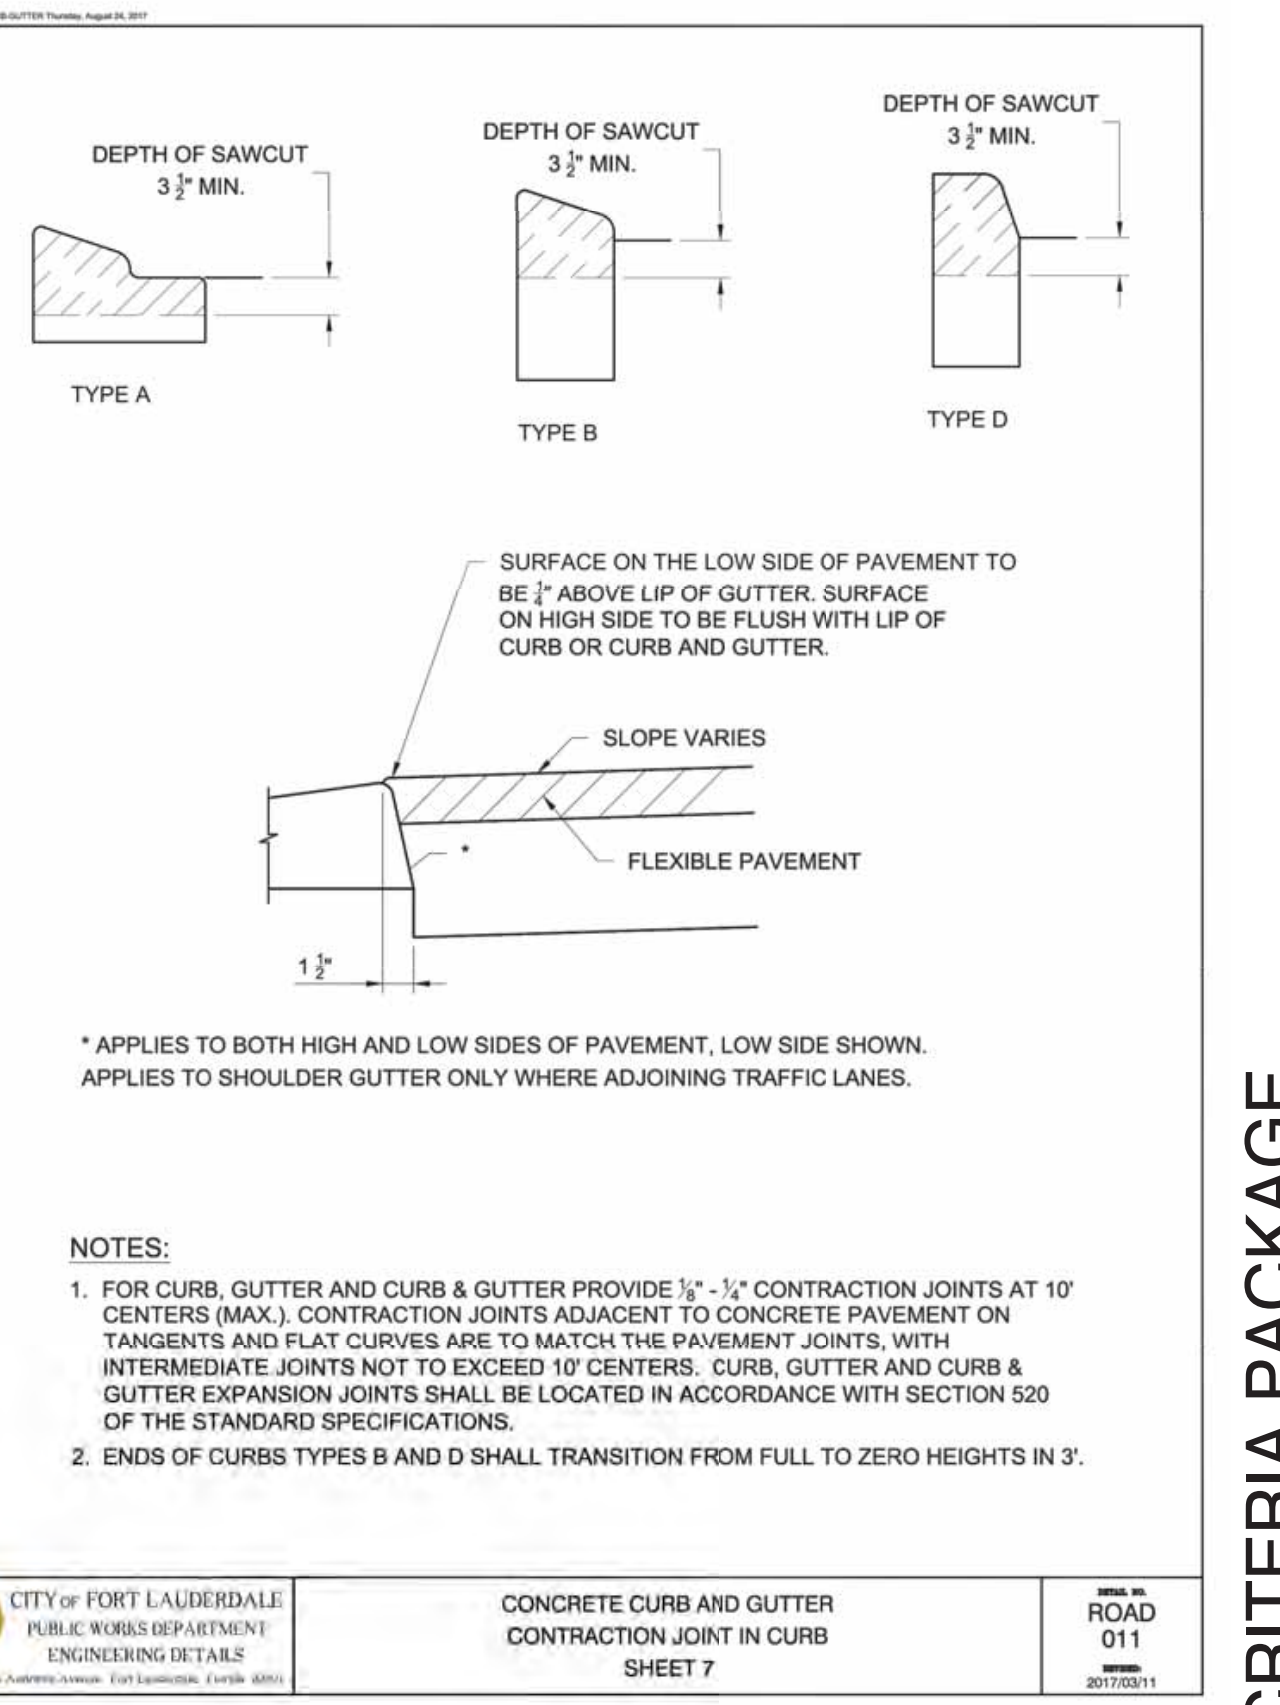

CITY OF FORT LAUDERDALE  
PUBLIC WORKS DEPARTMENT  
ENGINEERING DETAILS  
CONCRETE CURB AND GUTTER CONTRACTION JOINT IN CURB  
SHEET 7  
ROAD 011  
20170211

ENGINEER:  
GARY B. RAY, P.E.  
REG. NO. 46682  
DATE: 9/26/2021

DESIGNED BY: AL  
SCALE: AS NOTED  
CHECKED BY: CR  
FIELD BOOK:

CITY OF FORT LAUDERDALE  
PUBLIC WORKS DEPARTMENT  
ENGINEERING & ARCHITECTURE  
100 North Andrews Avenue, Fort Lauderdale, Florida 33301

NO.	DATE	BY	DESCRIPTION

PROJECT # 12412  
PUMP STATION A-16 UPGRADE  
WASTEWATER DESIGN CRITERIA PACKAGE  
STANDARD DETAILS

SHEET NO. 16 OF 31  
CAD FILE: 12412-MULTI-DET-16  
DRAWING FILE NO. 4-142-31

DESIGN CRITERIA PACKAGE

PREPARED BY:  
**Kimley-Horn**  
© 2021 KIMLEY-HORN AND ASSOCIATES, INC.  
8201 PETERS ROAD, SUITE 2200, PLANTATION, FL 33324  
PHONE: 954-535-5100 FAX: 954-739-2247  
WWW.KIMLEY-HORN.COM REGISTRY No. 696

Plotted By: Marissa Street; Set: PUMP STATION A-16 DESIGN CRITERIA PACKAGE; Layout: DET-17; September 28, 2021 04:14:38pm; K:\V\1\0\1\043 jobs\043184407\_cano 12464-416 ps a-16 rev location\CAD\plan\shades\12412-MULTI-DET-17.dwg; This document, together with the concepts and designs presented herein, as an instrument of service, is intended only for the specific purpose and client for which it was prepared. Reuse of and improper reliance on this document without written authorization and adaptation by Kimley-Horn and Associates, Inc. shall be without liability to Kimley-Horn and Associates, Inc.

**GENERAL NOTES**

- SIDEWALK CURB RAMPS SHALL BE CONSTRUCTED AT LOCATIONS THAT WILL PROVIDE CONTINUOUS UNOBSTRUCTED PEDESTRIAN CIRCULATION PATH TO PEDESTRIAN AREAS, ELEMENTS AND FACILITIES WITHIN THE RIGHT OF WAY AND TO ACCESSIBLE PEDESTRIAN ROUTES ON ADJACENT SITES. CURBED FACILITIES WITH SIDEWALKS AND THOSE WITHOUT SIDEWALKS ARE TO HAVE CURB RAMPS CONSTRUCTED FOR ALL INTERSECTIONS AND TURNS WITH CURBED RETURNS. TO ACCOMMODATE CURB RAMPS, PARTIAL CURB RETURNS ARE TO EXTEND TO THE LIMITS PRESCRIBED IN INDEX NO. 516. RAMPS CONSTRUCTED AT LOCATIONS WITHOUT SIDEWALKS ARE TO HAVE A LANDING CONSTRUCTED AT THE TOP OF EACH RAMP. SEE LANDINGS FOR CURB RAMPS WITHOUT SIDEWALKS.
- WHEN ALTERING EXISTING PEDESTRIAN FACILITIES, WHERE EXISTING RESTRICTED CONDITIONS PRECLUDE THE ACCOMMODATION OF A RAMP SLOPE OF 1:12, A RAMP SLOPE BETWEEN 1:12 AND 1:10 IS PERMITTED FOR A RISE OF 6" MAXIMUM. WHERE COMPLIANCE WITH THE REQUIREMENTS FOR CROSS SLOPE CANNOT BE FULLY MET, THE MINIMUM FEASIBLE CROSS SLOPE SHALL BE PROVIDED. RAMP SLOPES ARE NOT REQUIRED TO EXCEED 19' IN LENGTH.
- IF SIDEWALK CURB RAMPS ARE LOCATED WHERE PEDESTRIANS MUST WALK ACROSS THE RAMP, THEN PROVIDE TRANSITION SLOPES TO THE RAMP. OTHERWISE A SIDEWALK CURB MAY BE REQUIRED.
- ALL SIDEWALKS, RAMPS, AND LANDINGS WITH A CROSS SLOPE OF 0.02 SHOWN IN THIS INDEX ARE 0.02 MAXIMUM. ALL RAMP SLOPES SHOWN IN THIS INDEX AS 1:12 ARE 1:12 MAXIMUM. LANDINGS SHALL HAVE SLOPES LESS THAN OR EQUAL TO 0.02 IN ANY DIRECTION.
- GRADE BREAKS AT THE TOP AND BOTTOM OF RAMPS SHALL BE PARALLEL TO EACH OTHER AND PERPENDICULAR TO THE DIRECTION OF THE RAMP SLOPE.
- WHERE A SIDEWALK CURB RAMP IS CONSTRUCTED WITHIN EXISTING CURB, CURB AND GUTTER AND/OR SIDEWALK, THE EXISTING CURB OR CURB AND GUTTER SHALL BE REMOVED TO THE NEAREST JOINT BEYOND THE CURB TRANSITION OR TO THE EXTENT THAT NO REMAINING SECTION OF CURB OR CURB AND GUTTER IS LESS THAN 5' LONG. EXISTING SIDEWALKS SHALL BE REMOVED TO THE NEAREST JOINT BEYOND THE TRANSITION SLOPE OR TO THE EXTENT THAT NO REMAINING SECTION OF SIDEWALK IS LESS THAN 5' LONG. FOR CONCRETE SIDEWALK DETAILS REFER TO INDEX 310.
- SIDEWALK CURB RAMP ALPHA IDENTIFICATIONS ARE FOR REFERENCE PURPOSES (PLANS, PERMITS, ETC.). ALPHA IDENTIFICATIONS CR1 AND CR2 WERE INTENTIONALLY OMITTED.
- DETECTABLE WARNINGS SHALL EXTEND THE FULL WIDTH OF THE RAMP AND TO A DEPTH OF 2'. DETECTABLE WARNINGS SHALL BE CONSTRUCTED IN ACCORDANCE WITH SPECIFICATION SECTION 527. FOR THE LAYOUT OF DETECTABLE WARNINGS, REFER TO THE TYPICAL PLACEMENT OF DETECTABLE WARNINGS DETAILS. DETECTABLE WARNINGS SHALL NOT BE PROVIDED ON TRANSITION SLOPES.
- WHEN DETECTABLE WARNINGS ARE PLACED ON A SLOPE GREATER THAN 5%, DOMES SHALL BE ALIGNED WITH THE CENTERLINE OF THE RAMP; OTHERWISE DOMES ARE NOT REQUIRED TO BE ALIGNED.
- DETECTABLE WARNINGS SHALL BE REQUIRED ON SIDEWALKS AND SHARED USE PATHS AT:
  - INTERSECTING ROADS
  - MEDIAN CROSSINGS GREATER THAN OR EQUAL TO 6' IN WIDTH
  - RAILROAD CROSSINGS
  - SIGNALIZED DRIVEWAYS
- DETECTABLE WARNINGS - ACCEPTANCE CRITERIA:
  - COLOR AND TEXTURE SHALL BE COMPLETE AND UNIFORM
  - 90% OF INDIVIDUAL TRUNCATED DOMES SHALL BE IN
  - ACCORDANCE WITH THE AMERICANS WITH DISABILITIES ACT STANDARDS FOR TRANSPORTATION FACILITIES, SECTION 705
  - THERE SHALL BE NO MORE THAN 4 NON-COMPLIANT DOMES IN ANY ONE SQUARE FOOT
  - NON-COMPLIANT DOMES SHALL NOT BE ADJACENT TO OTHER NON-COMPLIANT DOMES
  - SURFACES SHALL NOT DEVIATE MORE THAN 6" FROM A TRUE PLANE
- DETECTABLE WARNINGS SHALL BE INSTALLED NO GREATER THAN 9' FROM THE BACK OF CURB OR EDGE OF PAVEMENT.
- DETECTABLE WARNINGS SHALL NOT BE INSTALLED OVER GRADE BREAKS.

**LEGEND**

DETECTABLE WARNINGS

**CITY OF FORT LAUDERDALE**  
PUBLIC WORKS DEPARTMENT  
ENGINEERING DETAILS

**DETECTABLE WARNINGS AND SIDEWALK CURB RAMPS**

ROAD 013  
20170211

**CONCRETE SIDEWALK ON CURBED ROADWAYS**

PLAN  
SIDEWALK WITH UTILITY STRIP

SECTION AA

NOTES FOR CONCRETE SIDEWALK ON CURBED ROADWAYS

- CONSTRUCT SIDEWALKS IN ACCORDANCE WITH SPECIFICATION SECTION 522.
- INCLUDE DETECTABLE WARNINGS ON SIDEWALK CURB RAMPS AND CONSTRUCT IN ACCORDANCE WITH INDEX NO. 304.
- DETECTABLE WARNINGS ARE NOT REQUIRED WHERE SIDEWALKS INTERSECT URBAN FLARED TURNOUTS.
- BOND BREAKER MATERIAL CAN BE ANY IMPERMEABLE COATED OR SHEET MEMBRANE OR PREFORMED MATERIAL HAVING A THICKNESS OF NOT LESS THAN 6 MILS NOR MORE THAN 1/2".
- FOR TURNOUTS SEE INDEX NO. 515.
- CONSTRUCT SIDEWALKS WITH 1" THICK EDGE BEAM THROUGH THE LIMITS OF ANY SURFACE MOUNTED PEDESTRIAN/BICYCLE PICKET RAILING OR PIPE GUIDERAIL SHOWN IN THE PLANS.

**CITY OF FORT LAUDERDALE**  
PUBLIC WORKS DEPARTMENT  
ENGINEERING DETAILS

**CONCRETE SIDEWALK SHEET 1**

ROAD 035  
20170211

**CONCRETE SIDEWALK ON CURBED ROADWAYS**

PLAN  
SIDEWALK WITHOUT UTILITY STRIP

SECTION BB

NOTES FOR CONCRETE SIDEWALK ON CURBED ROADWAYS

- CONSTRUCT SIDEWALKS IN ACCORDANCE WITH SPECIFICATION SECTION 522.
- INCLUDE DETECTABLE WARNINGS ON SIDEWALK CURB RAMPS AND CONSTRUCT IN ACCORDANCE WITH INDEX NO. 304.
- DETECTABLE WARNINGS ARE NOT REQUIRED WHERE SIDEWALKS INTERSECT URBAN FLARED TURNOUTS.
- BOND BREAKER MATERIAL CAN BE ANY IMPERMEABLE COATED OR SHEET MEMBRANE OR PREFORMED MATERIAL HAVING A THICKNESS OF NOT LESS THAN 6 MILS NOR MORE THAN 1/2".
- FOR TURNOUTS SEE INDEX NO. 515.
- CONSTRUCT SIDEWALKS WITH 1" THICK EDGE BEAM THROUGH THE LIMITS OF ANY SURFACE MOUNTED PEDESTRIAN/BICYCLE PICKET RAILING OR PIPE GUIDERAIL SHOWN IN THE PLANS.

**CITY OF FORT LAUDERDALE**  
PUBLIC WORKS DEPARTMENT  
ENGINEERING DETAILS

**CONCRETE SIDEWALK SHEET 2**

ROAD 036  
20170211

**ASPHALT TAPER DETAIL**

1. REPLACE ALL LANE MARKINGS AND REFLECTIVE MARKERS.

**CITY OF FORT LAUDERDALE**  
OFFICE OF THE CITY ENGINEER

ENGINEER: GARY E. RAY, P.E.  
REG. NO: 46682  
DATE: 9/29/2021

DESIGNED BY: AL  
CHECKED BY: GR  
FIELD BOOK: 100

DATE: FEB'06  
REVISION: MARCH '09

SCALE: N.T.S.  
DRAWN BY: R.C.

**101**

**HOSE BIB**

DATE: FEB'08  
REVISION: MARCH '09

SCALE: N.T.S.  
DRAWN BY: R.C.

**961**

**RESTORATION OF PAVEMENT UTILITIES INSTALLATION CROSSING**

DATE: APRIL'04  
REVISION: MARCH '09

SCALE: N.T.S.  
DRAWN BY:

**4.11**  
2 of 2

**RESTORATION OF PAVEMENT UTILITIES INSTALLATION PARALLEL**

DATE: APRIL'04  
REVISION: MARCH '09

SCALE: N.T.S.  
DRAWN BY:

**4.12**



PREPARED BY:  
**Kimley-Horn**

© 2021 KIMLEY-HORN AND ASSOCIATES, INC.  
8201 PETERS ROAD, SUITE 2200, PLANTATION, FL 33324  
PHONE: 954-535-5100 FAX: 954-739-2247  
WWW.KIMLEY-HORN.COM REGISTRY No. 696

**DESIGN CRITERIA PACKAGE**

**PROJECT # 12412**  
**PUMP STATION A-16 UPGRADE**  
**WASTEWATER DESIGN CRITERIA PACKAGE**  
**STANDARD DETAILS**

SHEET NO. 17 OF 31  
CAD FILE: 12412-MULTI-DET  
DRAWING FILE NO. 4-142-31

NO.	DATE	BY (CHKD)	DESCRIPTION

**CITY OF FORT LAUDERDALE**  
PUBLIC WORKS DEPARTMENT  
ENGINEERING & ARCHITECTURE

100 North Andrews Avenue, Fort Lauderdale, Florida 33301

GRAN BY: AL  
DESIGNED BY: GR  
CHECKED BY: GR  
FIELD BOOK: 100

DATE: MAR 2021  
SCALE: AS NOTED

DATE: 9/29/2021

TEL: (954) 436-5100  
FAX:



This document, together with the concepts and designs presented herein, is intended only for the specific purpose and client for which it was prepared. Reuse of and improper reliance on this document without written authorization and adaptation by Kinney-Horn and Associates, Inc. shall be without liability to Kinney-Horn and Associates, Inc.

PLAN SYMBOLS	PLAN SYMBOLS (CONTINUED)	CONTROL DIAGRAM SYMBOLS	ABBREVIATIONS	NOTES
HOME RUN TO PANELBOARD. NO. OF ARROWS INDICATE NO. OF CIRCUITS, HASH MARKS INDICATE NO. OF #12 AWG. CONDUCTORS. NO HASH MARKS INDICATE 2 #12 CONDUCTORS. CONDUIT CONCEALED IN WALL, IN SLAB ABOVE, OR ABOVE CEILING CONDUIT CONCEALED IN OR BELOW FLOOR OR UNDERGROUND. CONDUIT RUN EXPOSED. RUN PARALLEL OR PERPENDICULAR TO STRUCTURE OR WALL. FLEXIBLE CONDUIT WITH EQUIPMENT CONNECTION. CONDUIT ROUTING ENVELOPE (CONCRETE ENCASED DUCTBANK). WALL MOUNTED LED LIGHTING FIXTURE. LED LIGHTING FIXTURE, CEILING MOUNTED. EXTERIOR LED LUMINAIRE AND MOUNTING STANDARD. EXISTING EXTERIOR LIGHTING. EMERGENCY BATTERY PACK LIGHTING FIXTURE. JUNCTION BOX N.E.C. SURFACE MOUNTED UNLESS INDICATED OTHERWISE. JUNCTION BOX PER N.E.C., NEMA 4X 316 SSS, FLUSH MOUNTED UNLESS INDICATED OTHERWISE. MOTOR JUNCTION BOX, NEMA 4X 316 SS JUNCTION BOX, 12" X 12" X 6" MINIMUM SIZE ENLARGE IF REQUIRED PER N.E.C. FLUSH OR SURFACE MOUNTED LIGHTING PANELBOARD. FLUSH OR SURFACE MOUNTED POWER PANELBOARD. DRY TYPE TRANSFORMER. NO. INDICATES KVA RATING. LIQUID FILLED TRANSFORMER, KVA RATING AS SHOWN FLUSH MOUNTED RECEPTACLE WITH USB OUTLET 20A, 125V, 3W DUPLEX RECEPTACLE IN FLUSH OUTLET BOX, 18" ABOVE FINISHED FLOOR. 20A, 125V, 3W GFI DUPLEX RECEPTACLE IN FLUSH OUTLET BOX, 48" ABOVE FINISHED FLOOR OR 6" ABOVE FINISHED COUNTER AS REQUIRED (AFC) 20A, 125V, 3W DUPLEX RECEPTACLE, SURFACE MOUNTED. SURFACE MOUNTED GROUND FAULT DUPLEX WEATHERPROOF RECEPTACLE 20A, 125V, 3W - MOUNTED 48" ABOVE FINISHED FLOOR, UNLESS OTHERWISE NOTED. 20A, 125V, 3W DOUBLE DUPLEX RECEPTACLE IN FLUSH OUTLET BOX. FLUSH MOUNTED GROUND FAULT WEATHERPROOF DUPLEX RECEPTACLE 20A, 125V, 3W - MOUNTED 48" ABOVE FINISHED FLOOR. FLUSH MOUNTED GFI WP DUPLEX RECEPTACLE WITH COVER RATED NEMA 4 WHILE IN USE. DISCONNECT RACK MOUNTED. OFF REMOTE/DISCONNECT RACK MOUNTED WITH JUNCTION BOX MOUNTED BELOW OFF REMOTE. NEMA 3R SS UNLESS OTHERWISE NOTED. SINGLE POLE SWITCH IN FLUSH OUTLET BOX, 48" ABOVE FINISHED FLOOR, UNLESS OTHERWISE NOTED (TYPICAL). SINGLE POLE SWITCH, SURFACE MOUNTED. THREE-WAY SWITCH IN FLUSH OUTLET BOX. FOUR-WAY SWITCH IN FLUSH OUTLET BOX. NON-FUSIBLE DISCONNECT SWITCH, 30A, 3P NEMA 4X 316 SS UNLESS OTHERWISE INDICATED. NON-FUSIBLE DISCONNECT SWITCH, 30A, 3P UNLESS OTHERWISE INDICATED, WITH REMOTE CONTROL STATION AS REQUIRED BY ELEMENTARY DIAGRAMS OR SPECS. ELECTRIC A.C. MOTOR, NO. INDICATES HORSEPOWER. FUSED DISCONNECT SWITCH(30/20: 30=SWITCH RATING, 20=FUSE RATING) 3 POLE-UNLESS NOTED OTHERWISE. MOTORIZED VALVE COMBINATION MOTOR STARTER, DISCONNECT SWITCH VARIABLE FREQUENCY DRIVE THERMOSTAT ELECTRIC HEATER	CONTROL PULLBOX. SEE "PULL BOX DETAIL" POWER MANHOLE. SEE "MANHOLE DETAIL" FLOW SWITCH FLOW ELEMENT LEVEL ELEMENT LIMIT SWITCH SEAL FAIL LIQUID LEVEL SWITCH VIBRATION SWITCH ANALYSIS INDICATING TRANSMITTER FLOW INDICATING TRANSMITTER LEVEL INDICATING TRANSMITTER TEMPERATURE SWITCH SPACE HEATER ANALYTICAL ELEMENT PRESSURE INDICATING TRANSMITTER  <b>SINGLE LINE DIAGRAM SYMBOLS</b> COMBINATION MOTOR STARTER GROUND FAULT INTERRUPTER FUSE CAPACITOR MOLDED CASE CIRCUIT BREAKER TYPICAL SELECTOR SWITCH AND CONTROL. SEE ELEMENTARY DIAGRAMS FOR EXACT TYPE. ELECTRIC A.C. MOTOR, NO. INDICATES HORSEPOWER. SERVICE OR EQUIPMENT GROUND. NON-FUSIBLE DISCONNECT SWITCH, 30A, 3P UNLESS OTHERWISE INDICATED. NON-FUSIBLE DISCONNECT SWITCH, 30A, 3P UNLESS OTHERWISE INDICATED, WITH REMOTE CONTROL STATION AS REQUIRED BY ELEMENTARY DIAGRAMS OR SPECS. CROUSE HINDS EYSR FITTING w/CHICO SPEED SEAL COMPOUND LIGHTING PANELBOARD POWER PANELBOARD. CURRENT TRANSFORMERS POTENTIAL TRANSFORMERS. NEMA 4X 316 STAINLESS STEEL TERMINATION CABINET. TEMPERATURE SWITCH SEAL FAIL SWITCH PRESSURE INDICATING TRANSMITTER HIGH LEVEL FLOAT FLOW INDICATING TRANSMITTER FLOW ELEMENT	NORMALLY OPEN CONTACT NORMALLY CLOSED CONTACT LIMIT SWITCH, NORMALLY OPEN LIMIT SWITCH, NORMALLY CLOSED PRESSURE SWITCH, NORMALLY OPEN PRESSURE SWITCH, NORMALLY CLOSED FLOAT SWITCH, NORMALLY OPEN FLOAT SWITCH, NORMALLY CLOSED FLOW SWITCH, NORMALLY OPEN FLOW SWITCH, NORMALLY CLOSED TEMPERATURE SWITCH, NORMALLY OPEN TEMPERATURE SWITCH, NORMALLY CLOSED NORMALLY OPEN, TIMED TO CLOSE CONTACT NORMALLY CLOSED, TIMED TO OPEN CONTACT NORMALLY CLOSED, TIMED TO CLOSE CONTACT NORMALLY OPEN, TIMED TO OPEN CONTACT LIMIT SWITCH FLOW SWITCH PRESSURE SWITCH SOLENOID VALVE LIQUID LEVEL SWITCH VIBRATION SWITCH SMOKE DETECTOR ALARM RELAY ALARM TIMER CONTROL RELAY MOTOR STARTER TIMING RELAY TORQUE SWITCH ALARM INDICATING LIGHT RUN INDICATING LIGHT MOMENTARY CONTACT PUSHBUTTON MOMENTARY BREAK PUSHBUTTON OR RESET KEYED SWITCH MAINTAINED CONTACT ON-OFF SWITCH START/STOP(S/S) CONTROL SWITCH MAINTAINED CONTACT THREE POSITION MAINTAINED CONTACT SELECTOR SWITCH FUSE MOLDED CASE CIRCUIT BREAKER CONTROL POWER TRANSFORMER REMOTE TERMINAL BLOCK POINT	<p>A AMPERES  AC AIR CONDITIONER  AFF ABOVE FINISHED FLOOR  AIC AMPS INTERRUPTING CURRENT BREAKER  BKR BREAKER  BLDG BUILDING  CP CONTROL PANEL  CPT CONTROL POWER TRANSFORMER  CU CONDENSING UNIT  CT CURRENT TRANSFORMER  DB DIGESTER BLOWER  DE DUKE ENERGY  EEB EAST ELECTRICAL BUILDING  EFF EFFLUENT  ELEC ELECTRICAL  EM EMERGENCY  ENCL ENCLOSURE  ETM ELAPSED TIME METER  EUH ELECTRIC UNIT HEATER  EXH EXHAUST  FPL FLORIDA POWER &amp; LIGHT  FTC FLOAT CABLE TERMINATION CABINET  FVNR FULL VOLTAGE NON-REVERSING GENERATOR  GFR GROUND FAULT RECEPTACLE  GFI GROUND FAULT INTERRUPTER  GND GROUND  GRS GALVANIZED RIGID STEEL  HOA HAND-OFF-AUTOMATIC  HOR HAND-OFF-REMOTE  HP HORSEPOWER  JB JUNCTION BOX  KVA KILO VOLT-AMPERES  KW KILOWATT  LCP LOCAL CONTROL PANEL  LP LOOP NUMBER  LOP LOCAL OPERATOR PANEL  LTG LIGHTING  MAX MAXIMUM  MCB MAIN CIRCUIT BREAKER  MIN MINIMUM  MLO MAIN LUGS ONLY  MSC MANUFACTURER SUPPLIED CABLE  MTD MOUNTED  N NEUTRAL  NEC NATIONAL ELECTRICAL CODE  NTS NOT TO SCALE  OH OVERHEAD  P POLE  PM PHASE MONITOR  PS PUMP STATION  PSCP PUMP STATION CONTROL PANEL  SH SHIELDED  SPD SURGE PROTECTION DEVICE  SS STAINLESS STEEL  SSS SOLID STATE STARTER  STR STARTER  SW SWITCH  TC TERMINATION CABINET  TYP TYPICAL  UG UNDERGROUND  UPS UNINTERRUPTABLE POWER SUPPLY  V VOLT  VFD VARIABLE FREQUENCY DEVICE  WEB WEST ELECTRICAL BUILDING  W WATT  W/ WITH  WP WEATHERPROOF  XFMR TRANSFORMER  Φ PHASE</p>	<ol style="list-style-type: none"> <li>ELECTRICAL CONTRACTOR SHALL SUPPLY AND INSTALL ALL NEW ELECTRICAL WORK INDICATED.</li> <li>ELECTRICAL CONTRACTOR SHALL VISIT JOB SITE AND FAMILIARIZE HIMSELF WITH ALL CONDITIONS AFFECTING ELECTRICAL INSTALLATION AND MAKE PROVISIONS AS TO THE COST THEREOF. EXISTING CONDITIONS OF ELECTRICAL EQUIPMENT, LIGHT FIXTURES, ETC., THAT ARE PART OF THE FINAL SYSTEM SHALL BE VERIFIED BY THE CONTRACTOR PRIOR TO SUBMITTING HIS BID.</li> <li>ALL WORK SHALL BE DONE IN ACCORDANCE WITH THE 2017 NATIONAL ELECTRICAL CODE, 2020 FLORIDA BUILDING CODE, 2014 NATIONAL FIRE PROTECTION ASSOCIATION AND SHALL COMPLY WITH ALL LOCAL RULES AND ORDINANCES.</li> <li>MINIMUM WIRE SIZE SHALL BE #12 A.W.G. EXCLUDING CONTROL WIRING, UNLESS OTHERWISE NOTED.</li> <li>IT IS NOT THE INTENT OF THESE PLANS TO SHOW EVERY MINOR DETAIL OF CONSTRUCTION. THE CONTRACTOR IS EXPECTED TO FURNISH AND INSTALL ALL ITEMS FOR A COMPLETE ELECTRICAL SYSTEM AND PROVIDE ALL REQUIREMENTS NECESSARY FOR THE EQUIPMENT TO BE PLACED IN PROPER WORKING ORDER.</li> <li>ELECTRICAL SYSTEM SHALL BE COMPLETE AND EFFECTIVELY GROUNDED AS REQUIRED BY THE LATEST EDITION OF THE N.E.C. OR LOCAL CODES. ALL CONDUITS SHALL HAVE A BOND WIRE SIZED PER TABLE 250-122 OF THE NATIONAL ELECTRICAL CODE.</li> <li>ALL MATERIALS SHALL BE NEW AND BEAR UNDERWRITERS' LABELS WHERE APPLICABLE.</li> <li>ALL WORK SHALL BE PERFORMED BY A LICENSED ELECTRICAL CONTRACTOR IN A FIRST CLASS WORKMANLIKE MANNER. THE COMPLETED SYSTEM SHALL BE FULLY OPERATIVE AND ACCEPTED BY ENGINEER/OWNER.</li> <li>CONTRACTOR SHALL GUARANTEE ALL MATERIALS AND WORKMANSHIP FREE FROM DEFECTS FOR A PERIOD OF NOT LESS THAN TWO YEARS FROM DATE OF ACCEPTANCE.</li> <li>CORRECTION OF ANY DEFECTS SHALL BE COMPLETED WITHOUT ADDITIONAL CHARGE AND SHALL INCLUDE REPLACEMENT OR REPAIR OF ANY OTHER PHASE OF THE INSTALLATION WHICH MAY HAVE BEEN DAMAGED.</li> <li>THE ELECTRICAL INSTALLATION SHALL MEET ALL STANDARD REQUIREMENTS OF THE F.P.L. SEE 16050 FOR ADDITIONAL INFORMATION.</li> <li>CONTRACTOR SHALL BE RESPONSIBLE FOR ALL CUTTING AND PATCHING REQUIRED OF HIS WORK.</li> <li>ELECTRICAL CONTRACTOR SHALL LABEL ALL PANELS W/ TYPE WRITTEN DIRECTORIES (NEW &amp; EXISTING).</li> <li>DO NOT SCALE THE ELECTRICAL DRAWINGS. REFER TO THE MECHANICAL DRAWINGS &amp; THE APPROVED MANUFACTURER'S SHOP DRAWINGS FOR THE EXACT LOCATION OF ALL EQUIPMENT.</li> <li>NON-SHADED TEXT DENOTES NEW EQUIPMENT, STRUCTURES AND WORK. SHADED AND SLANTED TEXT DENOTES EXISTING EQUIPMENT OR STRUCTURES.</li> <li>ALL CONTROL PANELS SHALL BE UL LISTED AND SHALL COMPLY WITH ARTICLE 409 OF THE NEC.</li> <li>ALL EMPTY CONDUITS SHALL BE INSTALLED WITH PULL STRING.</li> </ol>

ERIC HAMMOND, P.E.  
FL LICENSE # PE9048  
DRAWN BY: H.A. DATE: 04/09/2021  
DESIGNED BY: H.A. SCALE: AS NOTED  
CHECKED BY: E.H.  
FIELD BOOK: 33301

**CITY OF FORT LAUDERDALE**  
**PUBLIC WORKS DEPARTMENT**  
**ENGINEERING & ARCHITECTURE**  
100 North Andrews Avenue, Fort Lauderdale, Florida 33301

NO.	DATE	BY	CHKD	DESCRIPTION


**DESIGN CRITERIA PACKAGE**  
PROJECT # 12412  
PUMP STATION A-16 UPGRADE  
WASTEWATER DESIGN CRITERIA PACKAGE  
ELECTRICAL NOTES, SYMBOLS AND  
ABBREVIATIONS

SHEET NO.	OF
19	31
CAD FILE:	12412-19-LGND
DRAWING FILE NO.	4-142-31

HAMMOND & ASSOCIATES, INC.  
CONSULTING ENGINEERS  
499 NW 70TH AVE. SUITE 201  
PLANTATION, FLORIDA 33317  
TEL: (954) 327-7111 FAX (954) 327-7154  
ERIC J. HAMMOND P.E.  
MECHANICAL / ELECTRICAL ENGINEER  
P.E. #39048  
EB 5315



Plotted By: Olga Litvinskaya Sheet Set: #12412-20-SITE.dwg M:\ACAD\_DWG\Site\12412-20-SITE.dwg Layout: E20 September 28, 2021 04:48:45pm  
 This document, together with the concepts and designs presented herein, is an instrument of service, is intended only for the specific purpose and client for which it was prepared. Reuse or improper reliance on this document without written authorization and adaptation by Kimberly-Horn and Associates, Inc. shall be without liability to Kimberly-Horn and Associates, Inc.

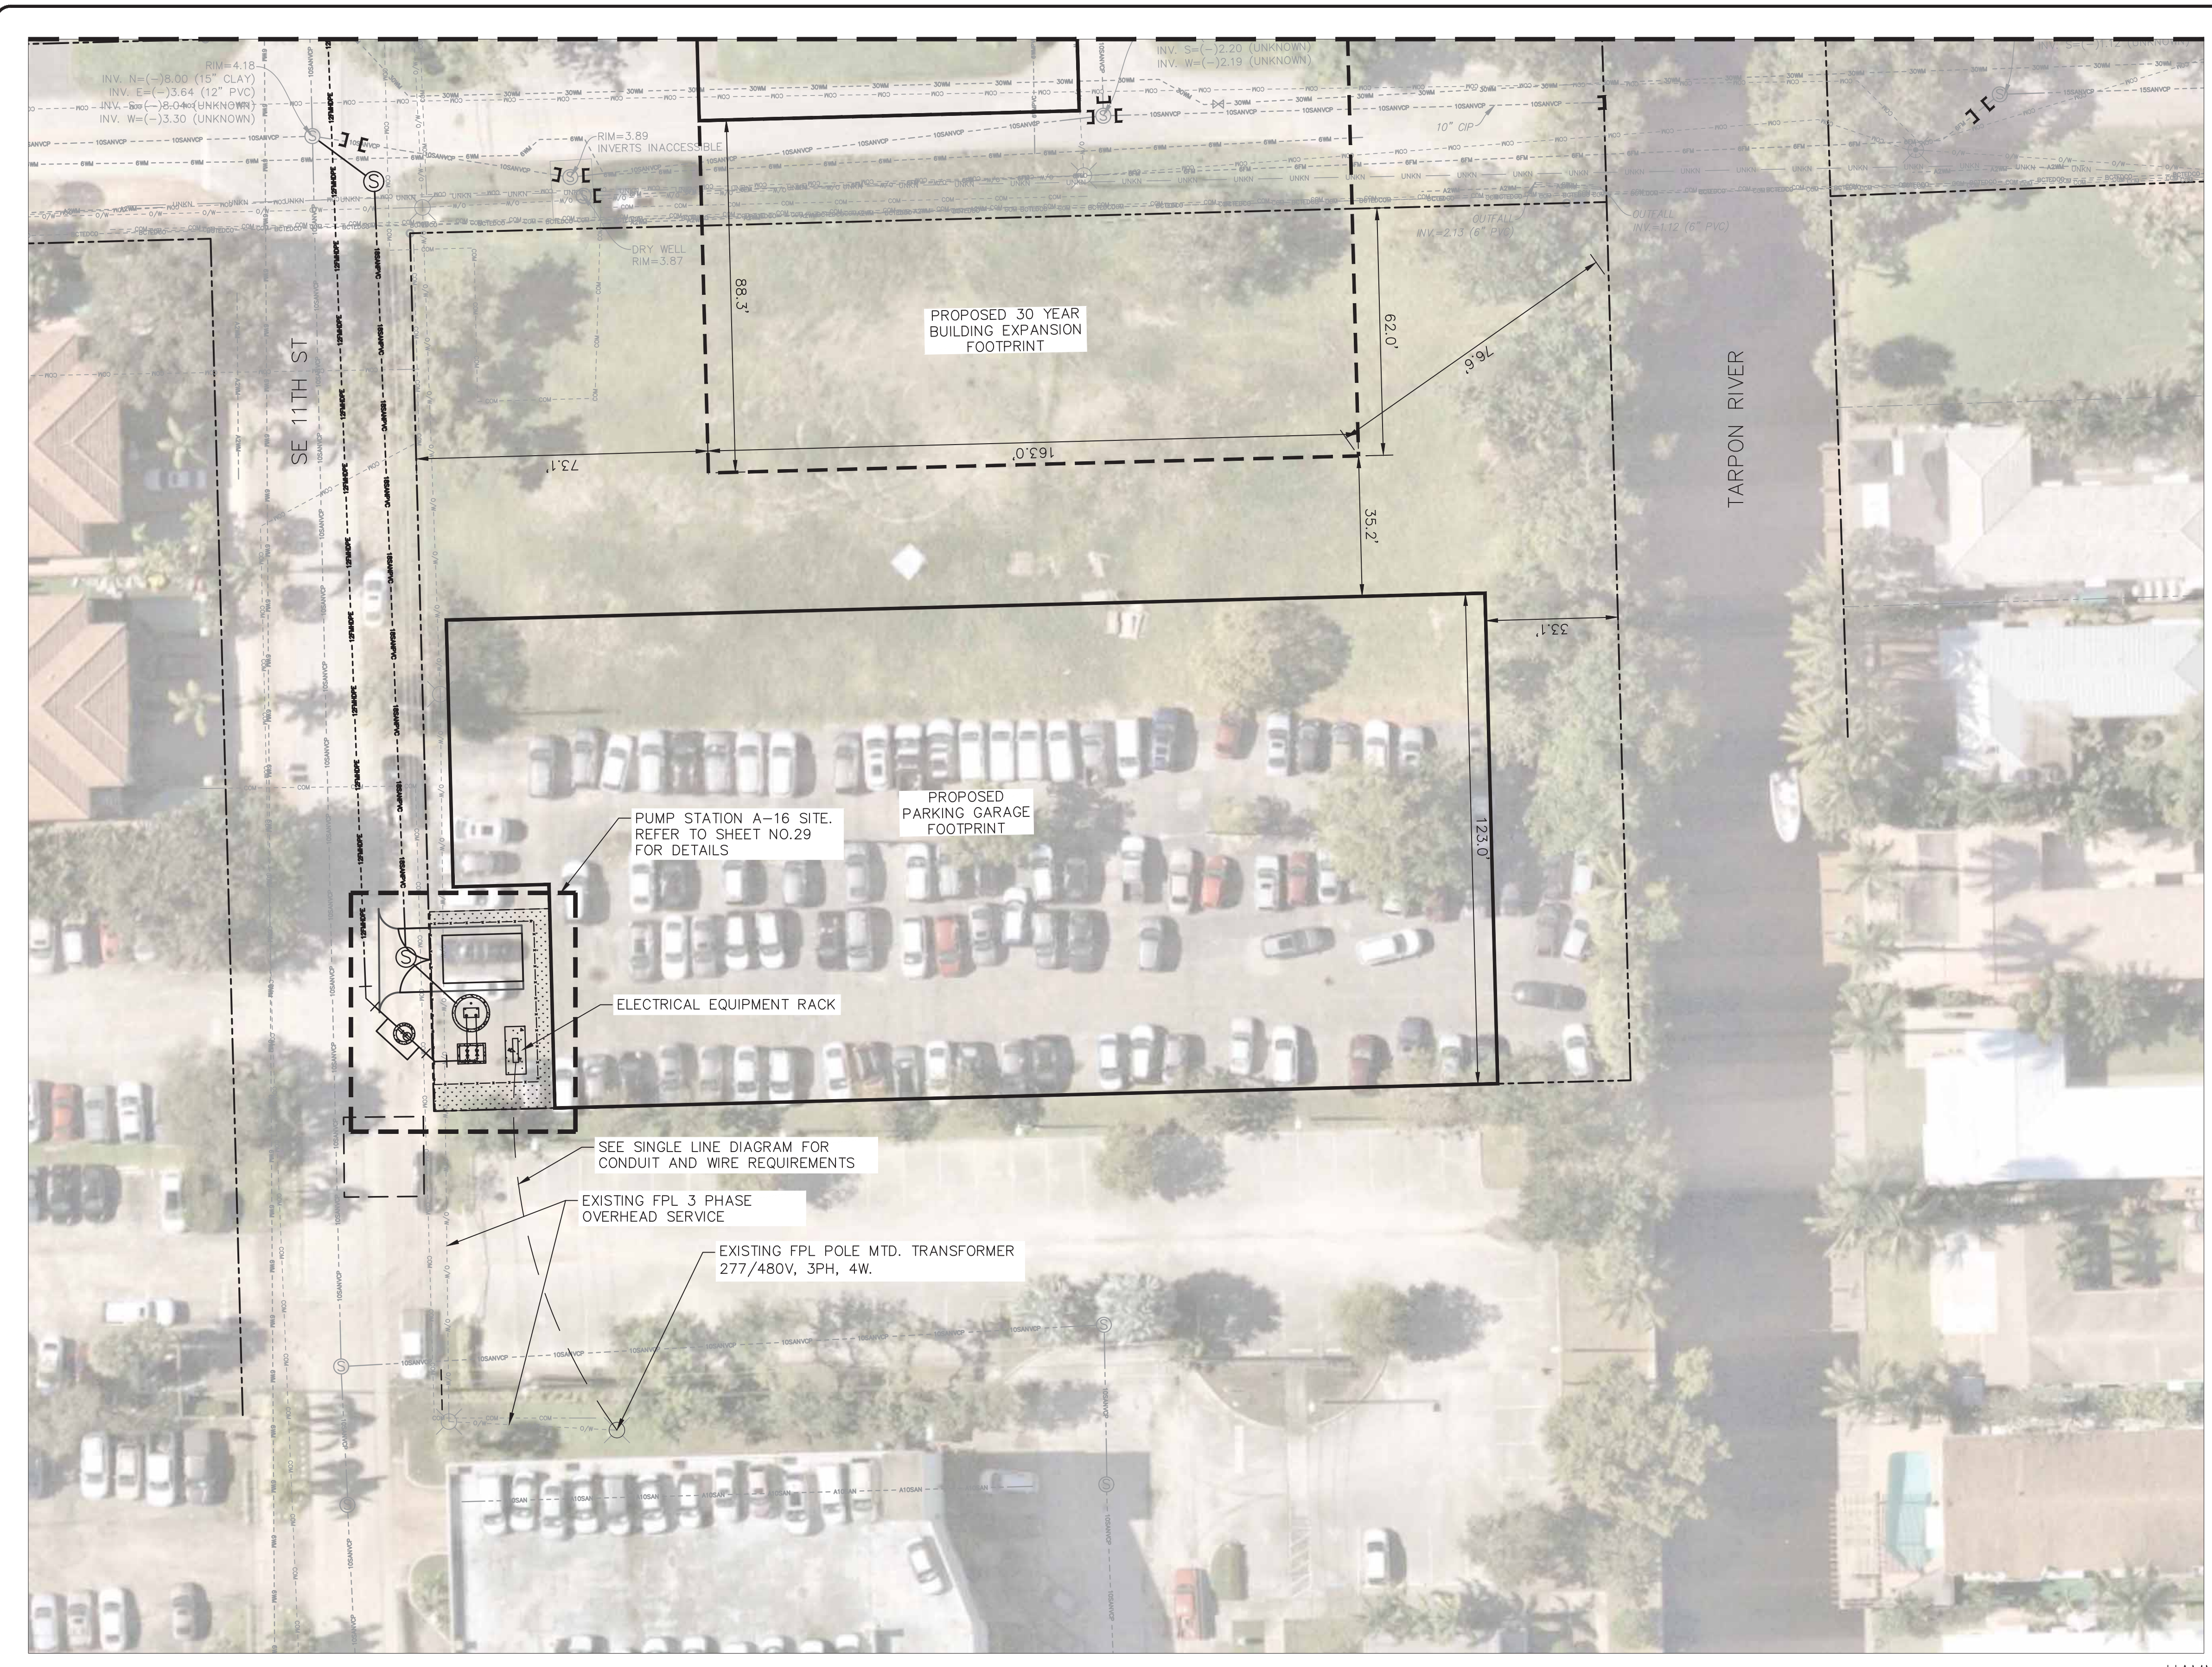

**ELECTRICAL SITE PLAN**  
 SCALE: 1"=20'-0"  
 20 10 0 20

HAMMOND & ASSOCIATES, INC.  
 CONSULTING ENGINEERS  
 499 NW 70TH AVE. SUITE 201  
 PLANTATION, FLORIDA 33317  
 TEL: (954) 327-7111 FAX (954) 327-7154  
 ERIC J. HAMMOND P.E.  
 MECHANICAL / ELECTRICAL ENGINEER  
 P.E. #39048  
 EB 5315




**DESIGN CRITERIA PACKAGE**

**PROJECT # 12412**  
**PUMP STATION A-16 UPGRADE**  
**WASTEWATER DESIGN CRITERIA PACKAGE**  
**ELECTRICAL SITE PLAN**


SHEET NO.	OP
<b>20</b>	<b>31</b>
CAD FILE:	12412-20-SITE
DRAWING FILE NO.	4-142-31

REVISIONS	
NO.	DESCRIPTION

**CITY OF FORT LAUDERDALE**  
**PUBLIC WORKS DEPARTMENT**  
**ENGINEERING & ARCHITECTURE**  
  
 100 North Andrews Avenue, Fort Lauderdale, Florida 33301

ERIC HAMMOND, P.E.  
 FL LICENSE # PE39048  
 DRAWN BY: H/A  
 DATE: 04/09/2021  
 DESIGNED BY: H/A  
 SCALE: AS NOTED  
 CHECKED BY: E.H.  
 FIELD BOOK:

This document, together with the concepts and designs presented herein, as an instrument of service, is intended only for the specific purpose and client for which it was prepared. Reuse of and improper reliance on this document without written authorization and adaptation by Kinney-Horn and Associates, Inc. shall be without liability to Kinney-Horn and Associates, Inc.

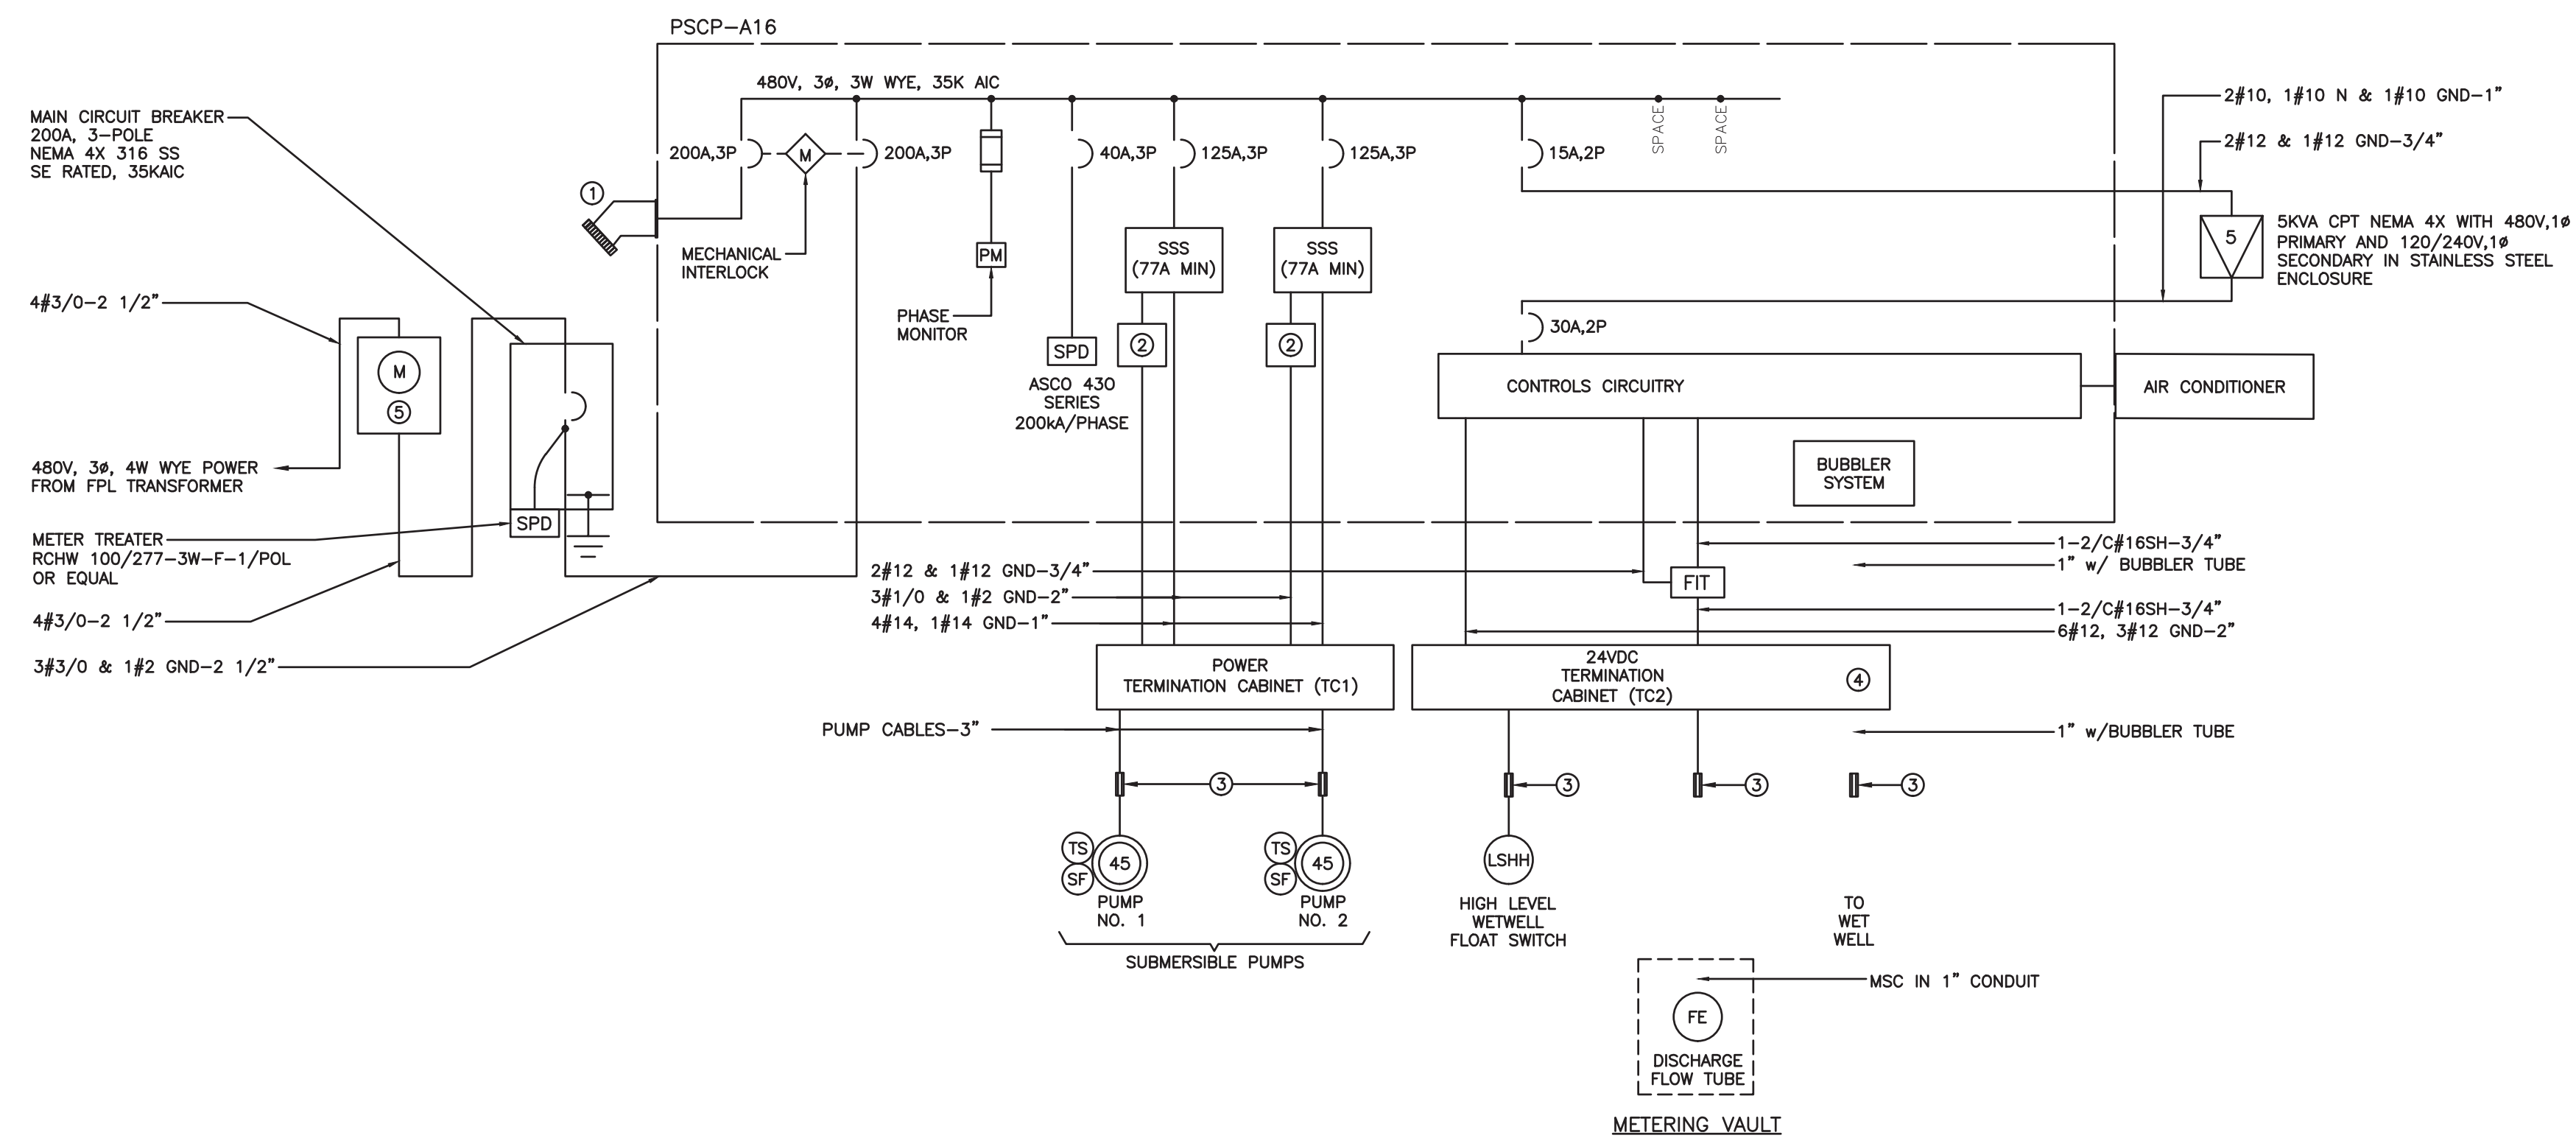

SINGLE LINE DIAGRAM

KEY NOTES:

- ① GENERATOR RECEPTACLE EATON ARL2042.
- ② PUMP SUPERVISION RELAY.
- ③ CROUSE HINDS EYSR FITTING FILLED WITH CHICO CEMENT (TYP.)
- ④ FURNISH WITH 20 PERCENT SPARE TERMINALS.
- ⑤ FPL METER CAN. FURNISHED AND INSTALLED BY CONTRACTOR.
- ⑥ CONFIGURE FLOW METER FOR OPERATION EXTERNALLY POWERED 4-20MA CIRCUIT.

LOAD TABULATION		
SERVICE VOLTAGE: 480V, 3Φ WYE		
DESCRIPTION	LOAD	AMPACITY
① SUBMERSIBLE PUMPS	2 @ 45 HP EACH	= 130.0 AMPS
MISCELLANEOUS	5 KVA	= 10.6 AMPS
	CONNECTED LOAD	= 140.5 AMPS
② MINIMUM SERVICE ENTRANCE	= 140.5 AMPS + (0.25)(65.0)	= 156.75 AMPS

NOTES:

- ① AMPACITIES PER PUMP NEC TABLE 250, USING NEXT LARGEST STANDARD SIZE.
- ② SERVICE ENTRANCE MINIMUM SIZE AS PER ARTICLE 230 OF THE NATIONAL ELECTRICAL CODE.



HAMMOND & ASSOCIATES, INC.  
 CONSULTING ENGINEERS  
 499 NW 70TH AVE., SUITE 201  
 PLANTATION, FLORIDA 33317  
 TEL: (954) 327-7111 FAX (954) 327-7154  
 ERIC J. HAMMOND P.E.  
 MECHANICAL / ELECTRICAL ENGINEER  
 P.E. #39048  
 EB 5315

DESIGN CRITERIA PACKAGE

PROJECT # 12412  
 PUMP STATION A-16 UPGRADE  
 WASTEWATER DESIGN CRITERIA PACKAGE  
 SINGLE LINE DIAGRAM

SHEET NO.	OP
21	31
CAD FILE:	12412-21-RIS
DRAWING FILE NO.	4-142-31

REVISIONS	
NO.	DESCRIPTION

CITY OF FORT LAUDERDALE  
 PUBLIC WORKS DEPARTMENT  
 ENGINEERING & ARCHITECTURE  
 100 North Andrews Avenue, Fort Lauderdale, Florida 33301

ERIC HAMMOND, P.E.  
 FL. LICENSE # PE39048  
 DRAWN BY: H.A. DATE: 04/08/2021  
 DESIGNED BY: H.A. SCALE: AS NOTED  
 CHECKED BY: E.H.  
 FIELD BOOK:

This document, together with the concepts and designs presented herein, is intended only for the specific purpose and client for which it was prepared. Reuse of and improper reliance on this document without written authorization and adaptation by Kinney-Horn and Associates, Inc. shall be without liability to Kinney-Horn and Associates, Inc.

POS	QTY	DESCRIPTION	MANUFACTURER PART NUMBER
1	1	MICROLOGIX 1100 PROGRAMMABLE CONTROLLER	ALLEN-BRADLEY, 1763-L16BWA
2	1	16-POINT SINK/SOURCE 24V INPUT MODULE	ALLEN-BRADLEY, 1762-IQ16
3	0	6-POINT SINK/SOURCE DC INPUT AND 6-POINT AC/DC RELAY OUTPUT MODEL	ALLEN-BRADLEY, 1762-IQB0W6
4	1	4-CHANNEL CURRENT ANALOG INPUT MODULE	ALLEN-BRADLEY, 1762-IF4
5	1	COMPACT POWER SUPPLY, OUTPUT 24-28V DC, 100W, 4A INPUT VOLTAGE 100/240V AC	ALLEN-BRADLEY, 1606-XLP100E
6	1	SPIDER STX INDUSTRIAL RAIL ETHERNET SWITCH	HIRSCHMAN, 943 824-002
7	25	END ANCHOR, USED W/ STANDARD 35MM DIN RAIL, GRAY	ALLEN-BRADLEY, 1492-EAJ35
8	13	FINGER-SAFE SINGLE CIRCUIT FUSE BLOCK, NO BLOWN FUSE INDICATOR #30-#12 AWG, BLACK	ALLEN-BRADLEY, 1492-H6
9	5	1/2A, FAST-ACTING GLASS BODY FUSE 1/4IN X 1 1/4IN	LITTLEFUSE, 0312.500
10	6	1/32A, FAST-ACTING GLASS BODY FUSE 1/4IN X 1 1/4IN	GRANGER, ICM28
11	1	2A, SLO-BLO GLASS BODY FUSE, 1/4IN X 1 1/4IN	LITTLEFUSE, 0313.002
12	0	4A, SLO-BLO GLASS BODY FUSE, 1/4IN X 1 1/4IN	LITTLEFUSE, 0313.004
13	8	END BARRIER SINGLE CIRCUIT FUSE OR ISOLATION BLOCKS, BLACK	ALLEN-BRADLEY, 1492-N37
14	100	IEC 1-CIRCUIT FEED-THROUGH BLOCK, 4MM MAX WIRE, GRAY	ALLEN-BRADLEY, 1492-J4
15	12	END BARRIER, GRAY	ALLEN-BRADLEY, 1492-EBJ3
16	1	MINIATURE CIRCUIT BREAKER, 10 AMP RATING	ALLEN-BRADLEY, 1492-GH100
17	2	MINIATURE CIRCUIT BREAKER, 5 AMP RATING	ALLEN-BRADLEY, 1492-GH050
18	2	MINIATURE CIRCUIT BREAKER, 2 AMP RATING	ALLEN-BRADLEY, 1492-GH020
19	5	SURGE AND FILTER PROTECTION, DIN RAIL MOUNT, DATALINE UL 4979, 24V DC	ALLEN-BRADLEY, 4983-DD24
20	1	DIN RAIL AC SOLA-HD UNINTERRUPTIBLE POWER SYSTEM SDU - A SERIES AND SDU CF DRY CONTACT I/O RELAY CARD	EMMERSON SDU500A + SDUCFRELYCARD
21	3	CONTROL RELAY OCTAL 8 PIN/COIL 120 VAC/ DPDT, 10 AMP RATING	750XBXR4M4L
22	3	DIN RAIL MOUNT RELAY SOCKET SCREW TYPE, 8 PIN	IDEC, SR2P-06
23	1	ENCLOSURE BACK PANEL, WHITE	HOFFMAN, A60P36
24	1	ENCLOSURE CABINET SS 316 NEMA 4X ONE-DOOR, 3 POINT LATCH, 72 X 36 X 16	HOFFMAN
25	6	CENTER JUMPERS	ALLEN-BRADLEY, 1492-CJJ6-10
26	1	SNAP-IN MARKER CARD, WHITE	ALLEN-BRADLEY, 1492-M6X12
27	1	GROUND BAR KIT, 14 POSITION #14-4AWG	ELECTRICCENTER ECGB14
28	4	DIN RAIL 35MM ALUMINUM 1M	IDEC, BNDN-1000
29	3	PANDUCT TYPE MC METRIC NARROW SLOT WIRING DUCT, GRAY 0.97 X 2.85 IN, 2M	PANDUIT, MC25X75IG2
30	3	WIRING DUCT COVER, 2M	PANDUIT, C251G2
31	0	RECTANGULAR LOUVERED VENT, STAINLESS STEEL 5"W X 4-5/8"H	WEST MARINE, 226993
32	1	CONTROL CABINET OUTLET FOR MOUNTING ON DIN RAILS	PHOENIX CONTACT SD-US/SC/LA/GY - 2963860
33	2	500 OHM RESISTORS, 1/2 WATT	
34	2	CAT 5E ETHERNET PATCH CABLE 2 FT	
35	0	WIRE LABELS, HEAT SHRINK WIRE LABELS	
36	0	PIN TERMINALS - BLUE	
37	0	PIN TERMINAL - RED	
38	1	MAPLE SYSTEMS 7" HMI TOUCHSCREEN 24VDC	PANDUIT, FSD80-8DSL6
39	2	YELLOW, PILOT LIGHT, LED 120 VAC	PANDUIT, FS78-8-DSL2
40	2	RED PILOT LIGHT, LED 120 VAC	MAPLESYSTEMS HMI5070B
41	2	AMBER PILOT LIGHT, LED 120 VAC	ALLEN-BRADLEY, 800FD-P5N5
42	2	UWZ SERIES AC HOUR METERS, FLUSH MOUNT, 120 VAC	ALLEN-BRADLEY, 800FD-P4N5
43	0	APC SMART-UPS ON-LINE, 1050 WATTS/1500VA, INPUT 120V / OUTPUT 120V	ALLEN-BRADLEY, 800FD-P0N5
44	1	18" LED UNDERCABINET, WHITE + 48" POWER CORD	INTERMATIC UWZ52E-120U
45	1	GFI DUAL RECEPTACLE, 20 AMP	APC, SURTA1500XL
46	0	750 OCTAL RELAYS, 11 PIN/ 3PDT, 16 AMP RATING	HALO HU1018D930P + HU105P
47	0	RELAY SOCKET 300 VAC 10 AMP TYPE K	HUBBLE GFWRST20W OR SIMILAR
48	2	30MM SELECTOR SWITCH 3 POSITION, TYPE K, BLACK KNOB	MAGNECRAFT, 750XCXM4L
49	0	30MM CONTACT BLOCK 1N/O 1N/C	SQUARE D, 8501NR62
50	2	SELECTOR PADLOCK	SQUARE D, 9001KS43B/LEGENT PLAT
51	0	PANEL LIGHT SWITCH	SQUARE D, 9001KA1
52	1	40MM MUSHROOM HEAD BUTTON, TWO POSITIONS, NON-ILLUMINATED	SQUARE D, 9001K7
53	1	PRESSURE GAUGE, 4" DIAL, 1/4" PROCESS CONNECTION, RANGE 0-200", PANEL MOUNT WITH FRONT FLANGE	SQUARE D, 9001SKS11BH5
54	1	DIN RAIL MOUNTED CABINET THERMOSTAT, 32-140 F, NO CONTACT	CUTLER-HAMMER, HT80BR
55	6	MINIATURE CIRCUIT BREAKER (QOU) STANDARD, 10A, 1 POLE, 120/240 VAC, HACR RATED	MCDANIEL CONTROLS
56	2	MINIATURE CIRCUIT BREAKER (QOU), STANDARD 15A, 1 POLE, 120/240 VAC, HACR RATED	PFANNENBERG FLZ 530 PN#17121000010
57	2	MINI-CAS 120V RELAYS FOR PUMP THERMAL/SEAL FAIL PROTECTION	SQUARE D, QOU110
58	1	PHASE MONITORING RELAY 3 PHASE 180-500 VOLT	SQUARE D, QOU115
59	2	480V THREE PHASES S-811+ EATON SOFTSTARTER WITH DIM. INCLUDING PROTECTIVE MODEL EMS39 AND FAN COOLING KIT	FLYGT MINI-CAS 120, 14-407129
60	2	CURRENT TRANSFORMERS 10A TO 50A, 4-20MA, 24VDC	MARCOMATIC PMPU
61	2	3P 600VAC POWERPACT H-FRAME MOLDED CASE THERMAL-MAGNETIC CIRCUIT BREAKERS, UNIT MOUNT	EATON S811+ SERIES
62	2	3P 600VAC POWERPACT H-FRAME MOLDED CASE THERMAL-MAGNETIC CIRCUIT BREAKERS, UNIT MOUNT	EATON EAC1420SC
63	2	POWER SUPPLY, OUTPUT 24-28V DC, 10A INPUT VOLTAGE 100/240V AC	SQUARE D
64	1	600VAC POWER DISTRIBUTION BLOCKS, SURFACE MOUNT, 3 POLES, 2 LINE TERMINALS, 6 LOAD TERMINALS	SQUARE D
65	1	600VAC POWER DISTRIBUTION BLOCKS, SURFACE MOUNT, 1 POLE, 2 LINE TERMINALS, 6 LOAD TERMINALS	EATON, PSG240E
66	1	3-POLE FUSE HOLDER, AC: 600VAC, FINGER-SAFE DESIGN, DIN RAIL MOUNTING	SQUARE D 9080LB SERIES
67	3	1A FAST ACTING MIDGET FUSE WITH 600VAC VOLTAGE RATING FOR PROTECTION OF CONTROL AND ELECTRONIC CIRCUITS	SQUARE D 9080LB SERIES
68	1	AIR COMPRESSOR FOR FUSE WITH BUBBLER TYPE LIQUID LEVEL CONTROL SYSTEMS W/ MOUNTING BRACKET RANGE OF 0-15 FEET OF WATER COLUMN	EATON BUSSMAN CHM3DNU OR SIMILAR
69	1	GENERAL PURPOSE PRESSURE TRANSMITTER, 4-20MA 2-WIRE SIGNAL OUTPUT, SS 316L WETTED PARTS, 0-15 PSI RANGE, +/-0.5% ACCURACY, 1/4" MALE NPT CONNECTION	LITTLEFUSE 08LS001.T OR SIMILAR
70	2	24VDC STANDARD DPDT SCREW CONNECTION TERMINAL BLOCK RELAYS	INGRAM PRODUCTS PART NO. HR10WB3 + PART NO. HRMTBKT
71	1	ENCLOSURE INNER DOOR ALARM (BRUSHED)	WIKA 50426397
72	1	LIGHT SOURCE	EATON XRU2D24 + XRR2D24
73	1	RECEPTACLE ASSEMBLY WITH AJ BACK BOXES AND ANGLE ADAPTERS 200A 3 PHASES 4 POLES	DEAD FRONT
74	1	MAGNETIC SWITCH INC FOR SS ENCLOSURE	FEDERAL SIGNAL LP1-120R
75	1	MAGNETIC FLOW METER	CROUSE HINDS
			ABB MAGMASTER

NOTES:

- ① BILL OF MATERIALS SHALL NOT BE CONSIDERED AS FINAL. VENDOR SHALL PROVIDE ALL DEVICES AND EQUIPMENT REQUIRED TO PROVIDE THE FUNCTIONALITY POWER SOURCE CIRCUITS INDICATED AND REQUIRED.




HAMMOND & ASSOCIATES, INC.  
CONSULTING ENGINEERS  
499 NW 70TH AVE, SUITE 201  
PLANTATION, FLORIDA 33317  
TEL: (954) 327-7111 FAX (954) 327-7154  
ERIC J. HAMMOND P.E.  
MECHANICAL / ELECTRICAL ENGINEER  
P.E. #59048  
EB 5315

DESIGN CRITERIA PACKAGE

ERIC HAMMOND, P.E.	
FL LICENSE # PE59048	
DRAWN BY: H.A. DATE: 04/09/2021 DESIGNED BY: H.A. SCALE: AS NOTED CHECKED BY: E.H. FIELD BOOK:	<p>CITY OF FORT LAUDERDALE  PUBLIC WORKS DEPARTMENT  ENGINEERING &amp; ARCHITECTURE  100 North Andrews Avenue, Fort Lauderdale, Florida 33301</p>
NO. DATE BY CHKD DESCRIPTION	
PROJECT # 12412 PUMP STATION A-16 UPGRADE WASTEWATER DESIGN CRITERIA PACKAGE CONTROL PANEL BILL OF MATERIALS	
SHEET NO.	OF
22	31
CAD FILE: 12412-22-PBOM	
DRAWING FILE NO. 4-142-31	

This document, together with the concepts and designs presented herein, as an instrument of service, is intended only for the specific purpose and client for which it was prepared. Reuse of and improper reliance on this document without written authorization and adaptation by Kimley-Horn and Associates, Inc. shall be without liability to Kimley-Horn and Associates, Inc.

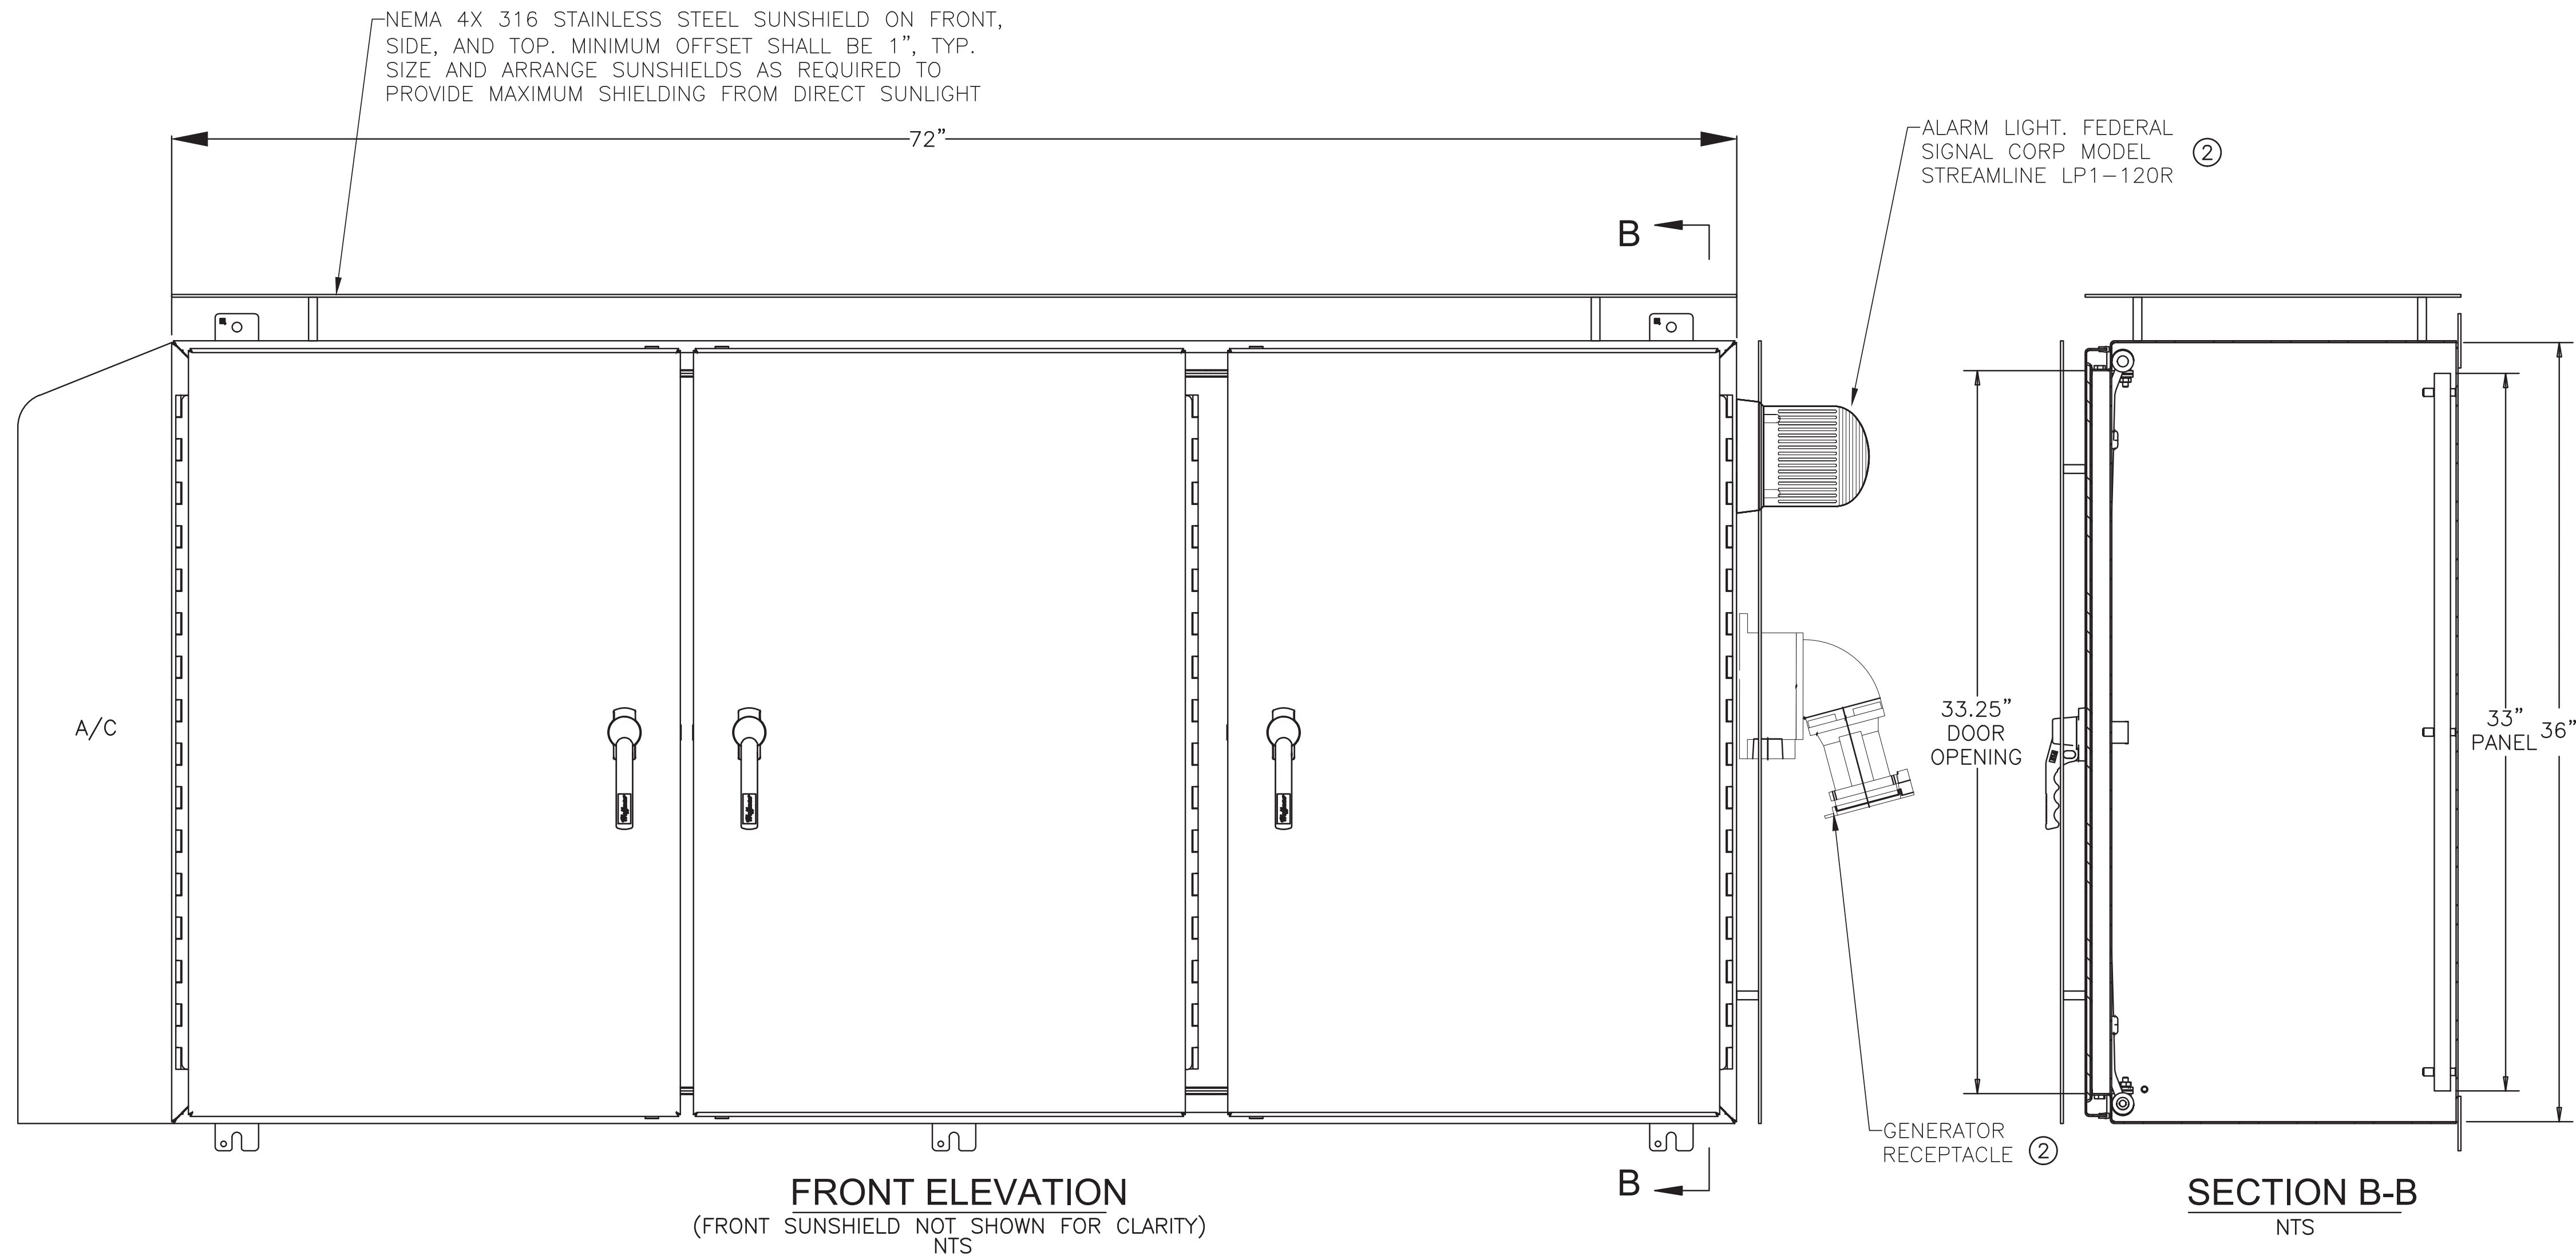

**NOTES:**

- ① CABINET DIMENSIONS SHALL NOT EXCEED DIMENSIONS SHOWN.
- ② CUT OUT AREAS OF SUNSHIED AS REQUIRED FOR INSTALLATION.



HAMMOND & ASSOCIATES, INC.  
CONSULTING ENGINEERS  
499 NW 70TH AVE, SUITE 201  
PLANTATION, FLORIDA 33317  
TEL: (954) 327-7111 FAX (954) 327-7154  
ERIC J. HAMMOND P.E.  
MECHANICAL / ELECTRICAL ENGINEER  
P.E. #39048  
EB 5315

**DESIGN CRITERIA PACKAGE**

PROJECT # 12412  
PUMP STATION A-16 UPGRADE  
WASTEWATER DESIGN CRITERIA PACKAGE  
CONTROL PANEL EXTERIOR LAYOUT

SHEET NO.	OP
23	31
CAD FILE: 12412-23-PANL	
DRAWING FILE NO. 4-142-31	

REVISIONS	
NO.	DESCRIPTION



**CITY OF FORT LAUDERDALE**  
PUBLIC WORKS DEPARTMENT  
ENGINEERING & ARCHITECTURE  
100 North Andrews Avenue, Fort Lauderdale, Florida 33301

DESIGNED BY:	H.A.	SCALE:	AS NOTED
CHECKED BY:	H.A.	DATE:	04/08/2021
FIELD BOOK:	E.H.		


ERIC HAMMOND, P.E.  
FL LICENSE # PE39048



This document, together with the concepts and designs presented herein, as an instrument of service, is intended only for the specific purpose and client for which it was prepared. Reuse of and improper reliance on this document without written authorization and adaptation by Kimley-Horn and Associates, Inc. shall be without liability to Kimley-Horn and Associates, Inc.

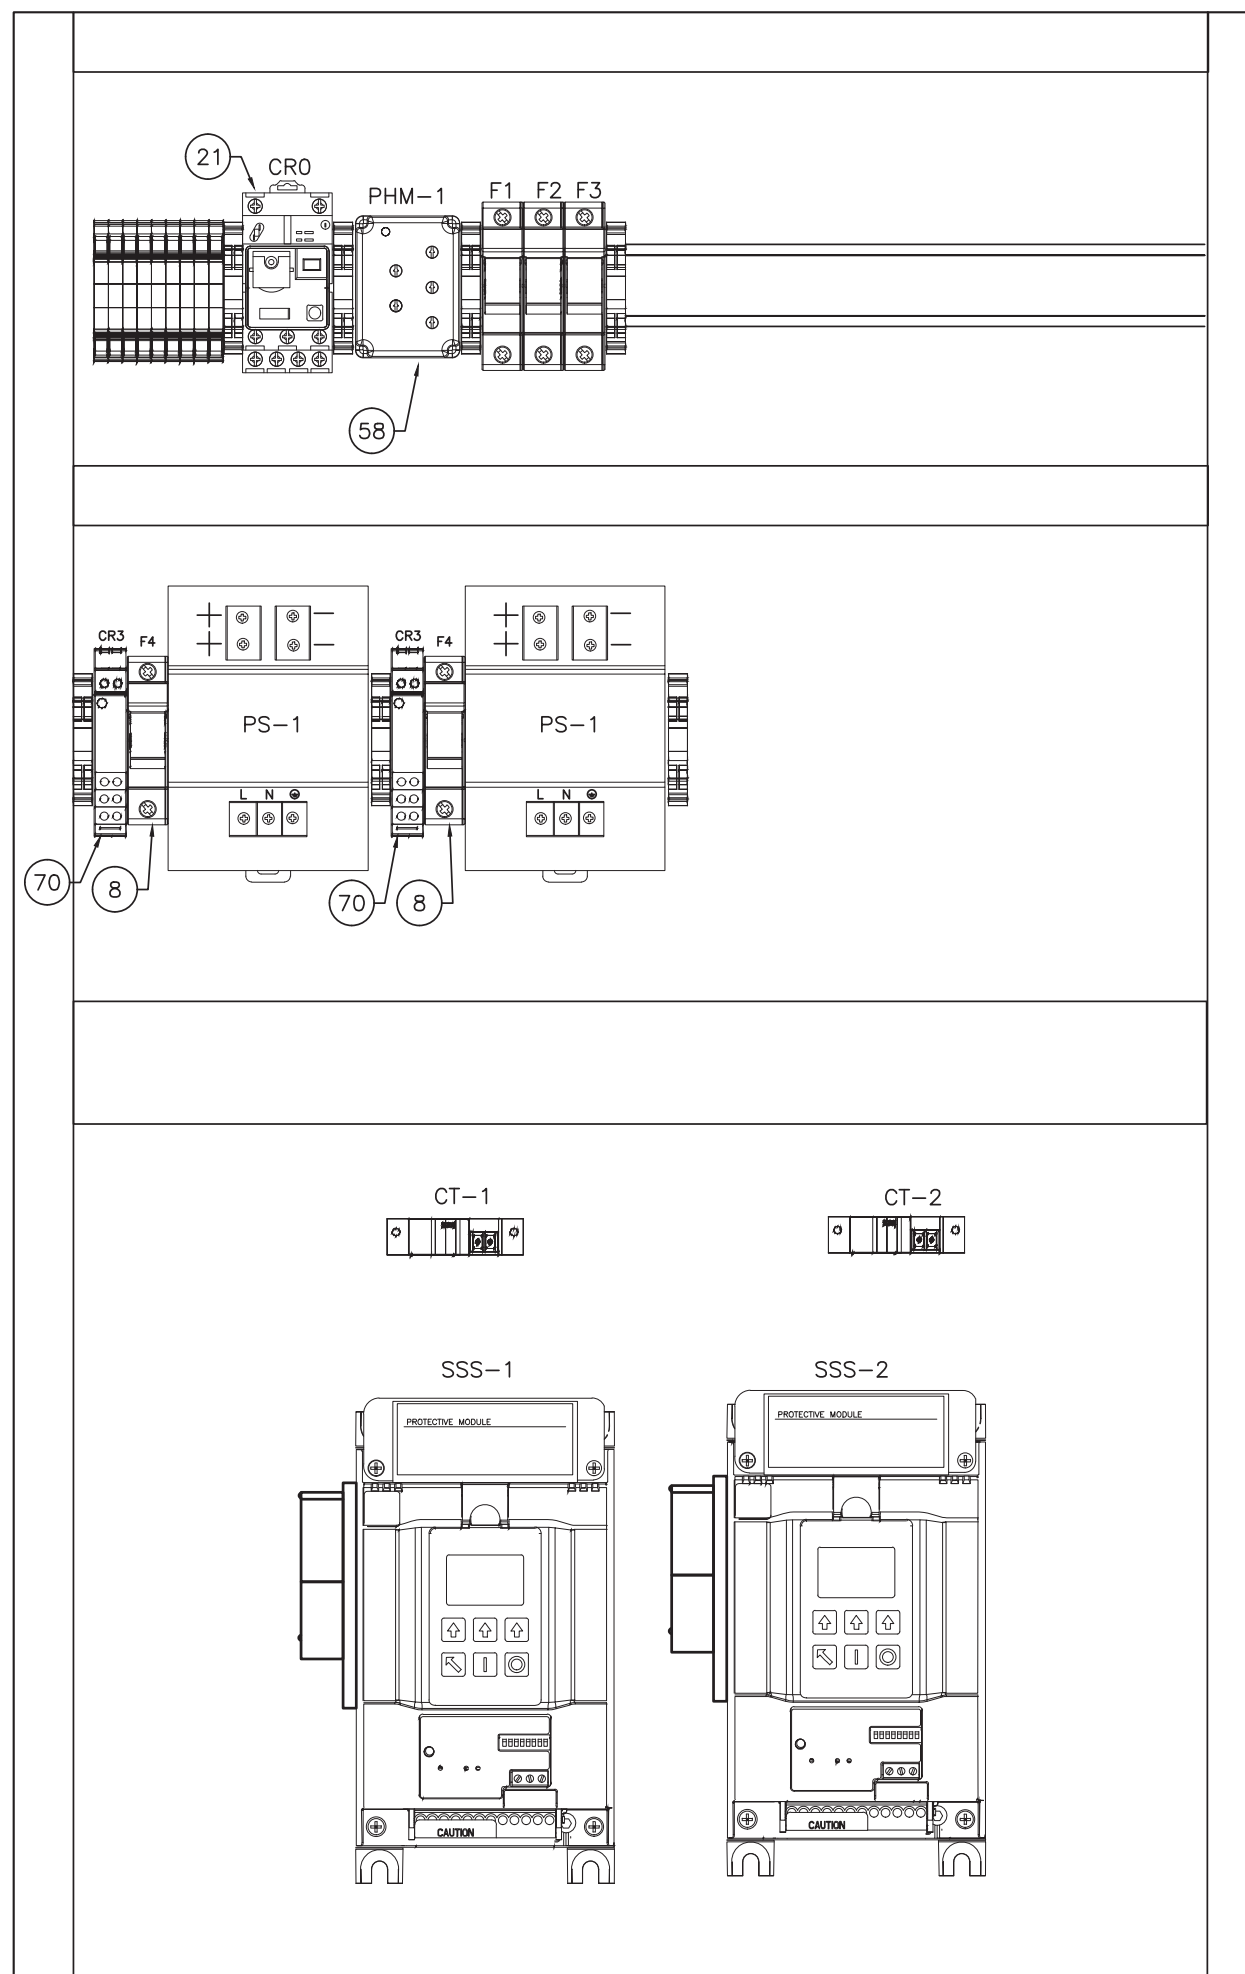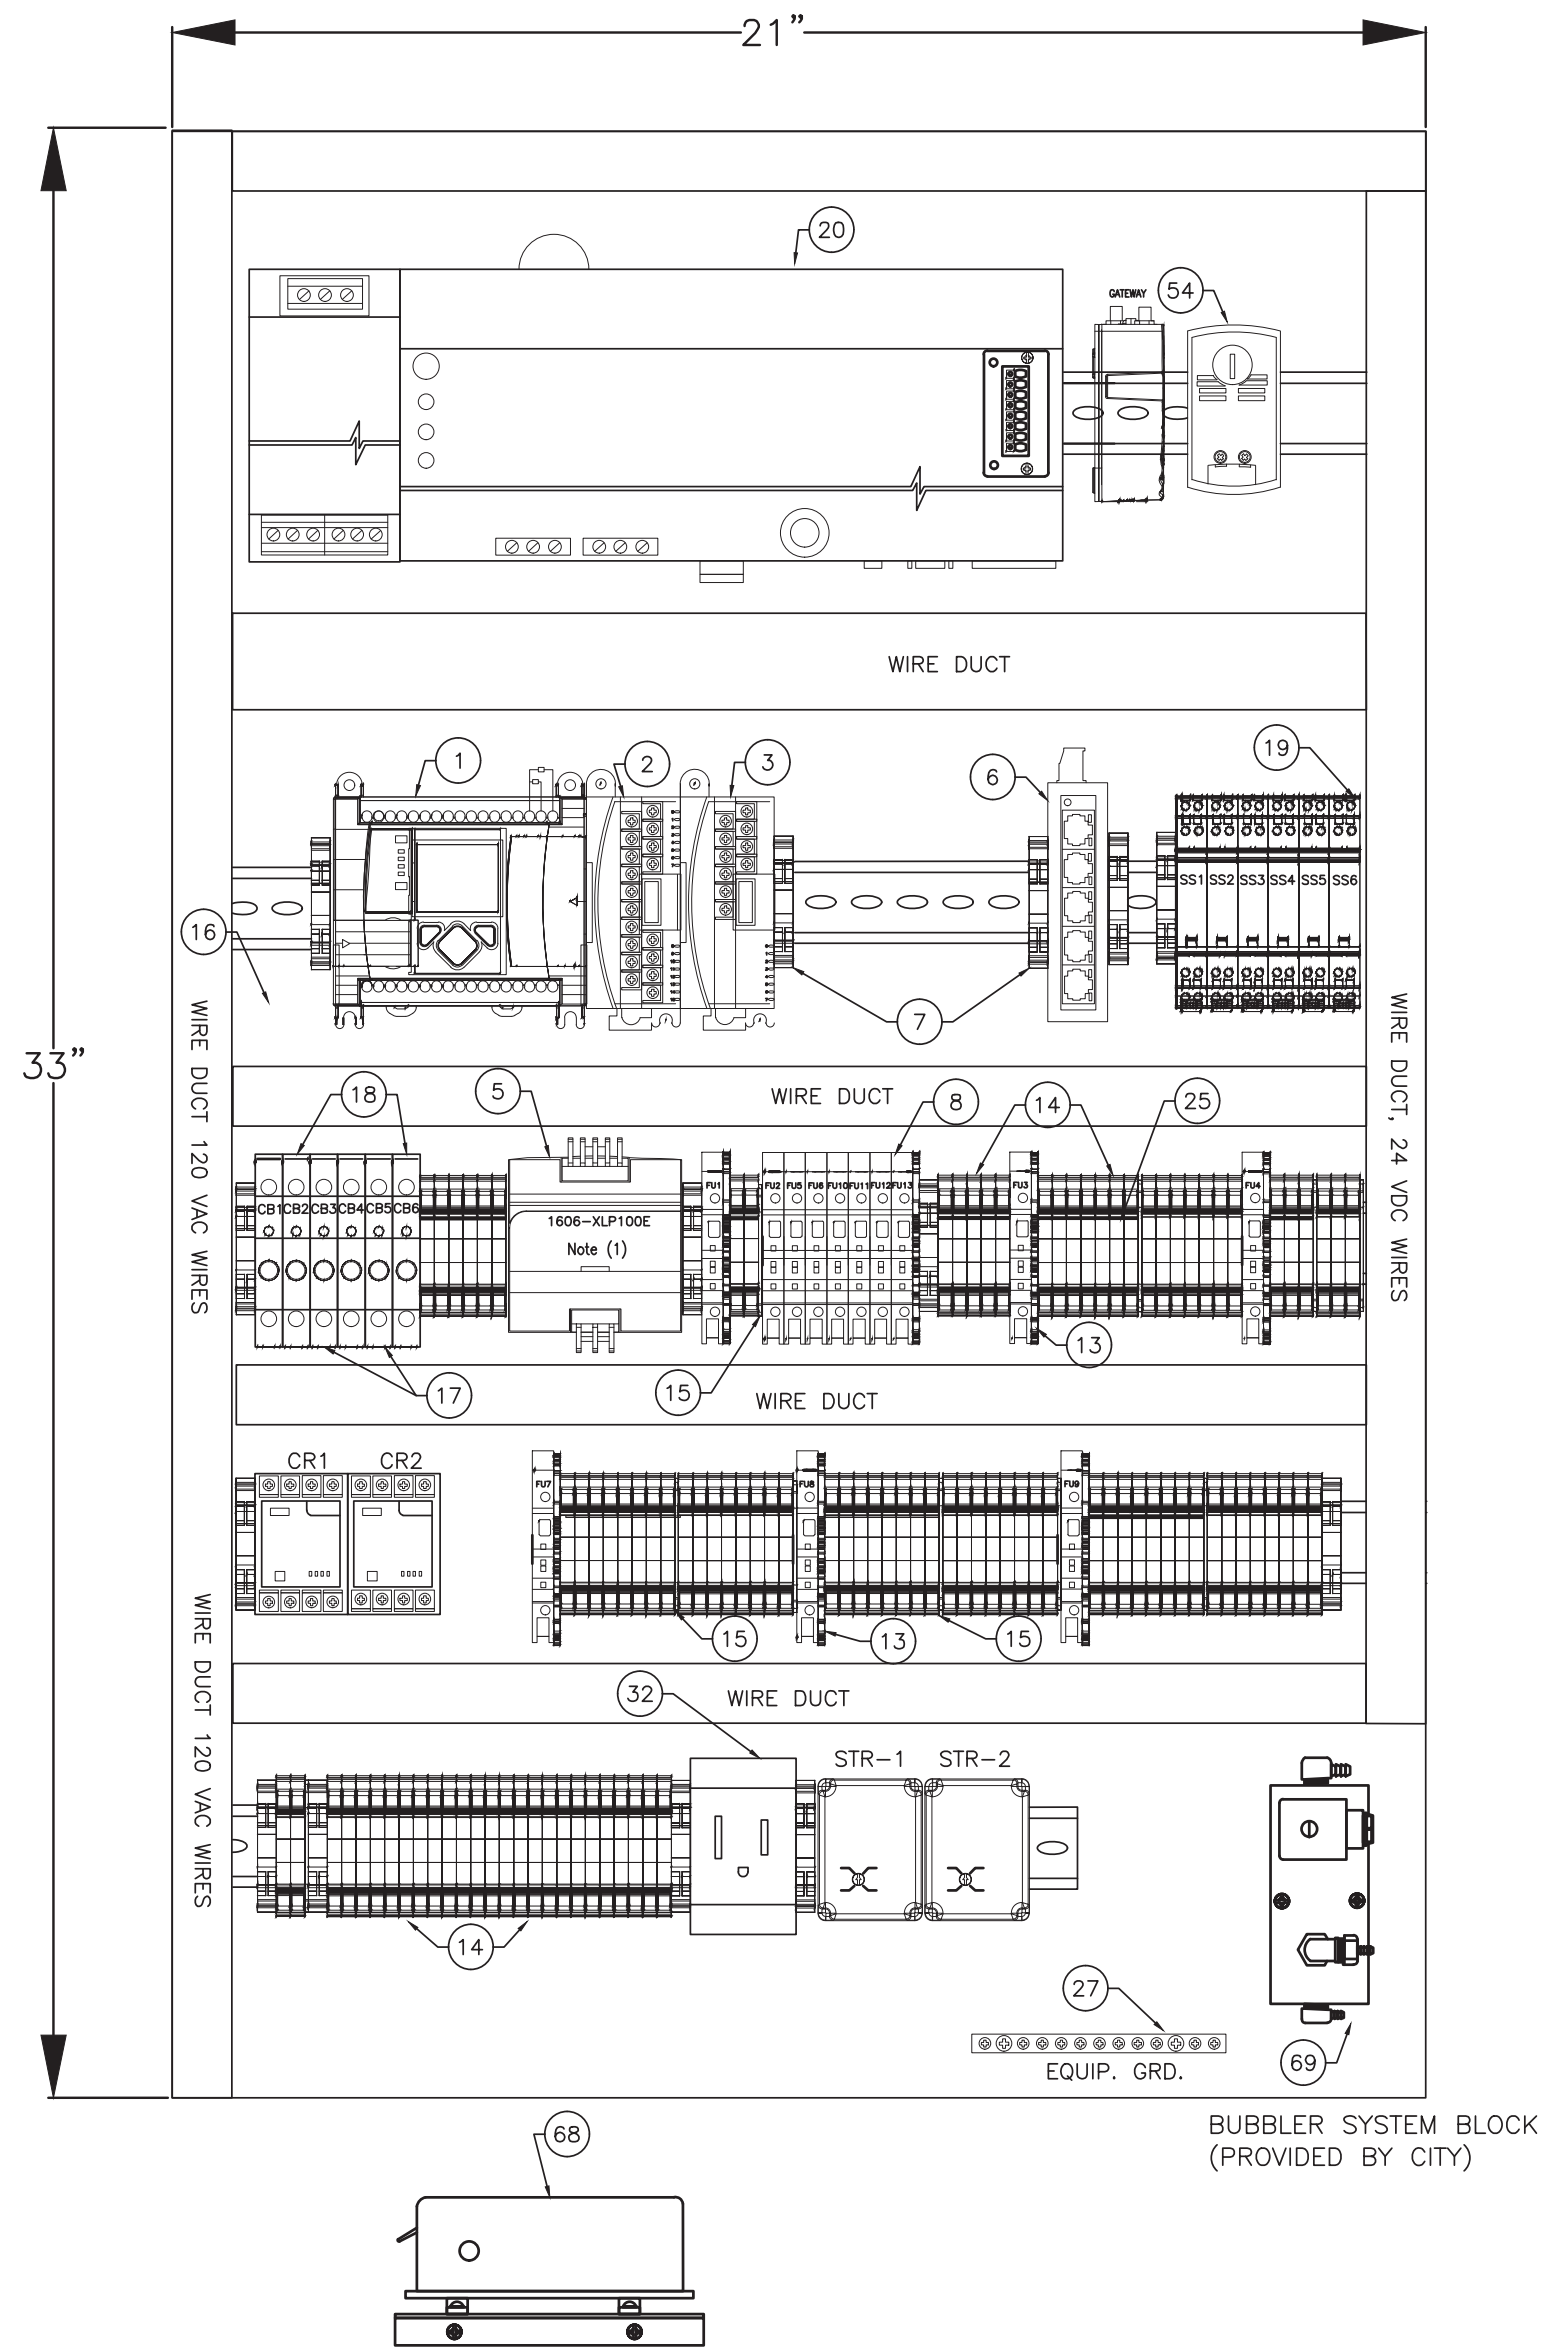

**GENERAL ELECTRICAL NOTES:**  
 1. FOR EACH SECTION, USE LEFT WIRE DUCTS FOR 120 VAC WIRES AND RIGHT WIRE DUCTS FOR 24 VDC WIRES.

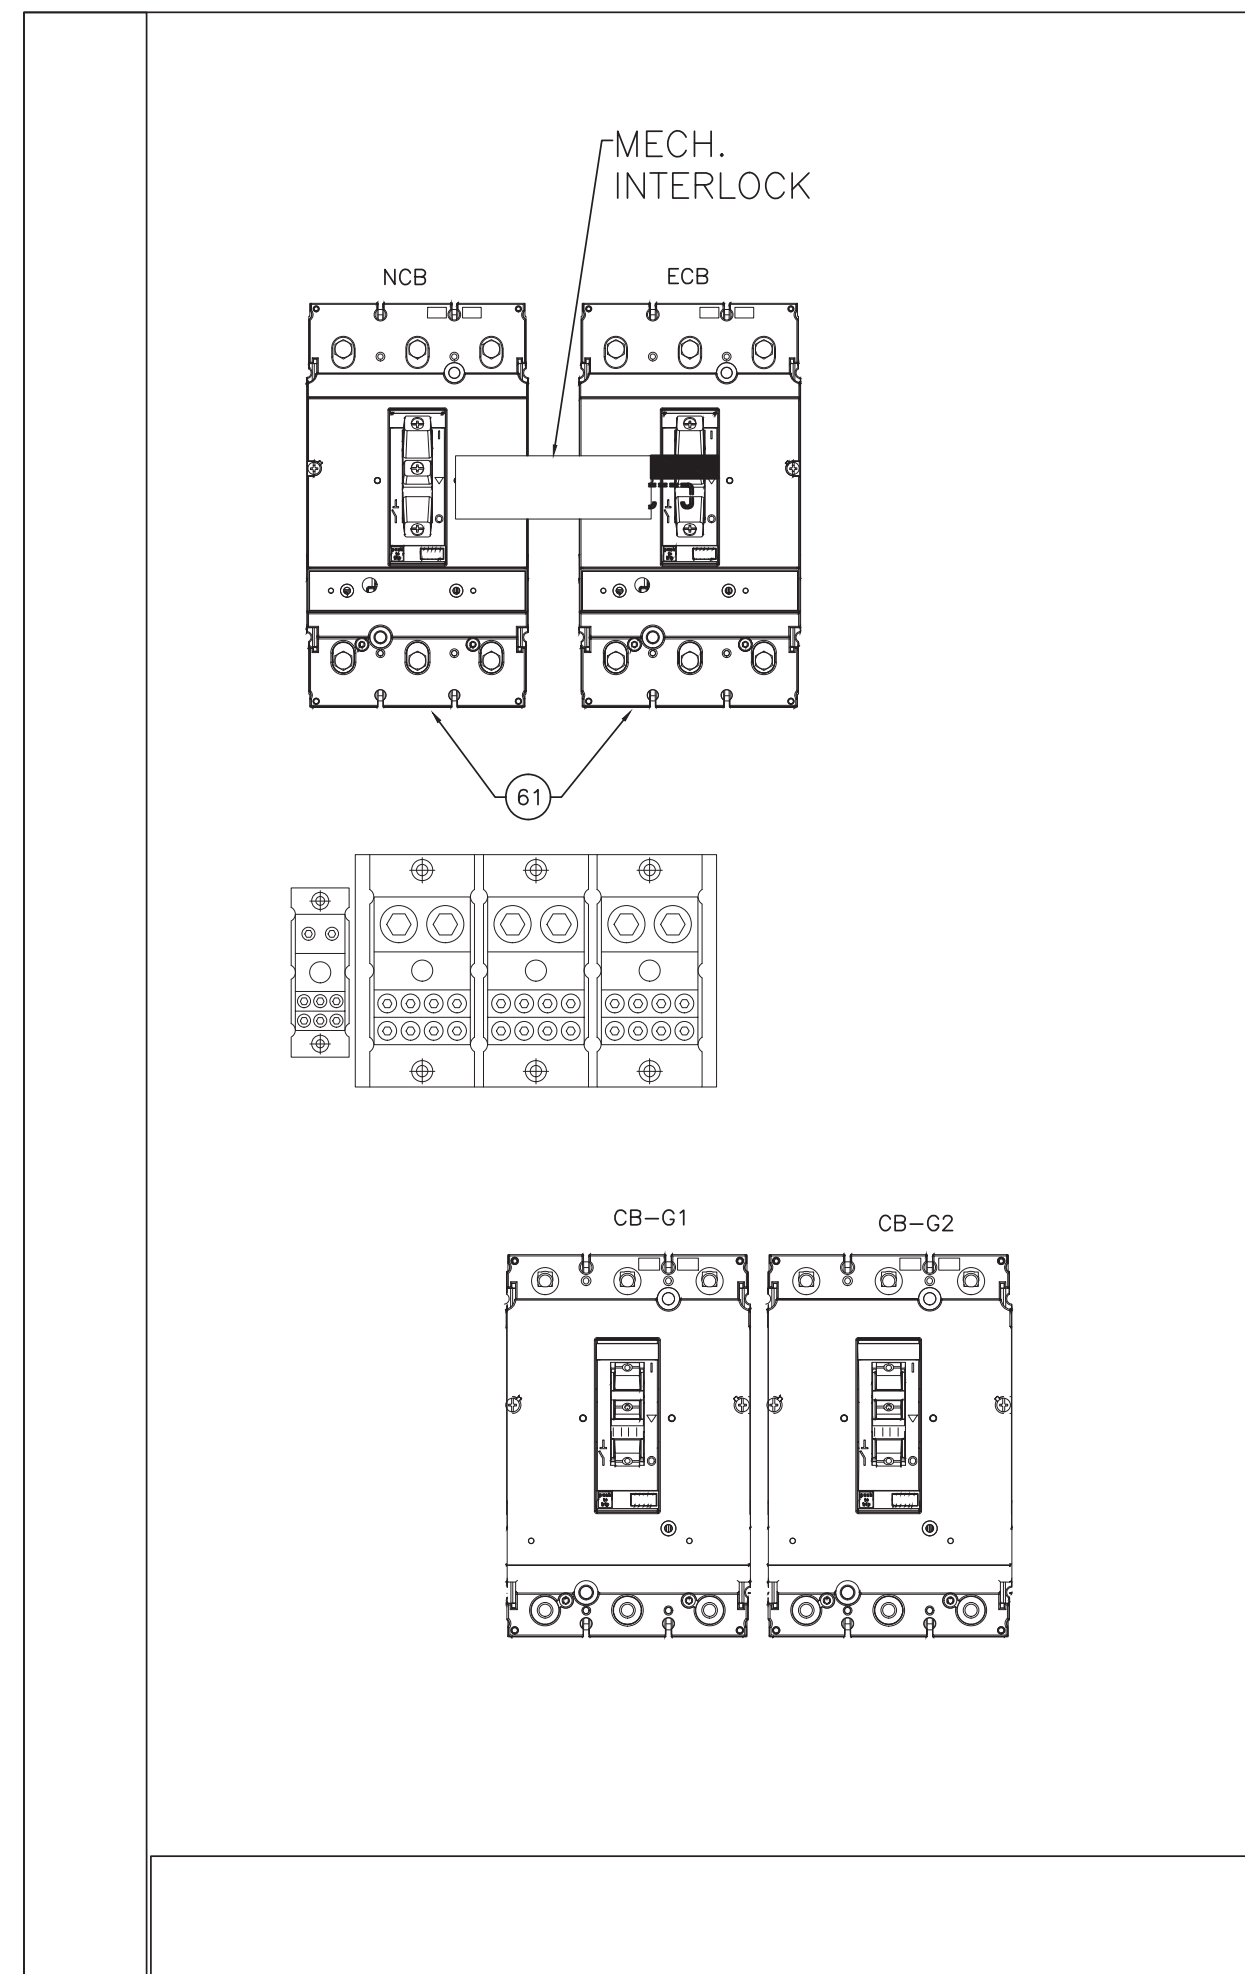

HAMMOND & ASSOCIATES, INC.  
 CONSULTING ENGINEERS  
 499 NW 70TH AVE., SUITE 201  
 PLANTATION, FLORIDA 33317  
 TEL: (954) 327-7111 FAX (954) 327-7154  
 ERIC J. HAMMOND P.E.  
 MECHANICAL / ELECTRICAL ENGINEER  
 P.E. #39048  
 EB 5315

**DESIGN CRITERIA PACKAGE**

**PROJECT # 12412  
 PUMP STATION A-16 UPGRADE  
 WASTEWATER DESIGN CRITERIA PACKAGE  
 CONTROL PANEL COMPONENT LAYOUT**


SHEET NO.	OP
24	31
CAD FILE:	12412-24-PANL
DRAWING FILE NO.	4-142-31

REVISIONS	
NO.	DESCRIPTION

**CITY OF FORT LAUDERDALE  
 PUBLIC WORKS DEPARTMENT  
 ENGINEERING & ARCHITECTURE**  
 100 North Andrews Avenue, Fort Lauderdale, Florida 33301

ERIC HAMMOND, P.E.  
 FL. LICENSE # PE39048  
 DRAWN BY: H.A. DATE: 04/08/2021  
 DESIGNED BY: H.A. SCALE: AS NOTED  
 CHECKED BY: E.H. FIELD BOOK:  
 FIELD BOOK:

This document, together with the concepts and designs presented herein, as an instrument of service, is intended only for the specific purpose and client for which it was prepared. Reuse of and improper reliance on this document without written authorization and adaptation by Kinney-Horn and Associates, Inc. shall be without liability to Kinney-Horn and Associates, Inc.

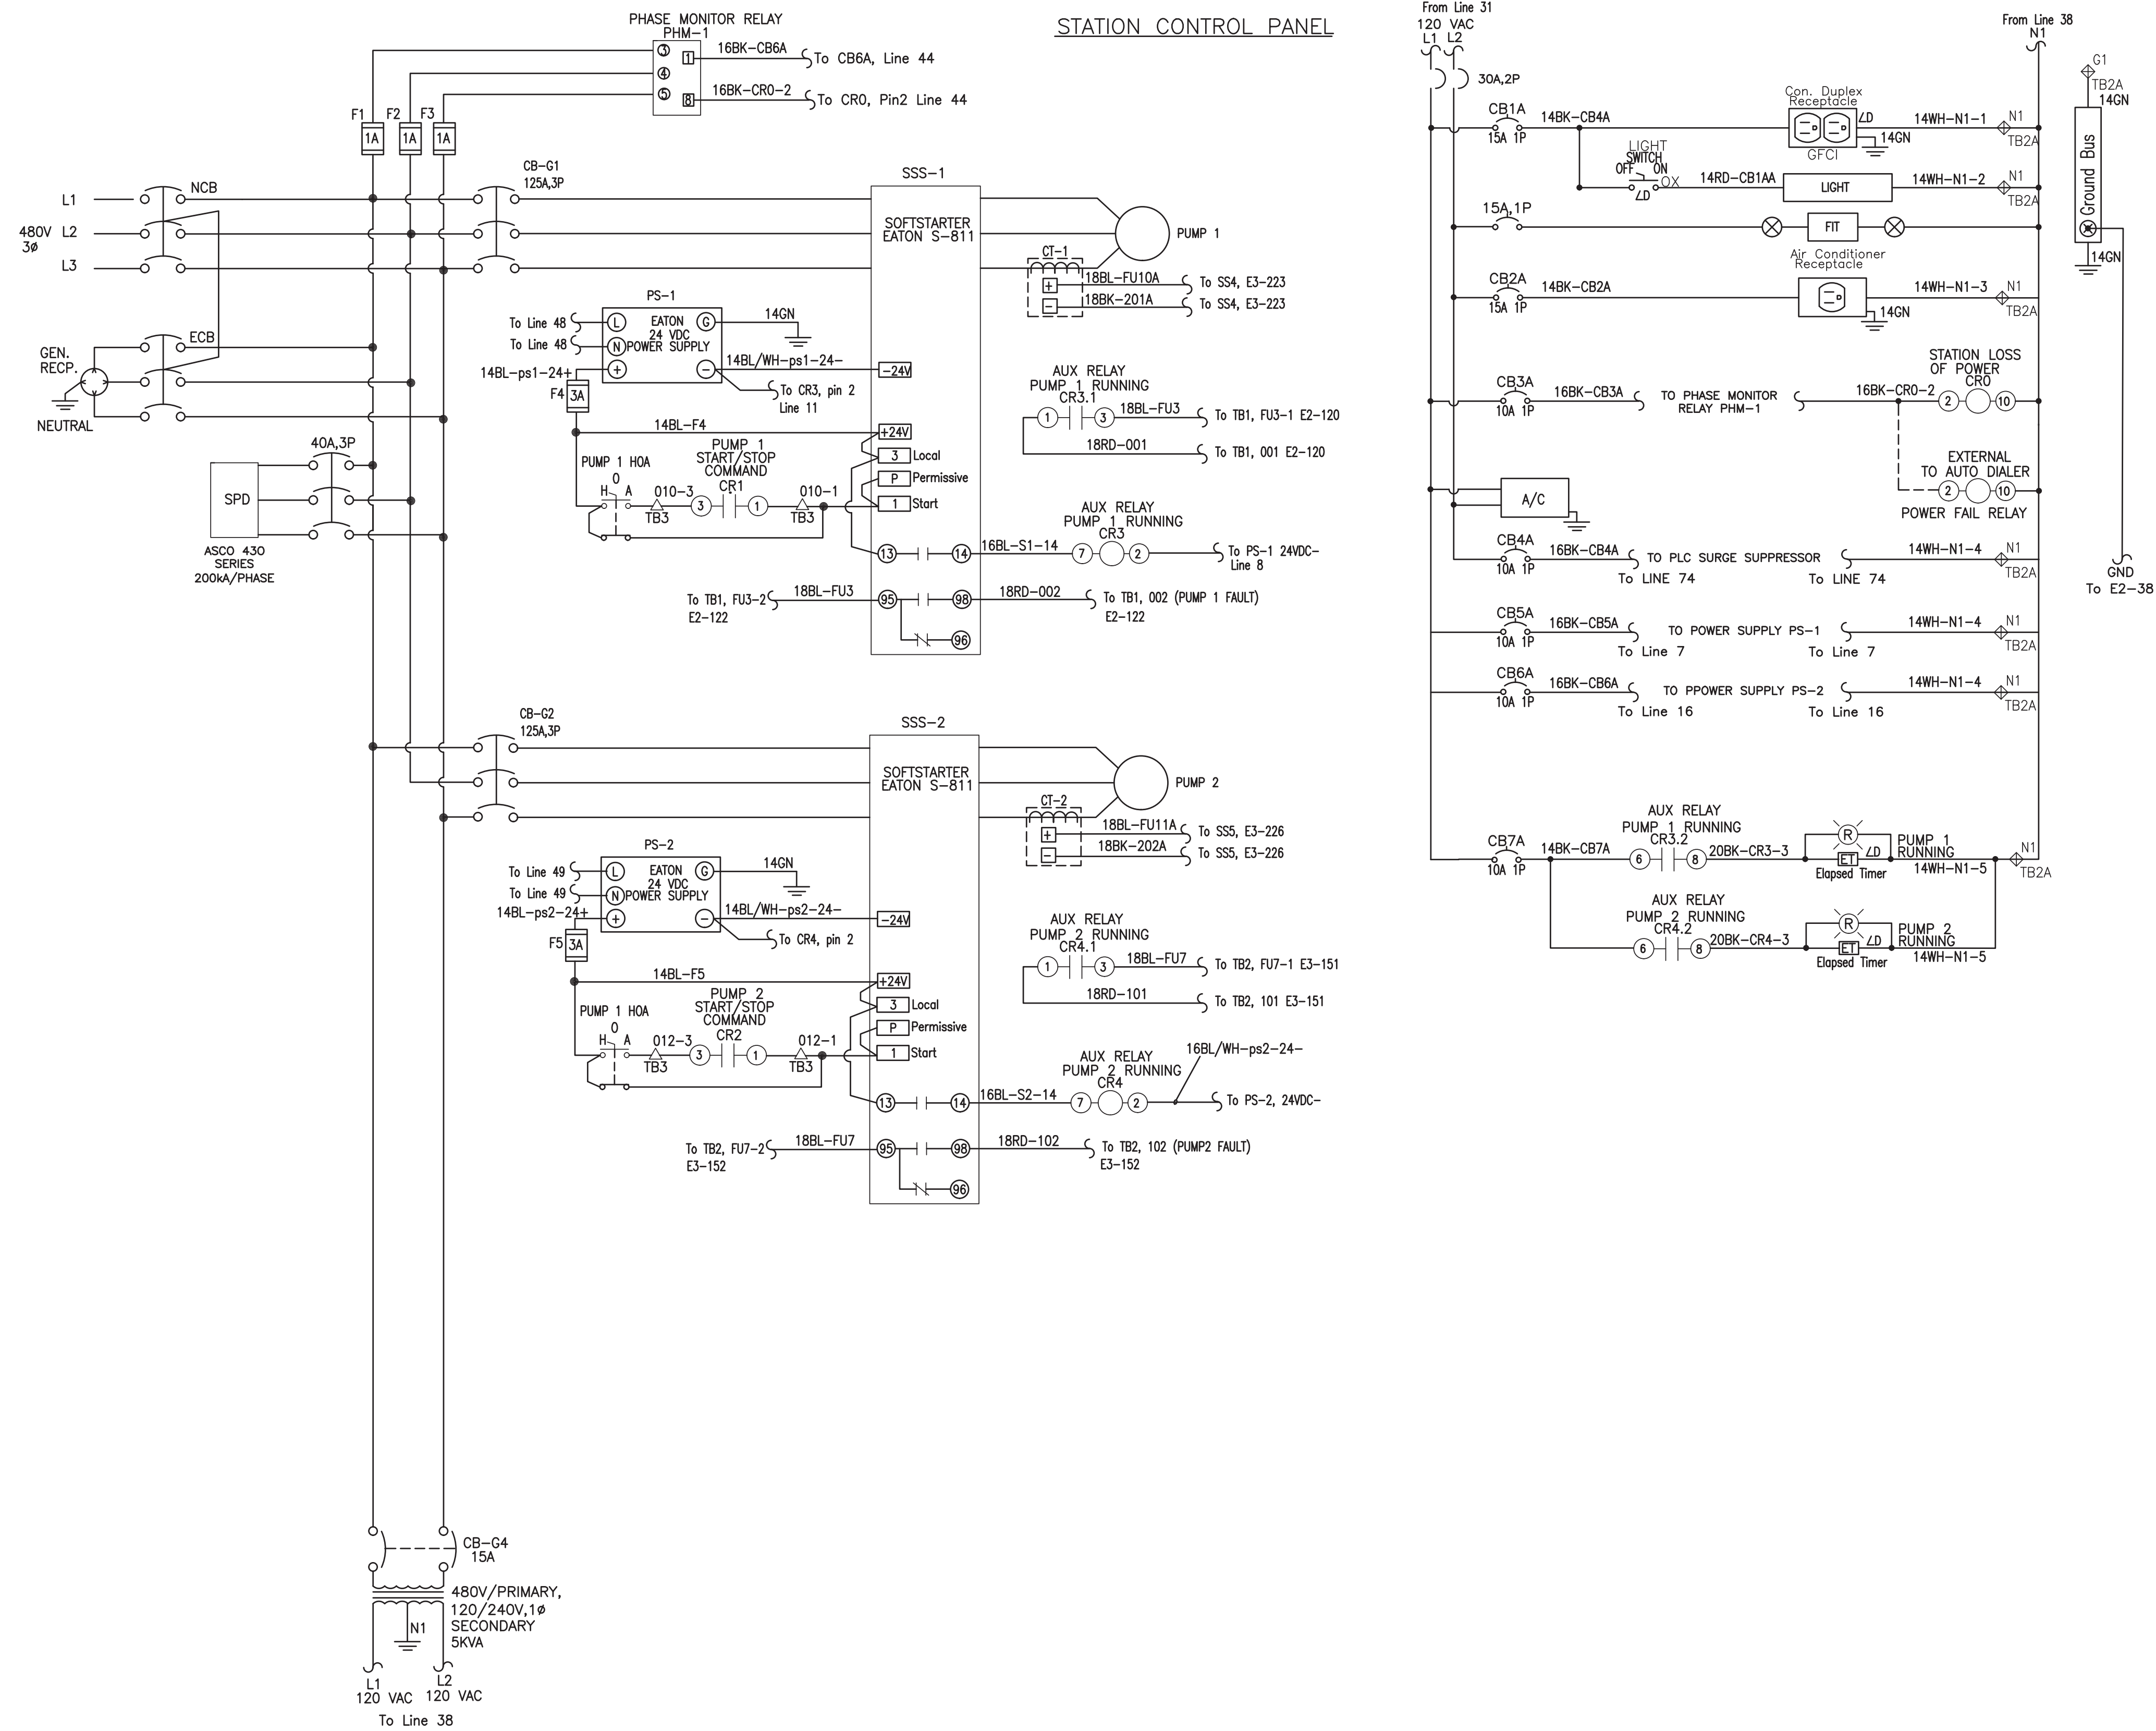

ERIC HAMMOND, P.E.  
FL LICENSE # PE99048

DATE: 04/09/2021  
DESIGNED BY: H.A.  
CHECKED BY: E.H.  
SCALE: AS NOTED  
FIELD BOOK:

**CITY OF FORT LAUDERDALE**  
PUBLIC WORKS DEPARTMENT  
ENGINEERING & ARCHITECTURE  
100 North Andrews Avenue, Fort Lauderdale, Florida 33301

NO.	DATE	BY	CHKD	DESCRIPTION


**DESIGN CRITERIA PACKAGE**  
PROJECT # 12412  
PUMP STATION A-16 UPGRADE  
WASTEWATER DESIGN CRITERIA PACKAGE  
CONTROL PANEL ELEMENTARY DIAGRAM -  
SHEET 1

SHEET NO. 25 OF 31  
CAD FILE: 12412-25-PANL  
DRAWING FILE NO. 4-142-31





HAMMOND & ASSOCIATES, INC.  
CONSULTING ENGINEERS  
499 NW 70TH AVE, SUITE 201  
PLANTATION, FLORIDA 33317  
TEL: (954) 327-7111 FAX (954) 327-7154  
ERIC J. HAMMOND P.E.  
MECHANICAL / ELECTRICAL ENGINEER  
P.E. #99048  
EB 5315

This document, together with the concepts and designs presented herein, is an instrument of service, is intended only for the specific purpose and client for which it was prepared. Reuse of and improper reliance on this document without written authorization and adaptation by Kinney-Trom and Associates, Inc. shall be without liability to Kinney-Trom and Associates, Inc.

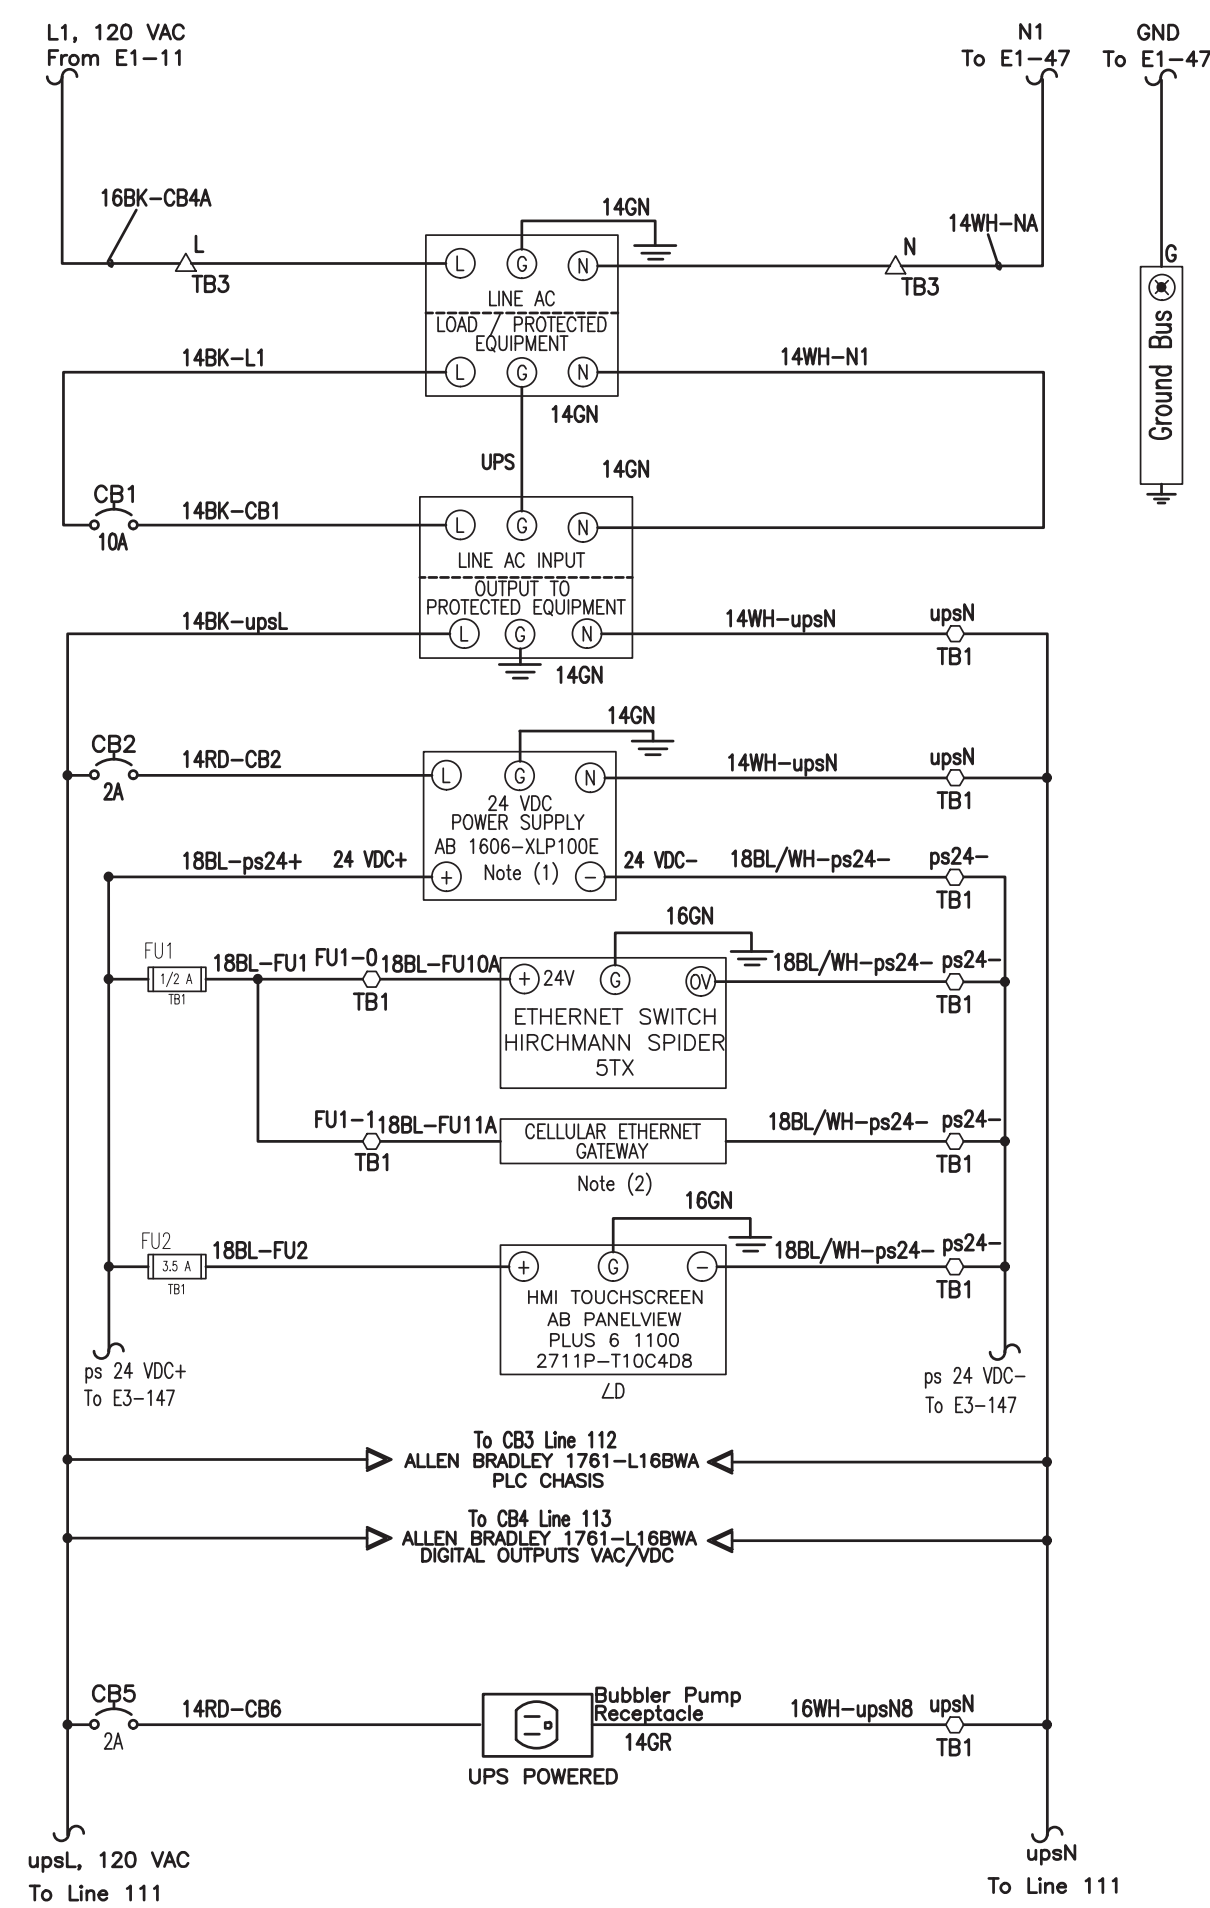

- GENERAL ELECTRICAL NOTES:**
- FINAL COMPONENT SIZE AND SELECTION TO BE DETERMINED BY SYSTEM SUPPLIER IN COORDINATION WITH CITY. IF PANEL VIEW PLUS 400 OR 600 IS REQUIRED, CHANGE POWER SUPPLY TO AB MODEL 1606-XLP100E.
  - SIERRA MODEL Raven XE V2221E-V CELLULAR RADIO TO BE PROVIDED AND CONFIGURED BY CITY.
  - PUMP SEAL FAIL RELAY, IF NEEDED AS PER SPEC OF PUMP MANUFACTURER.
  - LD DENOTES DEVICE MOUNTED ON PANEL DOOR.
  - WIRING GUIDE:
    - 18BL-FU1: WIRE NUMBER (CHARACTERS TO RIGHT OF DASH ONLY)
    - WIRE COLOR
    - WIRE GAUGE IN AWG
  - \* DENOTES COMPONENT MOUNTED OUTSIDE CONTROL PANEL
  - DENOTES FIELD WIRING OUTSIDE CONTROL PANEL
  - TB1 Terminal Block
  - TB2 Terminal Block
  - △ TB3 Terminal Block
  - ◇ TB2A Terminal Block
  - ◇ TB3A Terminal Block
  - \*\* DOOR INTRUSION SWITCH. PROVIDE ONE FOR EACH DOOR AND WIRE IN SERIES.

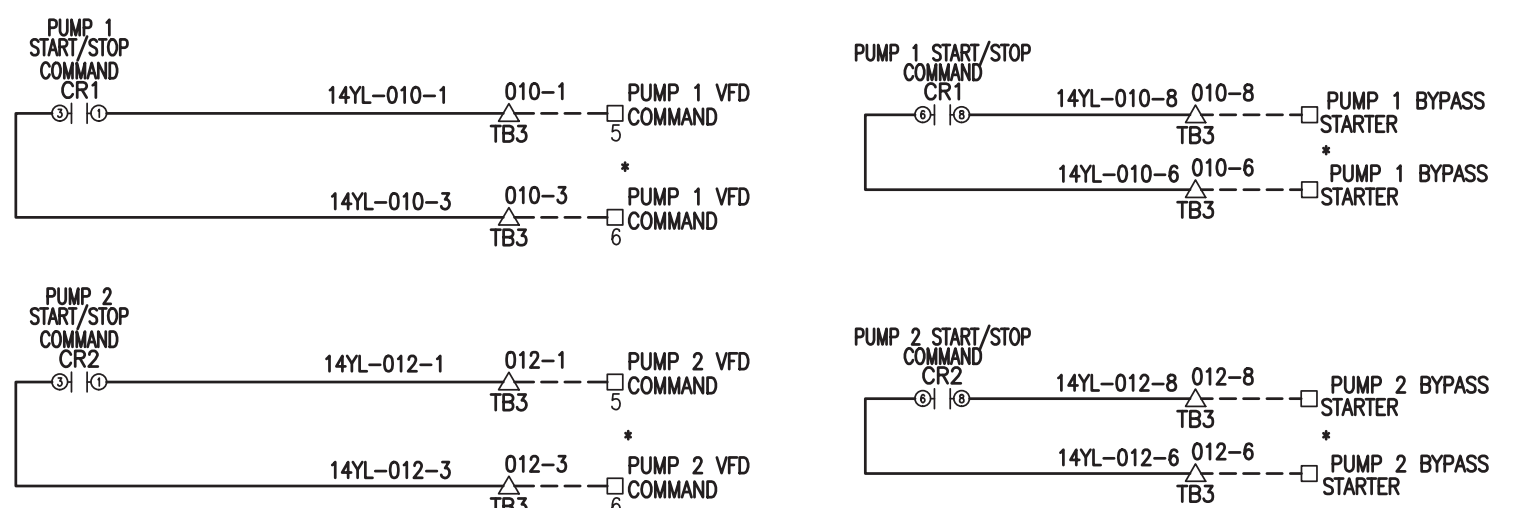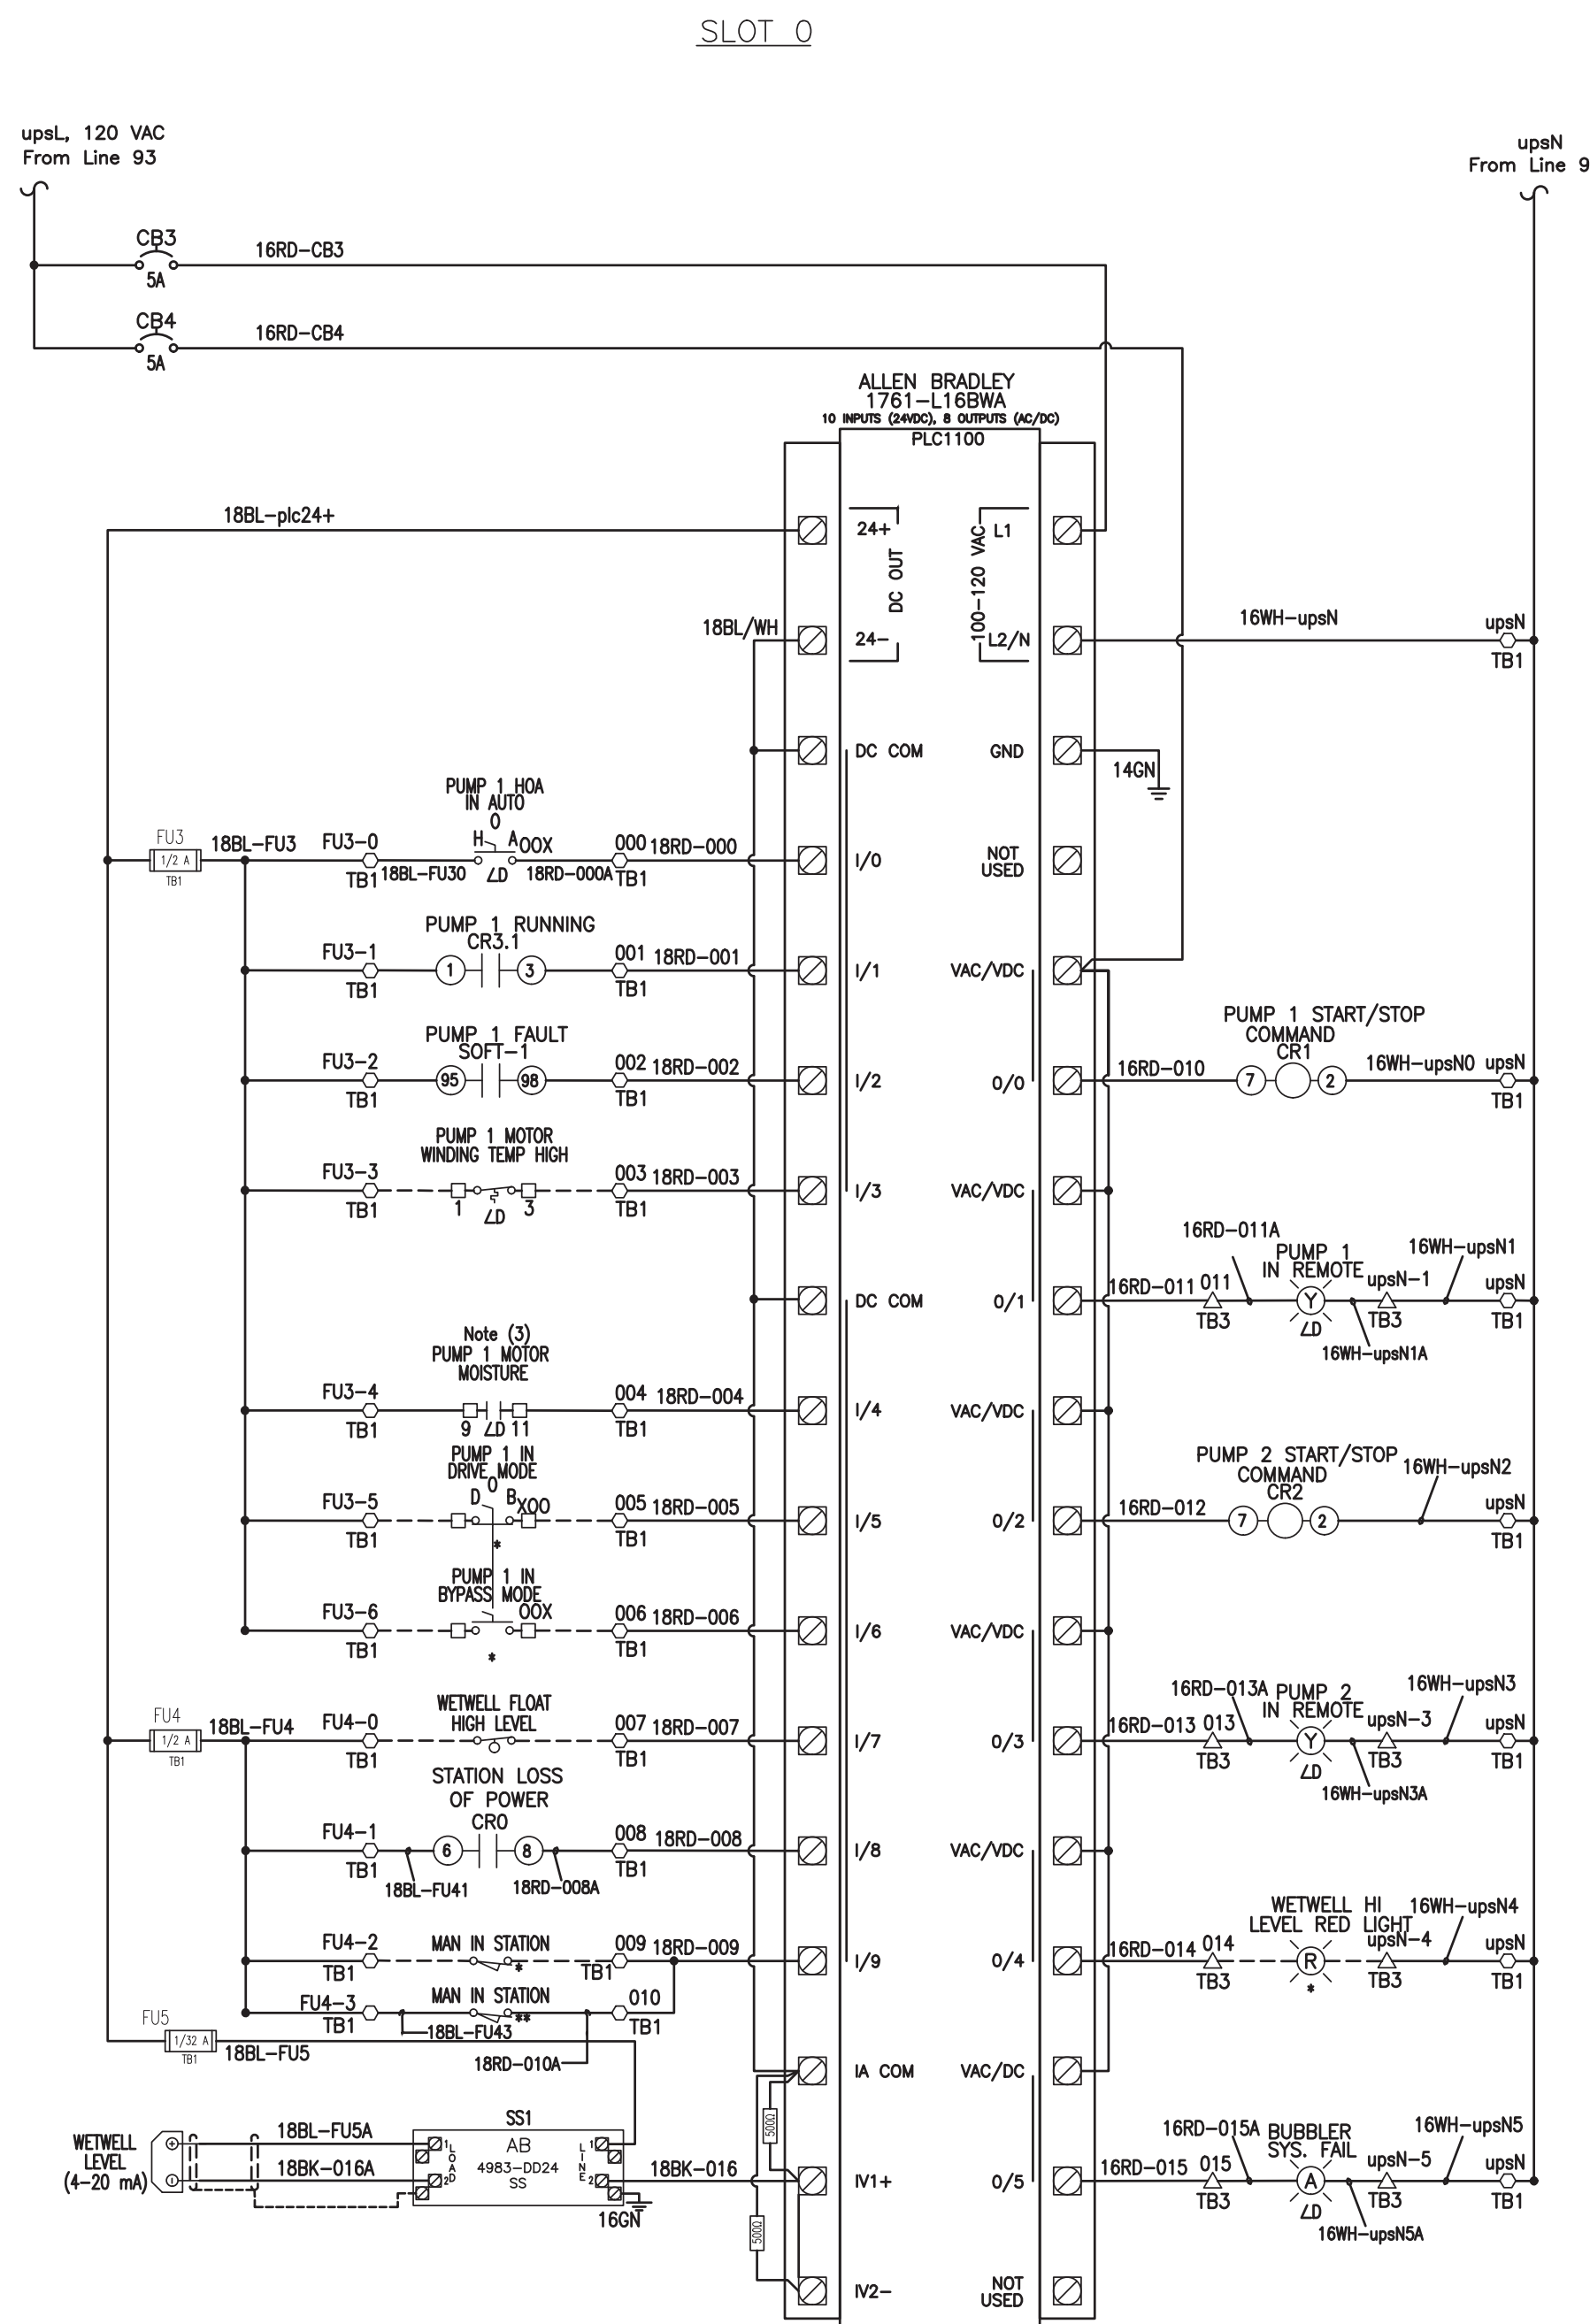

HAMMOND & ASSOCIATES, INC.  
 CONSULTING ENGINEERS  
 499 NW 70TH AVE, SUITE 201  
 PLANTATION, FLORIDA 33317  
 TEL: (954) 327-7111 FAX (954) 327-7154  
 ERIC J. HAMMOND P.E.  
 MECHANICAL / ELECTRICAL ENGINEER  
 P.E. #39048  
 EB 5315

**DESIGN CRITERIA PACKAGE**

PROJECT # 12412  
 PUMP STATION A-16 UPGRADE  
 WASTEWATER DESIGN CRITERIA PACKAGE  
 CONTROL PANEL ELEMENTARY DIAGRAM -  
 SHEET 2


NO.	DATE	BY	CHKD	DESCRIPTION

CITY OF FORT LAUDERDALE  
 PUBLIC WORKS DEPARTMENT  
 ENGINEERING & ARCHITECTURE  
 100 North Andrews Avenue, Fort Lauderdale, Florida 33301

ERIC HAMMOND, P.E.  
 FL LICENSE # PE39048  
 DRAWN BY: H.A.  
 DATE: 04/09/2021  
 DESIGNED BY: H.A.  
 SCALE: AS NOTED  
 CHECKED BY: E.H.  
 FIELD BOOK:

SHEET NO.	OF
26	31
CAD FILE:	12412-26-PANL
DRAWING FILE NO.	4-142-31

This document, together with the concepts and designs presented herein, as an instrument of service, is intended only for the specific purpose and client for which it was prepared. Reuse of and improper reliance on this document without written authorization and adaptation by Kinney-Horn and Associates, Inc. shall be without liability to Kinney-Horn and Associates, Inc.

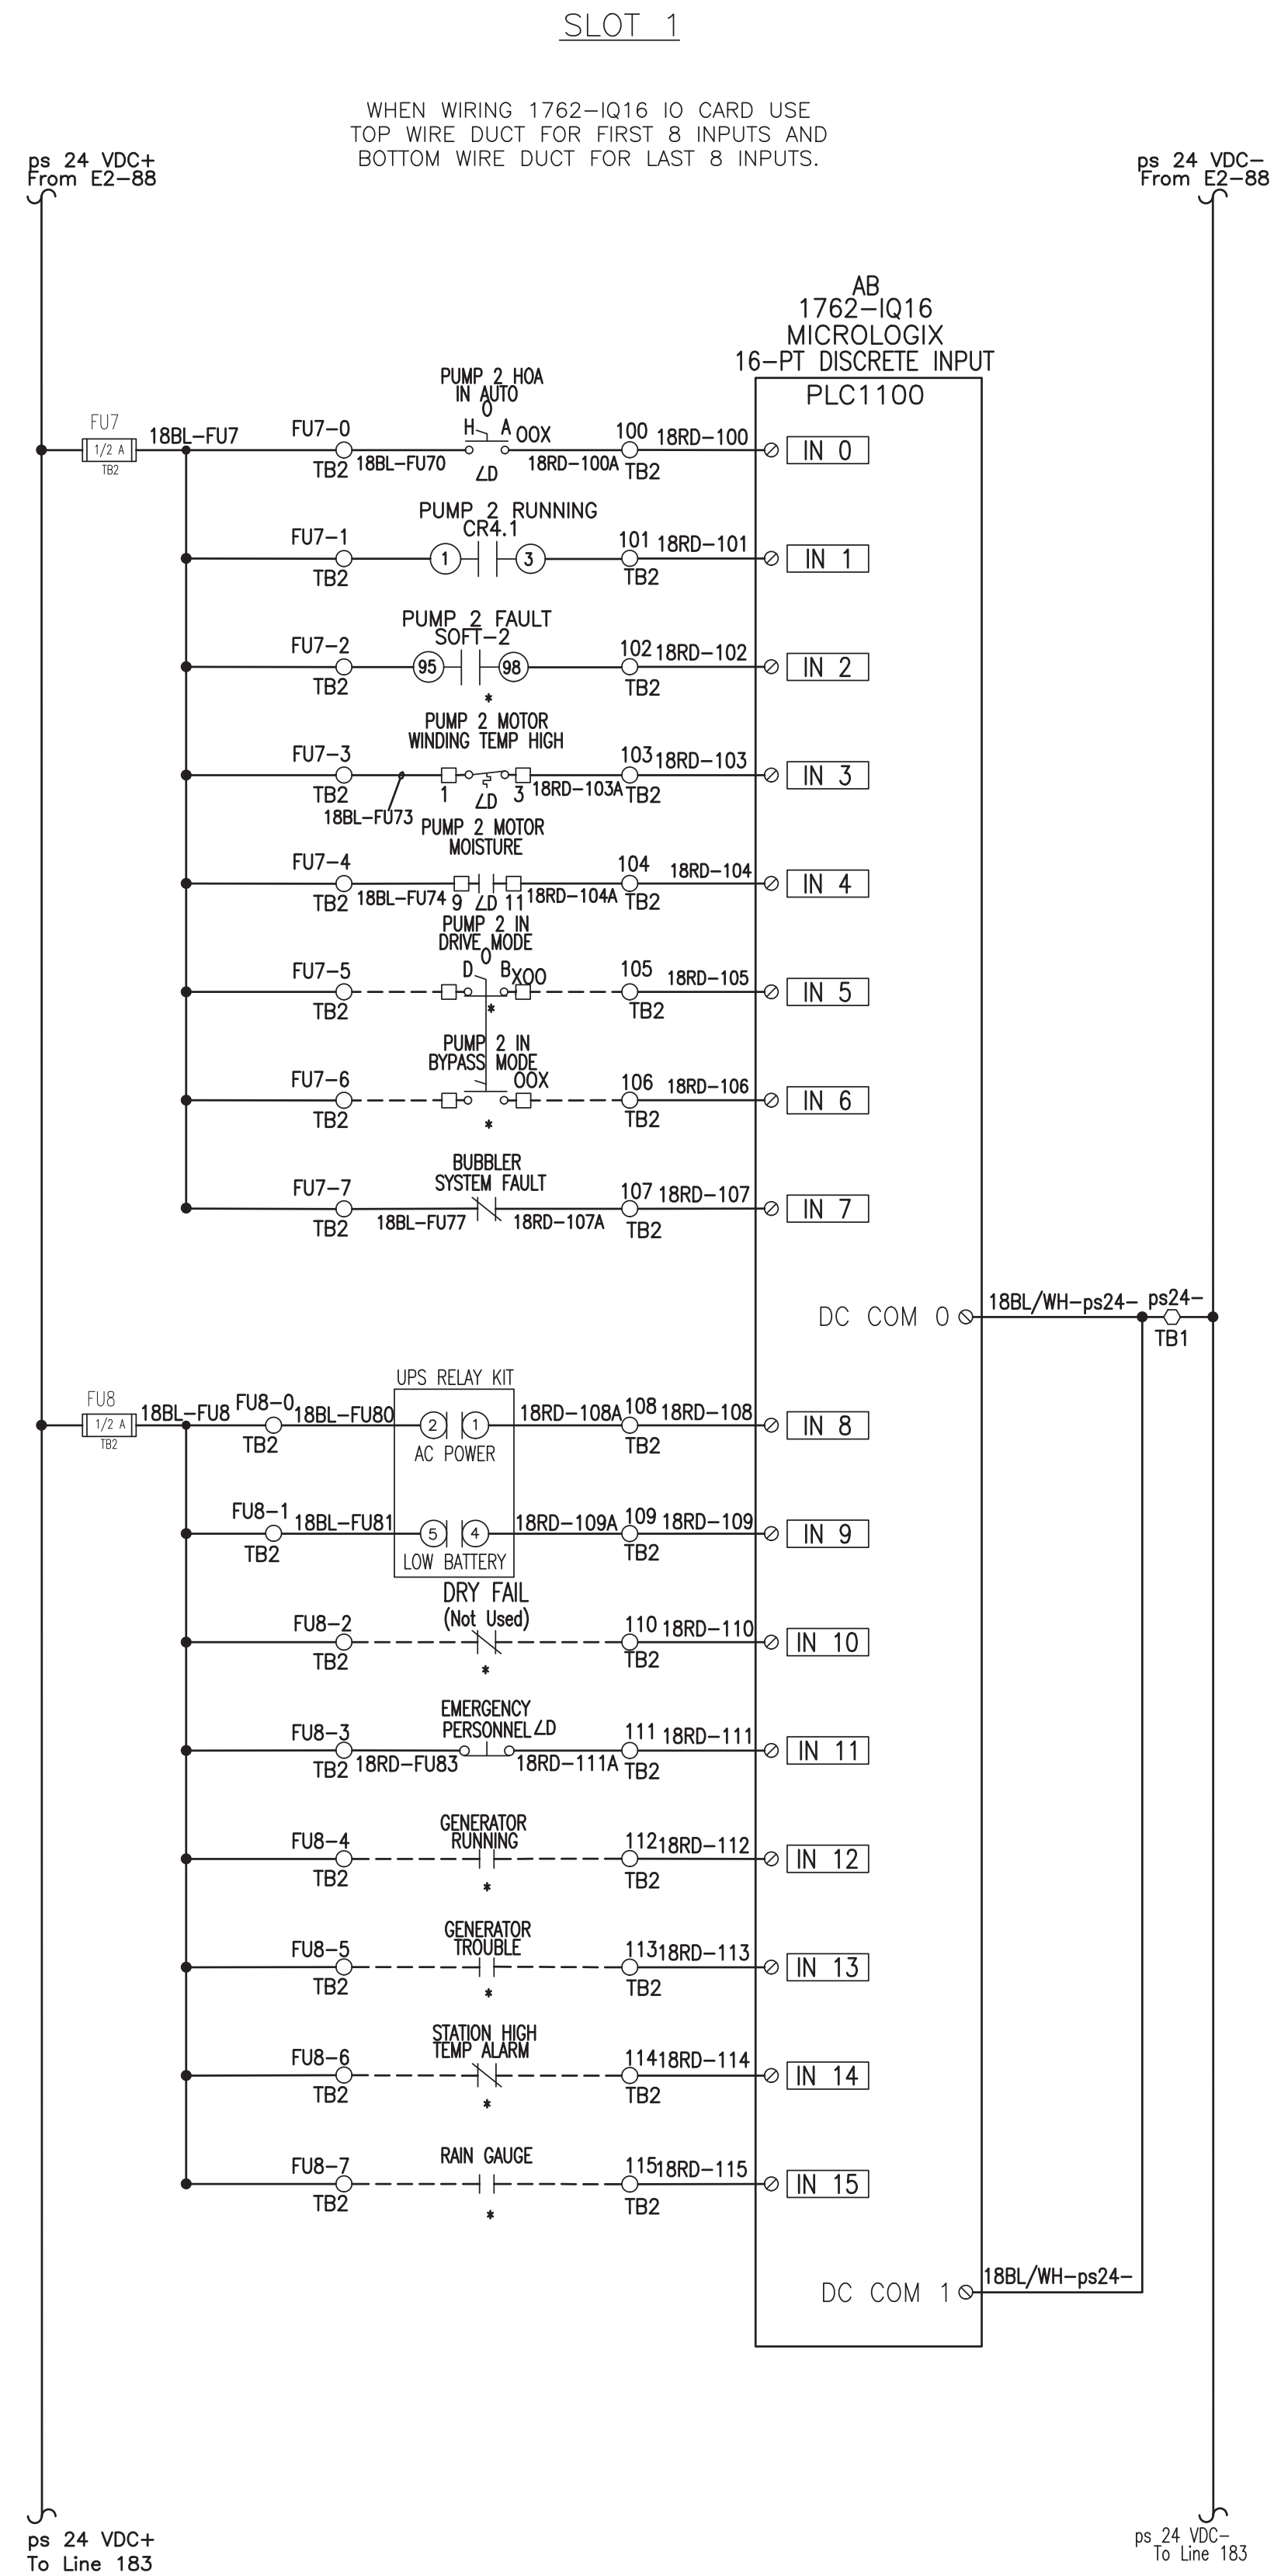

**GENERAL ELECTRICAL NOTES:**

1. FINAL COMPONENT SIZE AND SELECTION TO BE DETERMINED BY SYSTEM SUPPLIER IN COORDINATION WITH CITY. IF PANEL VIEW PLUS 400 OR 600 IS REQUIRED, CHANGE POWER SUPPLY TO AB MODEL 1606-XLP100E.
  2. SIERRA MODEL Raven XE V2221E-V CELLULAR RADIO TO BE PROVIDED AND CONFIGURED BY CITY.
  3. PUMP SEAL FAIL RELAY. IF NEEDED AS PER SPEC OF PUMP MANUFACTURER.
  4. LD DENOTES DEVICE MOUNTED ON PANEL DOOR.
  5. WIRING GUIDE:
    - 18BL-FU1 WIRE NUMBER (CHARACTERS TO RIGHT OF DASH ONLY)
    - 18BL WIRE COLOR
    - 18 WIRE GAUGE IN AWG
  6. \* DENOTES COMPONENT MOUNTED OUTSIDE CONTROL PANEL
  7. --- DENOTES FIELD WIRING OUTSIDE CONTROL PANEL
- TB1 Terminal Block  
 ○ TB2 Terminal Block  
 △ TB3 Terminal Block  
 ⊕ TB2A Terminal Block  
 ⊖ TB3A Terminal Block

ERIC HAMMOND, P.E.

FL LICENSE # PE9048

DRAWN BY: H.A.	DATE: 04/09/2021	DESIGNED BY: H.A.	SCALE: AS NOTED
CHECKED BY: E.H.	FIELD BOOK:		

**CITY OF FORT LAUDERDALE**  
PUBLIC WORKS DEPARTMENT  
ENGINEERING & ARCHITECTURE

100 North Andrews Avenue, Fort Lauderdale, Florida 33301

REVISIONS	
NO.	DESCRIPTION


**DESIGN CRITERIA PACKAGE**

**PROJECT # 12412**  
**PUMP STATION A-16 UPGRADE**  
**WASTEWATER DESIGN CRITERIA PACKAGE**  
**CONTROL PANEL ELEMENTARY DIAGRAM -**  
**SHEET 3**

SHEET NO. 27	OF 31
CAD FILE: 12412-27-PANL	
DRAWING FILE NO. 4-142-31	


HAMMOND & ASSOCIATES, INC.  
CONSULTING ENGINEERS  
499 NW 70TH AVE, SUITE 201  
PLANTATION, FLORIDA 33317  
TEL: (954) 327-7111 FAX (954) 327-7154  
ERIC J. HAMMOND P.E.  
MECHANICAL / ELECTRICAL ENGINEER  
P.E. #39048  
EB 5315

This document, together with the concepts and designs presented herein, is intended only for the specific purpose and client for which it was prepared. Reuse of and improper reliance on this document without written authorization and adaptation by Kinney-Horn and Associates, Inc. shall be without liability to Kinney-Horn and Associates, Inc.

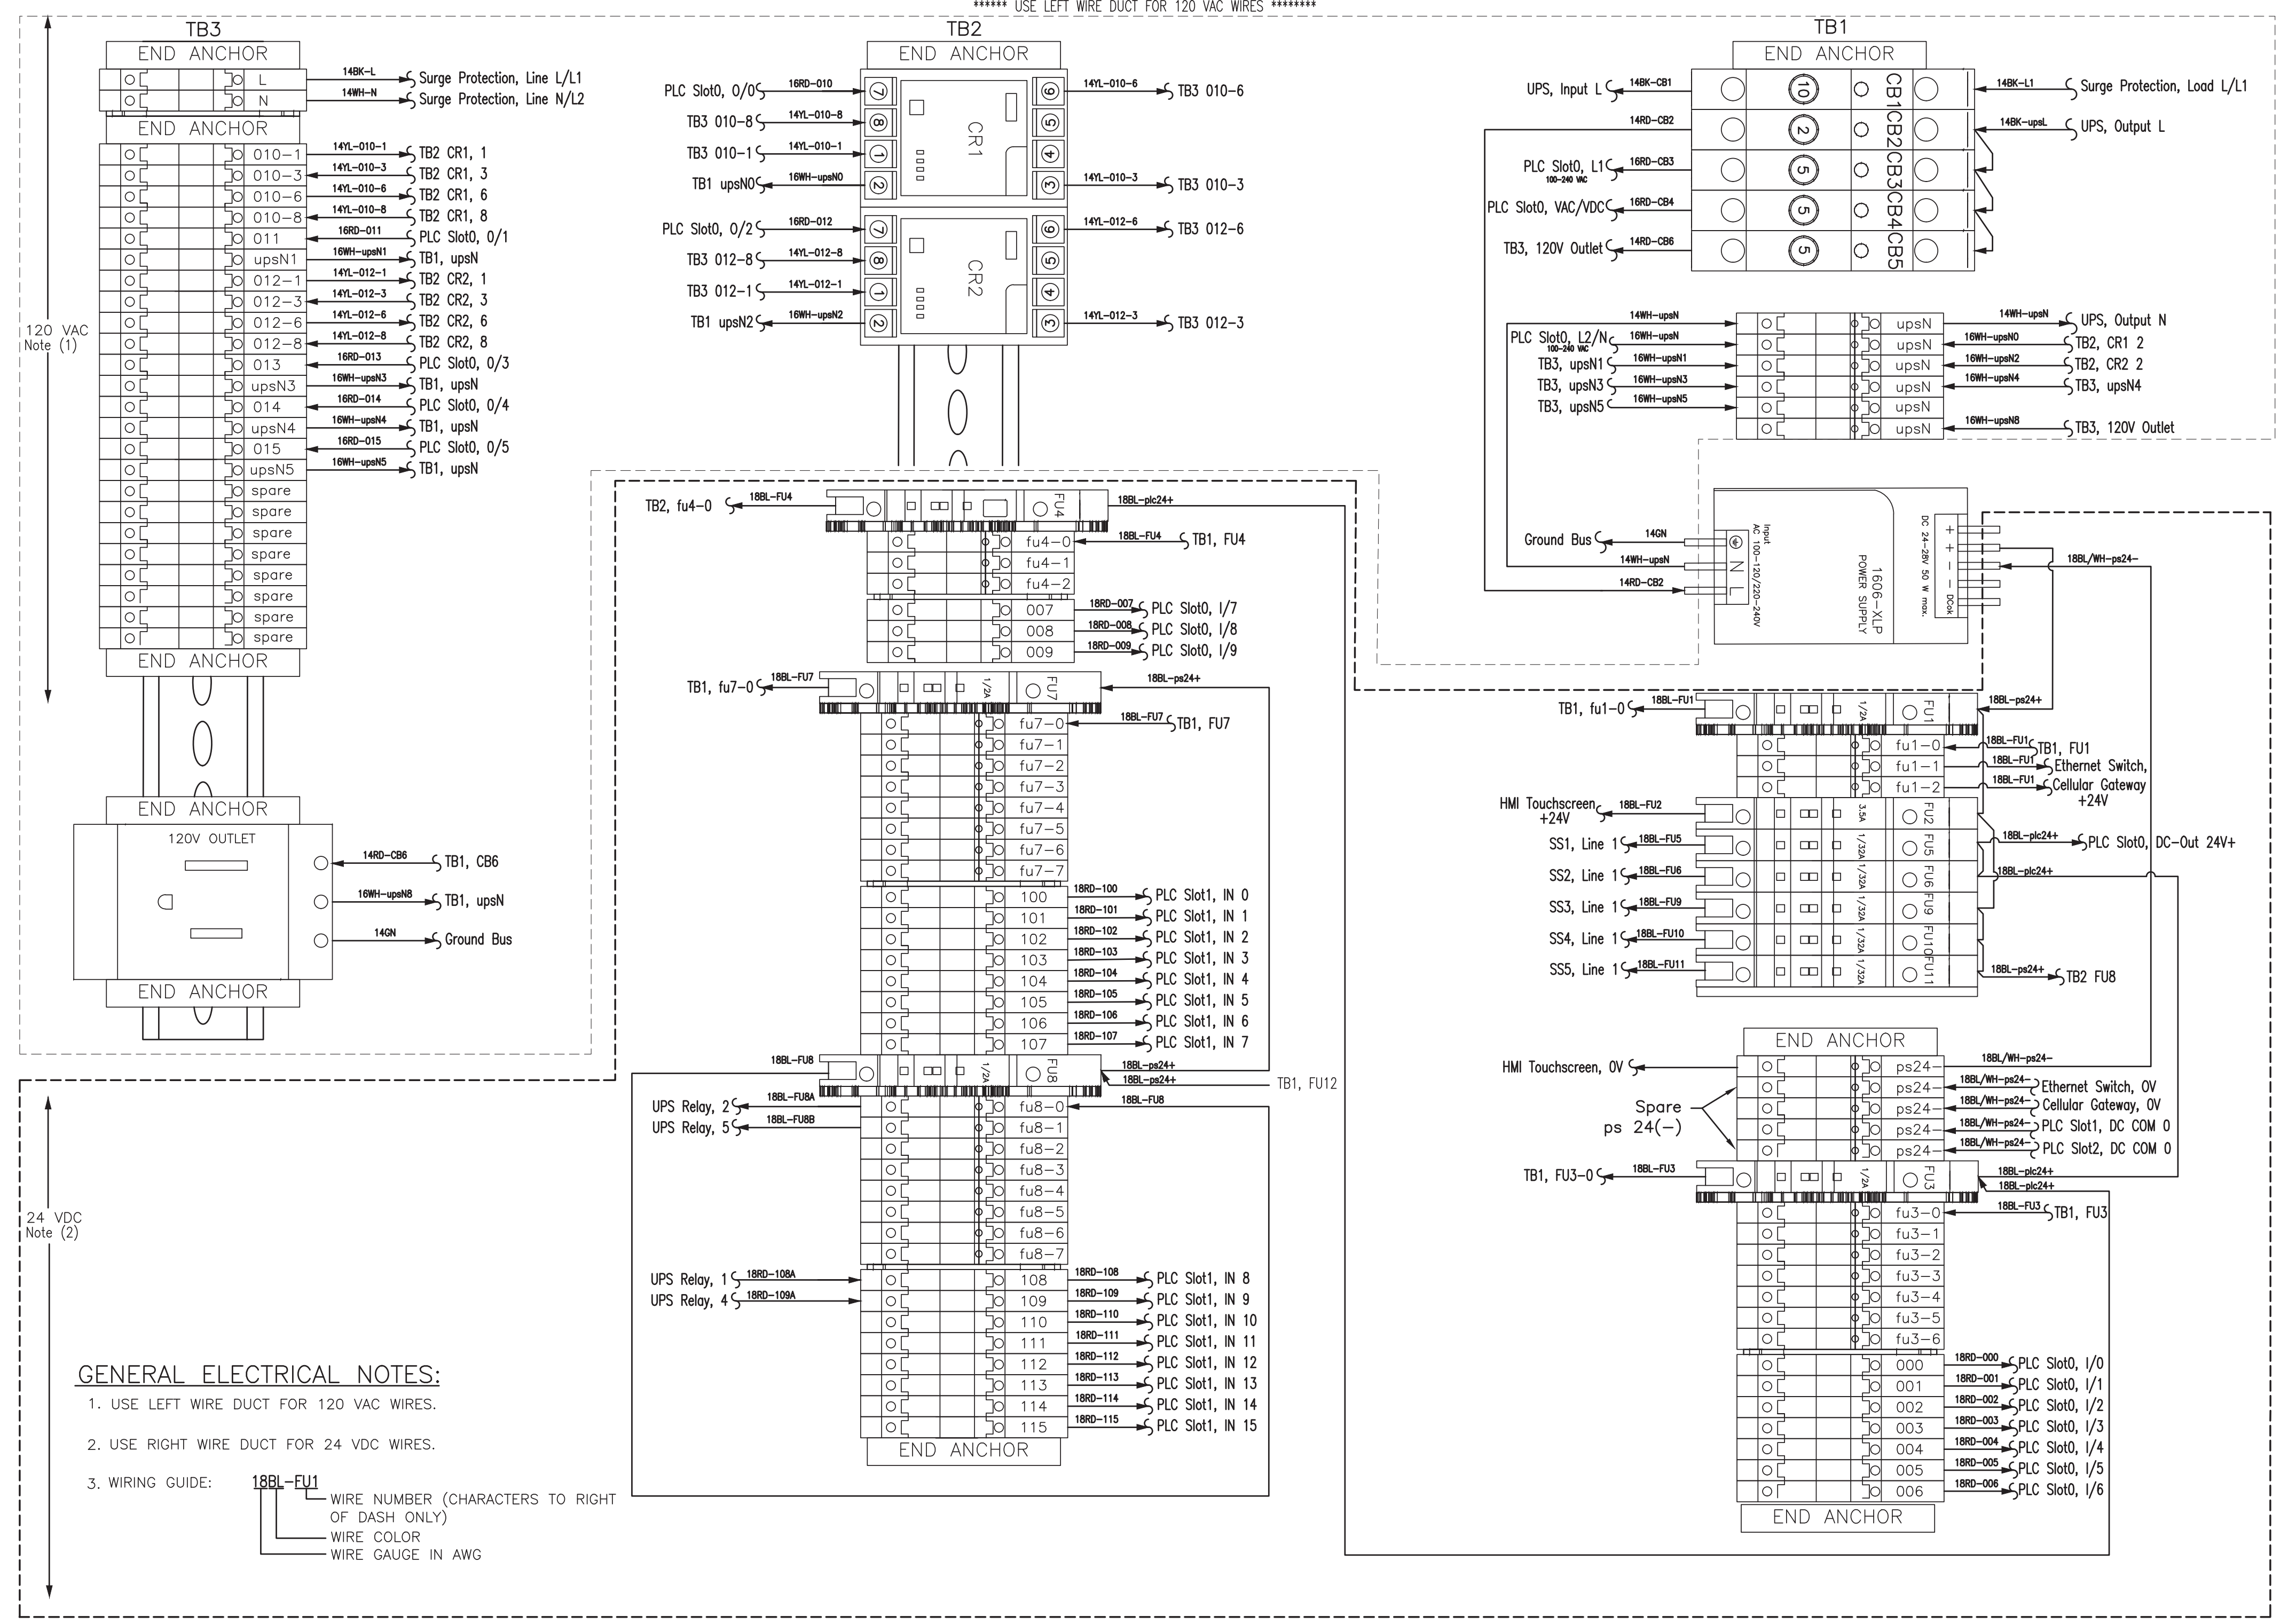

**GENERAL ELECTRICAL NOTES:**

1. USE LEFT WIRE DUCT FOR 120 VAC WIRES.
2. USE RIGHT WIRE DUCT FOR 24 VDC WIRES.
3. WIRING GUIDE:

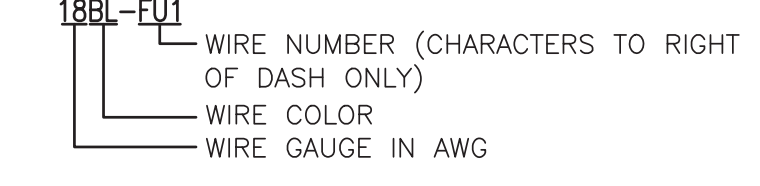

ERIC HAMMOND, P.E.  
 FL LICENSE # PE59048

DATE: 04/08/2021  
 DESIGNED BY: H.A.  
 CHECKED BY: E.H.  
 SCALE: AS NOTED  
 FIELD BOOK:

**CITY OF FORT LAUDERDALE**  
 PUBLIC WORKS DEPARTMENT  
 ENGINEERING & ARCHITECTURE  
 100 North Andrews Avenue, Fort Lauderdale, Florida 33301

NO.	DATE	BY	CHKD	DESCRIPTION


**DESIGN CRITERIA PACKAGE**  
 PROJECT # 12412  
 PUMP STATION A-16 UPGRADE  
 WASTEWATER DESIGN CRITERIA PACKAGE  
 CONTROL PANEL INTERCONNECTION  
 WIRING DIAGRAM

SHEET NO. 28 OF 31  
 CAD FILE: 12412-28-PANL  
 DRAWING FILE NO. 4-142-31



HAMMOND & ASSOCIATES, INC.  
 CONSULTING ENGINEERS  
 499 NW 70TH AVE, SUITE 201  
 PLANTATION, FLORIDA 33317  
 TEL: (954) 327-7111 FAX (954) 327-7154  
 ERIC J. HAMMOND P.E.  
 MECHANICAL / ELECTRICAL ENGINEER  
 P.E. #59048  
 EB 5315

This document, together with the concepts and designs presented herein, as an instrument of service, is intended only for the specific purpose and client for which it was prepared. Reuse of and improper reliance on this document without written authorization and adaptation by Kimley-Horn and Associates, Inc. shall be without liability to Kimley-Horn and Associates, Inc.

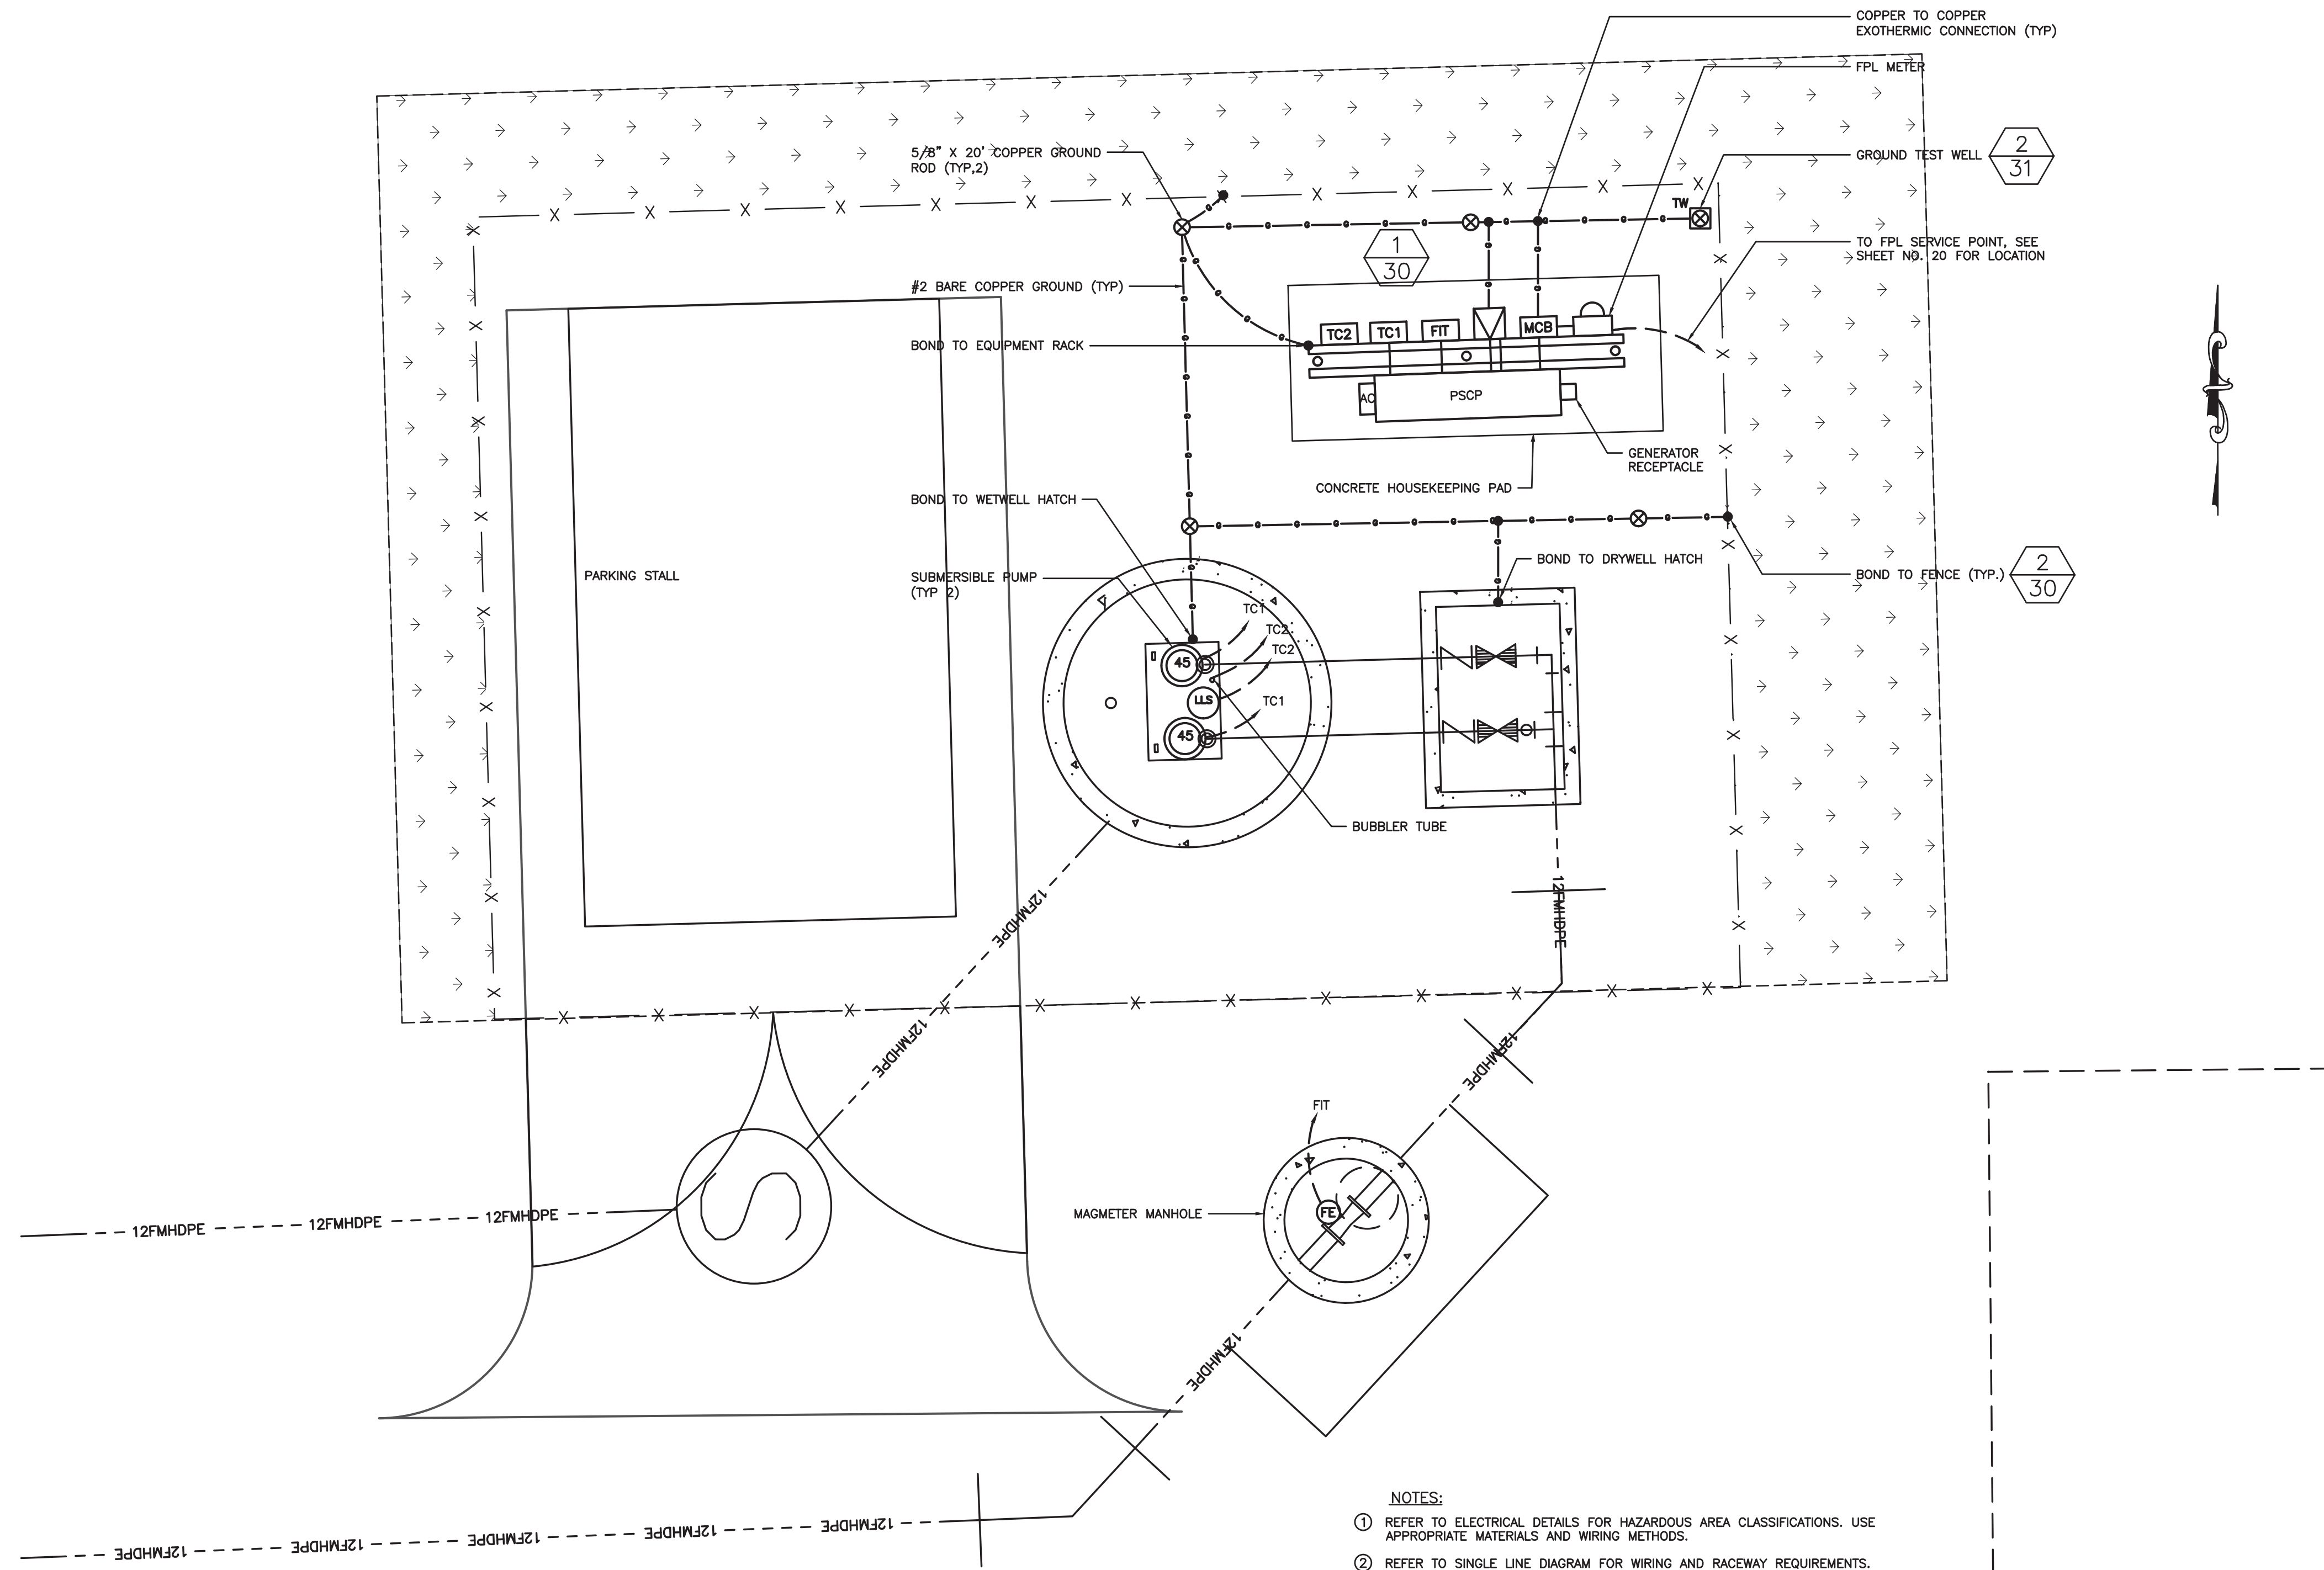

**ELECTRICAL PLAN VIEW**

SCALE: 3/8"=1'-0"

- NOTES:**
- ① REFER TO ELECTRICAL DETAILS FOR HAZARDOUS AREA CLASSIFICATIONS. USE APPROPRIATE MATERIALS AND WIRING METHODS.
  - ② REFER TO SINGLE LINE DIAGRAM FOR WIRING AND RACEWAY REQUIREMENTS.
  - ③ ALL CONDUITS ENTERING THE WET WELL, INCLUDING PIPING FOR BUBBLER TUBE, SHALL TERMINATE WITHIN SIX INCHES OF THE WET WELL ACCESS HATCH OPENING.
  - ④ AVOID MOISTURE TRAPS IN RACEWAY INSTALLATION.
  - ⑤ WHEREVER POSSIBLE, PROVIDE 24" SPACING BETWEEN RACEWAYS HOUSING POWER CONDUCTORS AND RACEWAYS HOUSING 24VDC DISCRETE AND ANALOG CIRCUITS.



HAMMOND & ASSOCIATES, INC.  
 CONSULTING ENGINEERS  
 499 NW 70TH AVE., SUITE 201  
 PLANTATION, FLORIDA 33317  
 TEL: (954) 327-7111 FAX (954) 327-7154  
 ERIC J. HAMMOND P.E.  
 MECHANICAL / ELECTRICAL ENGINEER  
 P.E. #39048  
 EB 5315

**DESIGN CRITERIA PACKAGE**

**PROJECT # 12412  
 PUMP STATION A-16 UPGRADE  
 WASTEWATER DESIGN CRITERIA PACKAGE  
 ENLARGED ELECTRICAL PLAN**

SHEET NO.	OP
29	31
CAD FILE: 12412-29-PLAN	
DRAWING FILE NO. 4-142-31	



NO.	DATE	BY	CHKD	DESCRIPTION

**CITY OF FORT LAUDERDALE  
 PUBLIC WORKS DEPARTMENT  
 ENGINEERING & ARCHITECTURE**  
  
 100 North Andrews Avenue, Fort Lauderdale, Florida 33301

DESIGNED BY:	H.A.	AS NOTED
CHECKED BY:	E.H.	
DATE:	04/08/2021	
SCALE:		
FIELD BOOK:		

ERIC HAMMOND, P.E.  
 FL LICENSE # PE39048


This document, together with the concepts and designs presented herein, is an instrument of service, is intended only for the specific purpose and client for which it was prepared. Reuse of and improper reliance on this document without written authorization and adaptation by Kinley-Horn and Associates, Inc. shall be without liability to Kinley-Horn and Associates, Inc.

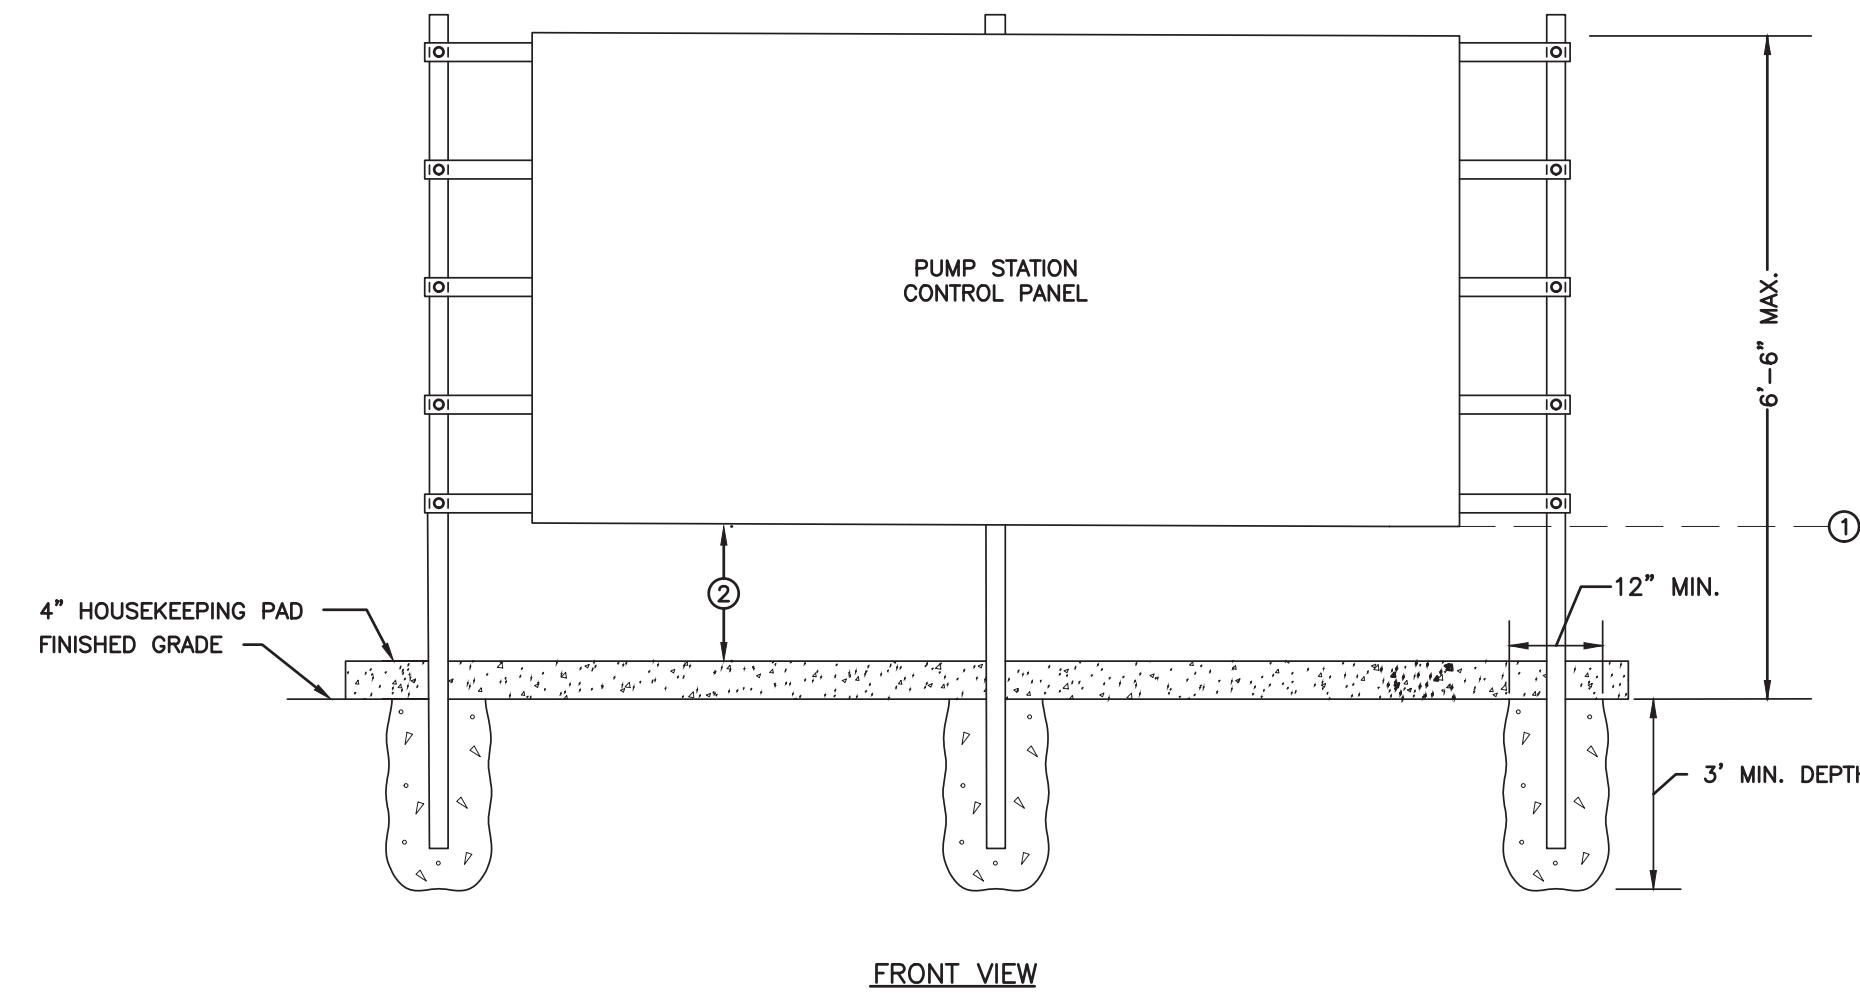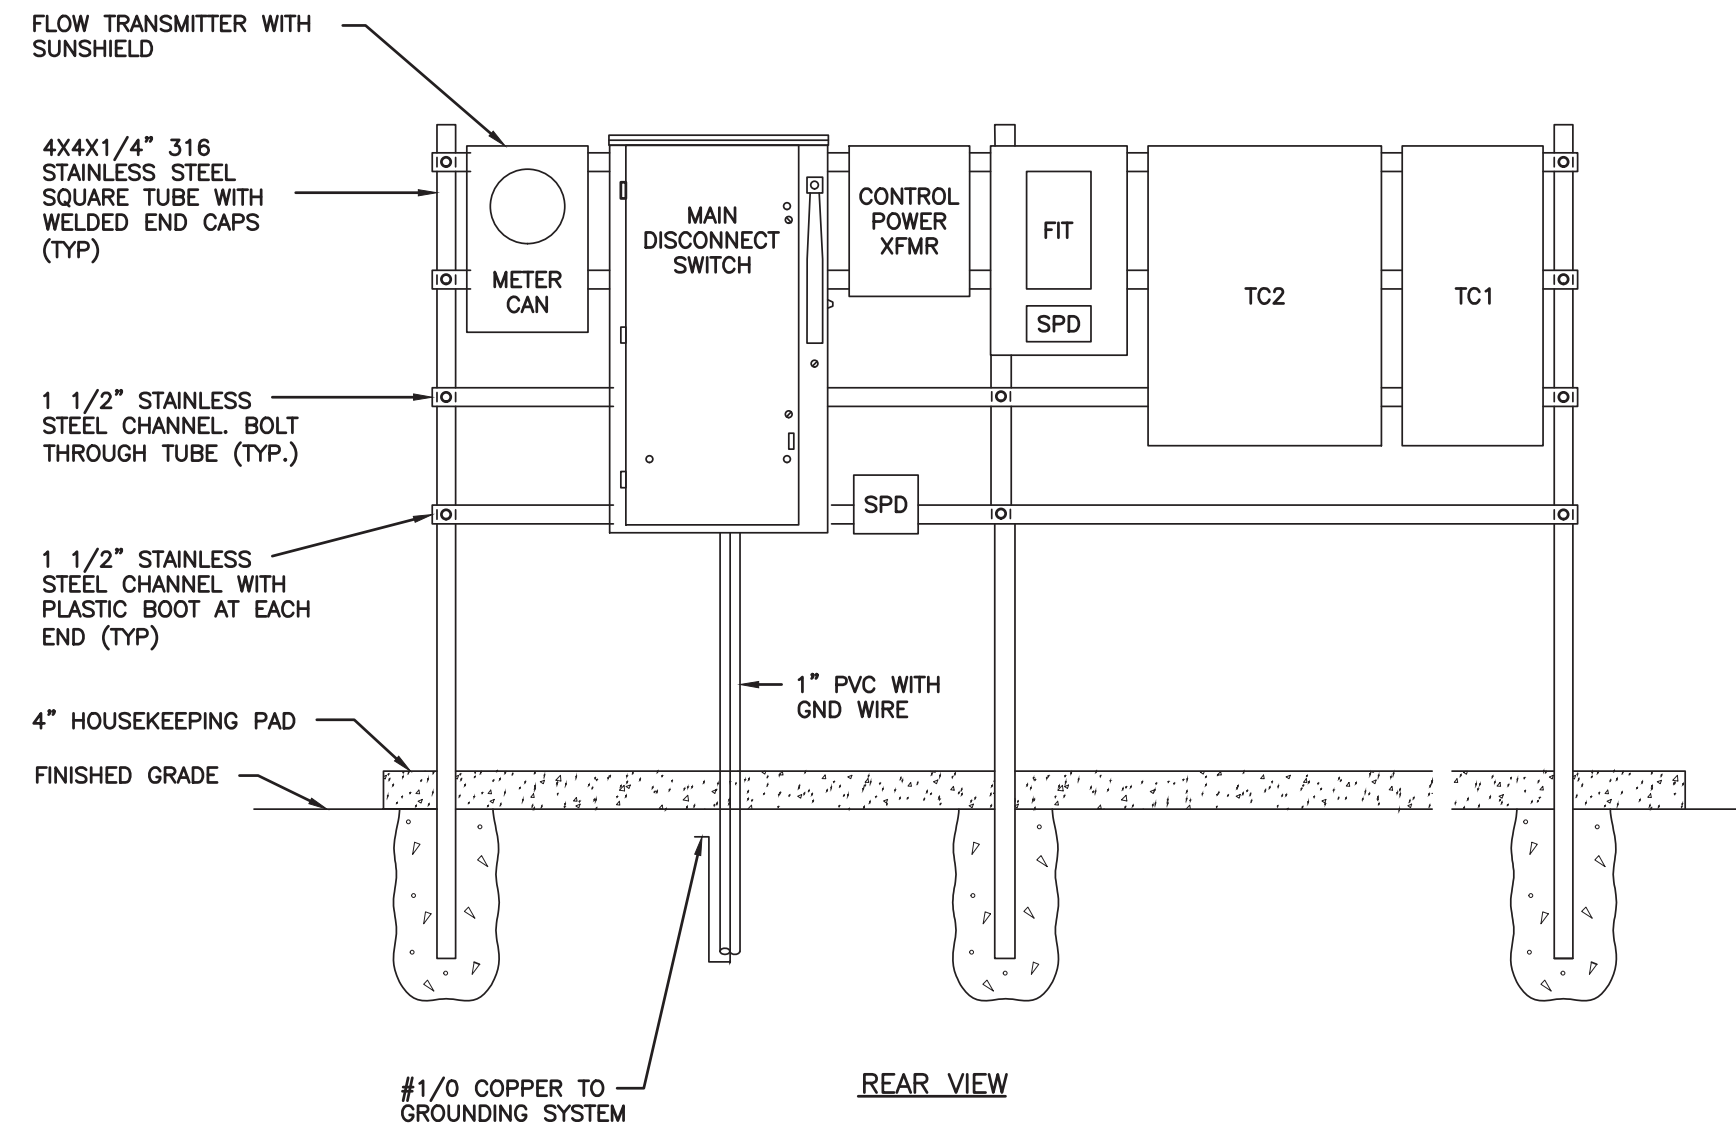

- GENERAL NOTES:**
- A. DEPTH AS REQUIRED TO MEET FLORIDA BUILDING CODE WIND LOAD REQUIREMENTS. CONTRACTOR SHALL SUBMIT SIGNED AND SEALED WIND LOAD CALCULATIONS FROM A STRUCTURAL ENGINEER LICENSED IN THE STATE OF FLORIDA.
  - B. ALL HARDWARE SHALL BE 316 STAINLESS STEEL UNLESS OTHERWISE NOTED.
  - C. REAR SUNSHIELDS ARE REQUIRED FOR ALL ELECTRICAL EQUIPMENT RACKS. SEE TYPICAL EQUIPMENT RACK REAR SUNSHIELD DETAIL BELOW.
  - D. REFER TO SINGLE LINE DIAGRAM FOR WIRING AND RACEWAY REQUIREMENTS.
  - E. CONTRACTOR MAY REARRANGE THE ORDER OF EQUIPMENT ON THE RACK, TO SUIT THE INSTALLATION.

- KEY NOTES:**
- ① BASE FLOOD ELEVATION IS 6'-0" NAVD 88, FLOOD ZONE X. INSTALL BOTTOM OF ALL ELECTRICAL EQUIPMENT AT BASE FLOOD ELEVATION.
  - ② DIMENSION "X". CONFIRM GRADE ELEVATION AND DIMENSION "X" WITH ENGINEER PRIOR TO PANEL INSTALLATION.

1  
30 ELECTRICAL EQUIPMENT RACK FRONT/REAR VIEW ELEVATION  
NOT TO SCALE

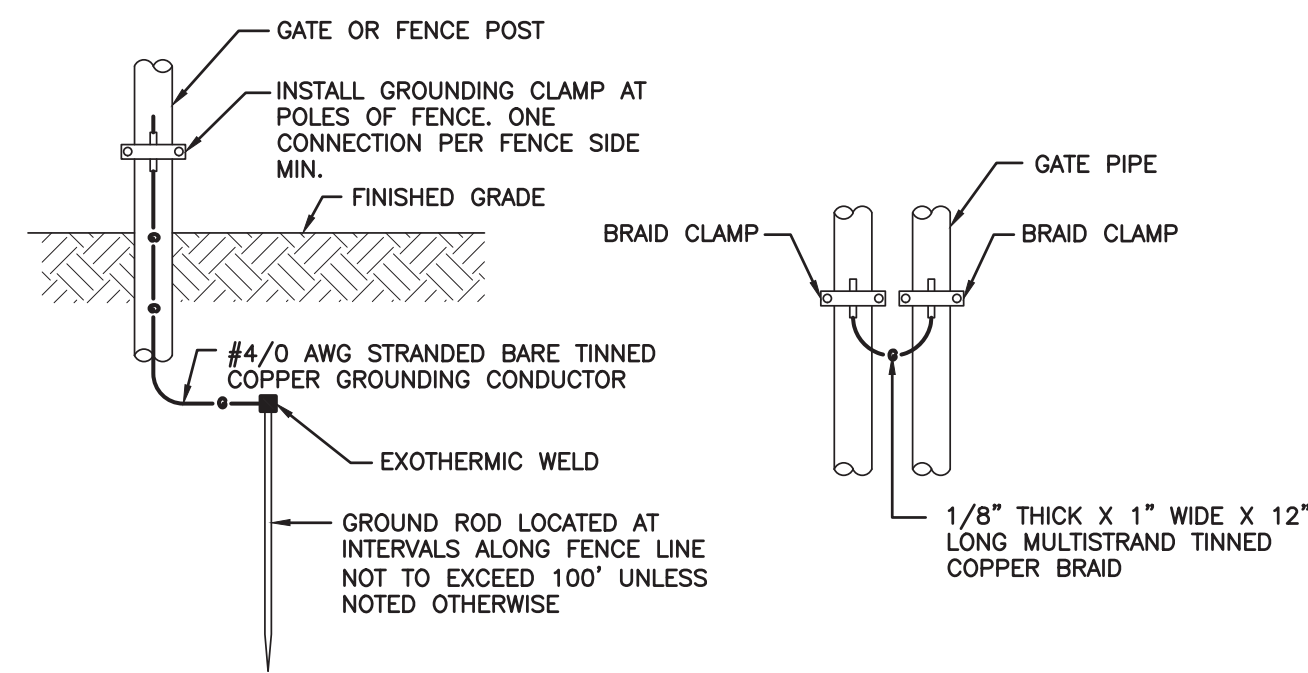

2  
30 TYPICAL GATE/FENCE POST GROUNDING DETAIL  
NOT TO SCALE

ERIC HAMMOND, P.E.  
FL LICENSE # PE59048

DATE:	04/09/2021
DESIGNED BY:	H.A.
CHECKED BY:	H.A.
SCALE:	AS NOTED
FIELD BOOK:	E.H.

CITY OF FORT LAUDERDALE  
PUBLIC WORKS DEPARTMENT  
ENGINEERING & ARCHITECTURE  
100 North Andrews Avenue, Fort Lauderdale, Florida 33301

NO.	DATE	BY	CHKD	DESCRIPTION

PROJECT # 12412  
PUMP STATION A-16 UPGRADE  
WASTEWATER DESIGN CRITERIA PACKAGE  
ELECTRICAL DETAILS - 1


SHEET NO.	OP
30	31
CAD FILE:	12412-30-DET1
DRAWING FILE NO.	4-142-31




HAMMOND & ASSOCIATES, INC.  
CONSULTING ENGINEERS  
499 NW 70TH AVE, SUITE 201  
PLANTATION, FLORIDA 33317  
TEL: (954) 327-7111 FAX (954) 327-7154  
ERIC J. HAMMOND P.E.  
MECHANICAL / ELECTRICAL ENGINEER  
P.E. #59048  
EB 5315

DESIGN CRITERIA PACKAGE


This document, together with the concepts and designs presented herein, as an instrument of service, is intended only for the specific purpose and client for which it was prepared. Reuse of and improper reliance on this document without written authorization and adaptation by Kinley-Horn and Associates, Inc. shall be without liability to Kinley-Horn and Associates, Inc.

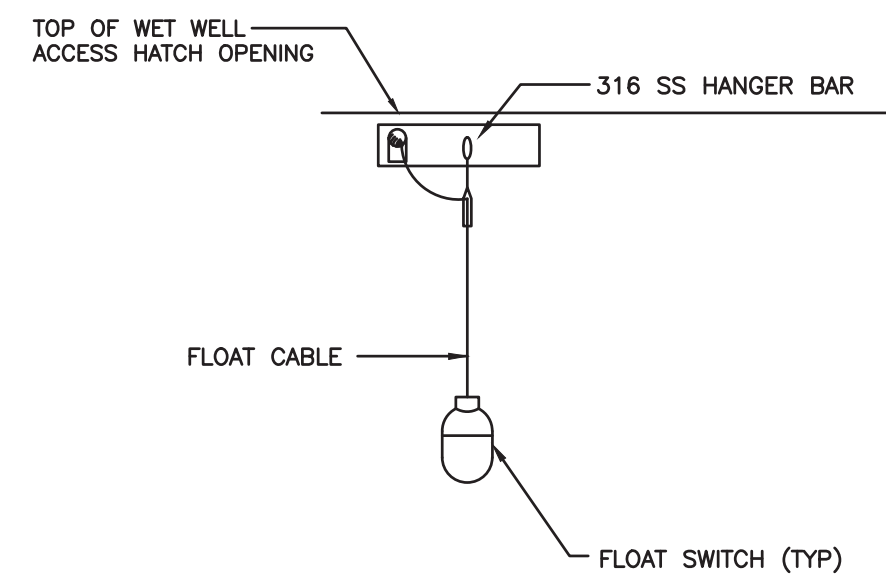


**1**  
31 TYPICAL LEVEL SWITCH MOUNTING DETAIL  
N.T.S.

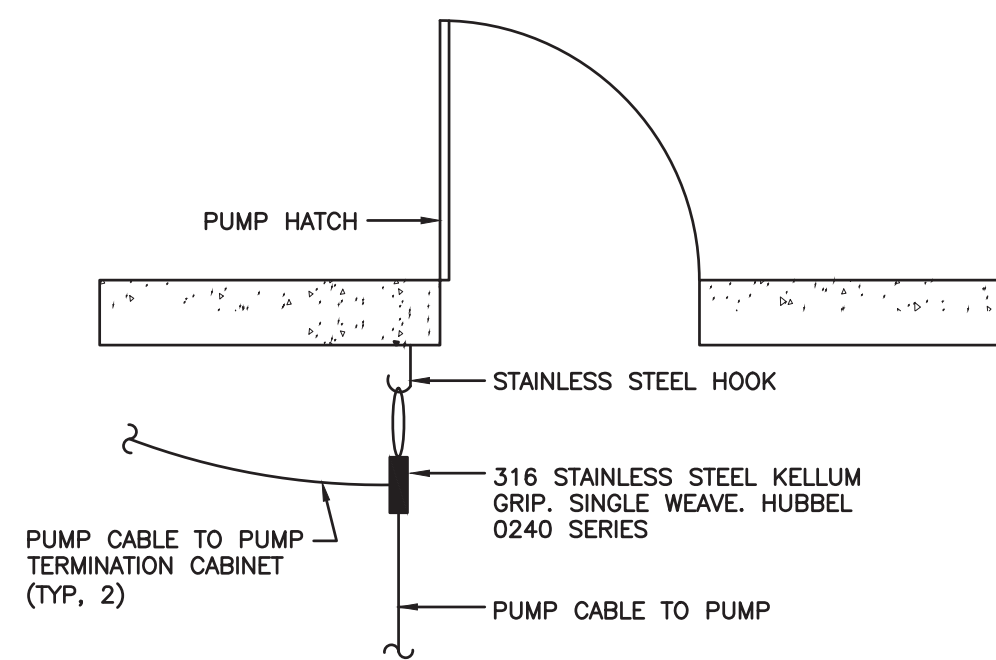

**3**  
31 TYPICAL PUMP CABLE MOUNTING DETAIL  
N.T.S.

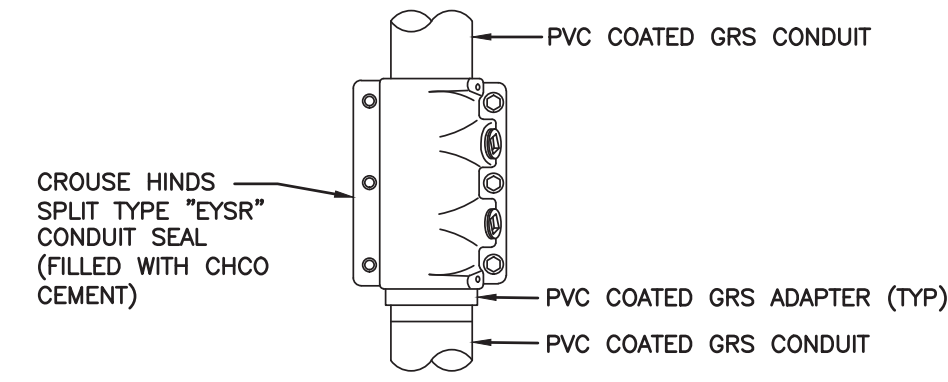


**5**  
31 CONDUIT SEAL DETAIL  
SCALE: N.T.S.

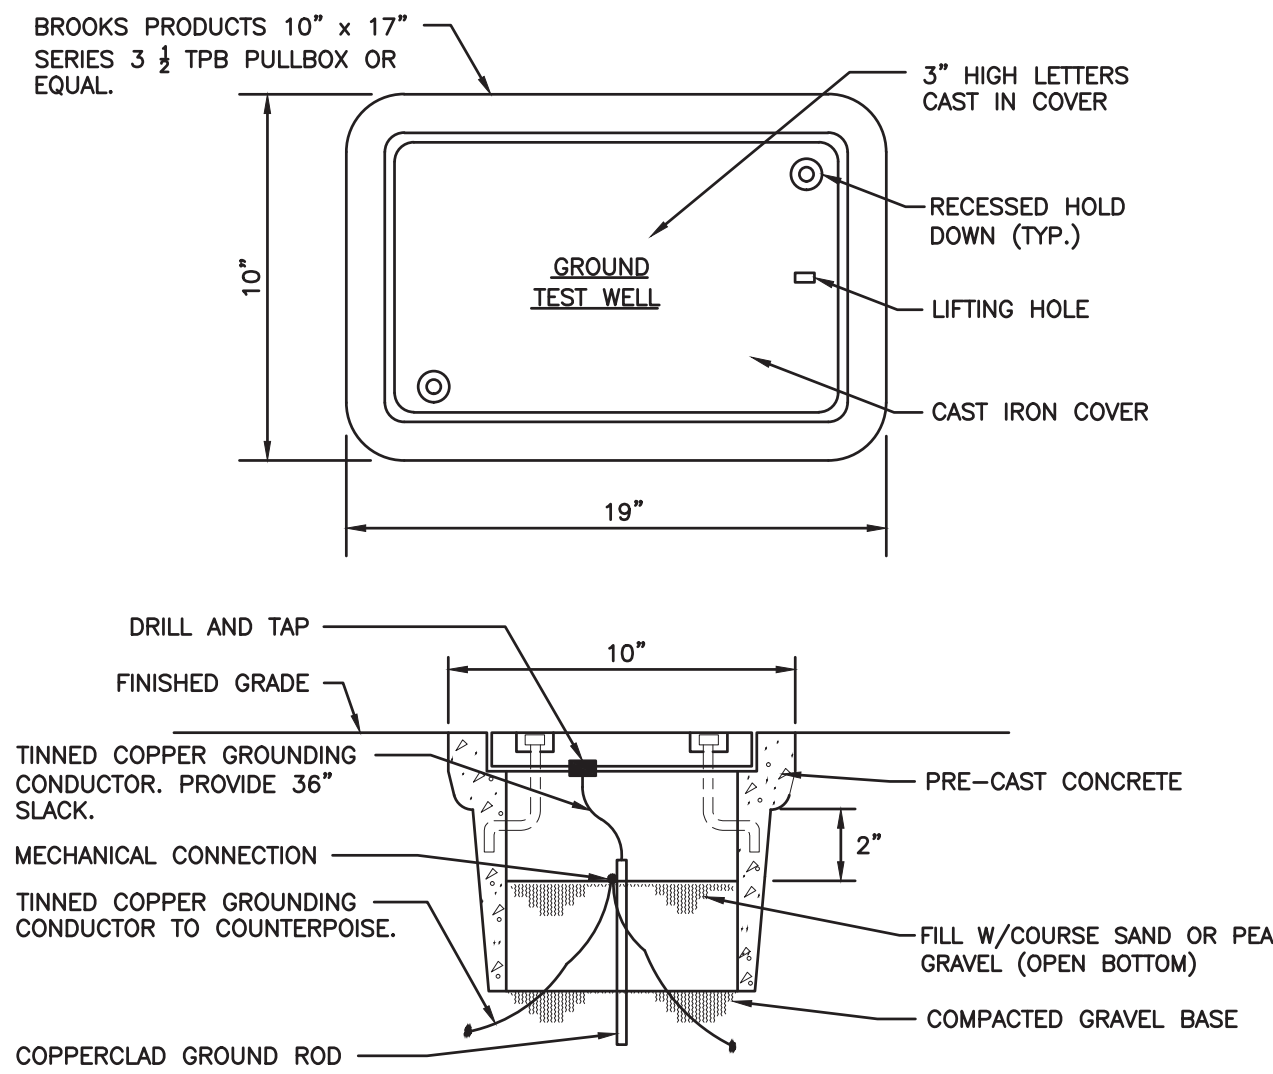

**2**  
31 TYPICAL GROUND TEST WELL  
SCALE: N.T.S.

NOTES:  
① TEST WELL AND COVER SHALL BE H-20 RATED.

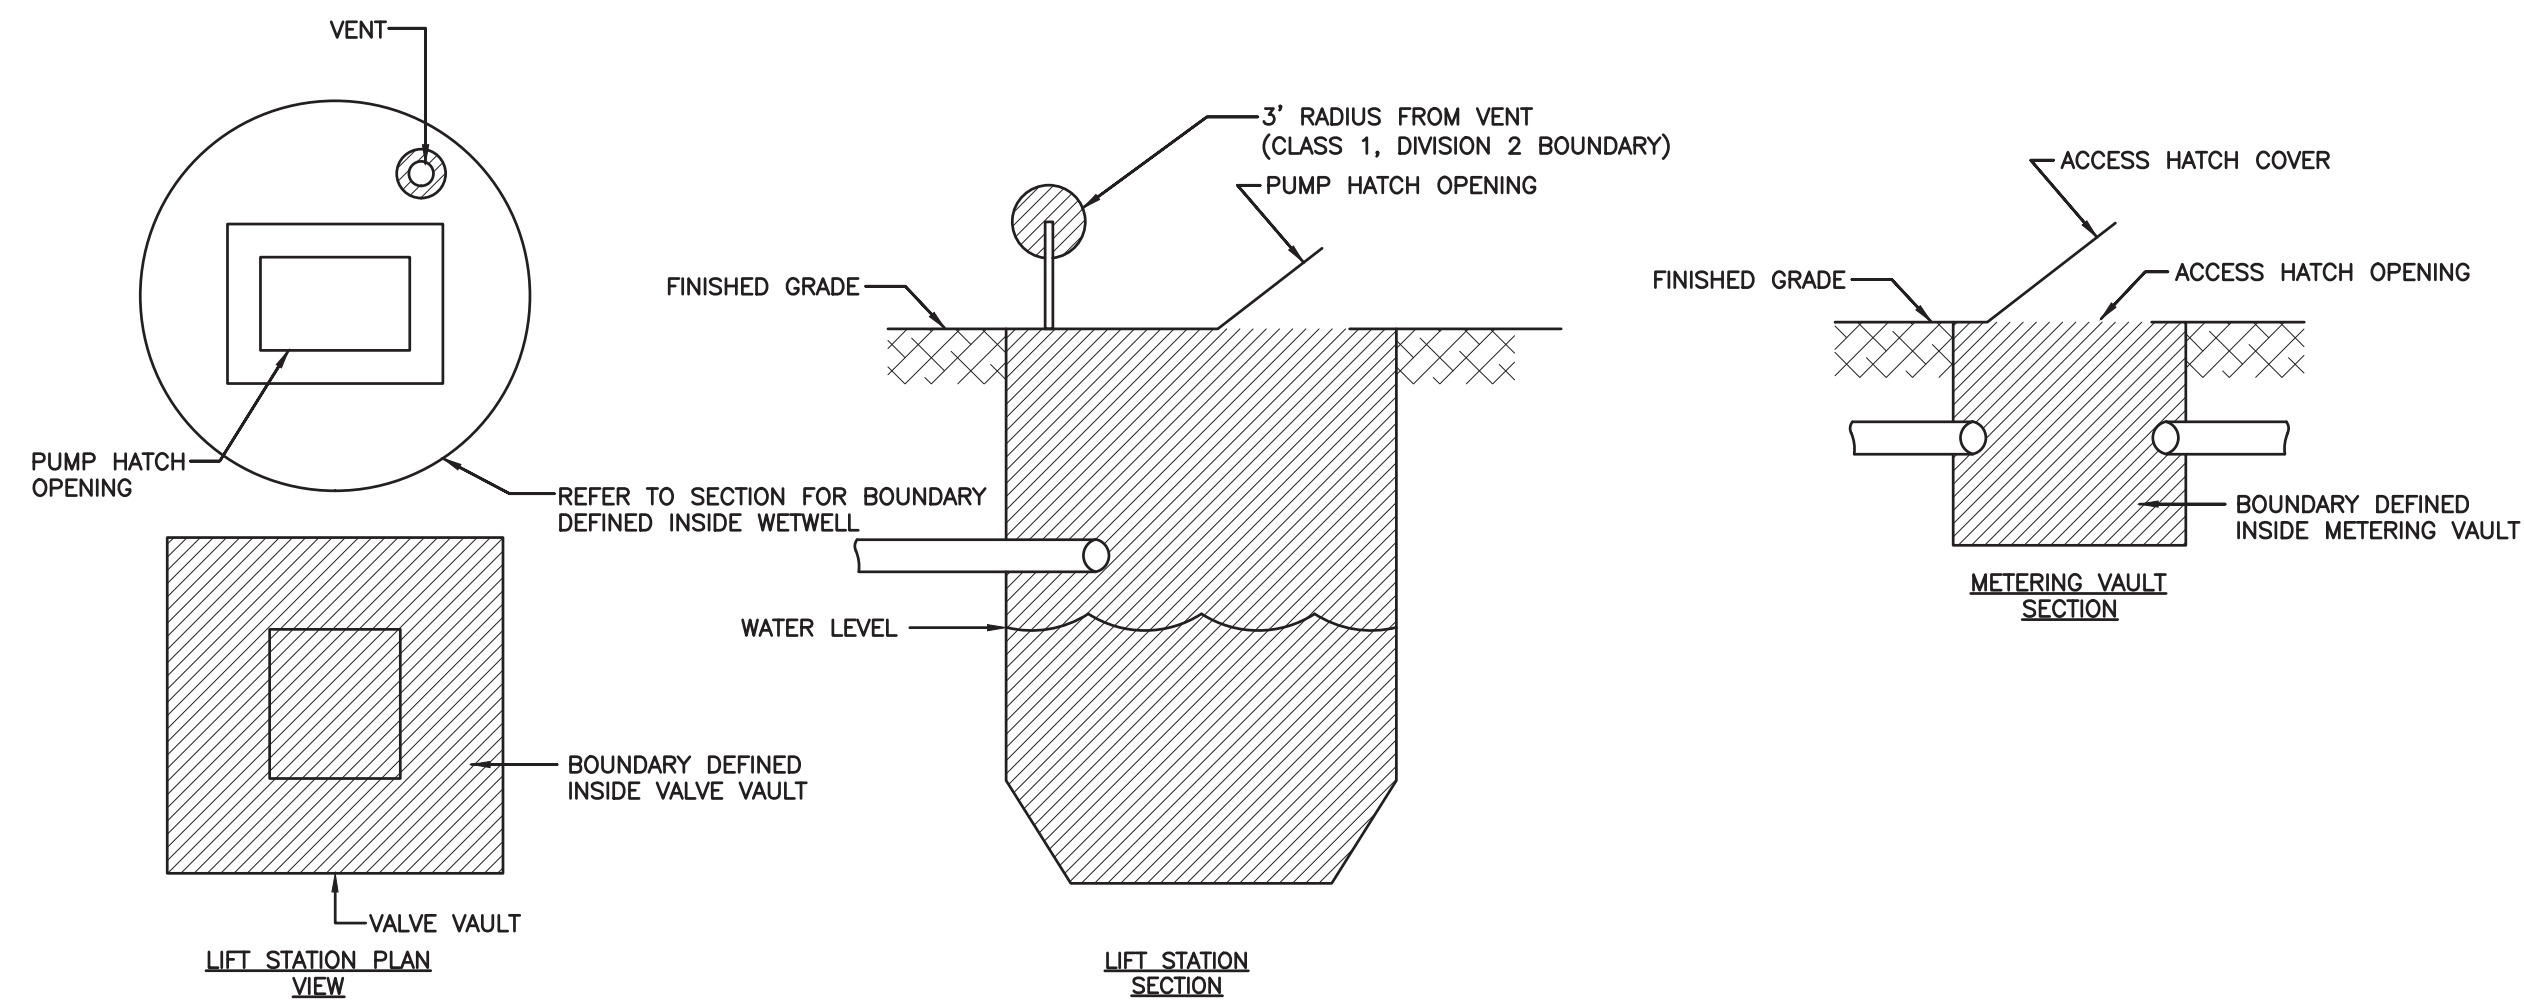

NOTES:  
① WET WELL HAZARDOUS AREA CLASSIFICATION ASSIGNED PER 2018 NFPA 820, TABLE 4.2.2, ROW 11-a.  
② DRY WELL HAZARDOUS AREA CLASSIFICATION ASSIGNED PER 2018 NFPA 820, TABLE 4.2.2, ROW 12-a.  
③ VALVE VAULT HAZARDOUS AREA CLASSIFICATION ASSIGNED PER 2018 NFPA 820, TABLE 4.2.2, ROW 31-a.  
④ METERING VAULT HAZARDOUS AREA CLASSIFICATION ASSIGNED PER 2018 NFPA 820, TABLE 4.2.2, ROW 36-a.

CLASS 1 DIVISION 1  
CLASS 1 DIVISION 2  
UNCLASSIFIED

**4**  
31 HAZARDOUS AREA CLASSIFICATION  
SCALE: N.T.S.

ERIC HAMMOND, P.E.  
FL. LICENSE # PE59048

DATE: 04/09/2021  
DESIGNED BY: H.A. AS NOTED  
CHECKED BY: E.H.  
FIELD BOOK:

CITY OF FORT LAUDERDALE  
PUBLIC WORKS DEPARTMENT  
ENGINEERING & ARCHITECTURE  
100 North Andrews Avenue, Fort Lauderdale, Florida 33301

NO.	DATE	BY	CHKD	DESCRIPTION

PROJECT # 12412  
PUMP STATION A-16 UPGRADE  
WASTEWATER DESIGN CRITERIA PACKAGE  
ELECTRICAL DETAILS - 2

DESIGN CRITERIA PACKAGE

SHEET NO. 31 OF 31  
CAD FILE: 12412-31-DET  
DRAWING FILE NO. 4-142-31



HAMMOND & ASSOCIATES, INC.  
CONSULTING ENGINEERS  
499 NW 70TH AVE., SUITE 201  
PLANTATION, FLORIDA 33317  
TEL: (954) 327-7111 FAX (954) 327-7154  
ERIC J. HAMMOND P.E.  
MECHANICAL / ELECTRICAL ENGINEER  
P.E. #59048  
EB 5315