

City of Fort Lauderdale Planning & Zoning Department

PLANNING & ZONING BOARD (PZB)

Site Plan Application

Cover: Page 1: Deadline, Notes, and Fees

Applicant Information Sheet

Page 2: Page 3:

Required Documentation / Submittal Checklist Sign Notification Requirements & Affidavit

Addendum: PZB Rezone with Flex Allocation <<if applicable>> Addendum: Parking Reduction Information <<if applicable>>

DEADLINE: Submittals must be received by 12:00 PM (noon) each day. Applications will not be accepted after noon. You will be asked to come back the following day. Pursuant to Section 47-24.1(1), the Planning and Zoning Department has five (5) business days to review all applications for a development permit to determine completeness. You will be notified by email within five (5) business days if your plans do not meet the submittal requirements.

NOTE: If your development site is separated by any public right-of-way (alley, alley reservation, or ROW easement) you must complete a separate application for each parcel.

NOTE: Only City of Fort Lauderdale audio and video equipment shall be used during any public meeting.

FEES: All applications for a development permit shall have an application fee as established by the City Commission as set forth by resolution, as amended from time to time. In addition to the application fee, any additional costs incurred by the City including review by a consultant on behalf of the City or special advertising costs shall be paid by the applicant. Any additional costs, which are unknown at the time of application but are later incurred by the City, shall be paid by the applicant prior to the issuance of a development permit.

Planned Unit Development (PUD)	\$ 7,580.00
Site Plan Level IV	\$ 2,730.00 + \$ 60 Flox brzoning fro
Site Plan Level III	\$ 2,110.00
Change of Use Requiring PZB review	\$ 550.00
Parking Reduction In addition to above site plan fee	\$ 750.00
Site Plan Deferral	\$ 510.00
Appeal of DRC Review	\$ 950.00

CITY OF FORT LAUDERDALE **PLANNING & ZONING**

DEPARTMENT 700 NW 19th Avenue Fort Lauderdale, FL 33311 Telephone: (954) 828-8980 Fax (954) 828-5858 Website: www.fortlauderdale.gov

Zoning Board Hoserings: 17th April
6:30 pm deadling the march

deadline stapping

Page 1: - Applicant Information Sheet

<u>INSTRUCTIONS</u>: Please print or type all information. The application must be filled out accurately and completely. Answer all questions. Do not leave an item blank. If an item does not apply, write N/A (Not Applicable). The following information requested is per Unified Land Development Regulations (ULDR). Incomplete applications will not be accepted.

Case Number	72R12	16	
Date of complete submittal	38113		
NOTE: For purpose of identification, the PRO Property Owner's Name	Second Avenue Properties		
Property Owner's Signature	Cecond / Wende / Toperties		
Address, City, State, Zip	3377 SW Second Avenue, Fort Lauderd	dale FI 33315	
E-mail Address	steveb@bowboat.com	date, 1 E 30010	
Phone Number	954-463-4307 ext:302		
Proof of Ownership	[] Warranty Deed or [x] Tax Record		
Proof of Ownership	[] Warranty Deed or [x] Tax Record		
NOTE: If AGENT is to represent OWNER, n			
Applicant / Agent's Name	Steve Baum		
Applicant / Agent's Signature	2277 CM Coord Avenue Forthonder	dala El 22245	
Address, City, State, Zip	3377 SW Second Avenue, Fort Lauder	dale, FL 33315	
E-mail Address	steveb@bowboat.com		
Phone Number	954-463-4307 ext:302		
Letter of Consent Submitted			
Development / Project Name	Boat Owners Warehouse		
Development / Project Address	Existing: 311 SW 24 th Street Fort Laud	lerdale, FL 33315 New:	
Legal Description	Lauderdale 2-9D	Lot 25 less S25 for ST Blk 126	
	Lot 1S65, 2S65 less W5 Blk 126 Lot 21 E1/2, lots 22,23,24 all less RD F		
Tax ID Folio Numbers (For all parcels in development)	504215-01-7260 , 504215-01-7232 , 504215-01-7160		
Request / Description of Project	Expand existing Boat Owners Warehouse store from approximately 7180 square feet to 9,900 square feet by building an addition of approximately 2,720 square feet.		
Applicable ULDR Sections	Expand parking to accommodate proposed addition. 47-23.B2b , 47-25.3A3d.IV , 47-25.3A3.d.II , 47-2015.1 , 47-20.5.C.2 , 47-20.5.C.6		
Total Estimated Cost of Project	\$ 408,000 (Including land cos	sts)	
	B-1 / X-P		
Future Land Use Designation			
Proposed Land Use Designation	B-1 / X-P		
Current Zoning Designation	B-1 / RM-15		
Proposed Zoning Designation	B-1 / X-P		
Current Use of Property	Retail sales / Vacant lot		
Residential SF (and Type)	Vacant lot		
Number of Residential Units	zero		
Non-Residential SF (and Type)	7180 pre construction		
Total Bldg. SF (include structured parking)	9900 SF after construction		
Site Adjacent to Waterway	[] Yes [x] No		
Dimensional Requirements	Required	Proposed	
Lot Size (SF / Acreage)	33,066 SF	33,066 SF	
Lot Density	N/A	N/A	
Lot Width	119.5ft / 65ft	119.5ft / 65ft	
Building Height (Feet / Levels)			
Structure Length			
Floor Area Ratio			
Lot Coverage			
Open Space	gr.		
Landscape Area			
Parking Spaces			
The second secon			
NOTE: State north, south, east or west for			
Setbacks/Yards*	Required 20ft	Proposed 20ft	
Front []			
Side [West]	Oft	Existing 1ft	
Side [East]		53ft	

13-0839 Page 2 of 14 Board of Adjustment Application 2011-09-12

Existing 16ft EXHIBIT 2

Rear [

Page 2: Required Documentation / Submittal Checklist

One	(1) copy of	the following do	cuments:	
V	Original Pre-PZE	3 signed-off set of plans and	all supplemental docu	mentation (ie. narratives, photos, etc.)
V	Completed applie	cation (all pages must be fill	ed out where applicabl	e)
Two	(2) original	sets, signed and	d sealed, of Pr	e-PZB plans at 24" x 36"
Thir	teen (13) co	py sets, of Pre-P	ZB half-size s	caled plans at 12" x 18"
	trash disposal	cribing project specifics, to in system, security/gating system author indicated.	nclude but not be limite tem, hours of operation	d to: architectural style and important design elements, , dock facilities, etc. Narratives must be on letterhead,
	Narrative quo		of the ULDR, with point	by-point responses of how project complies with such
	Land Use and	I Zoning maps indicating all and Zoning Office, 700 NW 1	I properties within 700	ft. of the subject property. These should be obtained from 66. Site should be highlighted or marked clearly to easily
		on plan set to state project n	ame and table of conte	ents.
	Current surve with Right-of-V	ey(s) of property, signed and Vay and Easement Vacation	d sealed, showing exist as Excluded. The surv	ing conditions; survey must be As-Built and Topographic ey should consist of the proposed project site alone. <u>Do not</u> e proposed project unless specifically requested by the
	Most current	recorded plat including amousting amousting section 5 S. Andrews Ave. Note: fo	endments, with site hig r Change of Use appl	hlighted. This may be obtained from Broward County Public ications, this is not required.
	Aerial photo i	indicating all properties with	in 700 ft. of the subject	property. Must be clear and current with site highlighted.
	affect these pl	ans. Otherwise, these items	Use applications , items should be obtained fr	is asterisked (*) are only required if proposed changes om Property Records if showing current conditions.
		Site Plan		Additional Renderings*
	√B.			Landscape Plans*
	7.	Floor Plans		Photometric Diagram*
	V D.	Building Elevations*	∨ н.	Engineering Plans*
Note:	All copy sets mu	st be clear and legible. If or	riginal set is in color, co	py sets must also be in color.
Note:	Plans must be b	ound, stapled and folded to	8 ½" x 11". All non-pla	an documents should be 8 ½" x 11" and stapled or bound.
Note:	Civil Engineering	g plans are only required at	Final-DRC sign-off. Co	entact DRC Engineering Representative for details.
Note:		project narratives, site plan ence Book" available at the		rings required with your application, please refer to the partment office.
I ackn		idavit Required Documentation a s of the application are me	and For	aff Intake Review Planning & Zoning Department staff use only:
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	varine			7
Signa	ture	Lew Ban	_ Teo	ch. Specs viewed By
	1	1		2000 100 100 100 100 100 100 100 100 100

Case No.

Page 2: Sign Notification Requirements and Affidavit

SIGN NOTICE

Applicant must POST SIGNS (for Planning and Zoning Board and City Commission Hearings) according to Sec. 47-27.4.

- Sign Notice shall be given by the applicant by posting a sign provided by the City stating the time, date and place of the Public Hearing on such matter on the property which is the subject of an application for a development permit. If more than one (1) public hearing is held on a matter, the date, time and place shall be stated on the sign or changed as applicable.
- The sign shall be posted at least fifteen (15) days prior to the date of the public hearing.
- The sign shall be visible from adjacent rights-of-way, including waterways, but excepting alleys.
- If the subject property is on more than one (1) right-of-way, as described above, a sign shall be posted facing each right-of-way.
- If the applicant is not the owner of the property that is subject of the application, the applicant shall post the sign on or as near to the subject property as possible subject to the permission of the owner of the property where the sign is located or, in a location in the right-of-way if approved by the City.
- Development applications for more than one (1) contiguous development site shall be required to have sign notice by posting one (1) sign in each geographic direction, (north, south, east and west) on the public right-of-way at the perimeter of the area under consideration.
- If the sign is destroyed or removed from the property, the applicant is responsible for obtaining another sign from the City and posting the sign on the property.
- The sign shall remain on the property until final disposition of the application. This shall include any deferral, rehearing, appeal, request for review or hearings by another body. The sign information shall be changed as above to reflect any new dates.
- The applicant shall, five (5) days prior to the public hearing, execute and submit to the department an affidavit of proof of posting of the public notice sign according to this section. If the applicant fails to submit the affidavit the public hearing will be postponed until the next hearing after the affidavit has been supplied.

AFFIDAVIT OF POSTING SIGNS

BROWARD COUNTY
RE:CITY COMMISSION CASE NO. 7 Z-R 12
APPLICANT: Second Avenue Properties Inc.
PROPERTY: 2307 S.W. 300 Avenue Fort. Land FC 33315
PUBLIC HEARING DATE: $7/2/13$
BEFORE ME, the undersigned authority, personally appeared, who upon being duly sworn and cautioned, under oath deposes and says:
1. Affiant is the Applicant in the above cited City of Fort Lauderdale Board or Commission Case.
The Affiant/Applicant has posted or has caused to be posted on the Property the signage provided by the City of Fort Lauderdale, which such signage notifies the public of the time, date and place of the Public Hearing on the application for relie before the Board or Commission.
3. That the sign(s) referenced in Paragraph two (2) above was posted on the Property in such manner as to be visible from adjacent streets and waterways and was posted at least fifteen (15) days prior to the date of the Public Hearing cited above and has remained continuously posted until the date of execution and filing of this Affidavit. Said sign(s) shall be visible from and within twenty (20) feet of streets and waterways, and shall be securely fastened to a stake, fence, or building.
4. Affiant acknowledges that the sign must remain posted on the property until the final disposition of the case before the Board or Commission. Should the application be continued, deferred or re-heard, the sign shall be amended to reflect the new dates.
 Affiant acknowledges that this Affidavit must be executed and filed with the City's Urban Design & Planning five (5) calendar days prior to the date of Public Hearing and if the Affidavit is not submitted, the Public Hearing on this case shall be cancelled.
6. Affiant is familiar with the nature of an oath or affirmation and is familiar with the laws of perjury in the State of Florida and the penalties therefore.
Affiant
SWORN TO AND SUBSCRIBED before me in the County and State above aforesaid this
PAULETTE HARTIGAN MY COMMISSION # EE 865203 EXPIRES: March 3, 2017 Bonded Thru Notary Public Underwriters NOTARY PUBLIC MY COMMISSION EXPIRES:
NOTE: I understand that if my sign is not returned within the prescribed time limit as noted in Sec. 47.27.3.i of the City of Fort

Initials of applicant (or representative) receiving sign as per 47-27.2(3)(A-J)

BKON

DATE OF FLIGI

2011

HTAON


Feet 300 200 100 **0** 150 300 Feet


Map Scale: 1 inch = 300 feet

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racy of any copies.






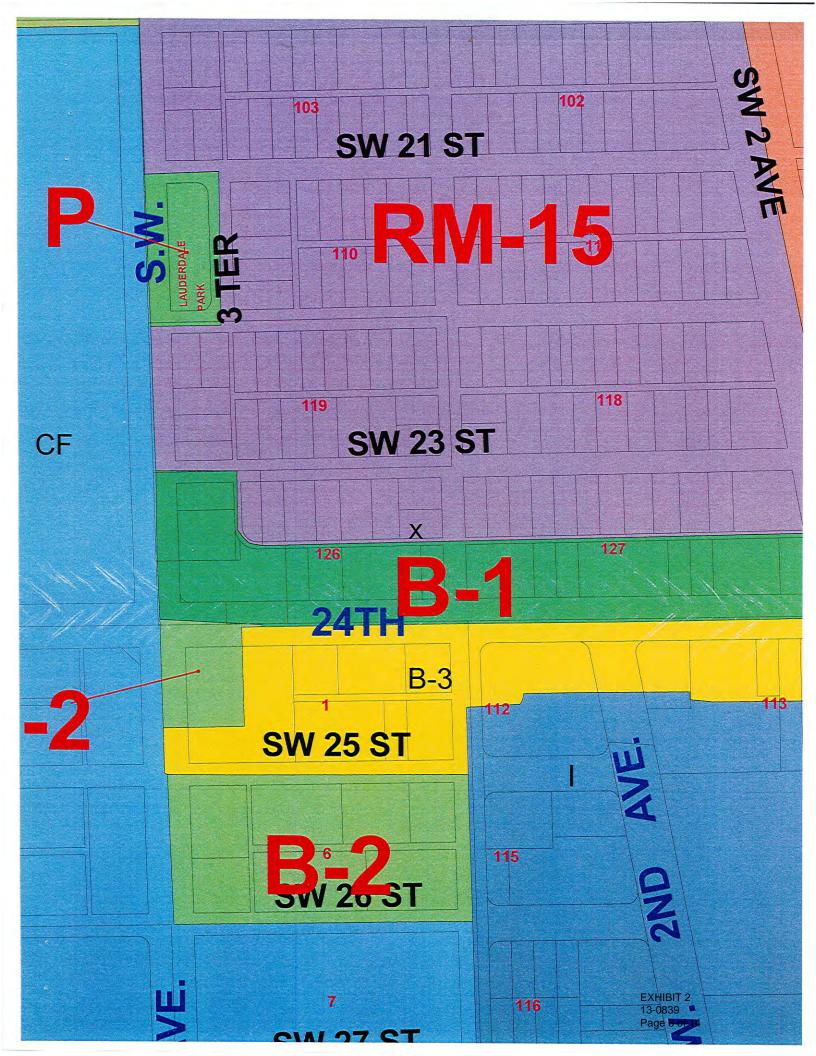

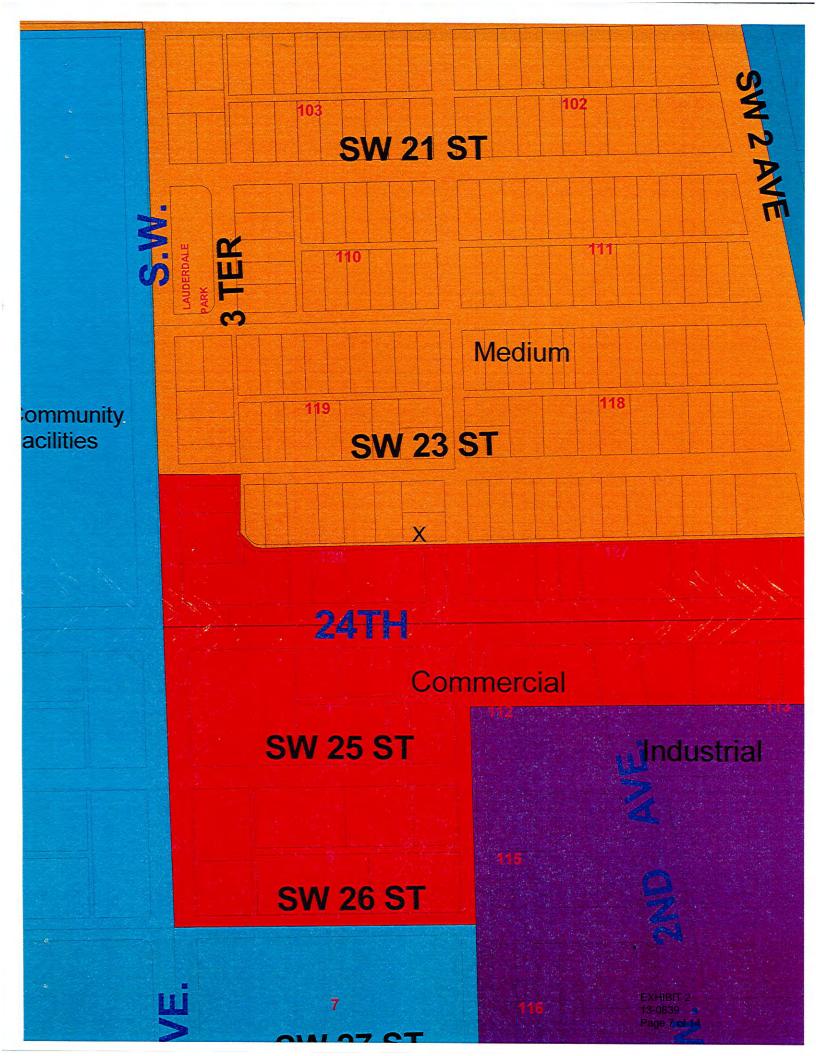
BOAT OWNERS WAREHOUSE


311 State Road 84


Fort Lauderdale, Florida

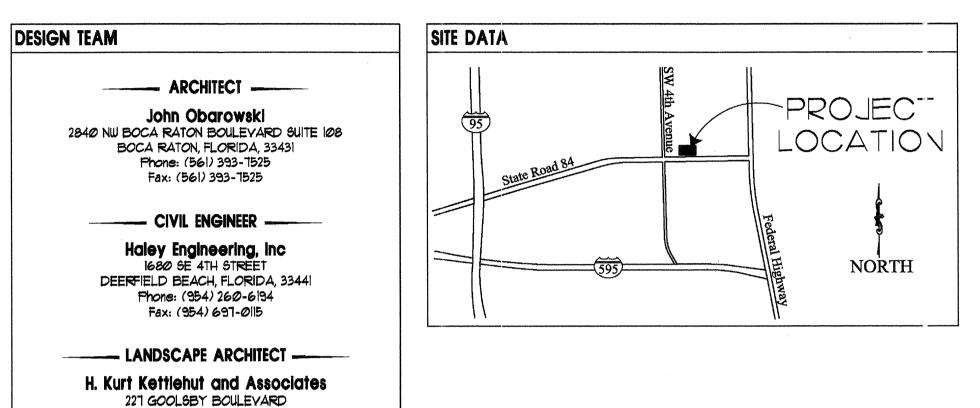

DEERFIELD BEACH, FLORIDA, 33442 Phone: (954) 426-4305

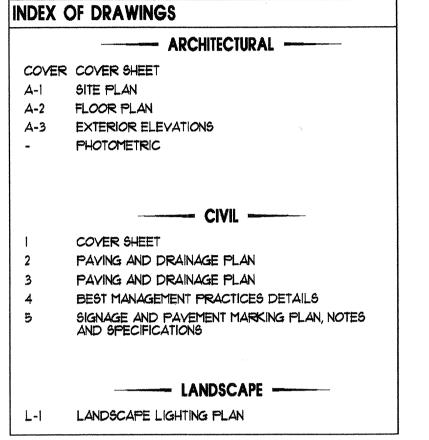

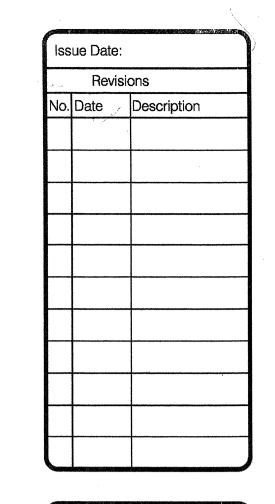

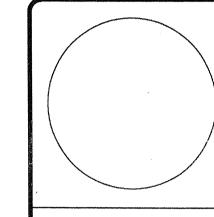

JOHN OBAROWSKI - ARCHITE 840 N.W. 2nd AVENUE SUITE BOCA RATON, FLORIDA 334

> Boat Owners' Warehouse 311 State Road 84 Fort Lauderdale, Florida

Date
June 29, 2012

Project Number:

Designed By:

Drawn By:

Checked By:

Sheet Title:

COVET

Cover

GENERAL NOTES

A. APPLICABLE CODES

- ALL CONSTRUCTION AND MATERIALS SHALL CONFORM TO THE STANDARDS AND SPECIFICATIONS OF THE CITY, COUNTY AND STATE.
- 2. CONSTRUCTION SAFETY ALL CONSTRUCTION SHALL BE DONE IN SAFE MANNER, SPECIFICALLY, THE RULES AND REGULATIONS OF THE OCCUPATIONAL SAFETY AND HEALTH ADMINISTRATION OSHA), AND THE MANUAL OF UNIFORM TRAFFIC CONTROL DEVICES (MUTCD) SHALL
- 3. THE CONTRACTOR SHALL BE REQUIRED TO COMPLY WITH CHAPTER 90-96 OF THE LAWS OF FLORIDA (THE TRENCH SAFETY ACT) AND OSHA STANDARD 29 C.F.R. SECTION 1926.650 SUBPART P. CONTRACTOR SHALL SUBMIT WITH HIS CONTRACT A COMPLETED, SIGNED, AND NOTARIZED COPY OF THE TRENCH SAFETY ACT COMPLIANCE STATEMENT. THE CONTRACTOR SHALL ALSO SUBMIT A SEPARATE COST ITEM IDENTIFYING THE COST OF COMPLIANCE WITH
- 4. NO CONSTRUCTION MAY COMMENCE UNTIL THE APPROPRIATE PERMITS HAVE BEEN OBTAINED FROM ALL LOCAL, STATE AND FEDERAL

B. PRE CONSTRUCTION RESPONSIBILITIES

- ARRANGE A PRE CONSTRUCTION CONFERENCE TO INCLUDE ALL INVOLVED GOVERNMENTAL AGENCIES, ALL AFFECTED UTILITY
- 2. THE CONTRACTOR SHALL OBTAIN AN SUNSHINE STATE ONE CALL OF FLORIDA CERTIFICATION NUMBER AT LEAST 48 HOURS PRIOR TO
- 3. PRIOR TO BEGINNING CONSTRUCTION, THE CONTRACTOR SHALL VERIFY THE SIZE, LOCATION AND MATERIAL OF ALL EXISTING
- 4. THE CONTRACTOR SHALL BE RESPONSIBLE FOR DAMAGE TO ANY EXISTING UTILITIES FOR WHICH HE FAILS TO REQUEST LOCATIONS FROM THE UTILITY OWNER. HE IS RESPONSIBLE AS WELL FOR DAMAGE TO ANY EXISTING UTILITIES WHICH ARE PROPERLY
- 5. IF UPON EXCAVATION, AN EXISTING UTILITY IS FOUND TO BE IN CONFLICT WITH THE PROPOSED CONSTRUCTION OR TO BE OF A SIZE CONTRACTOR SHALL IMMEDIATELY NOTIFY THE ENGINEER.

1. THE OWNER, ENGINEER, AND LOCAL PERMITTING AGENCIES MAY MAKE INSPECTIONS OF THE WORK AT ANY TIME. THE CONTRACTOR SHALL COOPERATE FULLY WITH ALL INSPECTIONS.

- 1. THE CONTRACTOR SHALL SUBMIT (5) FIVE SETS OF SHOP DRAWINGS FOR APPROVAL TO THE ENGINEER OF RECORD PRIOR TO FABRICATION OR CONSTRUCTION FOR ALL MATERIALS USED ON THE PROJECT APPROVED SHOP DRAWINGS FROM THE ENGINEER SHALL THEN BE SUBMITTED BY THE CONTRACTOR TO THE COUNTY OR CITY FOR THEIR APPROVAL. NO CONSTRUCTION SHALL COMMENCE UNTIL THE APPROVED SHOP DRAWINGS HAVE BEEN OBTAINED BY THE CONTRACTOR FROM THE
- INDIVIDUAL SHOP DRAWINGS FOR ALL PRECAST STRUCTURES ARE REQUIRED. CATALOG LITERATURE WILL NOT BE ACCEPTED FOR PRECAST STRUCTURES.
- 1. TEMPORARY UTILITIES IT SHALL BE THE CONTRACTOR'S RESPONSIBILITY TO ARRANGE FOR OR SUPPLY TEMPORARY WATER SERVICE, SANITARY FACILITIES AND ELECTRICITY TO HIS EMPLOYEES AND SUBCONTRACTORS FOR THEIR USE DURING
- 2. TRAFFIC REGULATION MAINTENANCE OF TRAFFIC IN THE PUBLIC RIGHT-OF-WAY SHALL BE IN ACCORDANCE WITH THE MUTCD AND THE FDOT STANDARD SPECIFICATIONS.
- 3. ALL OPEN TRENCHES AND HOLES ADJACENT TO ROADWAYS OR WALKWAYS SHALL BE PROPERLY MARKED AND BARRICADED TO ASSURE THE SAFETY OF BOTH VEHICULAR AND PEDESTRIAN TRAFFIC. NO HOLES SHALL BE LEFT OPEN OVERNIGHT.

- I. DURING CONSTRUCTION THE PROJECT SITE AND ALL ADJACENT AREAS SHALL BE MAINTAINED IN A NEAT AND CLEAN MANNER. UPON FINAL CLEAN UP, THE PROJECT SITE SHALL BE LEFT CLEAR OF ALL SURPLUS MATERIAL OR TRASH. THE PAVED AREAS SHALL BE SWEPT
- 2. THE CONTRACTOR SHALL RESTORE OR REPLACE, WHEN AND AS DIRECTED BY THE ENGINEER ANY PUBLIC OR PRIVATE PROPERTY DAMAGED BY HIS WORK, EQUIPMENT, EMPLOYEES OR THOSE OF HIS SUBCONTRACTORS TO A CONDITION AT LEAST EQUAL TO THAT EXISTING IMMEDIATELY PRIOR TO THE BEGINNING OF OPERATIONS. TO THIS END, THE CONTRACTOR SHALL DO AS REQUIRED ALL NECESSARY HIGHWAY OR DRIVEWAY, WALK, AND LANDSCAPING WORK. SUITABLE MATERIALS AND METHODS SHALL BE USED FOR SUCH
- 3. WHERE MATERIAL OR DEBRIS HAS WASHED OR FLOWED INTO OR BEEN PLACED IN WATER COURSES, DITCHES, DRAINS, CATCH BASINS, OR ELSEWHERE AS A RESULT OF THE CONTRACTOR'S OPERATIONS, SUCH MATERIAL OR DEBRIS SHALL BE REMOVED AND SATISFACTORILY DISPOSED OF DURING PROGRESS OF THE WORK, AND THE AREA KEPT IN A CLEAN AND NEAT CONDITION.

G. PROJECT RECORD DOCUMENTS

- 1. THE CONTRACTOR SHALL MAINTAIN ACCURATE AND COMPLETE RECORDS WORK ITEMS COMPLETED. INFORMATION RELATIVE TO MANHOLES, VALVES, SERVICES, FITTINGS, LENGTH OF PIPE, INVERT ELEVATIONS, FINISHED GRADE ELEVATIONS AND THE LIKE, SHALL BE ACCURATELY RECORDED BY THE CONTRACTOR. TOP ELEVATIONS
- 2. ALL "AS-BUILT" INFORMATION SUBMITTED TO THE ENGINEER SHALL BE SUFFICIENTLY ACCURATE, CLEAR AND LEGIBLE TO SATISFY THE ENGINEER AND ANY APPLICABLE REVIEWING AGENCY THAT THE INFORMATION PROVIDES A TRUE REPRESENTATION OF THE IMPROVEMENTS
- 3. UPON COMPLETION OF CONSTRUCTION, THE CONTRACTOR SHALL SUBMIT TO THE ENGINEER OF RECORD FIVE COMPLETE SETS OF "AS-BUILT" CONSTRUCTION DRAWINGS (PRINTS) AND ONE MYLAR ORIGINAL. THESE DRAWINGS SHALL BE MARKED TO SHOW "AS-BUILT" CONSTRUCTION CHANGES AND DIMENSIONED LOCATIONS AND ELEVATIONS OF ALL IMPROVEMENTS AND SHALL BE SIGNED BY THE CONTRACTOR.
- 4. ALL "AS-BUILT" INFORMATION ON ELEVATIONS OF PAVING, DRAINAGE, WATER, AND SEWER SHALL BE CERTIFIED BY A REGISTERED LAND
- 5. IT IS THE INTENT THAT THE FLORIDA DEPARTMENT OF TRANSPORTATION "STANDARD SPECIFICATIONS FOR ROAD AND BRIDGE CONSTRUCTION: DATED 1991 TOGETHER WITH "SUPPLEMENTAL SPECIFICATIONS TO THE 1991 STANDARD SPECIFICATIONS FOR ROAD AND BRIDGE CONSTRUCTION" DATED 1991 BE USED WHERE APPLICABLE FOR THE VARIOUS WORK, AND THAT WHERE SUCH WORDING THEREIN REFERS TO THE STATE OF FLORIDA AND ITS DEPARTMENT OF TRANSPORTATION AND PERSONNEL, SUCH WORDING IS INTENDED TO BE REPLACED WITH THE WORDING WHICH WOULD PROVIDE PROPER TERMINOLOGY; THEREBY MAKING SUCH "STANDARD SPECIFICATIONS FOR ROAD AND BRIDGE CONSTRUCTION" AS THE "STANDARD SPECIFICATIONS" FOR THIS PROJECT. IF WITHIN A PARTICULAR SECTION, ANOTHER SECTION, ARTICLE OR PARAGRAPH IS REFERRED TO, IT SHALL BE PART OF THE STANDARD SPECIFICATIONS ALSO. THE CONTRACTOR SHALL ABIDE BY ALL LOCAL AND STATE LAWS, REGULATIONS AND BUILDING CODES WHICH HAVE JURISDICTION IN THE AREA.

H. EARTHWORK AND COMPACTION

- 1. ALL FILL MATERIAL IN AREAS NOT TO BE PAVED SHALL BE COMPACTED TO 95% OF THE MAXIMUM DENSITY AS DETERMINED BY AASHTO T-180. 2. A 2" BLANKET OF TOP SOIL SHALL BE PLACED OVER ALL AREAS TO BE SODDED.
- 3. SOD SHALL BE ST. AUGUSTINE, BITTER BLUE OR FLORATAM AND SHALL BE PLACED ON THE GRADED TOP SOIL AND WATERED TO INSURE SATISFACTORY CONDITION UPON FINAL ACCEPTANCE OF THE PROJECT.

I. STORM DRAINAGE

a. CONTRACTOR MAY UTILIZE ONE OF THE FOLLOWING MATERIALS.

- A. PIPE SHALL BE ALUMINUM, MANUFACTURED IN CONFORMANCE WITH ASTM B209.
- B. PIPE SHALL BE SPIRAL RIB DRAINAGE PIPE WITH 3/4" BY 3/4" RIBS, APPROXIMATELY 7-1/2" ON CENTER. GAUGE THICKNESS SHALL MEET FDOT STANDARD 945-1.
- C. PIPE COUPLING BANDS SHALL BE 12" WIDE STANDARD SPLIT BANDS OF THE SAME ALLOY AS THE PIPE AND MAY BE ONE GAUGE LIGHTER THAN THE PIPE. D. POLYURETHANE OR OTHER SEALANT SHALL BE USED WITH COUPLING BANDS ON ALL NON-PERFORATED PIPE.
- 2. REINFORCED CONCRETE PIPE (RCP):

ROCK LARGER THAN I" DIAMETER.

- CONCRETE PIPE FOR STORM SEWERS SHALL CONFORM TO ASTM L70-79, TABLE !!!, WALL B, OR LATEST REVISION. ALL PIPE SHALL HAVE MODIFIED TONGUE AND GROOVE JOINTS, AND HAVE RUBBER GASKETS, UNLESS OTHERWISE SPECIFIED.
- A. BEDDING AND INITIAL BACKFILL OVER DRAINAGE PIPES SHALL BE SAND WITH NO
- B. BACKFILL MATERIAL UNDER PAVED AREAS SHALL BE COMPACTED TO 98% OF THE MAXIMUM DENSITY AS DETERMINED BY ASSHTO T-180.
- C. BACKFILL MATERIAL UNDER AREAS NOT TO BE PAVED SHALL BE COMPACTED TO 95% OF THE MAXIMUM DENSITY AS DETERMINED BY AASHTO T-180.
- D. CATCH BASINS SHALL BE PRECAST MINIMUM 3000 PSI CONCRETE AND GRADE 40
- A. PIPE SHALL BE PLACED ON STABLE GRANULAR MATERIAL FREE OF ROCK FORMATION OTHER FOREIGN FORMATIONS, AND CONSTRUCTED TO UNIFORM GRADE AND LINE.
- B. BACKFILL MATERIAL SHALL BE WELL GRADED GRANULAR MATERIAL WELL TAMPED IN LAYERS NOT TO EXCEED SIX INCHES (6").
- C. PROVIDE A MINIMUM PROTECTIVE COVER OF 18 INCHES OVER STORM SEWER AND AVOID UNNECESSARY CROSSING BY HEAVY CONSTRUCTION VEHICLES DURING CONSTRUCTION.
- D. THE CONTRACTOR SHALL NOTIFY THE LOCAL WATER CONTROL DISTRICT AT LEAST 24 HOURS PRIOR TO THE START OF THE CONSTRUCTION AND INSPECTION.
- 5. HDPE DRAINAGE PIPE SHALL CONFORM TO AASHTO M294, STANDARD SPECIFICATION FOR CORRUGATED POLYETHYLENE PIPE, 12" TO 36" DIAMETER, SMOOTH LINED INSIDE WALLS.
- STORM DRAINAGE PRE-TREATMENT/EXFILTRATION SYSTEM
- a. ANY CONFLICT WITH EXISTING OR PROPOSED UTILITIES SHALL IMMEDIATELY BE BROUGHT TO THE ATTENTION OF THE ENGINEER. ANY IMPERMEABLE MATERIAL ENCOUNTERED IN THE EXCAVATION FOR THE DRAIN FIELD SHALL BE REMOVED AS DIRECTED BY THE ENGINEER.
- b. THE TRENCH LINER SHALL BE TYPAR SPUN BONDED POLYPROPYLENE FILTER FABRIC AS MANUFACTURED BY THE DUPONT COMPANY, OR APPROVED EQUAL. IT SHALL BE USED ON THE SIDES AND TOP OF DRAIN FIELD DITCH. THE TOP SECTION OF THE MATERIAL SHALL BE LAPPED A MINIMUM OF 24 INCHES AND THE CONTRACTOR SHALL TAKE EXTREME CARE
- c. PERFORATED PIPE WITHIN THE DRAIN FIELD SHALL HAVE 3/8 INCH PERFORATIONS 360° AROUND THE PIPE WITH APPROXIMATELY 120 PERFORATIONS PER FOOT OF PIPE.
- d. PERFORATED PIPE SHALL TERMINATE FIVE FEET (5') FROM THE DRAINAGE STRUCTURE. THE REMAINING FIVE FEET (5') SHALL BE NON-PERFORATED PIPE.
- e. PIPES SHALL TERMINATE TWO FEET (2') FROM THE END OF THE TRENCH OR CONNECT TO ADDITIONAL CATCH BASINS.

PAVING

- I. ALL UNDERGROUND UTILITIES SHALL BE COMPLETED PRIOR TO THE CONSTRUCTION OF LIMEROCK BASE AND PRIOR TO PLACEMENT OF THE PAVEMENT.
- 2. ALL EXISTING PAVEMENT CUT OR DAMAGED BY CONSTRUCTION SHALL BE PROPERLY RESTORED
- 3. WHERE PROPOSED PAVEMENT IS TO BE CONNECTED TO EXISTING PAVEMENT, THE EXISTING EDGE OF PAVEMENT SHALL BE SAW CUT. 4. ALL STREET CORNER PAVEMENT RADII SHALL BE 25 FEET UNLESS OTHERWISE NOTED
- 5. UPON COMPLETION OF DRAINAGE IMPROVEMENTS AND LIMEROCK BASE CONSTRUCTION (AND BEFORE PLACING ASPHALT PAVEMENT) THE CONTRACTOR SHALL FURNISH THE ENGINEER OF RECORD AND THE CITY OF FT. LAUDERDALE "AS-BUILT" PLANS FOR THESE IMPROVEMENTS, SHOWING THE LOCATIONS AND THE PERTINENT GRADES OF ALL DRAINAGE INSTALLATIONS AND THE FINISHED ROCK GRADES OF THE ROAD CROWN AND EDGE OF PAVEMENT AT 50 FEET INTERVALS. THESE "AS-BUILTS" SHALL BE APPROVED BY THE CITY PRIOR TO THE PLACEMENT OF ASPHALT.

b. MATERIALS:

- 1. BASE COURSE SHALL BE CRUSHED LIMEROCK MIAMI OOLITE WITH A MINIMUM OF 70% CARBONATES OF CALCIUM AND MAGNESIUM (60% FOR LOCAL STREETS AND PARKING AREAS) AND A MINIMUM LIMEROCK BEARING RATIO 100.
- 2. PRIME COAT AND TACK COAT SHALL MEET F.D.O.T. STANDARDS. 3. SURFACE COURSE SHALL BE EQUAL TO F.D.O.T. TYPE S-3 ASPHALT.
- 4. REINFORCED CONCRETE SLABS SHALL BE CONSTRUCTED OF CLASS I CONCRETE WITH A MINIMUM STRENGTH OF 3,000 PSI AND SHALL BE REINFORCED WITH A 6" X 6" NO. 6 GAUGE WIRE MESH.
- 1. LIMEROCK BASE MATERIAL SHALL BE 6 INCHES THICK AND SHALL BE COMPACTED TO 98% OF THE MAXIMUM DENSITY AS DETERMINED BY AASHTO T80-C.
- 2. LIMEROCK BASE MATERIAL SHALL BE PLACED IN MAXIMUM 6" LIFTS. BASES GREATER THAN 6" SHALL BE PLACED IN TWO OR MORE EQUAL LIFTS.
- 3. ASPHALTIC CONCRETE SHALL BE A MINIMUM OF I" THICK.
- 4. PRIME COAT SHALL BE PLACED ON ALL LIMEROCK BASES IN ACCORDANCE WITH F.D.O.T. STANDARDS. 5. TACK COAT SHALL BE PLACED AS REQUIRED IN ACCORDANCE WITH F.D.O.T. STANDARDS.
- d. TESTING: ALL SUBGRADE, LIMEROCK AND ASPHALT TESTS REQUIRED SHALL BE TAKEN AT THE DIRECTION OF THE ENGINEER AND/OR THE CITY OF FT. LAUDERDALE.
- 1. THE FINISHED SURFACE OF THE BASE COURSE AND THAT OF THE WEARING SURFACE SHALL NOT VARY MORE THAN 1/4" FROM THE TEMPLATE. ANY IRREGULARITIES EXCEEDING THIS LIMIT SHALL BE CORRECTED.
- 2. DENSITY TESTS SHALL BE TAKEN BY AN INDEPENDENT TESTING LABORATORY, CERTIFIED BY THE STATE OF FLORIDA, AND TAKEN AS DIRECTED BY THE ENGINEER AND THE CITY OF FT. LAUDERDALE.
- ALL TESTING COSTS (PAVING) SHALL BE PAID FOR BY THE OWNER EXCEPT THOSE TESTS FAILING TO MEET THE SPECIFIED REQUIREMENTS, WHICH ARE TO BE PAID BY THE

SIGNAGE AND PAVEMENT MARKINGS

- 1. THE ROADS AND PARKING AREAS SHALL BE STRIPED IN ACCORDANCE WITH THE PLANS, NO STRIPE SHALL BE LESS THAN THE SPECIFIED WIDTH NOR SHALL IT EXCEED THE SPECIFIED WIDTH BY MORE THAN 1/2 INCH. STRIPING SHALL BE IN ACCORDANCE WITH SECTIONS 710 971 OF THE STANDARD SPECIFICATIONS. ALL STRIPPING WITHIN THE PUBLIC RIGHT-OF-WAY AND AT DRIVEWAY ACCESS POINTS SHALL BE THERMOPLASTIC IN ACCORDANCE WITH THE STANDARD SPECIFICATIONS.
- 2. IT SHALL BE THE SOLE RESPONSIBILITY OF THE CONTRACTOR TO INSTALL AND MAINTAIN ADEQUATE TRAFFIC CONTROL DEVICES, WARNING DEVICES AND BARRIERS FOR THE PURPOSE OF PROTECTING THE TRAVELING PUBLIC, HIS WORKMEN AND THE WORK AREA IN GENERAL. SUCH TRAFFIC CONTROL SHALL BE MAINTAINED FOR THE DURATION OF THE PROJECT PERIOD, INCLUDING ANY TEMPORARY SUSPENSIONS OF THE WORK. MAINTENANCE OF TRAFFIC SHALL BE IN ACCORDANCE WITH SECTION 102 OF THE STANDARD SPECIFICATIONS AND THE STATE OF FLORIDA, MANUAL OF TRAFFIC CONTROL AND SAFE PRACTICES FOR STREET AND HIGHWAY CONSTRUCTION, MAINTENANCE AND UTILITY OPERATIONS.
- 3. ALL PAVEMENT MARKINGS ON-SITE SHALL BE THERMOPLASTIC UNLESS
- 4. ALL SIGNING AND MARKINGS SHALL CONFORM TO MUTCD AND COUNTY TRAFFIC ENGINEERING STANDARDS (LATEST EDITION).


FLORIDA BUILDING CODE 2001 - FLORIDA

ACCESSIBILITY CODE - CHAPTER I

- 11-4.29.2 DETECTABLE WARNINGS ON WALKING SURFAC 1. ALL DETECTABLE WARNING SURFACES REQUIRED BY THE CODE SHALL BE
- 2. DETECTABLE WARNING TEXTURES ON WALKING SURFACES SHALL CONSIST OF EXPOSED AGGREGATE CONCRETE, CUSHIONED SURFACES MADE OF RUBBER OR PLASTIC, RAISED STRIPS, OR GROOVES. TEXTURES SHALL CONTRAST WITH THAT OF THE SURROUNDING SURFACE. RAISED STRIOS OR GROOVES SHALL COMPLY WITH FIGURE 40(a) AND (b). GROOVES MAY BE USED INDOORS ONL

GOVERNED BY THE REQUIREMENTS OF AMERICAN NATIONAL STANDARDS

1. PARKED VEHICLE OVERHANGS SHALL NOT REDUCE THE CLEAR WIDTH OF AN ACCESSIBLE ROUTE, PARKING SPACES AND ACCESS AISLES SHALL BE LEVEL SURFACE SLOPES NOT EXCEEDING 1:50 (2%) IN ALL DIRECTIONS.

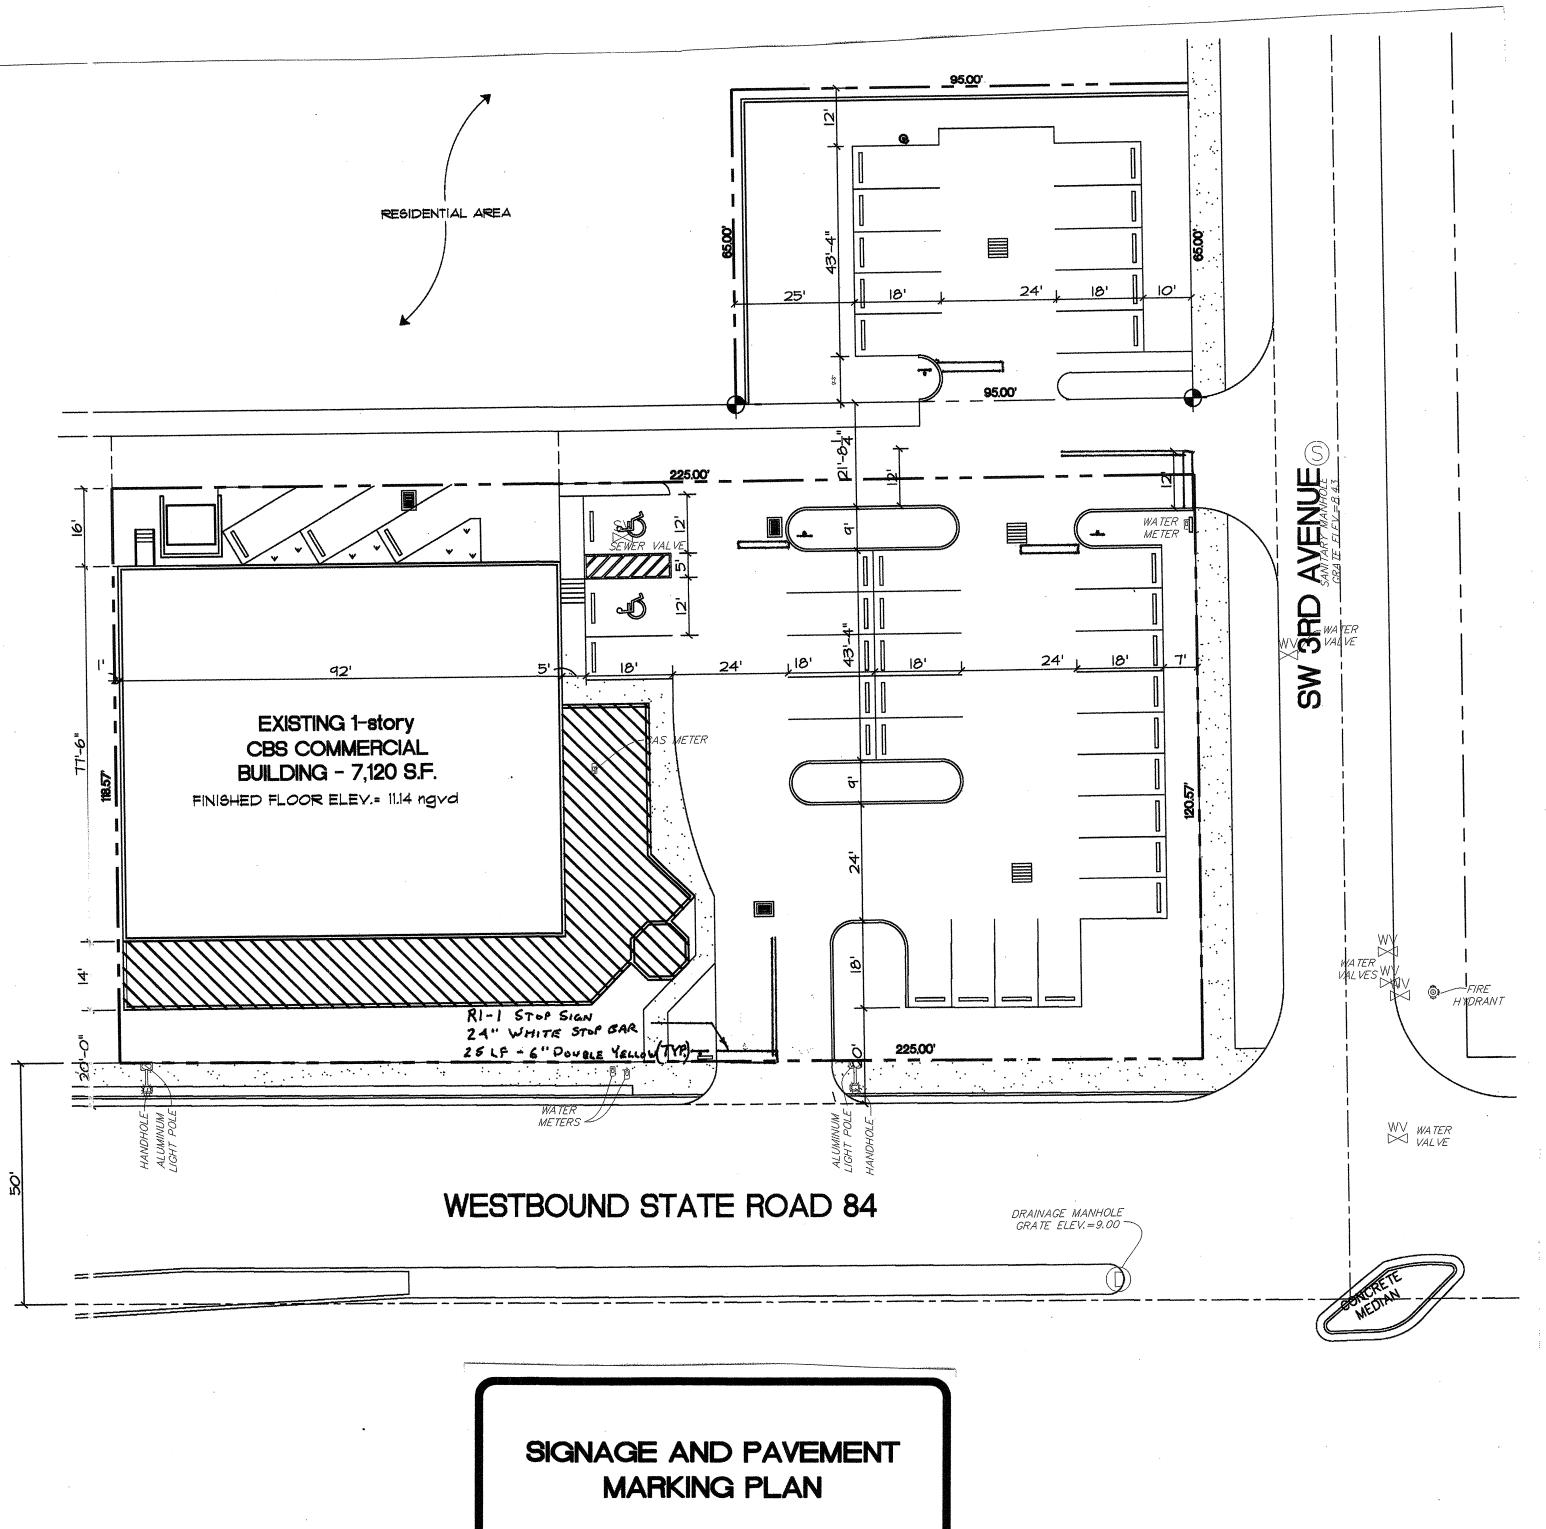

Checked J.J.H DATE REVISION

HALEY ENGINEERING, INC. CIVIL ENGINEERING SERVICES.

1680 SE 4th Street - Deerfield Beach, Fla. 33441 Phone (954) 260-6194 - Fax (954) 697-0115 F.B.P.E. Authorization No. 9463


BOAT OWNERS WAREHOUSE 311 STATE ROAD 84 FT. LAUDERDALE, FLORIDA

NOTES and SPECIFICATIONS

APPROVED DATE: 6/29/12 John M. Haley, P.E. REGISTERED ENGINEER NO. 40023 STATE OF FLORIDA

NUMBER

13-0839 Page 9 of 14

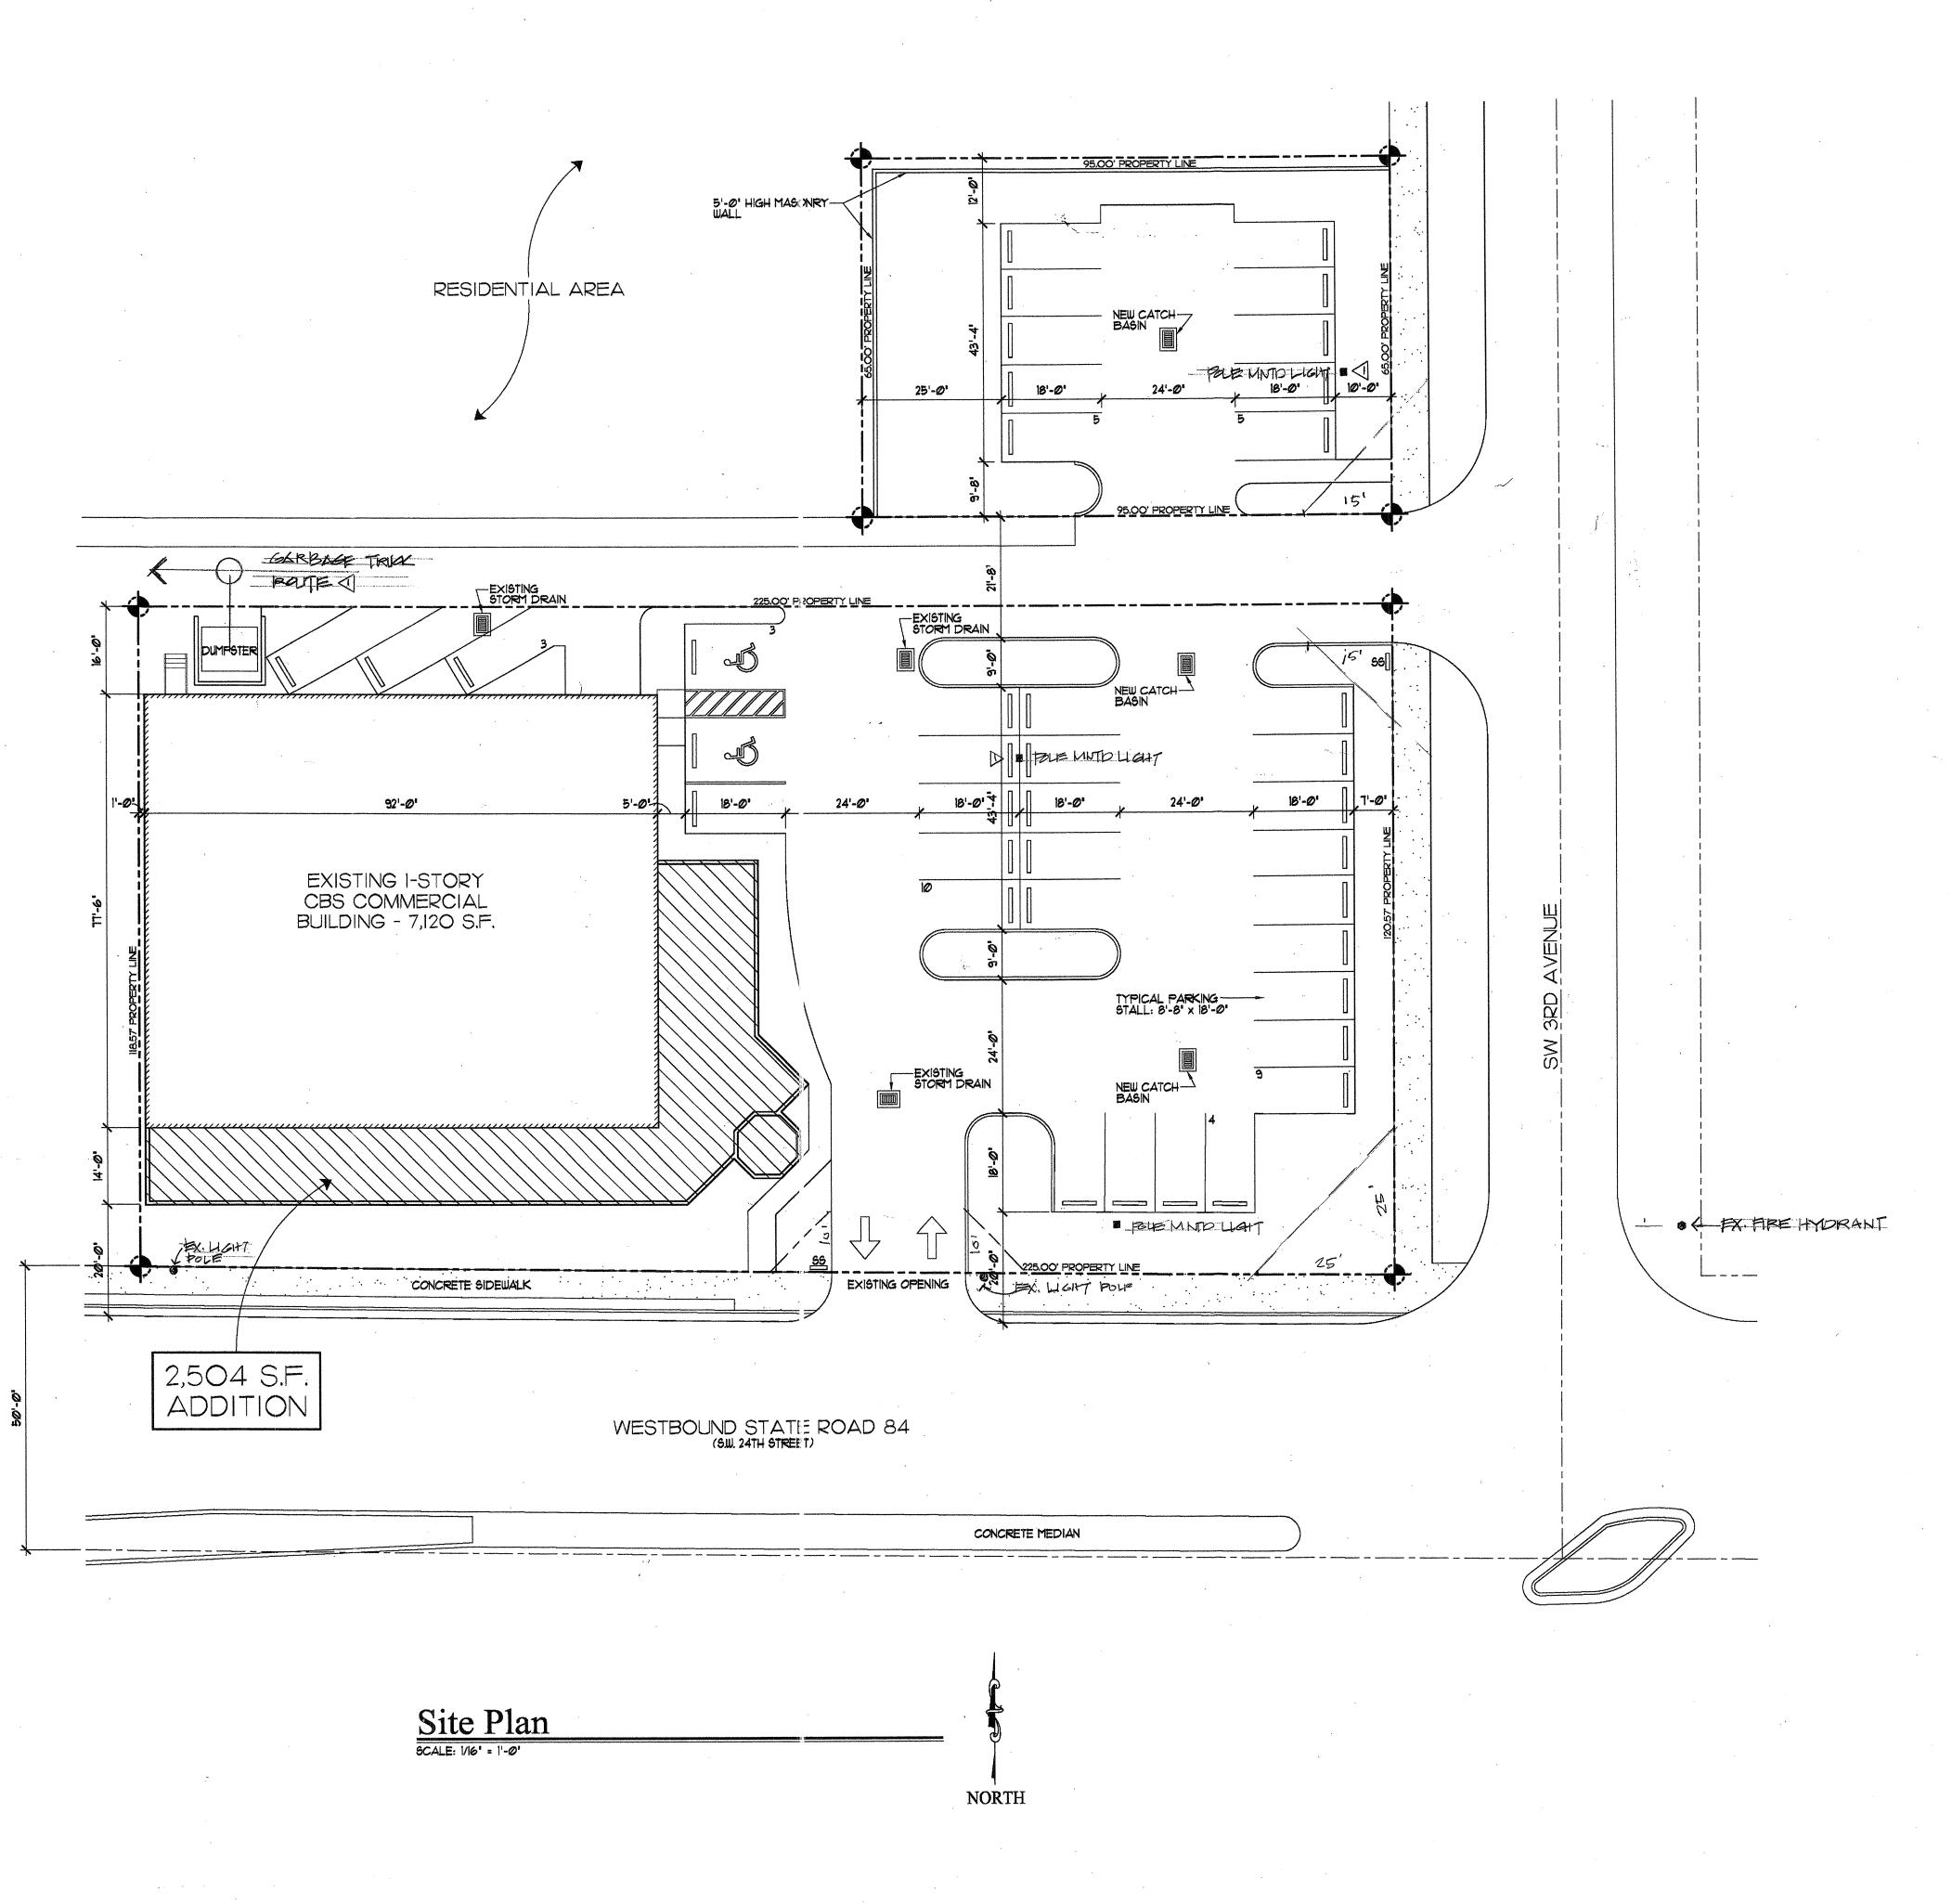

SITE DATA

SITE DATA

ZONING: B-I RETAIL PARKING: 39 TOTAL SPACES AREA: 1,120 SF. EXISTING + 2,510 SF. ADDITION 9,690 SF. TOTAL

TOTAL LOT AREA: 33,078 SF.
OPEN AREA: 23,526 SF. = 71,1%
GREEN AREA: 7,295 SF. = +/-22,1%
BUILDING COVERAGE: 9,552 SF. = 28,9%

PROJECT

NORTH

Issue Date:

Revisions

No. Date Description

| No. | Date | Description | Description





Boat Owners' Warehouse 311 State Road 84 Fort Lauderdale, Florida


Date
February 8, 20||
Project Number:

Designed By:

Drawn By:

Checked By:


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Issue Date:

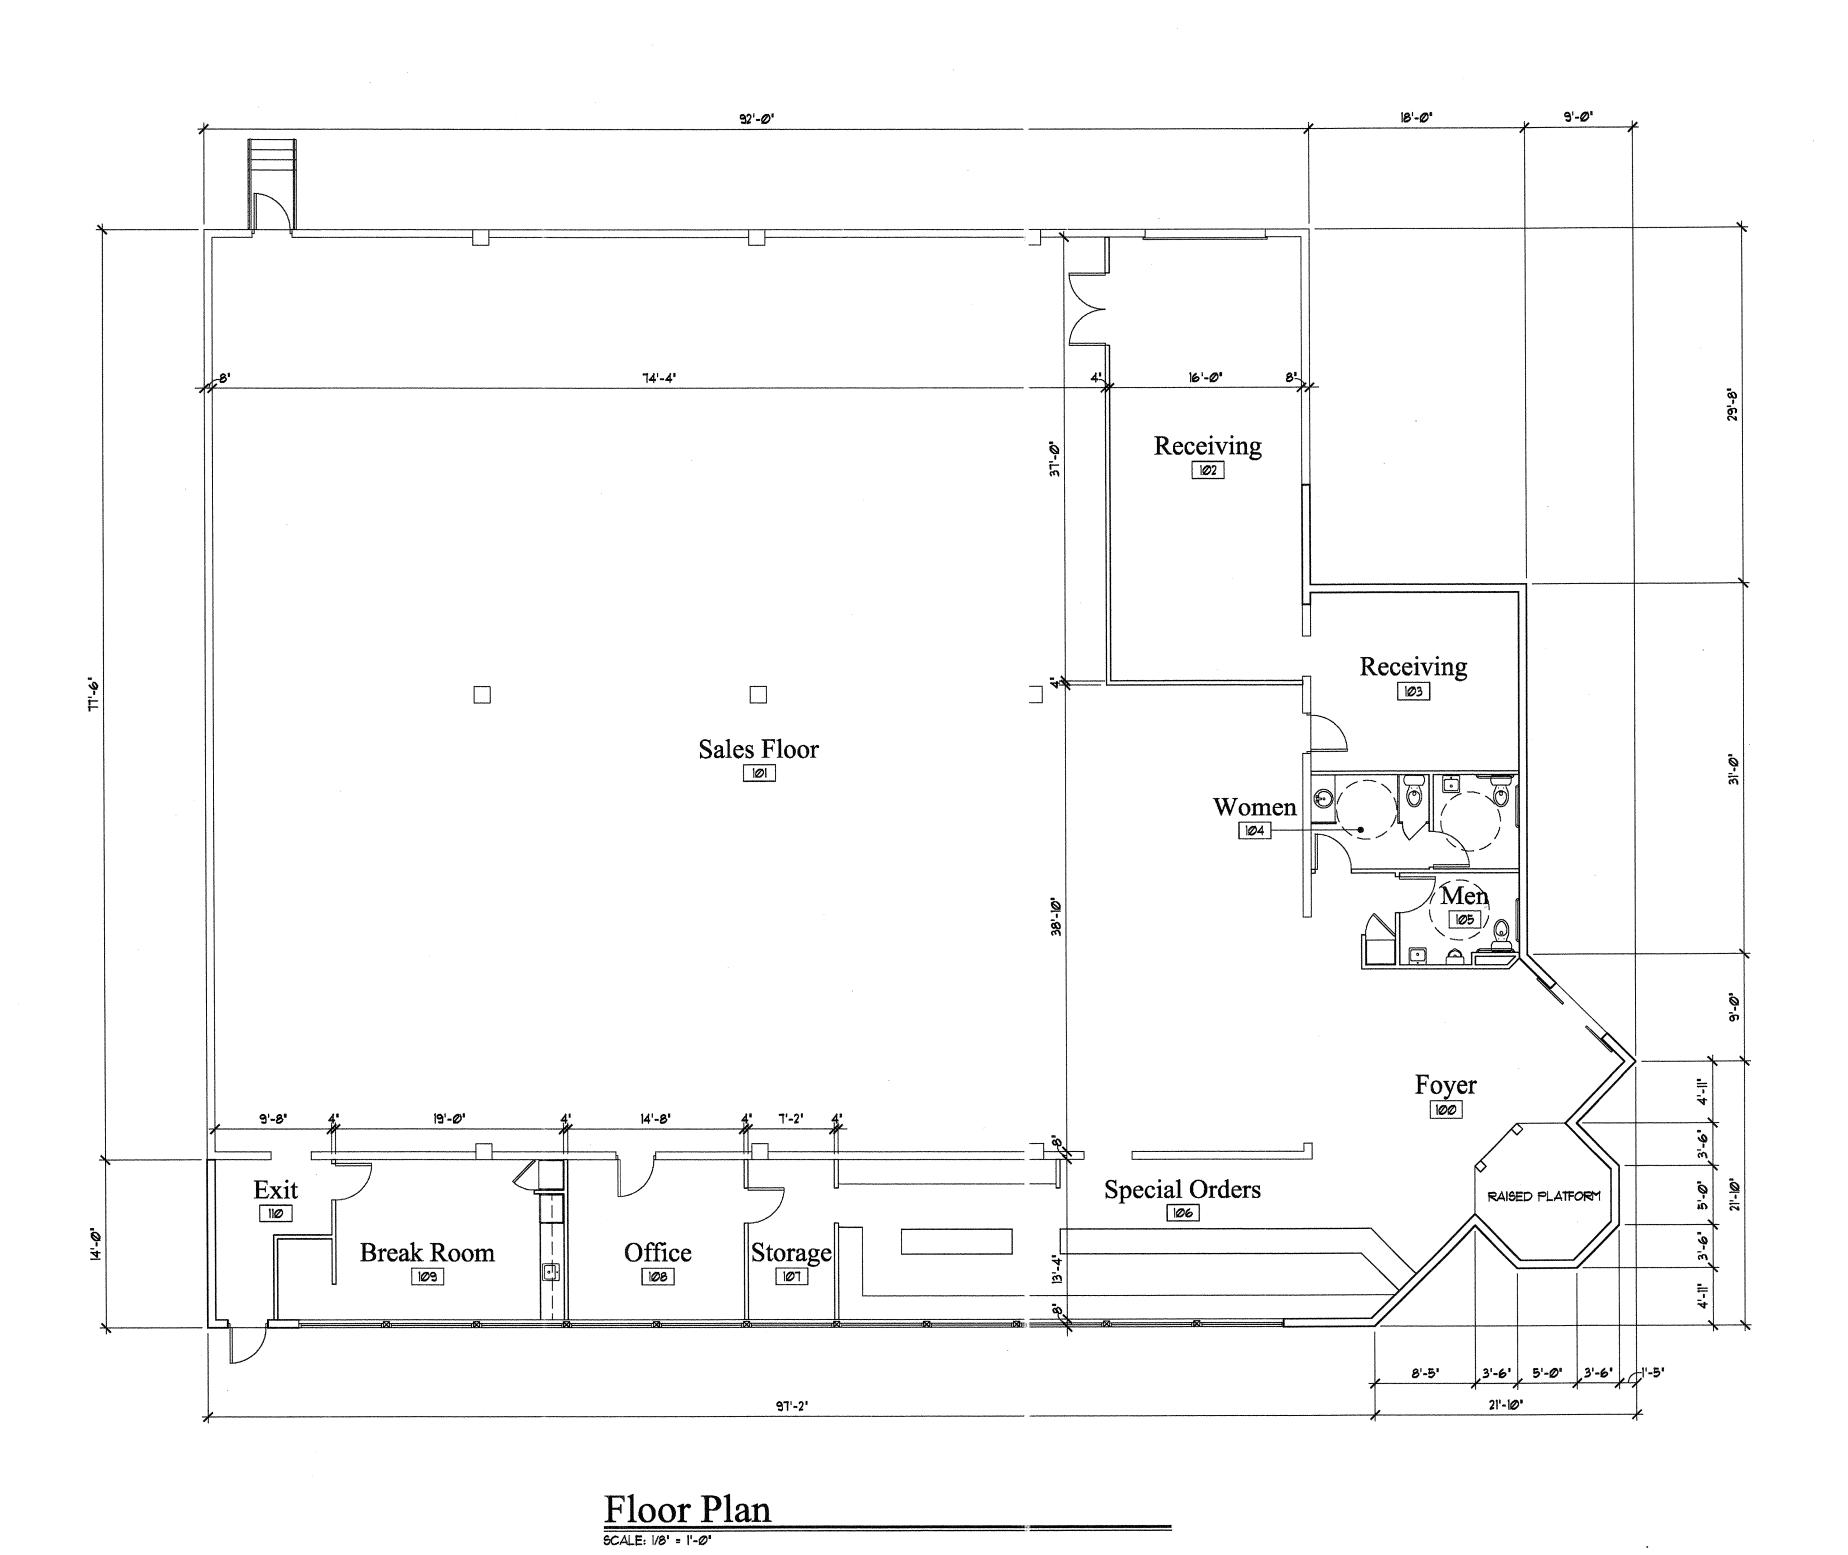Revisions


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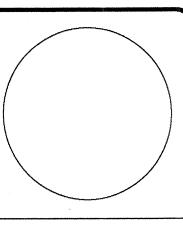
JOHN OBAROWSKI - ARCHITECT 2840 N.W. 2nd AVENUE SUITE 10 BOCA RATON, FLORIDA 33431 561-393-7525

> Boat Owners' Warehouse 311 State Road 84 Fort Lauderdale, Florida

Date February 8, 2011
Project Number:
Designed By:
Drawn By:
Checked By:
Sheet Title:
Sheet Number:

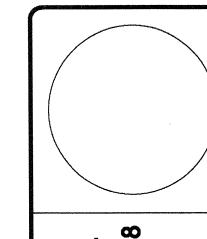

Issue Date:		
Revisions		
No.	Date	Description

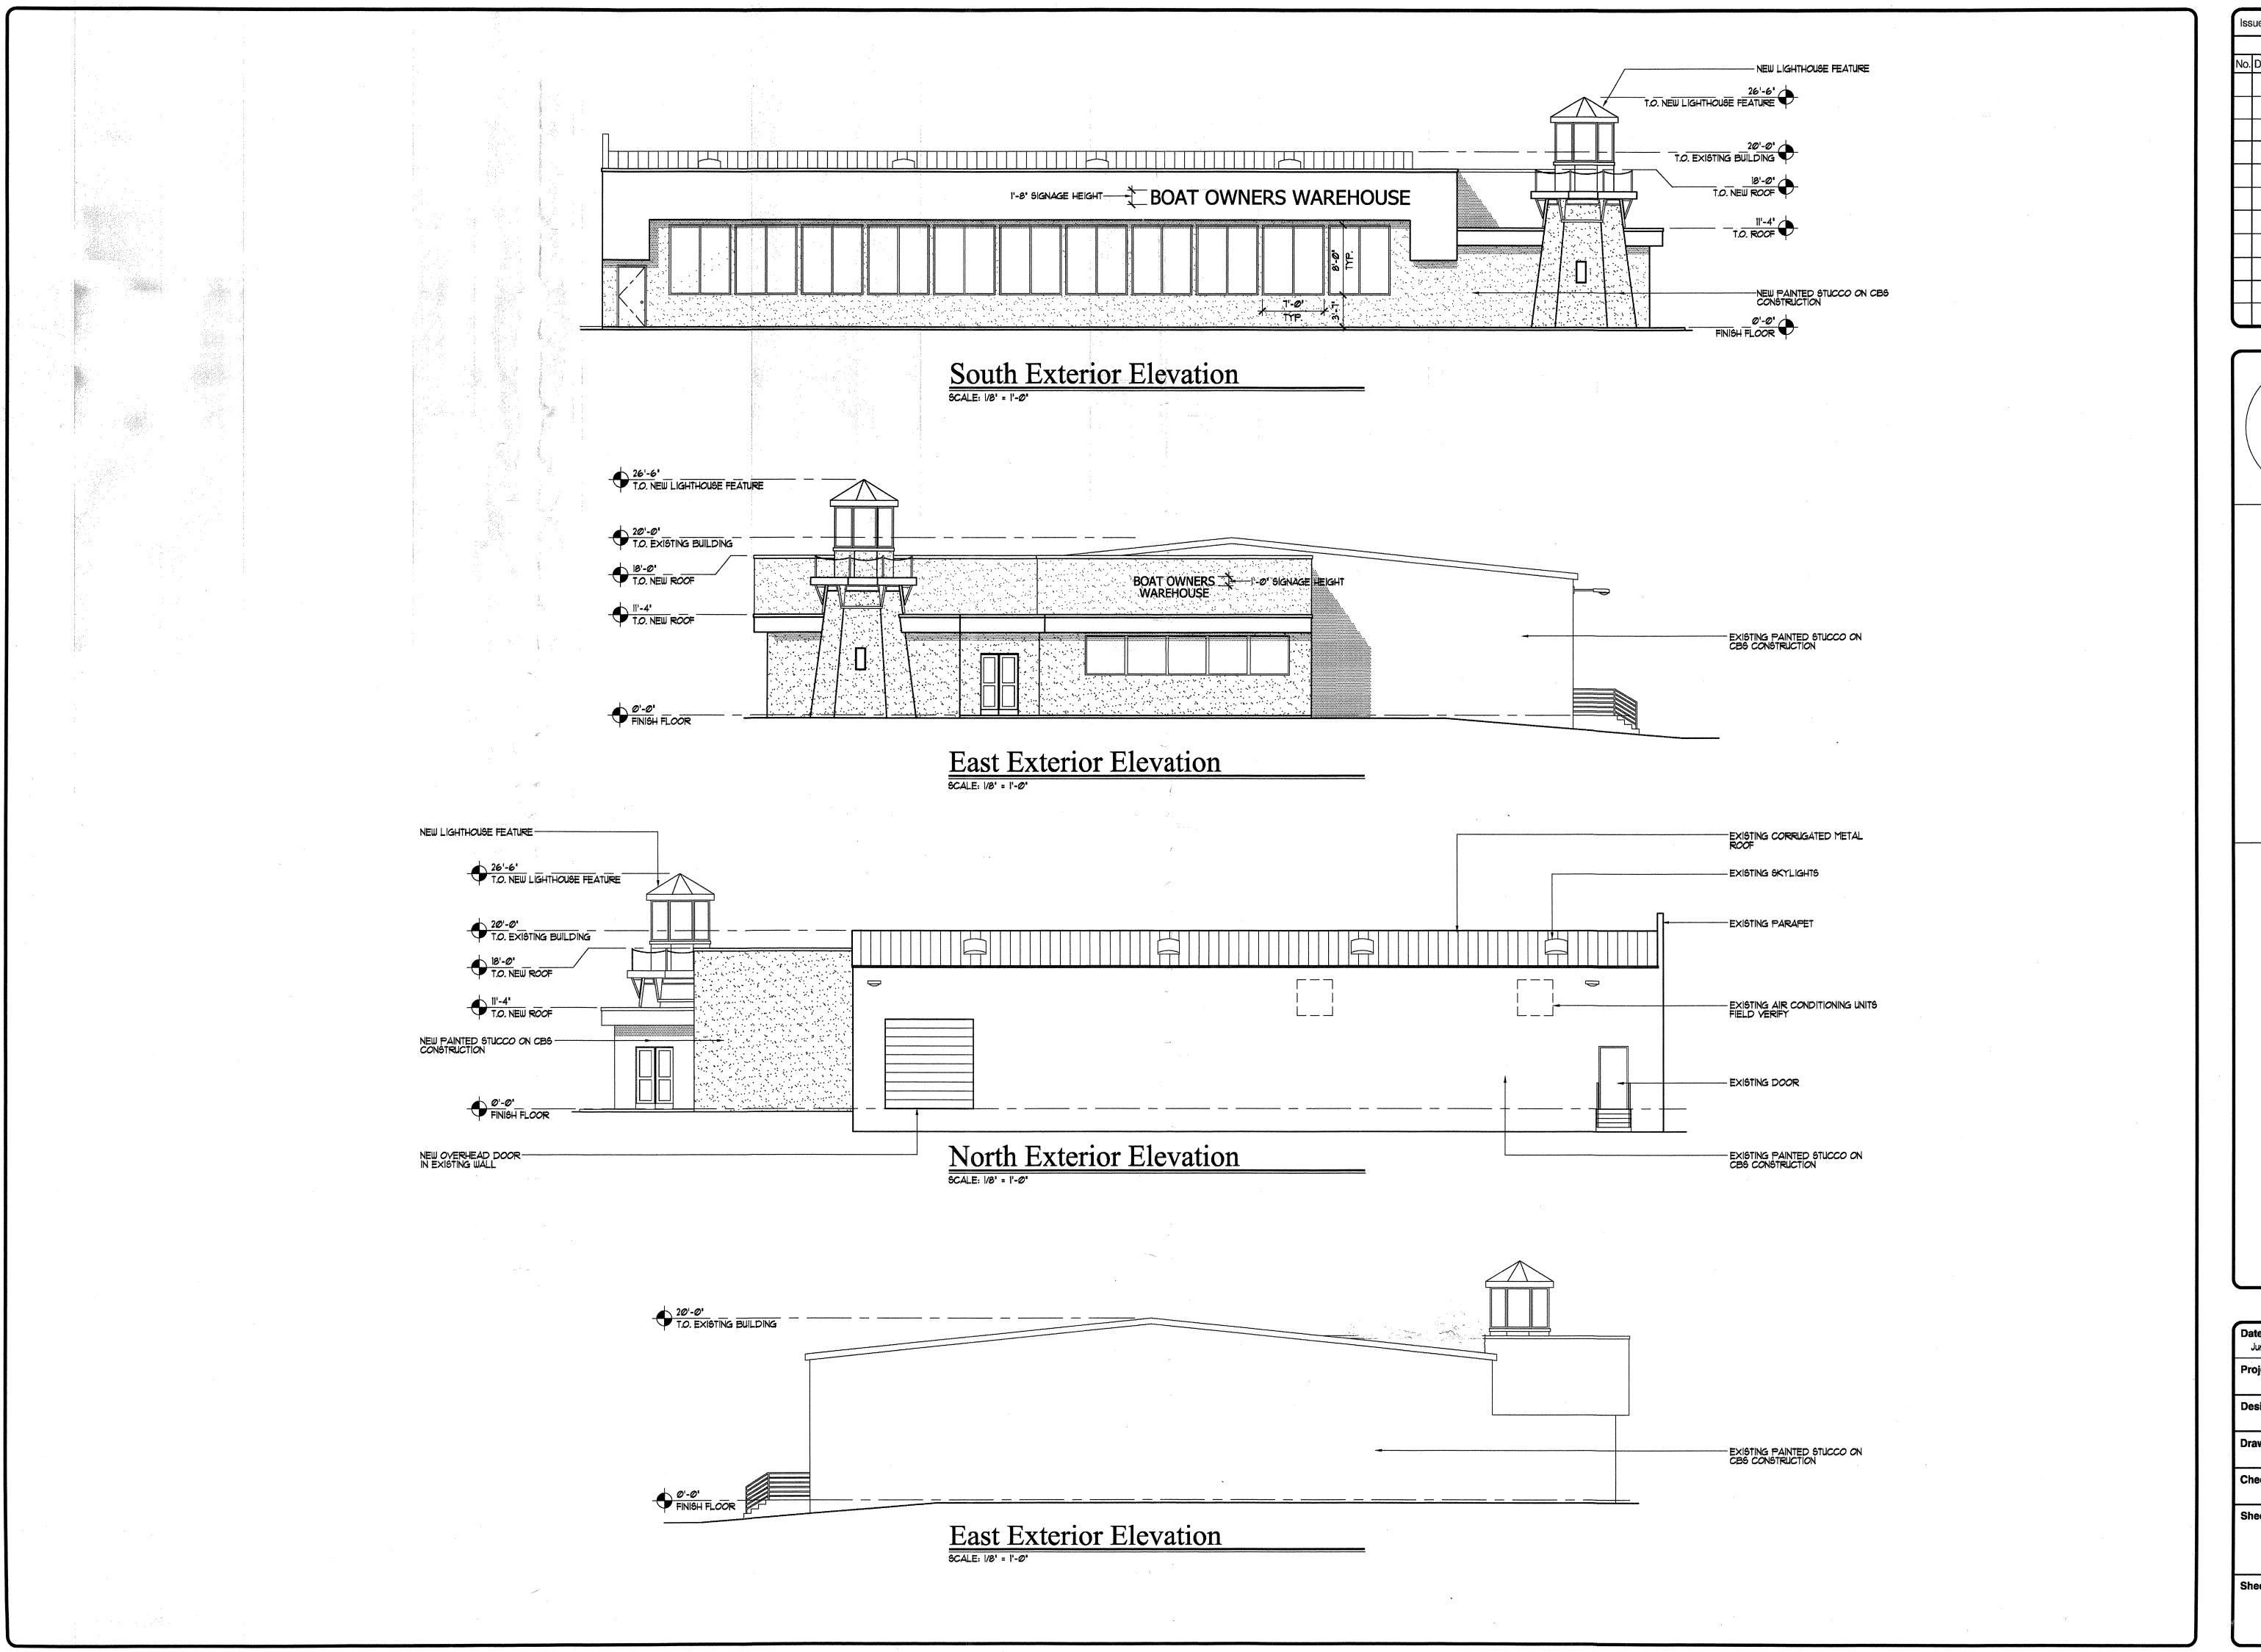

JOHN OBAROWSKI - ARCHITECT 2840 N.W. 2nd AVENUE SUITE 108 BOCA RATON, FLORIDA 33431 561-393-7525


Boat Owners' Warehouse 311 State Road 84

Date June 29, 2012
Project Number:
Designed By:
Drawn By:
Checked By:

Exterior Elevations

eet Number:

A-3EXHIBIT 2

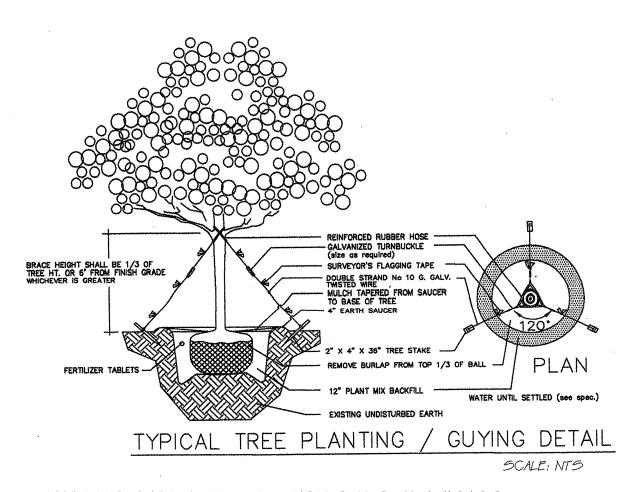


BRACE ME SHT SHALL BE 1/3 OF TREE HE R B' FROM FINISH GRADE WHICHESER IS GREATER TYPICAL TREE PLANTING / STAKING DETAIL SCALE: NTS

PROPOSED LANDSCAPE PLANT LIST


4'HT.X 3'SPR.


SOLID SOD

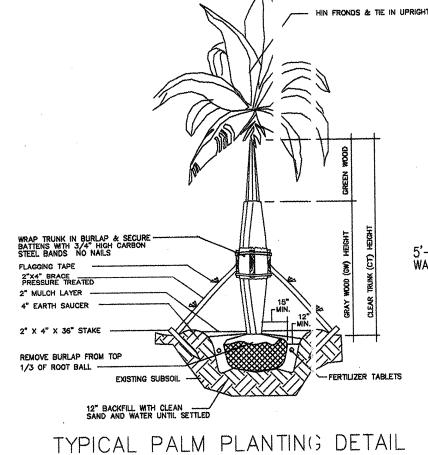

SCALE: NTS

RESIDENTIA_ AREA

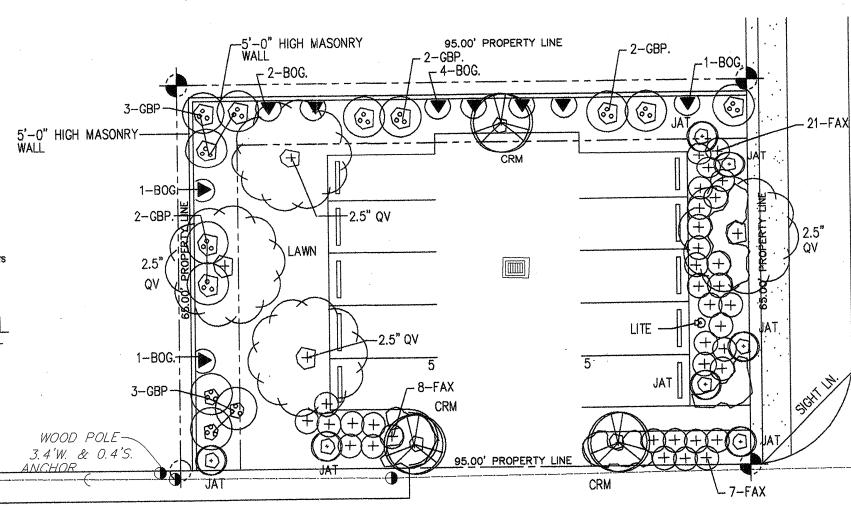

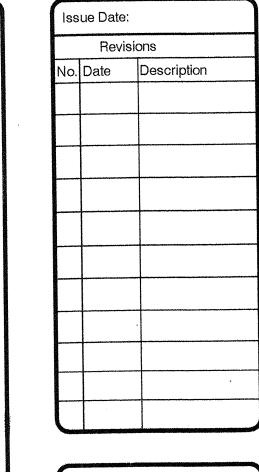

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WOOD POLE

WOOD LIGHT POLE

GRAPHIC SCALE

1 inch = 16 ft.

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JAN. 10, 2013 Project Number: Designed By: HKK. RLA Drawn By: HKK. RLA Checked By: HKK. RLA, LCS Sheet Title: LANDSCAPE PLANTING PLAN

Sheet Number:

FXHIBIT 2


Page 13 of 14

PROPOSED LANDSCAPE CALCULLATIONS

PROPOSED LANDSCAP	PE CALCULAI I REQUIRED	ONS PROVIDED
NET LOT AREA TREES 1 PER 1,000 S.F. 9,243 S.F.NET LOT AR.	= 9	= 9
V.U.A. LANDSCAPE AREA = 9,640 S.F. (20% DF GROSS V.U.A.)	= 1,928 S.F.	
PERIMETER LANDSCAPE AREA 317 LIN, FT. @ 10' AVERAGE	= 3,170 S.F.	
INTERIOR LANDSCAPE AREA 30 SF. PER INTERIOR SPACE X 12	= 360 S.F.	
V.U.A. TOTAL TREES = 9,640 S.F. 1 PER 1,000 S.F.	= 10	= 10
STREET TREES 118 LIN. FT. OUTSIDE VUA PERIMETER 200 LIN. FT. TOTAL	= 7	= 7
RES. BUFFER YARDS = 1,500 S.F. 1 PER 300 S.F.	= 5	= 5
TOTAL TREES	= 31	= 31
V.U.A. TOTAL SHRUBS = 9,640 S.F. 6 PER 1,000 S.F.	= 58	= 218
V.U.A. SHADE TREES 3" CAL.	= 3	= 3
V.U.A. SHADE TREES 2- 3" CAL.	= 2	= 2
V.U.A. FLOWERING TREES	= 2	= 2
V.U.A. PALM TREES	= 2	= 2
V.U.A. OPTIONAL TREES	= 1	= 1
STREET SHADE TREES	= 7	= 7
RES. BUFFER YARDS	= 5	= 5

GENERAL NOTES

- SEE ARCHITECTURAL SITE PLAN FOR ALL SITE DIMENSIONS
- EXISTING IRRIGATION TO BE UP-GRADED TO PROVIDE 100% COVERAGE TO NEW LANDSCAPE PLANTINGS, SEE PROPOSED IRRIGATION PLANS
- IRRIGATION LAYOUT TO BE ADJUSTED TO FIELD CONDITIONS
- 4. ALL PLANT MATERIAL SHALL BE FLORIDA NO.1 OR BETTER. ALL PLANT MATERIAL SHALL BE INSTALLED IN ACCORDANCE WITH GOOD NURSELY PRACTICES.
- THE ZONING OF ALL ADJACENT PROPERTIES IS COMMERCIAL
- SEE ENG. PLANS FOR LOCATION OF ALL UTILITY LINES
- ALL EXISTING TREES ARE SHOWN ON THE LANDSCAPE PLAN
- PRIOR TO COMMENCEMENT OF ANY EXCAVATION, THE CONTRACTOR SHALL COMP_Y WITH FLORIDA STATUTE 553.851 "PROTECTION OF UNDERGROUND GAS PIPELINES."
- NO CONSTRUCTION SHALL COMMENCE UNTIL ALL REQUIRED PERMITS AND APPRIVALS HAVE BEEN SECURED AND THE CONTRACTOR IS ISSUED A NOTICE TO PROCEED.
- 11. ALL VEGETATION DEBRIS, CONCRETE OR OTHER UNSUITABLE MATERIAL SHALL BE DISPOSED OF BY THE CONTRACTOR, IN OFF-SITE AREAS PROVIDED BY HIM.
- 12. THE CONTRACTOR SHALL COMPLY WITH ALL STATE AND LOCAL WATER QUALITY STANDARDS.
- 13. THE LOCATION OF UTILITIES SHOWN ON PLANS ARE APPROXIMATE ONLY. THE EXACT LOCATION SHALL BE DETERMINED BY THE CONTRACTOR AND THE UTILITY OWNER, EXPOSING THE SUBJECT FACILITY SHOULD SUCH ACTION BE DEEMED NECESSARY. THE APPROPRIATE UTILITY COMPANIES SHALL BE NOTIFIED 48 HOURS IN ADVANCE BY THE CONTRACTOR.
- 14. UTILITY OWNERS ARE:
- FLORIDA POWER AND LIGHT (ELECTRIC) SOUTHERN BELL TELEPHONE AND TELEGRAPH COMPANY
- 15. THE CONTRACTOR SHALL CALL U.N.C.L.E. 1-800-432-4770 (TOLL FREE) 48 HOURS BEFORE DIGGING FOR FIELD LOCATIONS OF UNDERGROUND UTILITIES.
- 16. THE CONTRACTOR SHALL EXERCISE EXTREME CAUTION IN AREAS OF BURIED UTILITY CABLES, SANITARY LINES, AND WATER LINES.
- 17. CAUTION SHOULD BE EXERCISED WHILE WORKING IN OR AROUND OVERHEAD
 TRANSMISSION LINES, NEAR EXISTING GROUND MOUNTED AND OVERHEAD SIGNS TO
 PREVENT UNNECESSARY DAMAGE. SIGNS AND STRUCTURES SHALL BE REPLACED BY THE CONTRACTOR AT HIS EXPENSE IF ANY ARE DAMAGED BEYOND USE, AS DETERMINED BY
- 18. ALL PLANT MATERIAL SHALL BE INSTALLED A MINIMUM OF TEN FEET (10') FROM OVERHEAD ANY UNDERGROUND UTILITIES AND NO LESS THAN TWENTY FEET (20') FROM OVERHEAD LINES AND UTILITIES, UNLESS APPROVED BY THE ENGINEER. IF THE INSTALLATION OF ANY PLANT MATERIAL DAMAGES ANY EXISTING UTILITIES, THE CONTRACTOR SHALL DEPOSITE OF THE PROPERTY O BE RESPONSIBLE FOR THE REPAIR OF ALL DAMAGE RESULTING FROM THE PLANTING OPERATION.
- 19. WHENEVER THE PLANT MATERIAL AND UTILITIES ARE IN CONFLICT, THE CONTRACTOR SHALL NOTIFY THE ENGINEER IN ORDER TO FIELD ADJUST THE PLACEMENT OF THE PLANT MATERIAL.

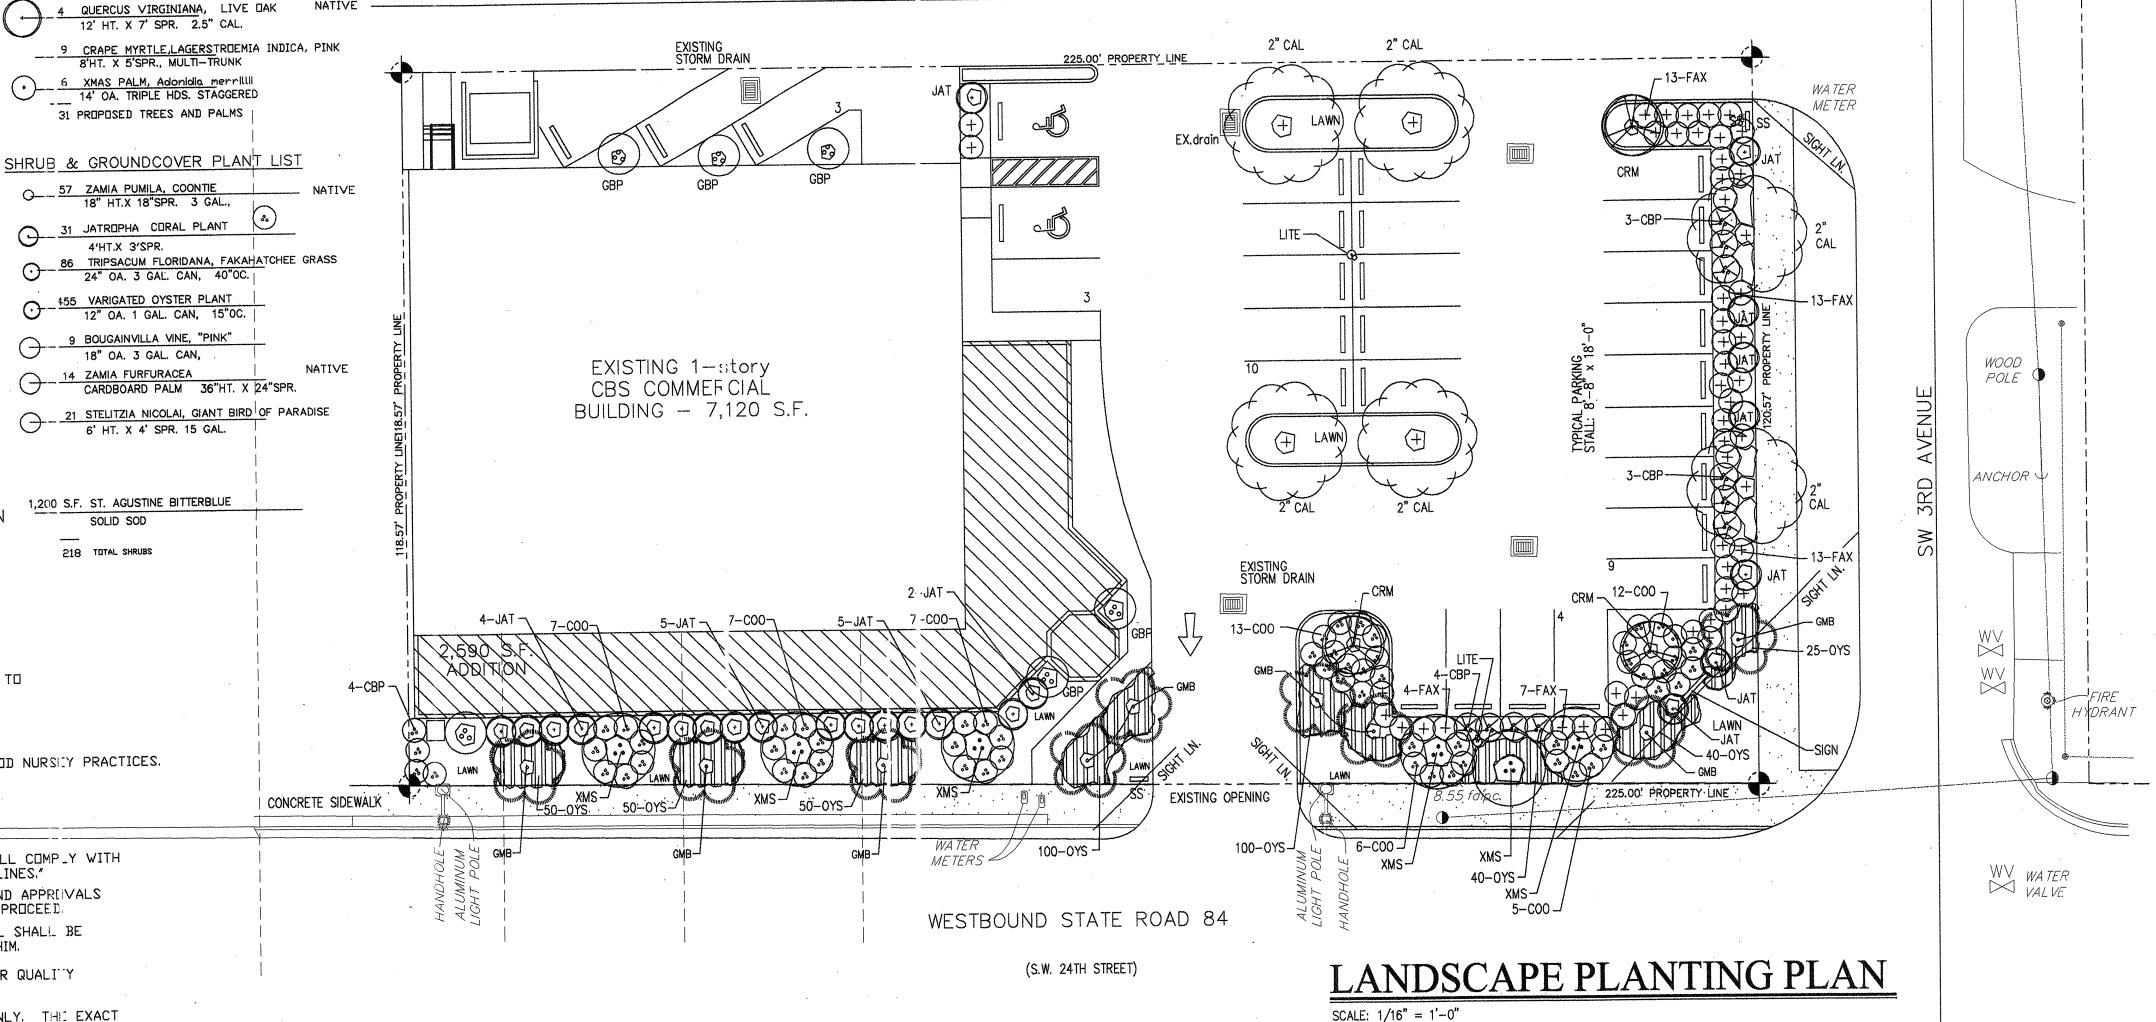

SITE DATA

SW 23rd St.

E 24TH ST.

STF TE ROAD # 84

NOT TO SCALE)

- 9" PREPARED PLANTING SOIL BACKFILL AND WATER UNTIL SETTLED

EXISTING UNDISTURBED SOIL

SCALE: NTS

TYPICAL SHRUB/GROUNDCOVER PLANTING DETAIL

CONCRETE MEDIAN

227 Goolsby Blvd. Deerfield Beach, Fl. 33442, 954 426-4305

PROJECT

LOCATION

SITE DATA

ZONING: B-1 RETAIL

PARKING: 39 TOTAL SPACES
AREA: 7,120 S.F. EXISTING + 2492 S.F. ADDITION
9,612 S.F. TOTAL


LANDSCAPE ARCHITECTURE


SHEET NO. 1 OF 1


LAND PLANNING


SITE PLANNING

TOTAL LOT AREA: 33,078 S.F.
OPEN AREA: 23,466 S.F. = 70.7%
GREEN AREA: 7,705 S.F. = +/-21.8%
BUILDING COVERAGE: 9,612 S.F. = 29.3%

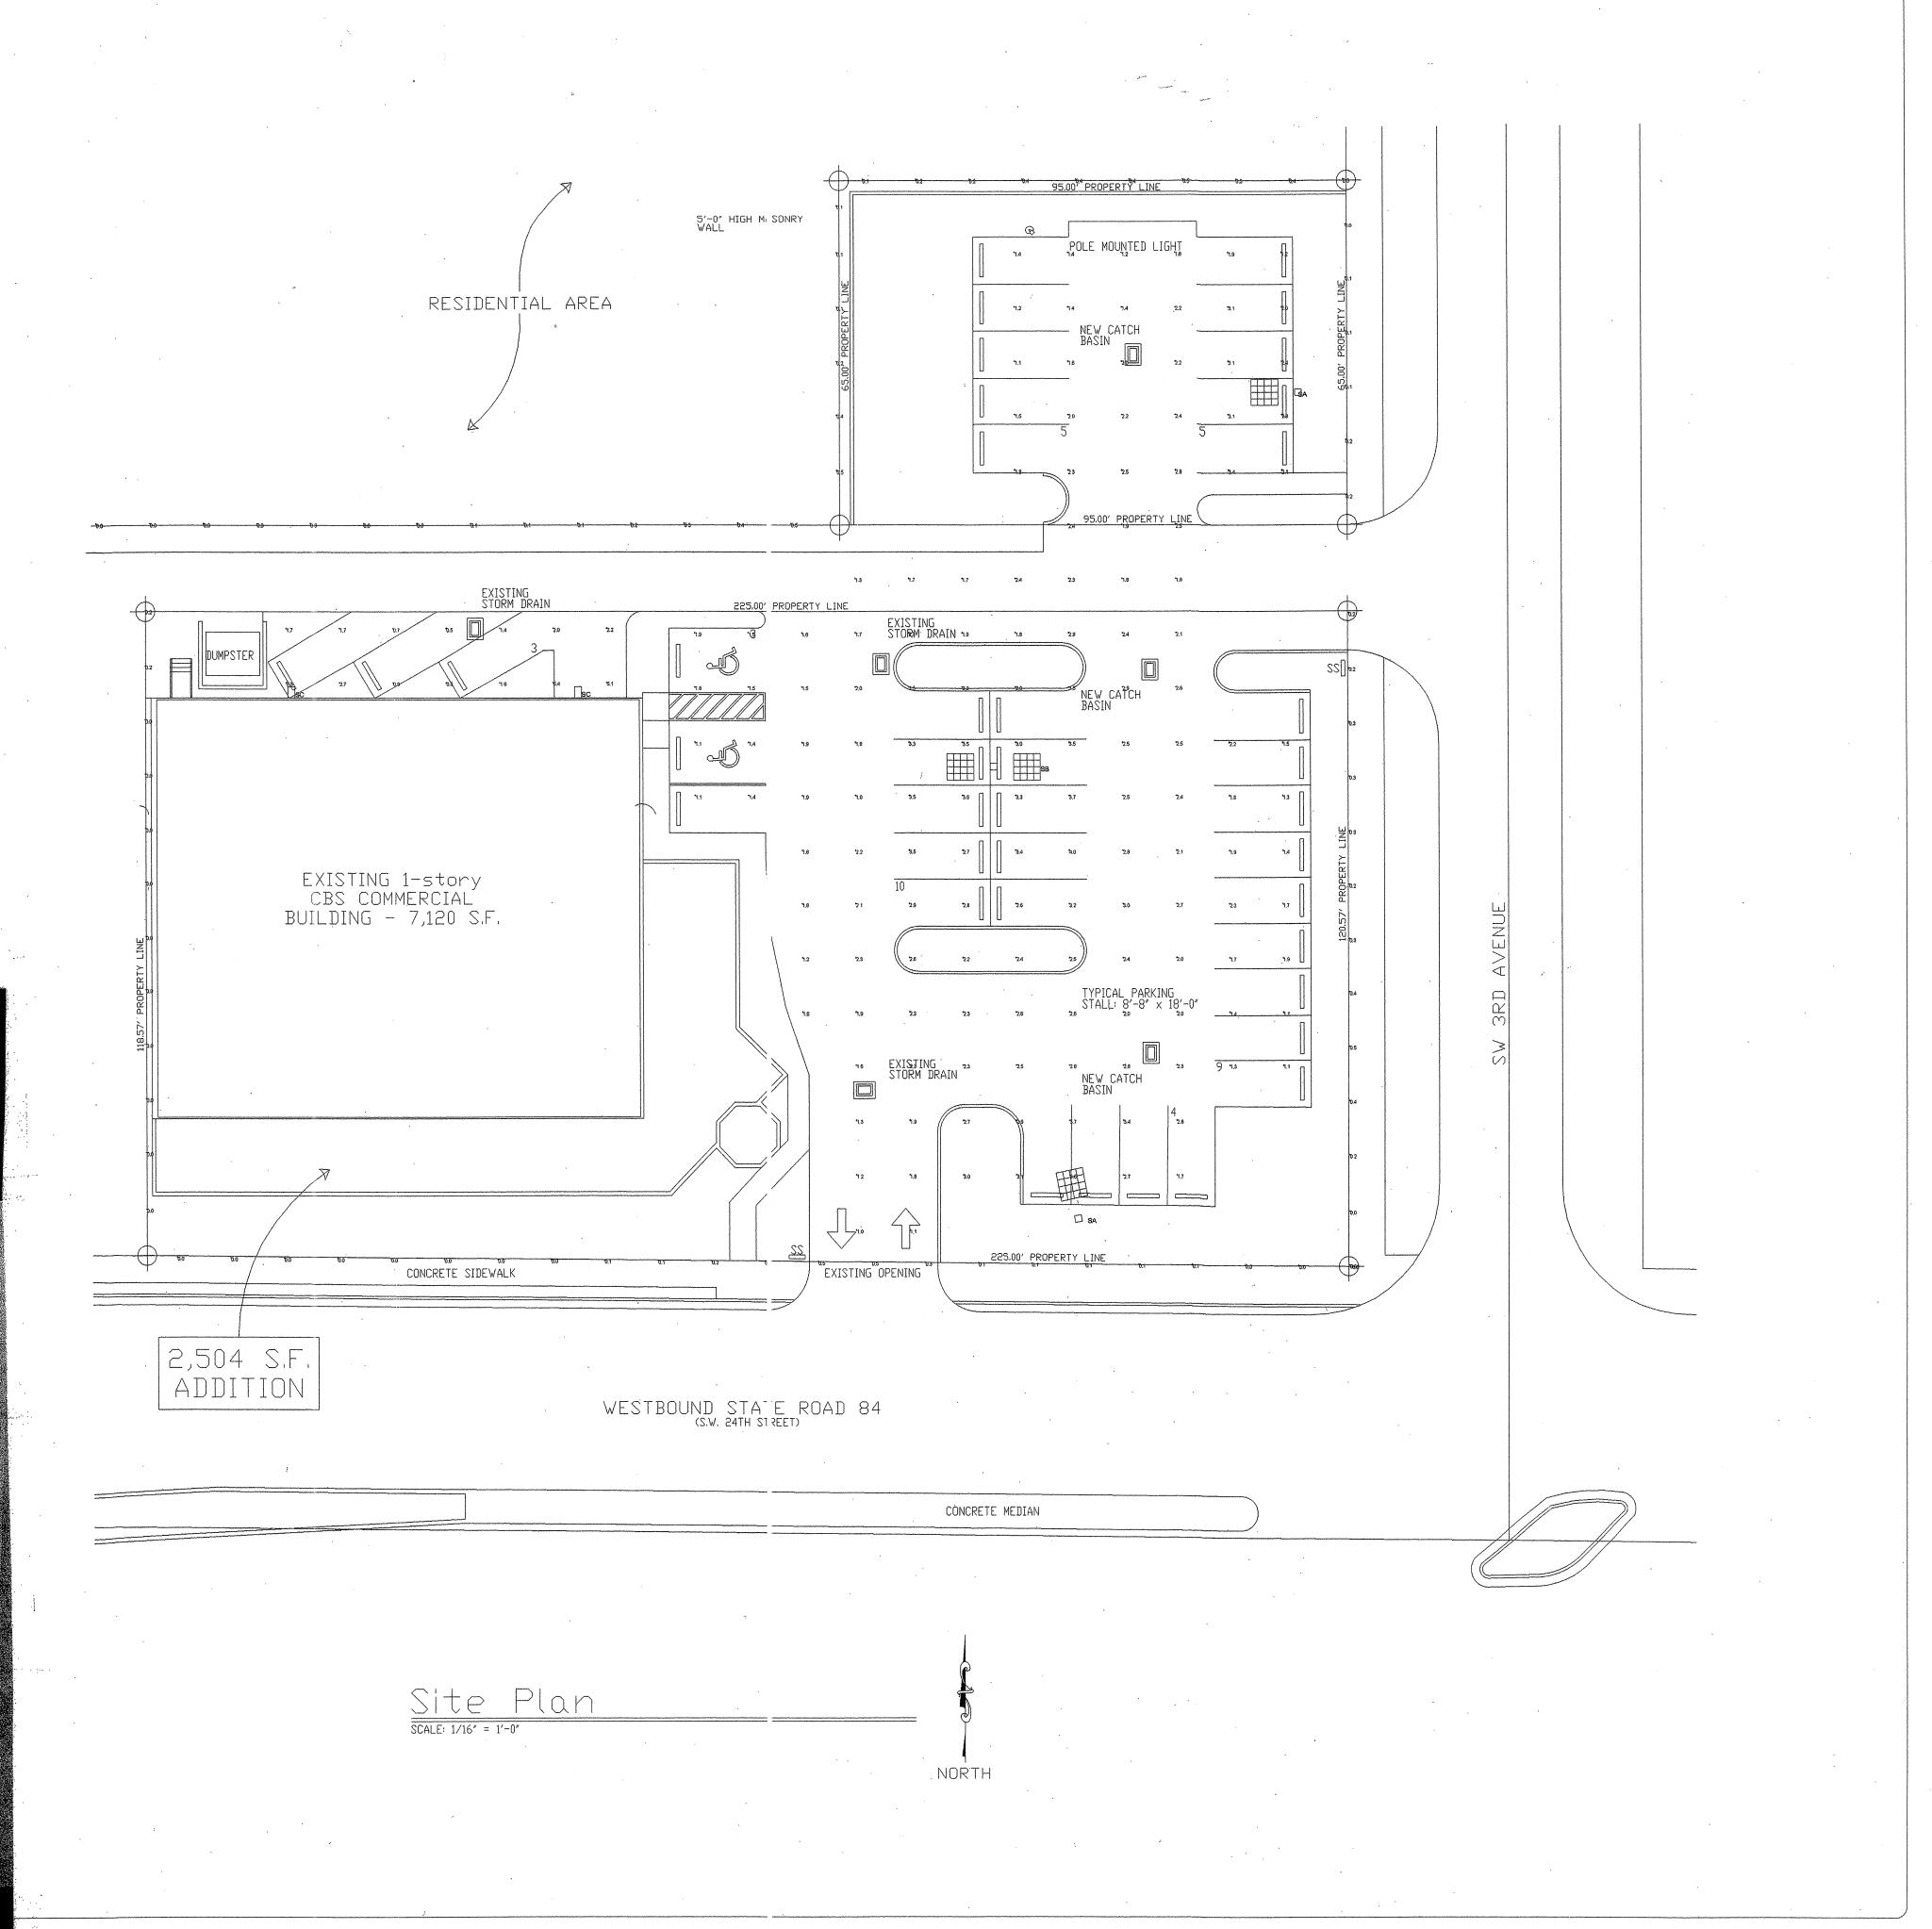

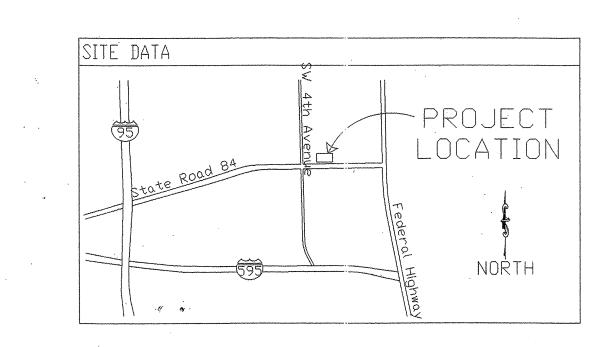

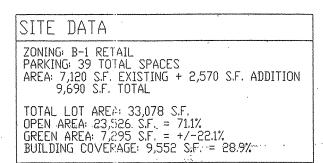

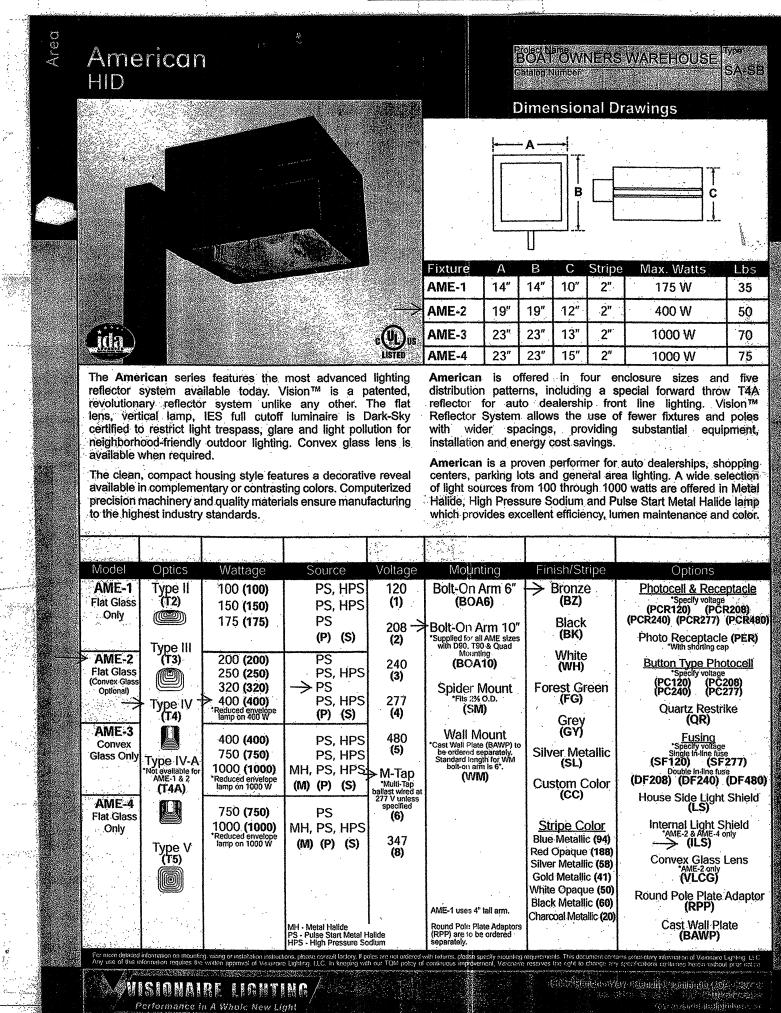

13-0839 Page 14 of 14

EXHIBIT 2

Issue Date:

Revisions

NoDate Description

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Koar dale,

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O M

February 8, 2011

Project Number:

Designed By:

Drawn By:

Checked By:

Sheet Title:

| Sheet Number:

Date