

PERMIT NO. CC13-12

**District 3** 



Applicant Name and Job Number Crown Castle NG East LLC SFL 63\_2 Job Address and Location 421 NW 12 Street Description of Work Installing cabinet and utility pole within right-of-way. Anticipated start and end dates of work \_\_\_6/2/14- 45 days X This permit application is for an exemption from the requirement to install communications service facilities below grade, in accordance with Section 25-100.1.B.3 of the City of Fort Lauderdale Code of Ordinances (Code). A letter by a qualified expert(s) is attached. Crown Castle is requesting the following waivers (check all applicable subsections and attach supporting documentation): □ C.1 □ C.2 □ C.3 ☐ C.4 □ C.6 □C.7 ☐ C.12 (Size) (Height) (Front Yard) (Corner Yard) (Separation) (Exist. Facility) (Collector) X With the exception of any waivers that may be checked above, the proposed at grade facilities conform to the requirements in Section 25-100.1 of the Code Notice of the pending application has been provided to all property owners abutting public rights-of-way within X one hundred fifty (150) feet of the proposed site and to the relevant homeowner association, in accordance with Section 25-100.1.E.5 of the Code. X The proposed site will be maintained by Crown Castle in accordance with the approved Graffiti Mitigation Plan dated \_\_\_\_\_\_\_, which is on file with the City Engineer A landscaping maintenance commitment letter from the adjacent property owner and relevant home owner association is attached to this application. X Crown Castle shall be responsible for maintaining landscaping X The proposed at grade facilities depicted on the attached plans are completely located in the public rights-ofway. As an authorized representative of Crown Castle, I certify under oath that the forgoing statements are true and correct. **Armando Hernandez** Printed Name of Authorized Crown Castle Agent Signature of Authorized Crown Castle Agent 674 day of hpy, 2008, 2014 Sworn to and subscribed before me this My Commission Expires 8 · 23 · 16 Notary Public, State of Florida Notary Public State of Florida (Sea Angel Prieto My Commission EE 829439 Expires 08/23/2016 (Do not write below this line) YWWWAAAAA Conceptual approval date \_\_\_\_\_, Subject to the following conditions: by 1) A detailed visual mitigation plan is required Final Permit approval date\_\_\_\_\_\_by Final Inspection date\_\_\_\_\_by \_\_\_\_

\*\*Notify Engineering Permits Division 24 hours prior to starting work at (954) 828-5649



CLIENT:

**CROWN CASTLE** SFL63\_2

ADDRESS:

CLIENT SITE ID#:

421 NW 12TH STREET FORT LAUDERDALE, FLORIDA 33311

SITE TYPE:

NEW CROWN CASTLE 40' CONCRETE POLE

FROM THE CROWN CASTLE OFFICE IN MIAMI, HEAD WEST ON NW 64TH ST TOWARD NW 87TH AVENUE. TURN RIGHT ONTO NW 87TH AVENUE. TURN RIGHT ONTO NW 74TH STREET. TURN LEFT

TO MERGE ONTO FL-826 NORTH. TAKE THE EXIT TOWARD FL-826 EAST/BEACHES. MERGE ONTO FL-826 EAST/FL-91 SOUTH. TURN LEFT ONTO NW 2ND AVENUE. TAKE THE RAMP ON THE

LEFT ONTO 1-95 NORTH. TAKE EXIT 29A TO MERGE ONTO FL-838 E/W SUNRISE BLVD. TURN LEFT ONTO NW 7TH AVENUE. TAKE THE 2ND RIGHT ONTO NW 12TH STREET. DESTINATION WILL BE

PROPERTY INFORMATION SITE COORDINATES:

PROPERTY OWNER: ADDRESS:

26.14031

-80.14856' **2** CITY OF FORT LAUDERDALE

CROWN CASTLE 8555 NW 64TH STREET

MIAMI, FL 33166

PROJECT TEAM

PROJECT MANAGEMENT FIRM: CROWN CASTLE ADDRESS: CROWN 64TH STREET MIAMI, FL 33166

ENGINEERING FIRM:

FLORIDA COA#:

CONTACT:

PHONE:

AW SOLUTIONS, INC. 300 CROWN OAK CENTRE DR. LONGWOOD, FL 32750 SHANE HAFNER 407.260.0231 EXT. 120

## DESIGN CRITERIA;

- 1. FLORIDA BUILDING CODE 2010 AND ASCE 7-10. WIND LOAD PER ASCE 7-10. A. ULTIMATE WIND SPEED: 170 MPH. B. BUILDING RISK CATEGORY: II. C. WIND EXPOSURE: C.
- 2. DEAD LOAD:
- A. EQUIPMENT WEIGHT PER MANUFACTURER DATA. 3. SEISMIC LOAD DOES NOT GOVERN THIS DESIGN.

**DRAWING** INDEX

SHEET	SHEET DESCRIPTION	R
T1	TITLE SHEET	
C1	SITE PLAN	
C1.1	LANDSCAPE MITIGATION PLAN	
C2	ELEVATION	
C3	DETAILS	
C4	DETAILS	
SP1	SPECIFICATIONS	
SP2	SPECIFICATIONS	

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300 CROWN OAK CENTRE DRIVE LONGWOOD, FL 32750 TEL: 407.260.0231 FAX: 407.260.0749 FL COA#: 26983 RAWN BY: EW CHECKED BY: JD

Mark Pond S. S. T. T. S. S. S. T. S.	·	
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DRIVING DIRECTIONS ————————————————————————————————————	SPECIFIC LOCATION MAP	

UNDERGROUND SERVICE ALERT CALL TOLL FREE -800-432-4770 48 HOURS BEFORE 05/05/14 REVISED LOCATION/EQUIPMENT 05/09/13 REVISED PER COMMENTS 10/30/12 ISSUED FOR PERMIT DATE DESCRIPTION

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SFL63\_2 DRESS: 421 NW 12TH STREET FORT LAUDERDALE, FL 33311

EET TITLE:


TITLE SHEET

SHEET NUMBER:

Exhibit 9

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LANDSCAPE NOTES: 1. ALL PLANT MATERIAL SHALL CONFORM TO THE STANDARDS FOR FLORIDA NO. 1 OR BETTER, AS GIVEN IN "GRADES AND STANDARDS FOR NURSERY PLANTS" PART I, 1963, AND PART 11, STATE OF FLORIDA, DEPARTMENT OF AGRICULTURE, TALLAHASSEE, FLORIDA.


2. IT SHALL BE THE RESPONSIBILITY OF THE LANDSCAPE CONTRACTOR TO VERIFY LOCATION OF ALL UNDERGROUND UTILITIES PRIOR TO BEGINNING WORK. ALL PLANT BEDS TO RECEIVE 10" OF 50/50 MIX. 50% SAND, 50% MUCK.

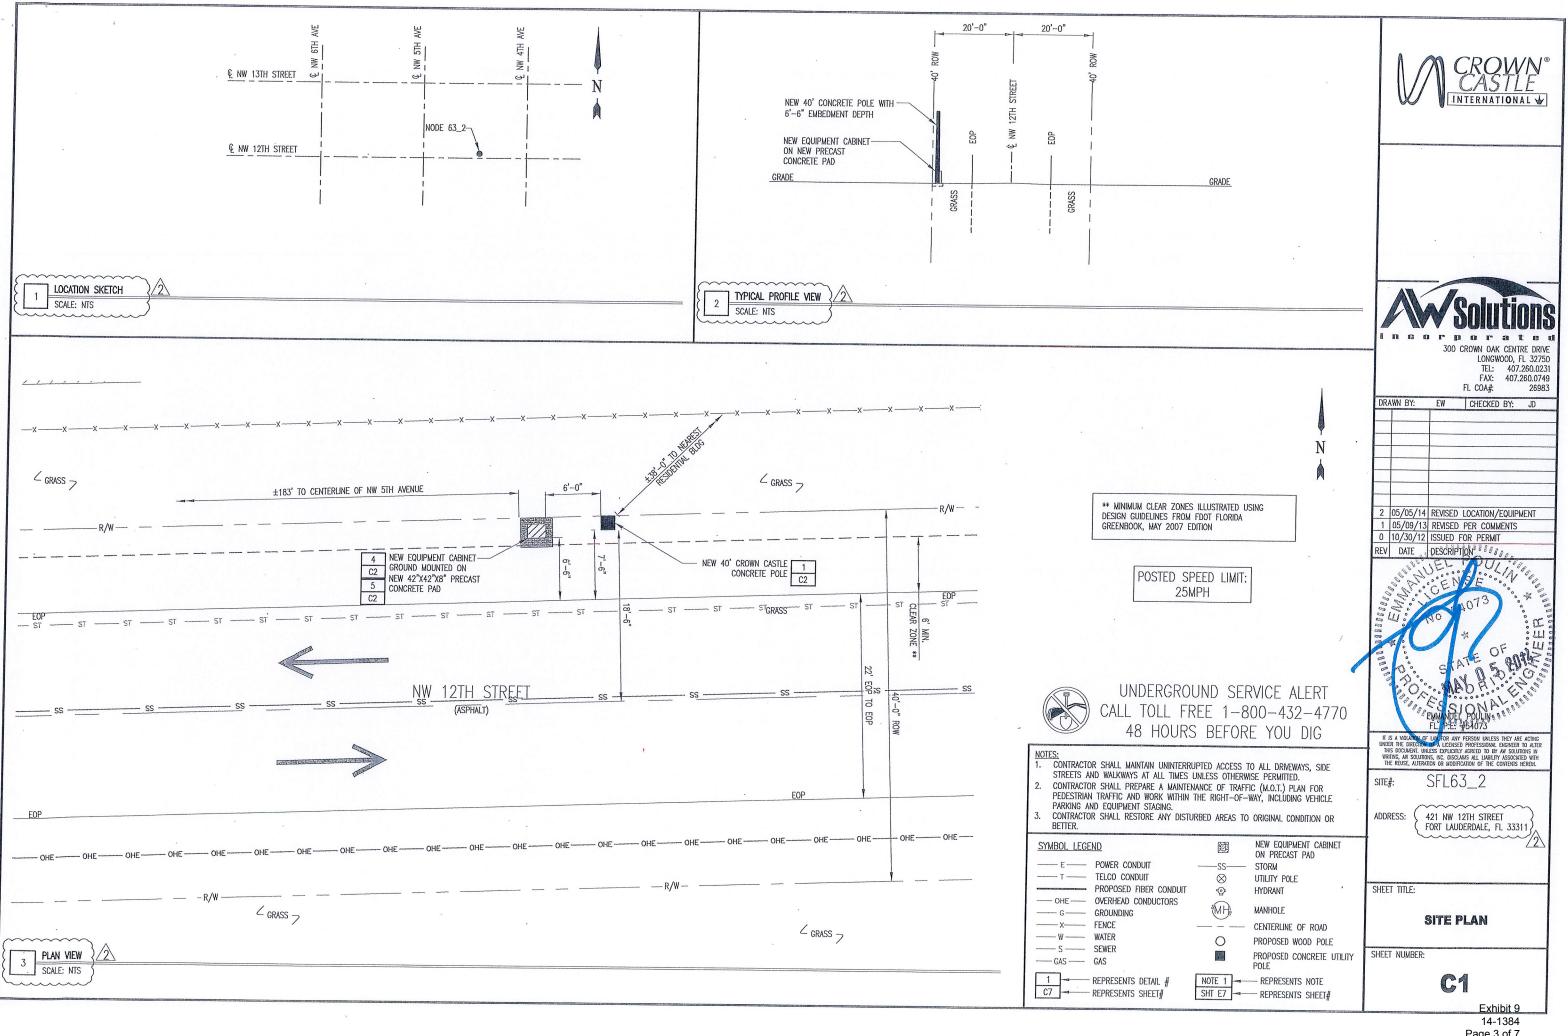IT SHALL BE THE RESPONSIBILITY OF THE LANDSACPE CONTRACTOR TO PROVIDE A SMOOTH UNIFORM GRADE PRIOR TO INSTALLING SOD. ALL MULCH TO BE 'FLORAMULCH' MELALEUCA MULCH. ALL TREES TO BE STAKED IN THE FIELD WITH APPROVED NURSERY STANDARD METHODS. 7. TREES/PALMS SHALL BE INSTALLED A MIN. OF 3' FROM UNDERGROUND UTILITIES. 4 NEW EQUIPMENT CABINET-GROUND MOUNTED ON C2

NEW 42"X42"X8" PRECAST

5 CONCRETE PAD

C2

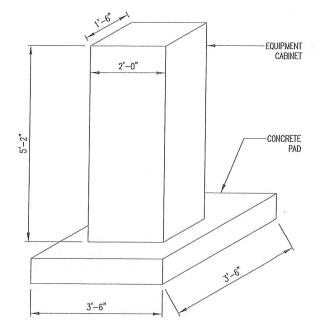

300 CROWN OAK CENTRE DRIVE LONGWOOD, FL 32750 TEL: 407.260.0231 FAX: 407.260.0749 FL COA#: EW CHECKED BY: JD 2 05/05/14 REVISED LOCATION/EQUIPMENT 1 05/09/13 REVISED PER COMMENTS 0 10/30/12 ISSUED FOR PERMIT REV DATE DESCRIPTION

INTERNATIONAL &



## UNDERGROUND SERVICE ALERT CALL TOLL FREE 1-800-432-4770 48 HOURS BEFORE YOU DIG

 ${\color{red} {\rm NOTES:}}$  1. Contractor shall maintain uninterrupted access to all driveways, side STREETS AND WALKWAYS AT ALL TIMES UNLESS OTHERWISE PERMITTED. CONTRACTOR SHALL PREPARE A MAINTENANCE OF TRAFFIC (M.O.T.) PLAN FOR PEDESTRIAN TRAFFIC AND WORK WITHIN THE RIGHT-OF-WAY, INCLUDING VEHICLE PARKING AND EQUIPMENT STAGING. 3. CONTRACTOR SHALL RESTORE ANY DISTURBED AREAS TO ORIGINAL CONDITION OR

SYMBOL LEGEND		NEW EQUIPMENT CABINET ON PRECAST PAD
E POWER CONDUIT	SS	STORM
T TELCO CONDUIT	$\otimes$	UTILITY POLE
PROPOSED FIBER CONDUIT	•	HYDRANT
OHE OVERHEAD CONDUCTORS G GROUNDING	MH.	MANHOLE
X FENCE		CENTERLINE OF ROAD
W WATER	0	PROPOSED WOOD POLE
S SEWER		PROPOSED CONCRETE UTILIT
—— GAS —— GAS	1050	POLE
1 REPRESENTS DETAIL # C7 REPRESENTS SHEET#		REPRESENTS NOTE REPRESENTS SHEET#

UNDER THE DIRECTION OF A LICENSED PROFESSIONAL ENGINEER TO ALTER THIS DOCUMENT. UNLESS EXPLICITLY AGREED TO BY AW SOLUTIONS IN WAITING, AW SOLUTIONS, INC. DISCLAUS ALL LUBBLITY ASSOCIATED WITH THE REUSE, ALTERATION OR MODIFICATION OF THE CONTENTS HEREIN.

SFL63 2 SITE#:

421 NW 12TH STREET FORT LAUDERDALE, FL 33311 ADDRESS:


SHEET TITLE:

LANDSCAPE **MITIGATION PLAN** 

SHEET NUMBER:


C1.1

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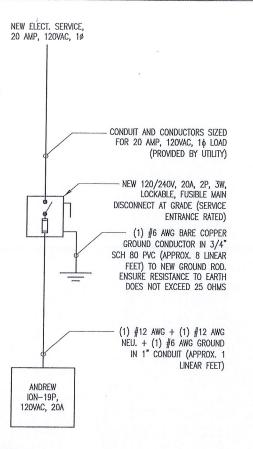


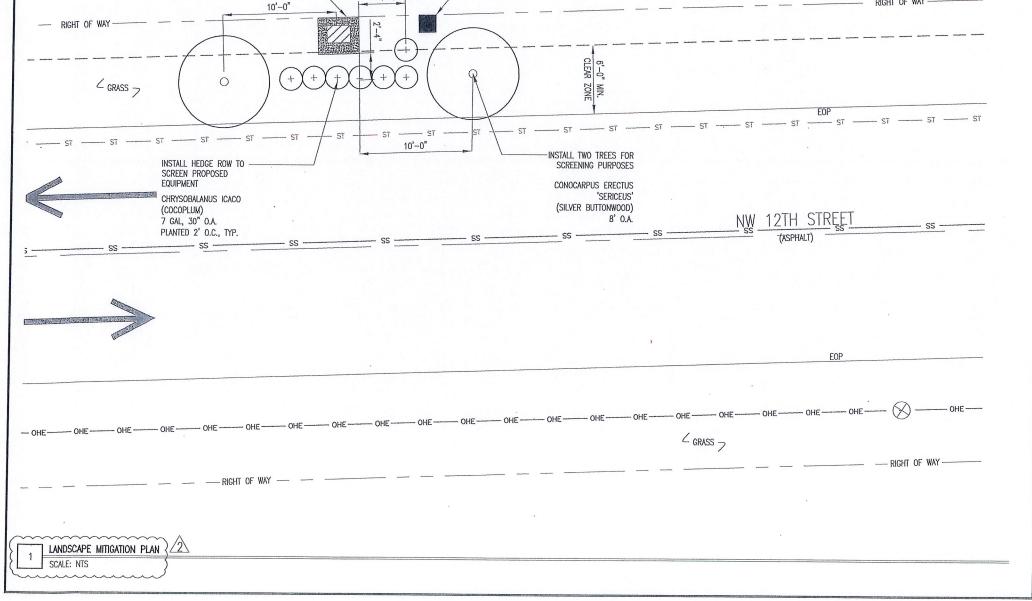NEW 40' CROWN CASTLE 1

CONCRETE POLE C2

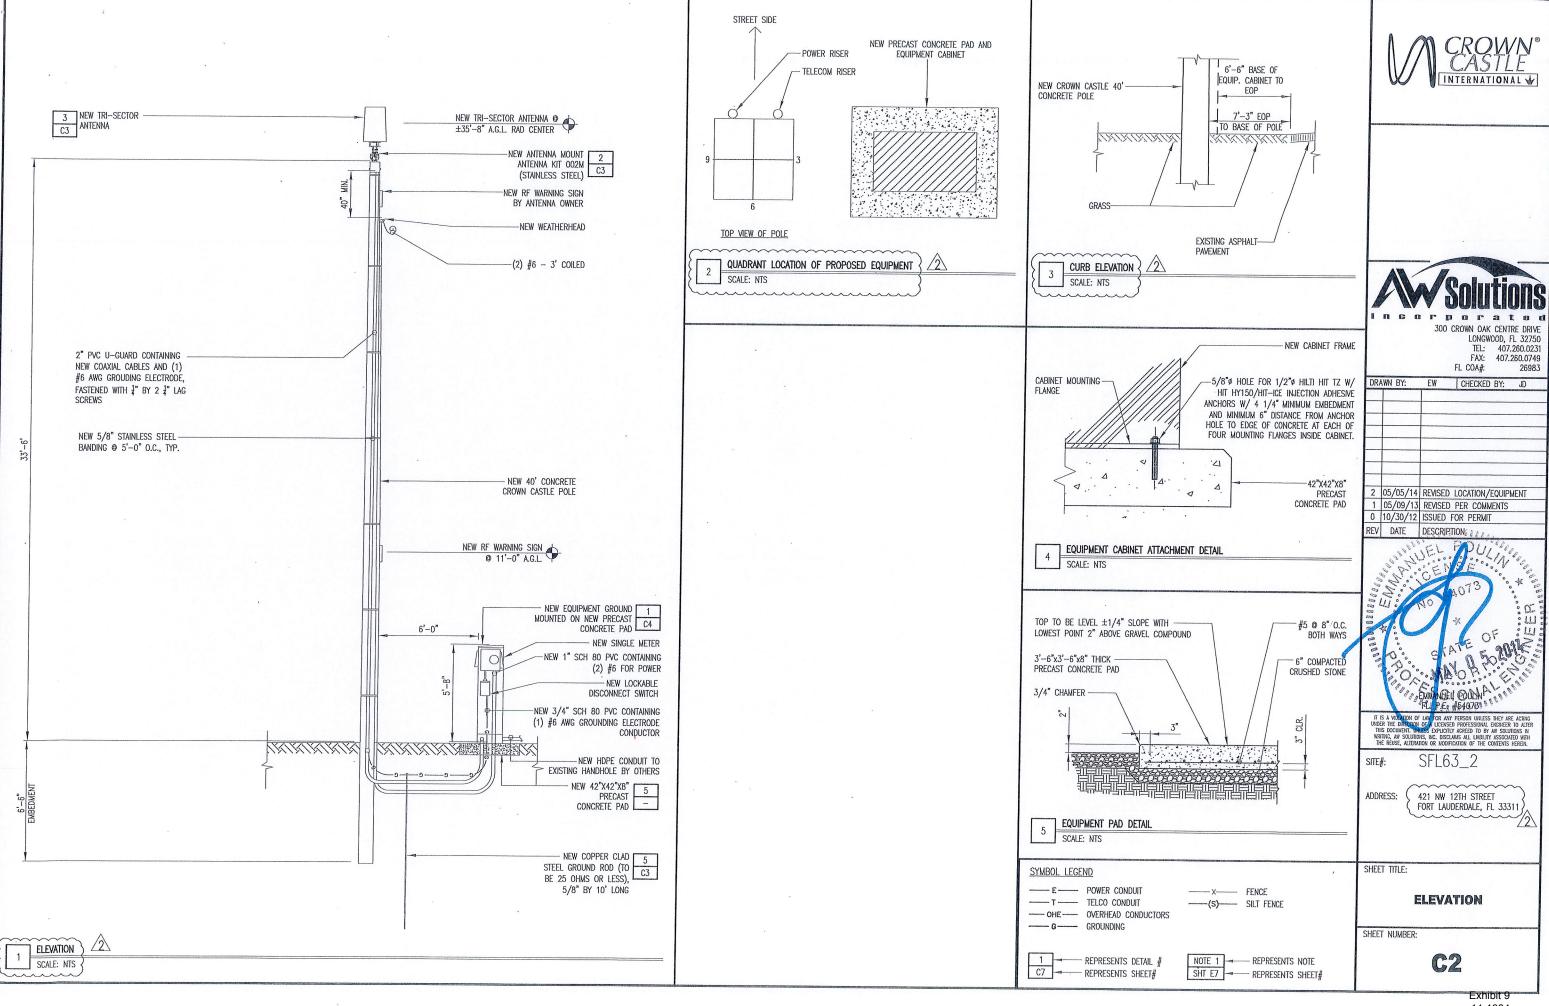

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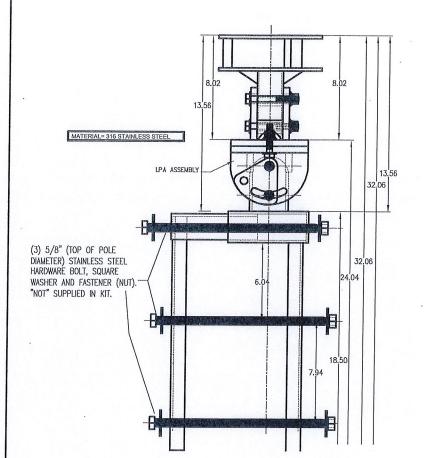


## RISER DIAGRAM SCALE: NTS

- SHORT CIRCUIT CURRENT RATING OF FUSIBLE MAIN DISCONNECT: 100kA.
- PER FLORIDA BUILDING CODE 2010: FEEDER CONDUCTORS ARE SIZED FOR A MAXIMUM VOLTAGE DROP OF 2% AT DESIGN LOAD OF 20A.
- PER FLORIDA BUILDING CODE 2010: BRANCH CIRCUIT CONDUCTORS ARE SIZED FOR A MAXIMUM VOLTAGE DROP OF 3% AT DESIGN LOAD. HOWEVER, THIS DESIGN

SEPARATION DIMENSION TO BE VERIFIED WITH LOCAL UTILITY CO. REQUIREMENTS.

ALL CONDUCTORS ARE TO BE COPPER WIRE WITH INSULATION TYPE XHHW. ALL ABOVE GRADE CONDUIT IS TO BE UV RESISTANT SCHEDULE 80 PVC. ALL BELOW GRADE CONDUIT IS TO BE SCHEDULE 40 PVC.



ANTENNA MOUNTING KIT (002M) SCALE: NTS

## SCALA DIVISION

Kathrein's dual band antennas are ready for 3G applications, covering all existing wireless bands as well as all spectrum under consideration for future systems, AMPS, PCS and 3G/UMTS.

- Wide band operation.
- Exceptional intermodulation characteristics.
- . High strength fiberglass radome.
- Internal diplexers allow the +45° polarization (upper and lower bands) to be combined on one connector and the -45° polarization (upper and lower bands) to be combined on a second connector for each antenna.

Frequency range	806–960 MHz 1710–2170 MHz			
VSWR	<1.5:1			
Impedance	50 ohms			
Intermodulation (2x20x)	M3: ≪150 dBc			
Polarization	445° upper and lower bard -45° upper and lower band			
Connector	6 x 7-16 DIN female			
Isolation intrasystem intersystem	>30 dB >40 dB (806–960 // 1710–2170 MHz)			
Radome color	Brown, gray or dark gray (custom colon available at additional cost)			
Weight	50 lb (22.7 kg)			
Height	24 inches (609 mm)			
Redome diameter	16 inches (407 mm)			
Equivalent flat plate area	1.6 ft² (0.148 m²)			
Wind servival rating*	100 mph (160 kph)			
Siepping dimensions	32 x 20 x 19 inches (B13 x 508 x 483 mm)			
Shipping weight	52 lb (29.6 kg)			
Mounting	Designed to be mounted on top of a utility pole using a custom mounting bracker supplied by the customer.			

+45° and -45° polerization 67° (helf-power) 66° (half-power)


25 dB (typical)

25 dB (typical)

GRADE

SCALE: NTS

ANTENNA GROUNDING SCHEMATIC

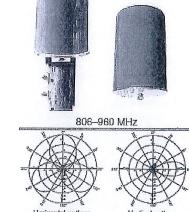

Horizontal pattern Vertical pattern ±45°-polarization 1710-2170 MHz Horizontal nation Vertical nattern

NEW TRI-SECTOR ANTENNA

-(1) #6 AWG GROUND IN

NEW LIGHTNING ARRESTOR

3/4" CONDUIT

rmonnation.					
806-886 MHz	824-894 MHz	2811-950 MHz	1710-1890 MHz	1850-1990 MHz	1920-2170 MHz
11.1 (15)	11. <b>4</b> dBi	11.8 dBi	12.5 dBi	13.3 dBi	13.6 dBi
>23 dB (co-polar) >20 dB (total power)	>23 dB (co-polar) >20 dB (total posser)	>25 dB (co-polar) >22 dB (total power)	>25 dB (co-polar) >22 dB (total power)	>25 dB (co-polar) >22 dB (lotal power)	:-25 dB (co-polar) :-22 dB (total power)
250 waits (at 50°C)	250 waits (et 50°C)	250 waits (at 50°C)	200 watts (et 50°C)	200 walts (et 50°C)	200 waits (et 50°C)
67° (heli-power)	66° (half-power)	64" (helf-power)	66° (half-power)	60° (half-power)	60° (half-power) .
34° (hali-power)	35° (half-power)	30° (half-power)	20° (half-power)	18° (half-power)	17.5° (half-power)

16 dB (hypical)

ANTENNA SPECIFICATIONS

Specifications:

Front-to-back ratio

Cross polar ratio Main direction

Meximum input power

SCALE: NTS

+45° and -45° polerization 94° (hali-power) vertical beamwidth

2	05/05/14	REVISED LOCATION/EQUIPMENT
1	05/09/13	REVISED PER COMMENTS
0	10/30/12	ISSUED FOR PERMIT
REV	DATE	DESCRIPTION
248200 Je 00 1888 2	STATE OF THE PARTY	NO DAOTS IN STATE OF IN

INTERNATIONAL 🍲

300 CROWN OAK CENTRE DRIVE

FL COA#:

DRAWN BY: EW CHECKED BY: JD

LONGWOOD, FL 32750

TEL: 407.260.0231

FAX: 407.260.0749

26983

ATON OF LAW FOR ANY PERSON UNLESS THEY ARE ACTING

SFL63\_2 SITE#:

421 NW 12TH STREET ADDRESS:

FORT LAUDERDALE, FL 33311

SHEET TITLE:

DETAILS

SHEET NUMBER:

C3

FINISHED GRADE, STONE, ASPHALT, CONCRETE PAVING OR SOD. MATCH SLOPE RESTORE SURFACE TO MATCH ORIGINAL CONDITION AND THICKNESS OF EXISTING SURFACE - UNDISTURBED COMPACTED BACKFILL (SUITABLE ON SITE MATERIAL) - 6" WARNING TAPE TELCO CONDUIT WHERE APPLICABLE (REFER TO NOTE 4) 6" MIN. NEW UNDERGROUND CONDUIT(S) TRENCHING DETAIL (IF APPLICABLE, REFER TO SITE PLAN) SCALE: NTS PROVIDE SCHEDULE 40 PVC CONDUIT BELOW GRADE EXCEPT AS NOTED BELOW. PROVIDE SCHEDULE 80 PVC CONDUIT AND ELBOWS AT STUB UP LOCATIONS (i.e. SERVICE POLE, BTS EQUIPMENT, ETC.). INSTALL UTILITY PULLBOXES PER NEC.


CONDUIT/TUBING CONTAINING FIBER OPTIC CABLING TO BE FILLED WITH GEL TO PREVENT WATER PENETRATION, COMMONLY REFERRED TO AS "ICKY PICK."

EXOTHERMIC WELD 2'-6" MIN. OR FROST DEPT (2) #6 AWG GROUNDING GROUND ROD (COPPERCLAD STEEL), 5/8"ø X 10'-0"

GROUND ROD DETAIL 5 SCALE: NTS

GROUND ROD TO BE DRIVEN 10' VERTICALLY.

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SHROUD KIT LOSH-BBU-1 GROUND MOUNT

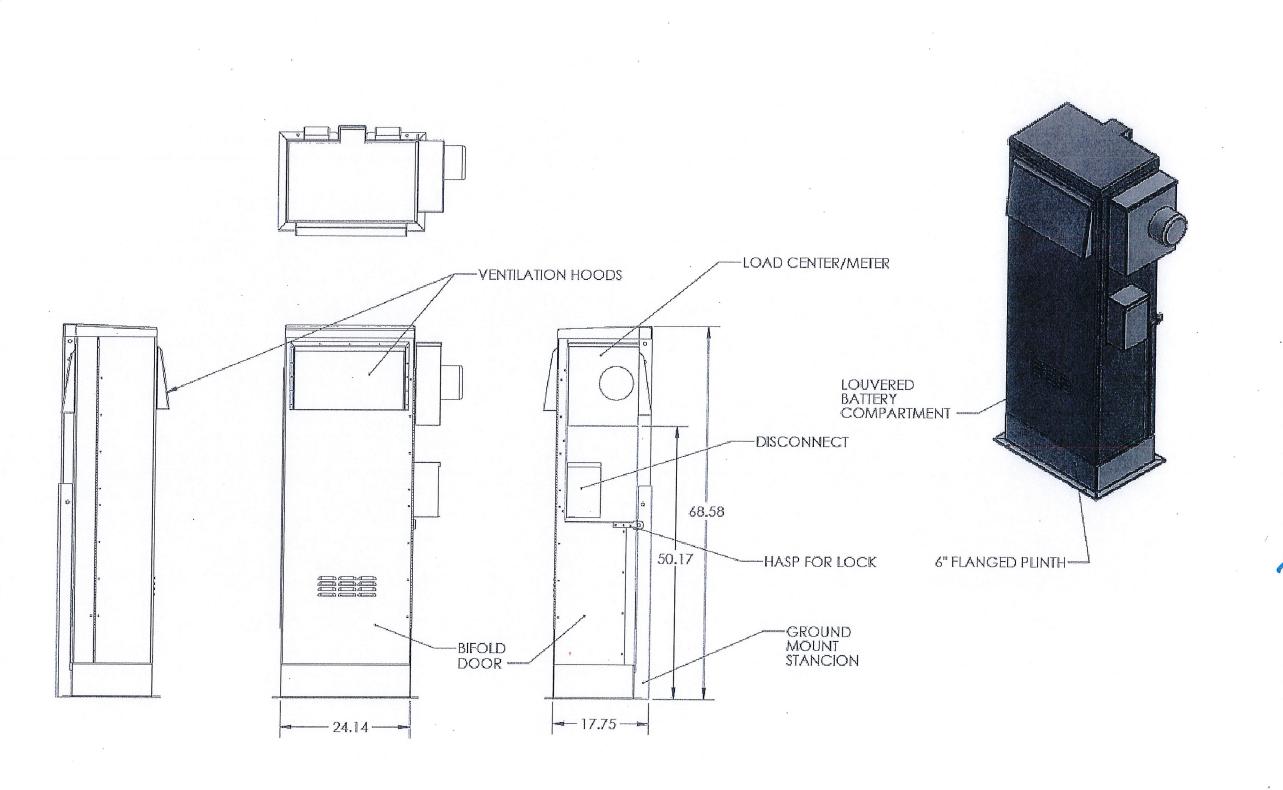SCALE: NTS

300 CROWN OAK CENTRE DRIVE LONGWOOD, FL 32750 TEL: 407.260.0231 FAX: 407.260.0749 FL COA#: 26983

DRAWN BY: EW CHECKED BY: JD 2 05/05/14 REVISED LOCATION/EQUIPMENT 1 05/09/13 REVISED PER COMMENTS 0 10/30/12 ISSUED FOR PERMIT

SFL63\_2 SITE#:

421 NW 12TH STREET FORT LAUDERDALE, FL 33311

SHEET TITLE:

DETAILS

SHEET NUMBER:

C4

Exhibit 9