
BOAT OWNERS WAREHOUSE


311 State Road 84


Fort Lauderdale, Florida

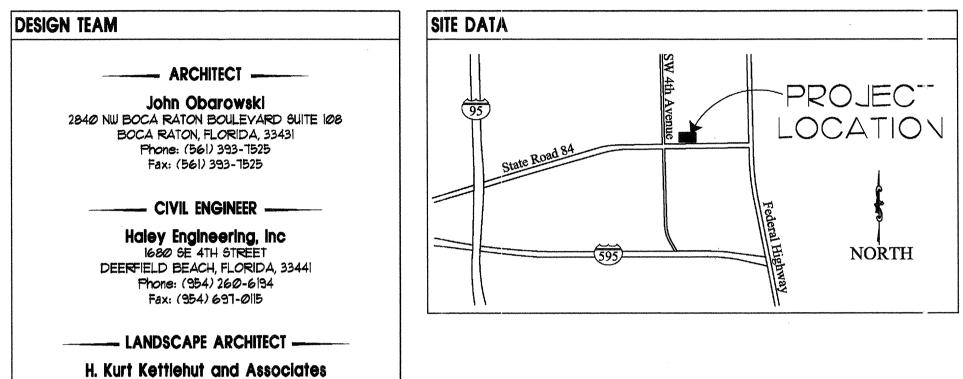


227 GOOLSBY BOULEVARD

DEERFIELD BEACH, FLORIDA, 33442 Phone: (954) 426-4305

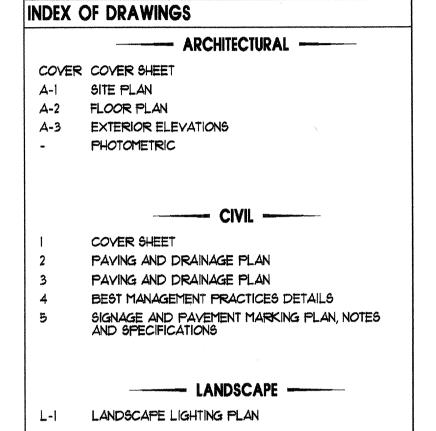

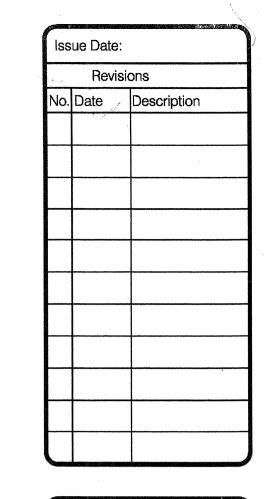

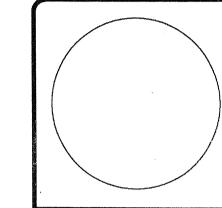

OHN OBAROWSKI - ARCHITE 340 N.W. 2nd AVENUE SUITE 1 30CA RATON, FLORIDA 334

> Boat Owners' Warehouse 311 State Road 84 Fort Lauderdale, Florida

Date
June 29, 2012

Project Number:

Designed By:

Drawn By:

Checked By:

Sheet Title:

COVET

Cover

GENERAL NOTES

A. APPLICABLE CODES

- ALL CONSTRUCTION AND MATERIALS SHALL CONFORM TO THE STANDARDS AND SPECIFICATIONS OF THE CITY, COUNTY AND STATE.
- 2. CONSTRUCTION SAFETY ALL CONSTRUCTION SHALL BE DONE IN SAFE MANNER, SPECIFICALLY, THE RULES AND REGULATIONS OF THE OCCUPATIONAL SAFETY AND HEALTH ADMINISTRATION OSHA), AND THE MANUAL OF UNIFORM TRAFFIC CONTROL DEVICES (MUTCD) SHALL
- 3. THE CONTRACTOR SHALL BE REQUIRED TO COMPLY WITH CHAPTER 90-96 OF THE LAWS OF FLORIDA (THE TRENCH SAFETY ACT) AND OSHA STANDARD 29 C.F.R. SECTION 1926.650 SUBPART P. CONTRACTOR SHALL SUBMIT WITH HIS CONTRACT A COMPLETED, SIGNED, AND NOTARIZED COPY OF THE TRENCH SAFETY ACT COMPLIANCE STATEMENT. THE CONTRACTOR SHALL ALSO SUBMIT A SEPARATE COST ITEM IDENTIFYING THE COST OF COMPLIANCE WITH
- 4. NO CONSTRUCTION MAY COMMENCE UNTIL THE APPROPRIATE PERMITS HAVE BEEN OBTAINED FROM ALL LOCAL, STATE AND FEDERAL

B. PRE CONSTRUCTION RESPONSIBILITIES

- ARRANGE A PRE CONSTRUCTION CONFERENCE TO INCLUDE ALL INVOLVED GOVERNMENTAL AGENCIES, ALL AFFECTED UTILITY
- 2. THE CONTRACTOR SHALL OBTAIN AN SUNSHINE STATE ONE CALL OF FLORIDA CERTIFICATION NUMBER AT LEAST 48 HOURS PRIOR TO
- 3. PRIOR TO BEGINNING CONSTRUCTION, THE CONTRACTOR SHALL VERIFY THE SIZE, LOCATION AND MATERIAL OF ALL EXISTING
- 4. THE CONTRACTOR SHALL BE RESPONSIBLE FOR DAMAGE TO ANY EXISTING UTILITIES FOR WHICH HE FAILS TO REQUEST LOCATIONS FROM THE UTILITY OWNER. HE IS RESPONSIBLE AS WELL FOR DAMAGE TO ANY EXISTING UTILITIES WHICH ARE PROPERLY
- 5. IF UPON EXCAVATION, AN EXISTING UTILITY IS FOUND TO BE IN CONFLICT WITH THE PROPOSED CONSTRUCTION OR TO BE OF A SIZE CONTRACTOR SHALL IMMEDIATELY NOTIFY THE ENGINEER.

1. THE OWNER, ENGINEER, AND LOCAL PERMITTING AGENCIES MAY MAKE INSPECTIONS OF THE WORK AT ANY TIME. THE CONTRACTOR SHALL COOPERATE FULLY WITH ALL INSPECTIONS.

- 1. THE CONTRACTOR SHALL SUBMIT (5) FIVE SETS OF SHOP DRAWINGS FOR APPROVAL TO THE ENGINEER OF RECORD PRIOR TO FABRICATION OR CONSTRUCTION FOR ALL MATERIALS USED ON THE PROJECT APPROVED SHOP DRAWINGS FROM THE ENGINEER SHALL THEN BE SUBMITTED BY THE CONTRACTOR TO THE COUNTY OR CITY FOR THEIR APPROVAL. NO CONSTRUCTION SHALL COMMENCE UNTIL THE APPROVED SHOP DRAWINGS HAVE BEEN OBTAINED BY THE CONTRACTOR FROM THE
- INDIVIDUAL SHOP DRAWINGS FOR ALL PRECAST STRUCTURES ARE REQUIRED. CATALOG LITERATURE WILL NOT BE ACCEPTED FOR PRECAST STRUCTURES.
- 1. TEMPORARY UTILITIES IT SHALL BE THE CONTRACTOR'S RESPONSIBILITY TO ARRANGE FOR OR SUPPLY TEMPORARY WATER SERVICE, SANITARY FACILITIES AND ELECTRICITY TO HIS EMPLOYEES AND SUBCONTRACTORS FOR THEIR USE DURING
- 2. TRAFFIC REGULATION MAINTENANCE OF TRAFFIC IN THE PUBLIC RIGHT-OF-WAY SHALL BE IN ACCORDANCE WITH THE MUTCD AND THE FDOT STANDARD SPECIFICATIONS.
- 3. ALL OPEN TRENCHES AND HOLES ADJACENT TO ROADWAYS OR WALKWAYS SHALL BE PROPERLY MARKED AND BARRICADED TO ASSURE THE SAFETY OF BOTH VEHICULAR AND PEDESTRIAN TRAFFIC. NO HOLES SHALL BE LEFT OPEN OVERNIGHT.

- I. DURING CONSTRUCTION THE PROJECT SITE AND ALL ADJACENT AREAS SHALL BE MAINTAINED IN A NEAT AND CLEAN MANNER. UPON FINAL CLEAN UP, THE PROJECT SITE SHALL BE LEFT CLEAR OF ALL SURPLUS MATERIAL OR TRASH. THE PAVED AREAS SHALL BE SWEPT
- 2. THE CONTRACTOR SHALL RESTORE OR REPLACE, WHEN AND AS DIRECTED BY THE ENGINEER ANY PUBLIC OR PRIVATE PROPERTY DAMAGED BY HIS WORK, EQUIPMENT, EMPLOYEES OR THOSE OF HIS SUBCONTRACTORS TO A CONDITION AT LEAST EQUAL TO THAT EXISTING IMMEDIATELY PRIOR TO THE BEGINNING OF OPERATIONS. TO THIS END, THE CONTRACTOR SHALL DO AS REQUIRED ALL NECESSARY HIGHWAY OR DRIVEWAY, WALK, AND LANDSCAPING WORK. SUITABLE MATERIALS AND METHODS SHALL BE USED FOR SUCH
- 3. WHERE MATERIAL OR DEBRIS HAS WASHED OR FLOWED INTO OR BEEN PLACED IN WATER COURSES, DITCHES, DRAINS, CATCH BASINS, OR ELSEWHERE AS A RESULT OF THE CONTRACTOR'S OPERATIONS, SUCH MATERIAL OR DEBRIS SHALL BE REMOVED AND SATISFACTORILY DISPOSED OF DURING PROGRESS OF THE WORK, AND THE AREA KEPT

IN A CLEAN AND NEAT CONDITION. G. PROJECT RECORD DOCUMENTS

- 1. THE CONTRACTOR SHALL MAINTAIN ACCURATE AND COMPLETE RECORDS WORK ITEMS COMPLETED. INFORMATION RELATIVE TO MANHOLES, VALVES, SERVICES, FITTINGS, LENGTH OF PIPE, INVERT ELEVATIONS, FINISHED GRADE ELEVATIONS AND THE LIKE, SHALL BE ACCURATELY RECORDED BY THE CONTRACTOR. TOP ELEVATIONS
- 2. ALL "AS-BUILT" INFORMATION SUBMITTED TO THE ENGINEER SHALL BE SUFFICIENTLY ACCURATE, CLEAR AND LEGIBLE TO SATISFY THE ENGINEER AND ANY APPLICABLE REVIEWING AGENCY THAT THE INFORMATION PROVIDES A TRUE REPRESENTATION OF THE IMPROVEMENTS
- 3. UPON COMPLETION OF CONSTRUCTION, THE CONTRACTOR SHALL SUBMIT TO THE ENGINEER OF RECORD FIVE COMPLETE SETS OF "AS-BUILT" CONSTRUCTION DRAWINGS (PRINTS) AND ONE MYLAR ORIGINAL. THESE DRAWINGS SHALL BE MARKED TO SHOW "AS-BUILT" CONSTRUCTION CHANGES AND DIMENSIONED LOCATIONS AND ELEVATIONS OF ALL IMPROVEMENTS AND SHALL BE SIGNED BY THE CONTRACTOR.
- 4. ALL "AS-BUILT" INFORMATION ON ELEVATIONS OF PAVING, DRAINAGE, WATER, AND SEWER SHALL BE CERTIFIED BY A REGISTERED LAND
- 5. IT IS THE INTENT THAT THE FLORIDA DEPARTMENT OF TRANSPORTATION "STANDARD SPECIFICATIONS FOR ROAD AND BRIDGE CONSTRUCTION: DATED 1991 TOGETHER WITH "SUPPLEMENTAL SPECIFICATIONS TO THE 1991 STANDARD SPECIFICATIONS FOR ROAD AND BRIDGE CONSTRUCTION" DATED 1991 BE USED WHERE APPLICABLE FOR THE VARIOUS WORK, AND THAT WHERE SUCH WORDING THEREIN REFERS TO THE STATE OF FLORIDA AND ITS DEPARTMENT OF TRANSPORTATION AND PERSONNEL, SUCH WORDING IS INTENDED TO BE REPLACED WITH THE WORDING WHICH WOULD PROVIDE PROPER TERMINOLOGY; THEREBY MAKING SUCH "STANDARD SPECIFICATIONS FOR ROAD AND BRIDGE CONSTRUCTION" AS THE "STANDARD SPECIFICATIONS" FOR THIS PROJECT. IF WITHIN A PARTICULAR SECTION, ANOTHER SECTION, ARTICLE OR PARAGRAPH IS REFERRED TO, IT SHALL BE PART OF THE STANDARD SPECIFICATIONS ALSO. THE CONTRACTOR SHALL ABIDE BY ALL LOCAL AND STATE LAWS, REGULATIONS AND BUILDING CODES WHICH HAVE JURISDICTION IN THE AREA.

H. EARTHWORK AND COMPACTION

- 1. ALL FILL MATERIAL IN AREAS NOT TO BE PAVED SHALL BE COMPACTED TO 95% OF THE MAXIMUM DENSITY AS DETERMINED BY AASHTO T-180. 2. A 2" BLANKET OF TOP SOIL SHALL BE PLACED OVER ALL AREAS TO BE SODDED.
- 3. SOD SHALL BE ST. AUGUSTINE, BITTER BLUE OR FLORATAM AND SHALL BE PLACED ON THE GRADED TOP SOIL AND WATERED TO INSURE SATISFACTORY CONDITION UPON FINAL ACCEPTANCE OF THE PROJECT.

I. STORM DRAINAGE

a. CONTRACTOR MAY UTILIZE ONE OF THE FOLLOWING MATERIALS.

- A. PIPE SHALL BE ALUMINUM, MANUFACTURED IN CONFORMANCE WITH ASTM B209.
- B. PIPE SHALL BE SPIRAL RIB DRAINAGE PIPE WITH 3/4" BY 3/4" RIBS, APPROXIMATELY 7-1/2" ON CENTER. GAUGE THICKNESS SHALL MEET FDOT STANDARD 945-1. C. PIPE COUPLING BANDS SHALL BE 12" WIDE STANDARD SPLIT BANDS OF THE SAME ALLOY AS THE PIPE AND MAY BE ONE GAUGE LIGHTER THAN THE PIPE.
- D. POLYURETHANE OR OTHER SEALANT SHALL BE USED WITH COUPLING BANDS ON ALL NON-PERFORATED PIPE.

2. REINFORCED CONCRETE PIPE (RCP):

- CONCRETE PIPE FOR STORM SEWERS SHALL CONFORM TO ASTM L70-79, TABLE !!!, WALL B, OR LATEST REVISION. ALL PIPE SHALL HAVE MODIFIED TONGUE AND GROOVE JOINTS, AND HAVE RUBBER GASKETS, UNLESS OTHERWISE SPECIFIED.
- A. BEDDING AND INITIAL BACKFILL OVER DRAINAGE PIPES SHALL BE SAND WITH NO
- ROCK LARGER THAN I" DIAMETER. B. BACKFILL MATERIAL UNDER PAVED AREAS SHALL BE COMPACTED TO 98% OF THE MAXIMUM DENSITY AS DETERMINED BY ASSHTO T-180.
- C. BACKFILL MATERIAL UNDER AREAS NOT TO BE PAVED SHALL BE COMPACTED TO 95% OF THE MAXIMUM DENSITY AS DETERMINED BY AASHTO T-180.
- D. CATCH BASINS SHALL BE PRECAST MINIMUM 3000 PSI CONCRETE AND GRADE 40
- A. PIPE SHALL BE PLACED ON STABLE GRANULAR MATERIAL FREE OF ROCK FORMATION OTHER FOREIGN FORMATIONS, AND CONSTRUCTED TO UNIFORM GRADE AND LINE.
- B. BACKFILL MATERIAL SHALL BE WELL GRADED GRANULAR MATERIAL WELL TAMPED IN LAYERS NOT TO EXCEED SIX INCHES (6").
- C. PROVIDE A MINIMUM PROTECTIVE COVER OF 18 INCHES OVER STORM SEWER AND AVOID UNNECESSARY CROSSING BY HEAVY CONSTRUCTION VEHICLES DURING CONSTRUCTION.
- D. THE CONTRACTOR SHALL NOTIFY THE LOCAL WATER CONTROL DISTRICT AT LEAST 24 HOURS PRIOR TO THE START OF THE CONSTRUCTION AND INSPECTION.
- 5. HDPE DRAINAGE PIPE SHALL CONFORM TO AASHTO M294, STANDARD SPECIFICATION FOR CORRUGATED POLYETHYLENE PIPE, 12" TO 36" DIAMETER, SMOOTH LINED INSIDE WALLS.
- STORM DRAINAGE PRE-TREATMENT/EXFILTRATION SYSTEM a. ANY CONFLICT WITH EXISTING OR PROPOSED UTILITIES SHALL IMMEDIATELY BE BROUGHT TO THE ATTENTION OF THE ENGINEER. ANY IMPERMEABLE MATERIAL ENCOUNTERED IN THE EXCAVATION FOR THE DRAIN FIELD SHALL BE REMOVED AS DIRECTED BY THE ENGINEER.
- b. THE TRENCH LINER SHALL BE TYPAR SPUN BONDED POLYPROPYLENE FILTER FABRIC AS MANUFACTURED BY THE DUPONT COMPANY, OR APPROVED EQUAL. IT SHALL BE USED ON THE SIDES AND TOP OF DRAIN FIELD DITCH. THE TOP SECTION OF THE MATERIAL SHALL BE LAPPED A MINIMUM OF 24 INCHES AND THE CONTRACTOR SHALL TAKE EXTREME CARE
- c. PERFORATED PIPE WITHIN THE DRAIN FIELD SHALL HAVE 3/8 INCH PERFORATIONS 360° AROUND THE PIPE WITH APPROXIMATELY 120 PERFORATIONS PER FOOT OF PIPE.
- d. PERFORATED PIPE SHALL TERMINATE FIVE FEET (5') FROM THE DRAINAGE STRUCTURE. THE REMAINING FIVE FEET (5') SHALL BE NON-PERFORATED PIPE.
- e. PIPES SHALL TERMINATE TWO FEET (2') FROM THE END OF THE TRENCH OR CONNECT TO ADDITIONAL CATCH BASINS.

PAVING

- I. ALL UNDERGROUND UTILITIES SHALL BE COMPLETED PRIOR TO THE CONSTRUCTION OF LIMEROCK BASE AND PRIOR TO PLACEMENT OF THE PAVEMENT.
- 2. ALL EXISTING PAVEMENT CUT OR DAMAGED BY CONSTRUCTION SHALL BE PROPERLY RESTORED
- 3. WHERE PROPOSED PAVEMENT IS TO BE CONNECTED TO EXISTING PAVEMENT, THE EXISTING EDGE OF PAVEMENT SHALL BE SAW CUT.
- 4. ALL STREET CORNER PAVEMENT RADII SHALL BE 25 FEET UNLESS OTHERWISE NOTED
- 5. UPON COMPLETION OF DRAINAGE IMPROVEMENTS AND LIMEROCK BASE CONSTRUCTION (AND BEFORE PLACING ASPHALT PAVEMENT) THE CONTRACTOR SHALL FURNISH THE ENGINEER OF RECORD AND THE CITY OF FT. LAUDERDALE "AS-BUILT" PLANS FOR THESE IMPROVEMENTS, SHOWING THE LOCATIONS AND THE PERTINENT GRADES OF ALL DRAINAGE INSTALLATIONS AND THE FINISHED ROCK GRADES OF THE ROAD CROWN AND EDGE OF PAVEMENT AT 50 FEET INTERVALS. THESE "AS-BUILTS" SHALL BE APPROVED BY THE CITY PRIOR TO THE PLACEMENT OF ASPHALT.

b. MATERIALS:

- 1. BASE COURSE SHALL BE CRUSHED LIMEROCK MIAMI OOLITE WITH A MINIMUM OF 70% CARBONATES OF CALCIUM AND MAGNESIUM (60% FOR LOCAL STREETS AND PARKING AREAS) AND A MINIMUM LIMEROCK BEARING RATIO 100.
- 2. PRIME COAT AND TACK COAT SHALL MEET F.D.O.T. STANDARDS. 3. SURFACE COURSE SHALL BE EQUAL TO F.D.O.T. TYPE S-3 ASPHALT.
- 4. REINFORCED CONCRETE SLABS SHALL BE CONSTRUCTED OF CLASS I CONCRETE WITH A MINIMUM STRENGTH OF 3,000 PSI AND SHALL BE REINFORCED WITH A 6" X 6" NO. 6 GAUGE WIRE MESH.
- 1. LIMEROCK BASE MATERIAL SHALL BE 6 INCHES THICK AND SHALL BE COMPACTED TO 98% OF THE MAXIMUM DENSITY AS DETERMINED BY AASHTO T80-C.
- 2. LIMEROCK BASE MATERIAL SHALL BE PLACED IN MAXIMUM 6" LIFTS. BASES GREATER THAN 6" SHALL BE PLACED IN TWO OR MORE EQUAL LIFTS.
- 3. ASPHALTIC CONCRETE SHALL BE A MINIMUM OF I" THICK.
- 4. PRIME COAT SHALL BE PLACED ON ALL LIMEROCK BASES IN ACCORDANCE WITH F.D.O.T. STANDARDS. 5. TACK COAT SHALL BE PLACED AS REQUIRED IN ACCORDANCE WITH F.D.O.T. STANDARDS.
- d. TESTING: ALL SUBGRADE, LIMEROCK AND ASPHALT TESTS REQUIRED SHALL BE TAKEN AT THE DIRECTION OF THE ENGINEER AND/OR THE CITY OF FT. LAUDERDALE.
- 1. THE FINISHED SURFACE OF THE BASE COURSE AND THAT OF THE WEARING SURFACE SHALL NOT VARY MORE THAN 1/4" FROM THE TEMPLATE. ANY IRREGULARITIES EXCEEDING THIS LIMIT SHALL BE CORRECTED.
- 2. DENSITY TESTS SHALL BE TAKEN BY AN INDEPENDENT TESTING LABORATORY, CERTIFIED BY THE STATE OF FLORIDA, AND TAKEN AS DIRECTED BY THE ENGINEER AND THE CITY OF FT. LAUDERDALE.
- ALL TESTING COSTS (PAVING) SHALL BE PAID FOR BY THE OWNER EXCEPT THOSE TESTS FAILING TO MEET THE SPECIFIED REQUIREMENTS, WHICH ARE TO BE PAID BY THE


SIGNAGE AND PAVEMENT MARKINGS

- 1. THE ROADS AND PARKING AREAS SHALL BE STRIPED IN ACCORDANCE WITH THE PLANS, NO STRIPE SHALL BE LESS THAN THE SPECIFIED WIDTH NOR SHALL IT EXCEED THE SPECIFIED WIDTH BY MORE THAN 1/2 INCH. STRIPING SHALL BE IN ACCORDANCE WITH SECTIONS 710 971 OF THE STANDARD SPECIFICATIONS. ALL STRIPPING WITHIN THE PUBLIC RIGHT-OF-WAY AND AT DRIVEWAY ACCESS POINTS SHALL BE THERMOPLASTIC IN ACCORDANCE WITH THE STANDARD SPECIFICATIONS.
- 2. IT SHALL BE THE SOLE RESPONSIBILITY OF THE CONTRACTOR TO INSTALL AND MAINTAIN ADEQUATE TRAFFIC CONTROL DEVICES, WARNING DEVICES AND BARRIERS FOR THE PURPOSE OF PROTECTING THE TRAVELING PUBLIC, HIS WORKMEN AND THE WORK AREA IN GENERAL. SUCH TRAFFIC CONTROL SHALL BE MAINTAINED FOR THE DURATION OF THE PROJECT PERIOD, INCLUDING ANY TEMPORARY SUSPENSIONS OF THE WORK. MAINTENANCE OF TRAFFIC SHALL BE IN ACCORDANCE WITH SECTION 102 OF THE STANDARD SPECIFICATIONS AND THE STATE OF FLORIDA, MANUAL OF TRAFFIC CONTROL AND SAFE PRACTICES FOR STREET AND HIGHWAY CONSTRUCTION, MAINTENANCE AND UTILITY OPERATIONS.
- 3. ALL PAVEMENT MARKINGS ON-SITE SHALL BE THERMOPLASTIC UNLESS
- 4. ALL SIGNING AND MARKINGS SHALL CONFORM TO MUTCD AND COUNTY TRAFFIC ENGINEERING STANDARDS (LATEST EDITION).

FLORIDA BUILDING CODE 2001 - FLORIDA

ACCESSIBILITY CODE - CHAPTER I

- 11-4.29.2 DETECTABLE WARNINGS ON WALKING SURFAC
- 1. ALL DETECTABLE WARNING SURFACES REQUIRED BY THE CODE SHALL BE GOVERNED BY THE REQUIREMENTS OF AMERICAN NATIONAL STANDARDS
- 2. DETECTABLE WARNING TEXTURES ON WALKING SURFACES SHALL CONSIST OF EXPOSED AGGREGATE CONCRETE, CUSHIONED SURFACES MADE OF RUBBER OR PLASTIC, RAISED STRIPS, OR GROOVES. TEXTURES SHALL CONTRAST WITH THAT OF THE SURROUNDING SURFACE. RAISED STRIOS OR GROOVES SHALL COMPLY WITH FIGURE 40(a) AND (b). GROOVES MAY BE USED INDOORS ONL
- 1. PARKED VEHICLE OVERHANGS SHALL NOT REDUCE THE CLEAR WIDTH OF AN ACCESSIBLE ROUTE, PARKING SPACES AND ACCESS AISLES SHALL BE LEVEL SURFACE SLOPES NOT EXCEEDING 1:50 (2%) IN ALL DIRECTIONS.

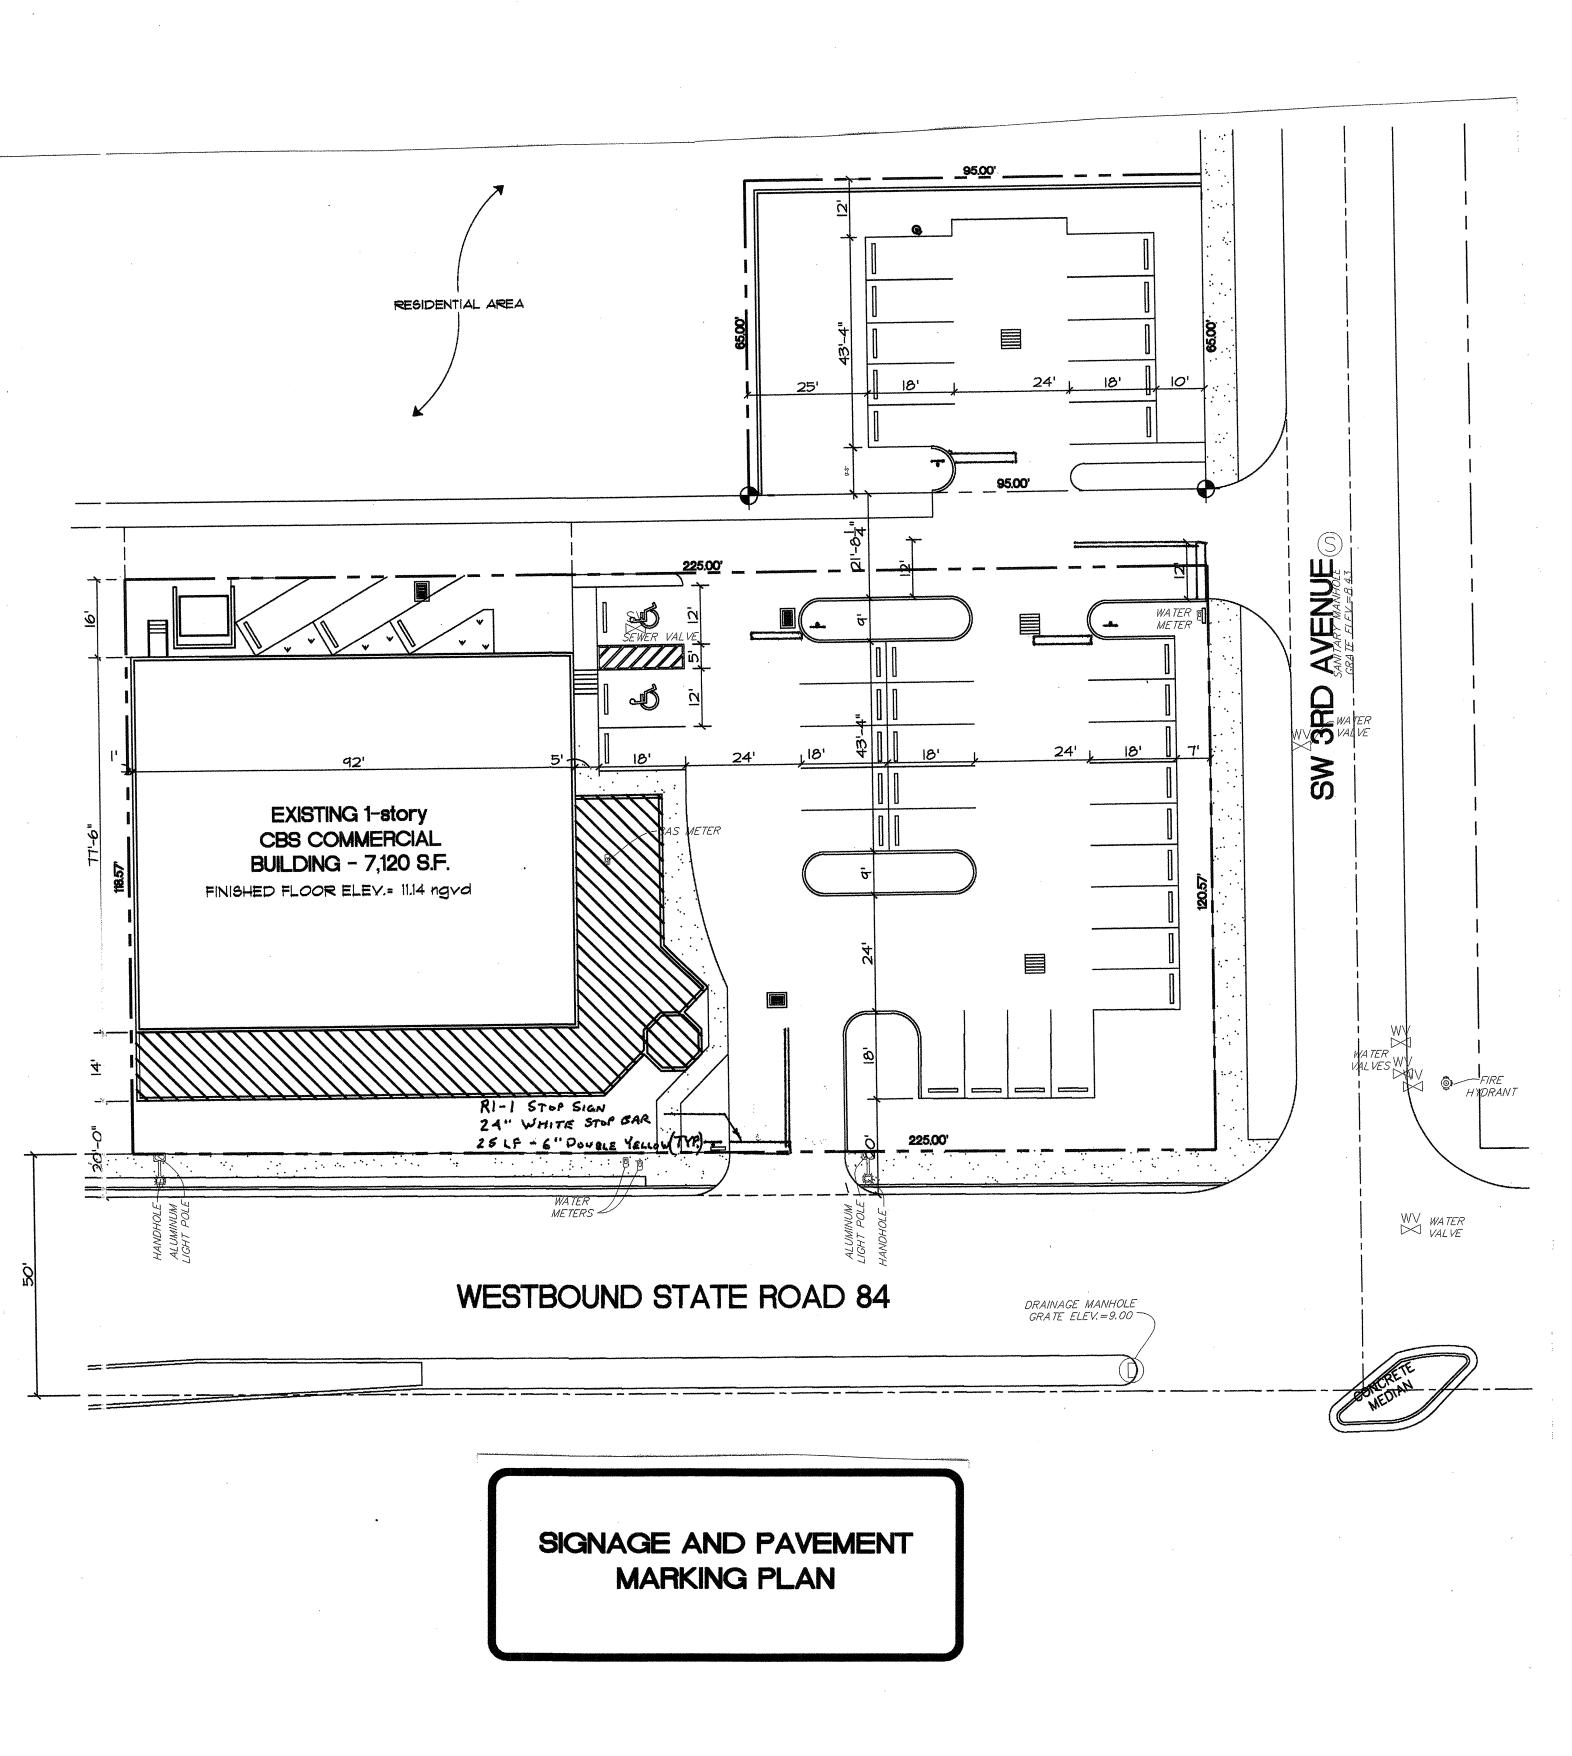

Checked J.J.H DATE REVISION

HALEY ENGINEERING, INC. CIVIL ENGINEERING SERVICES.

1680 SE 4th Street - Deerfield Beach, Fla. 33441 Phone (954) 260-6194 - Fax (954) 697-0115 F.B.P.E. Authorization No. 9463


BOAT OWNERS WAREHOUSE 311 STATE ROAD 84 FT. LAUDERDALE, FLORIDA

NOTES and SPECIFICATIONS

APPROVED DATE: 6/29/12 John M. Haley, P.E. REGISTERED ENGINEER NO. 40023 STATE OF FLORIDA

NUMBER

/12-1784

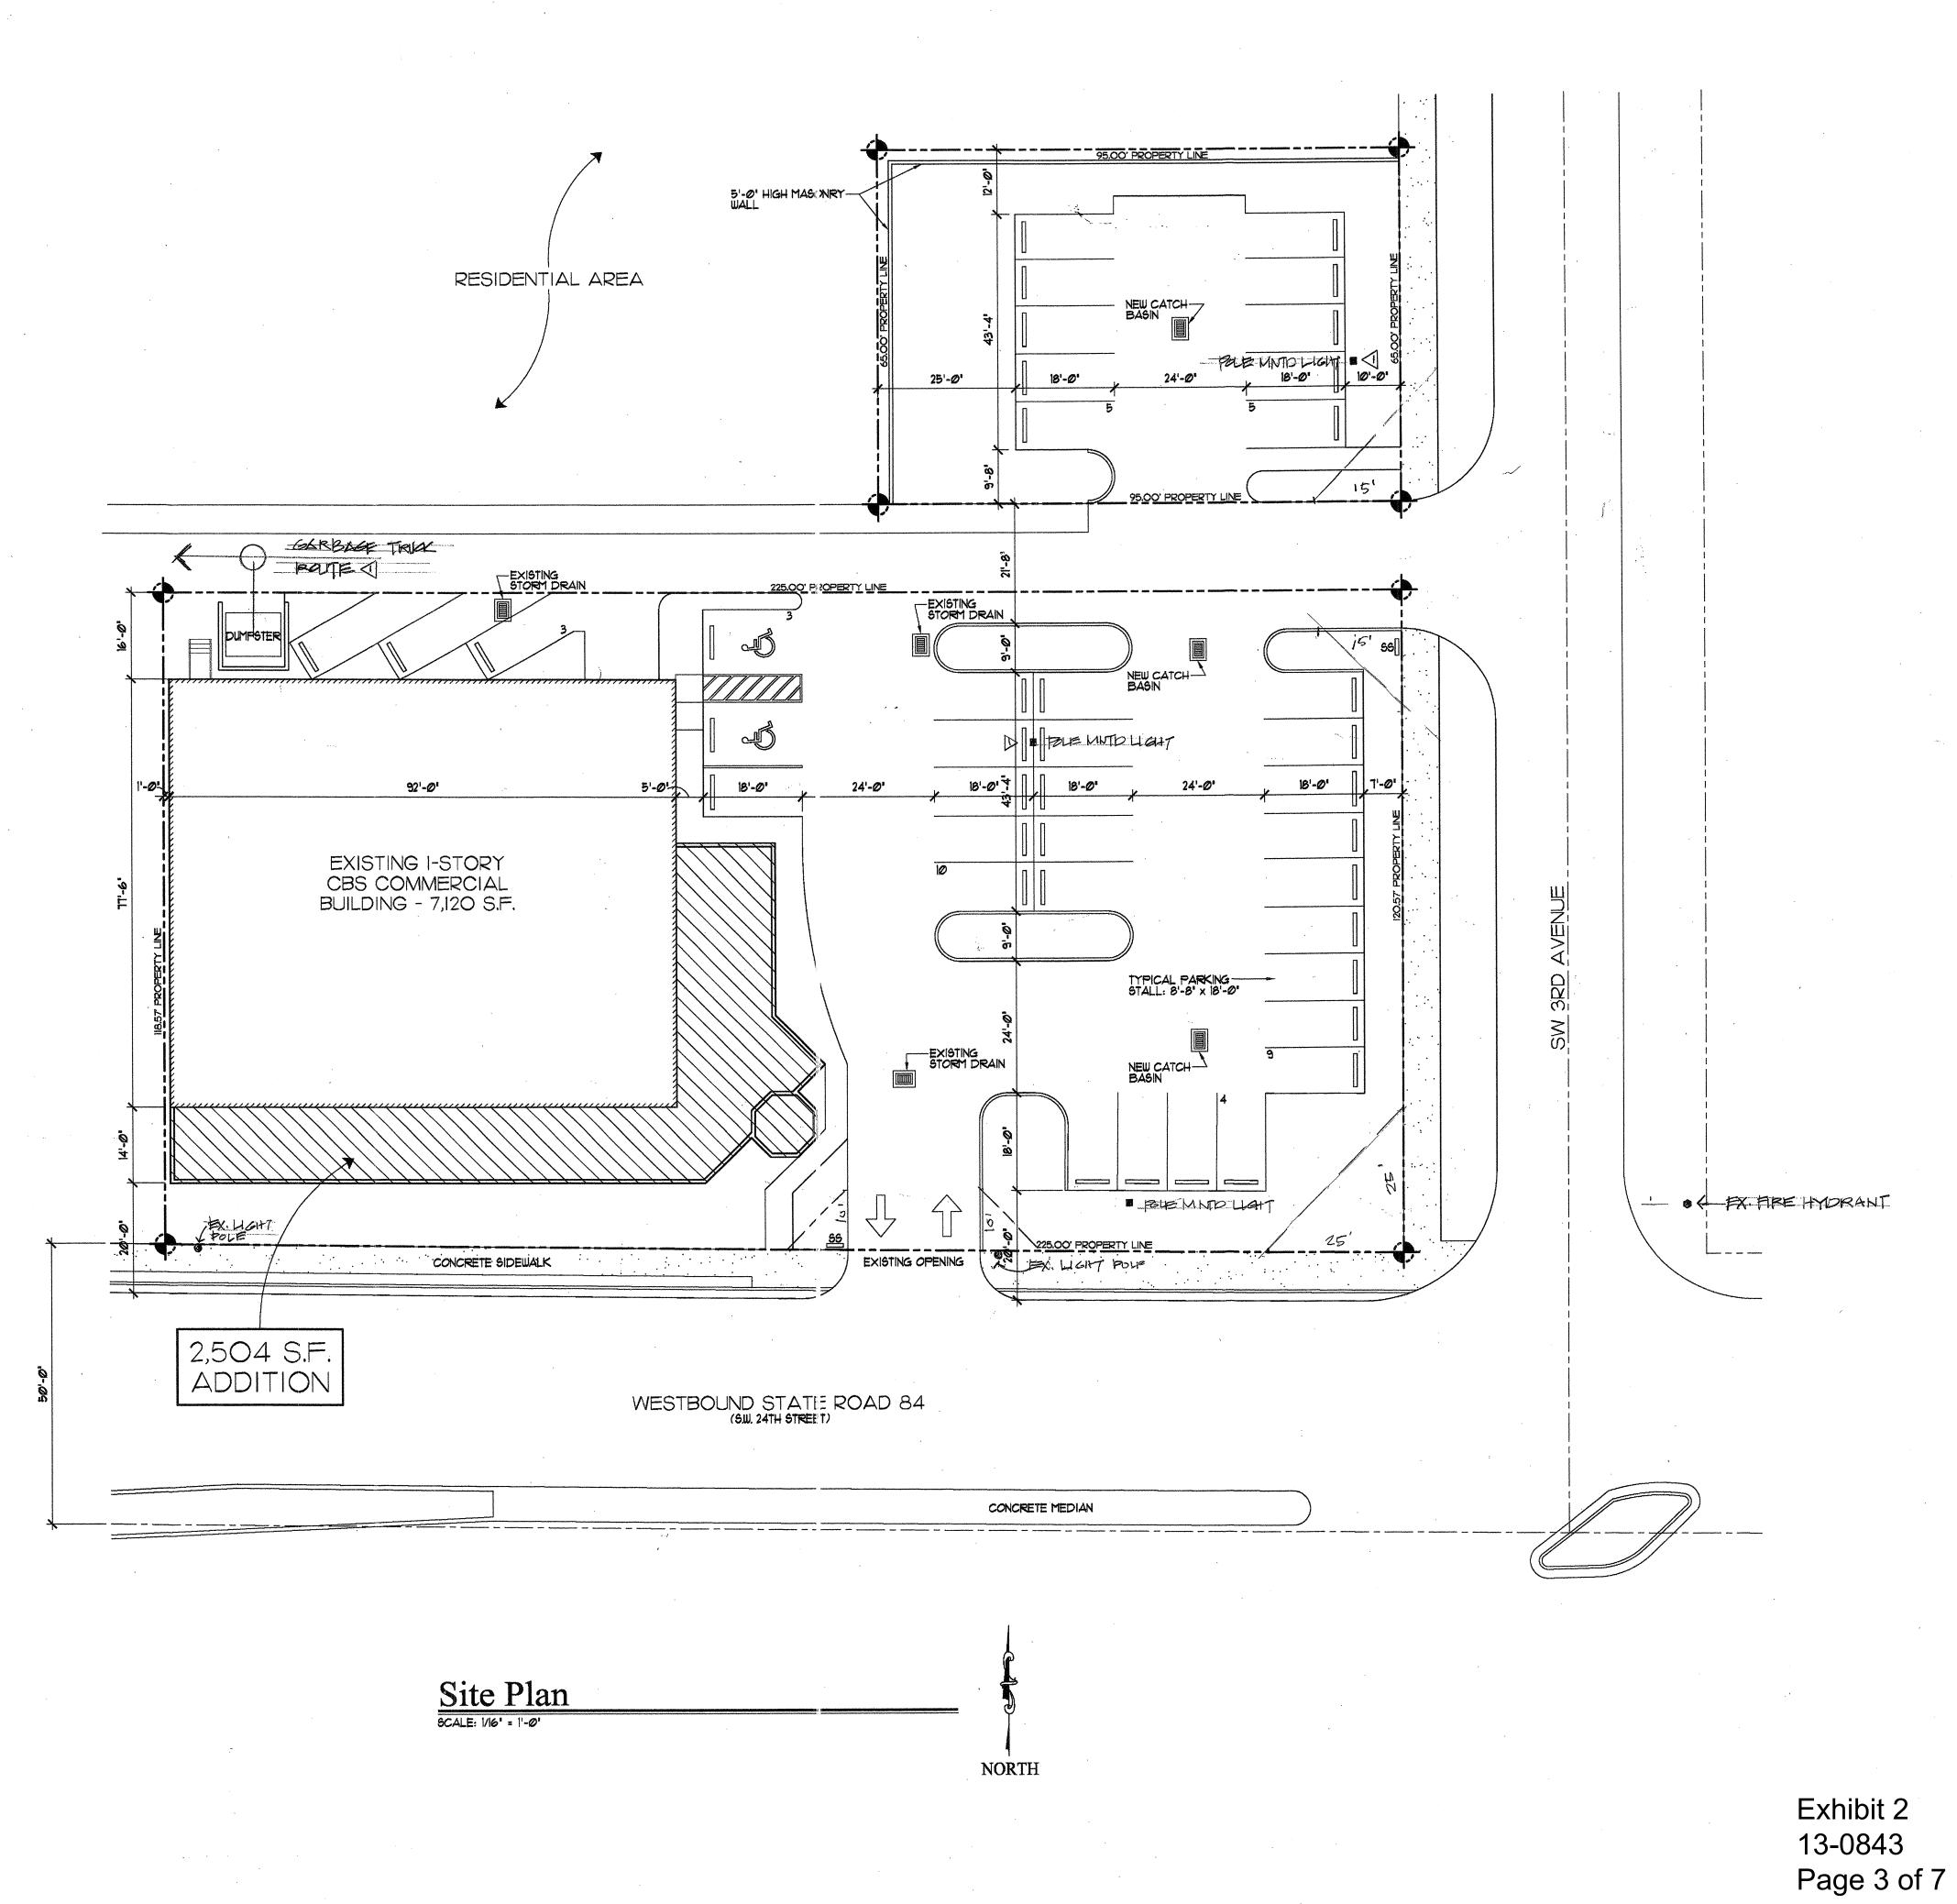

SITE DATA

SITE DATA

ZONING: B-1 RETAIL PARKING: 39 TOTAL SPACES AREA: 1,120 S.F. EXISTING + 2,510 S.F. ADDITION 9,690 S.F. TOTAL

TOTAL LOT AREA: 33,078 SF.
OPEN AREA: 23,526 SF. = 71,1%
GREEN AREA: 7,295 SF. = +/-22,1%
BUILDING COVERAGE: 9,552 SF. = 28,9%

PROJECT

NORTH

Issue Date:

Revisions

No. Date Description

DIGHTS CARRACE PATH

STATE OF THE PATH

REVISIONS

NO. Date Description

DIGHTS CARRACE PATH

STATE OF THE PATH


REVISIONS

NO. Date Description

DIGHTS CARRACE PATH

REVISIONS

NO. Date Description

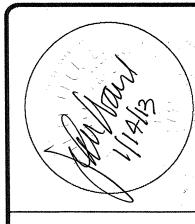

2nd AVENUE SUITE 108
TON, FLORIDA 33431
561-393-7525

Boat Owners' Warehouse 311 State Road 84 Fort Lauderdale, Florida


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February 8, 20||
Project Number:

Designed By:

Drawn By:

Checked By:


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Revisions
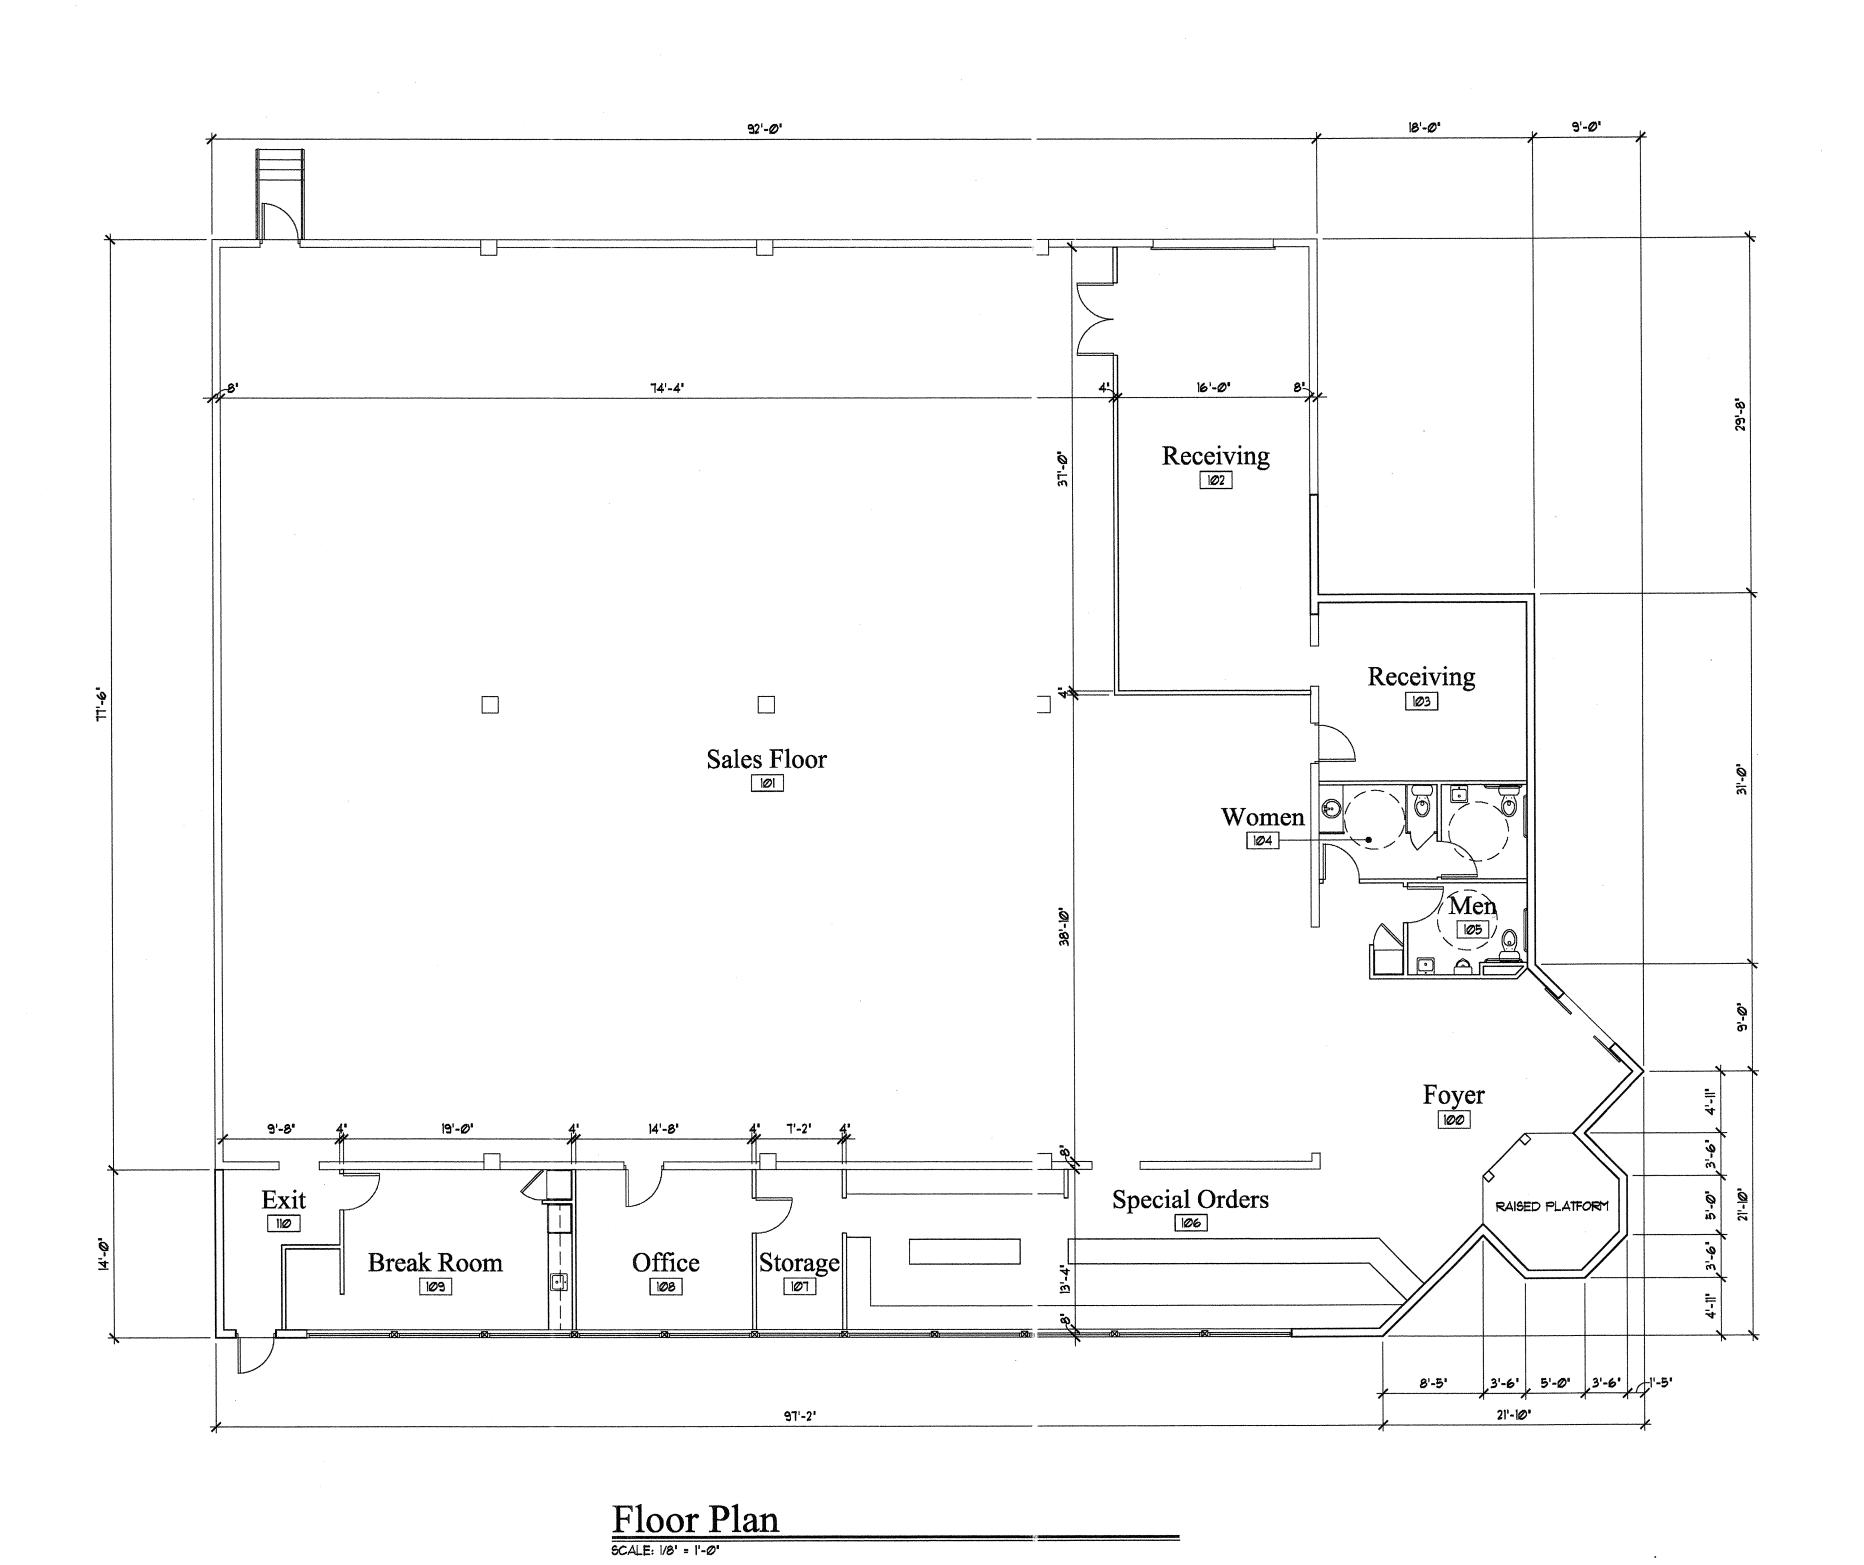
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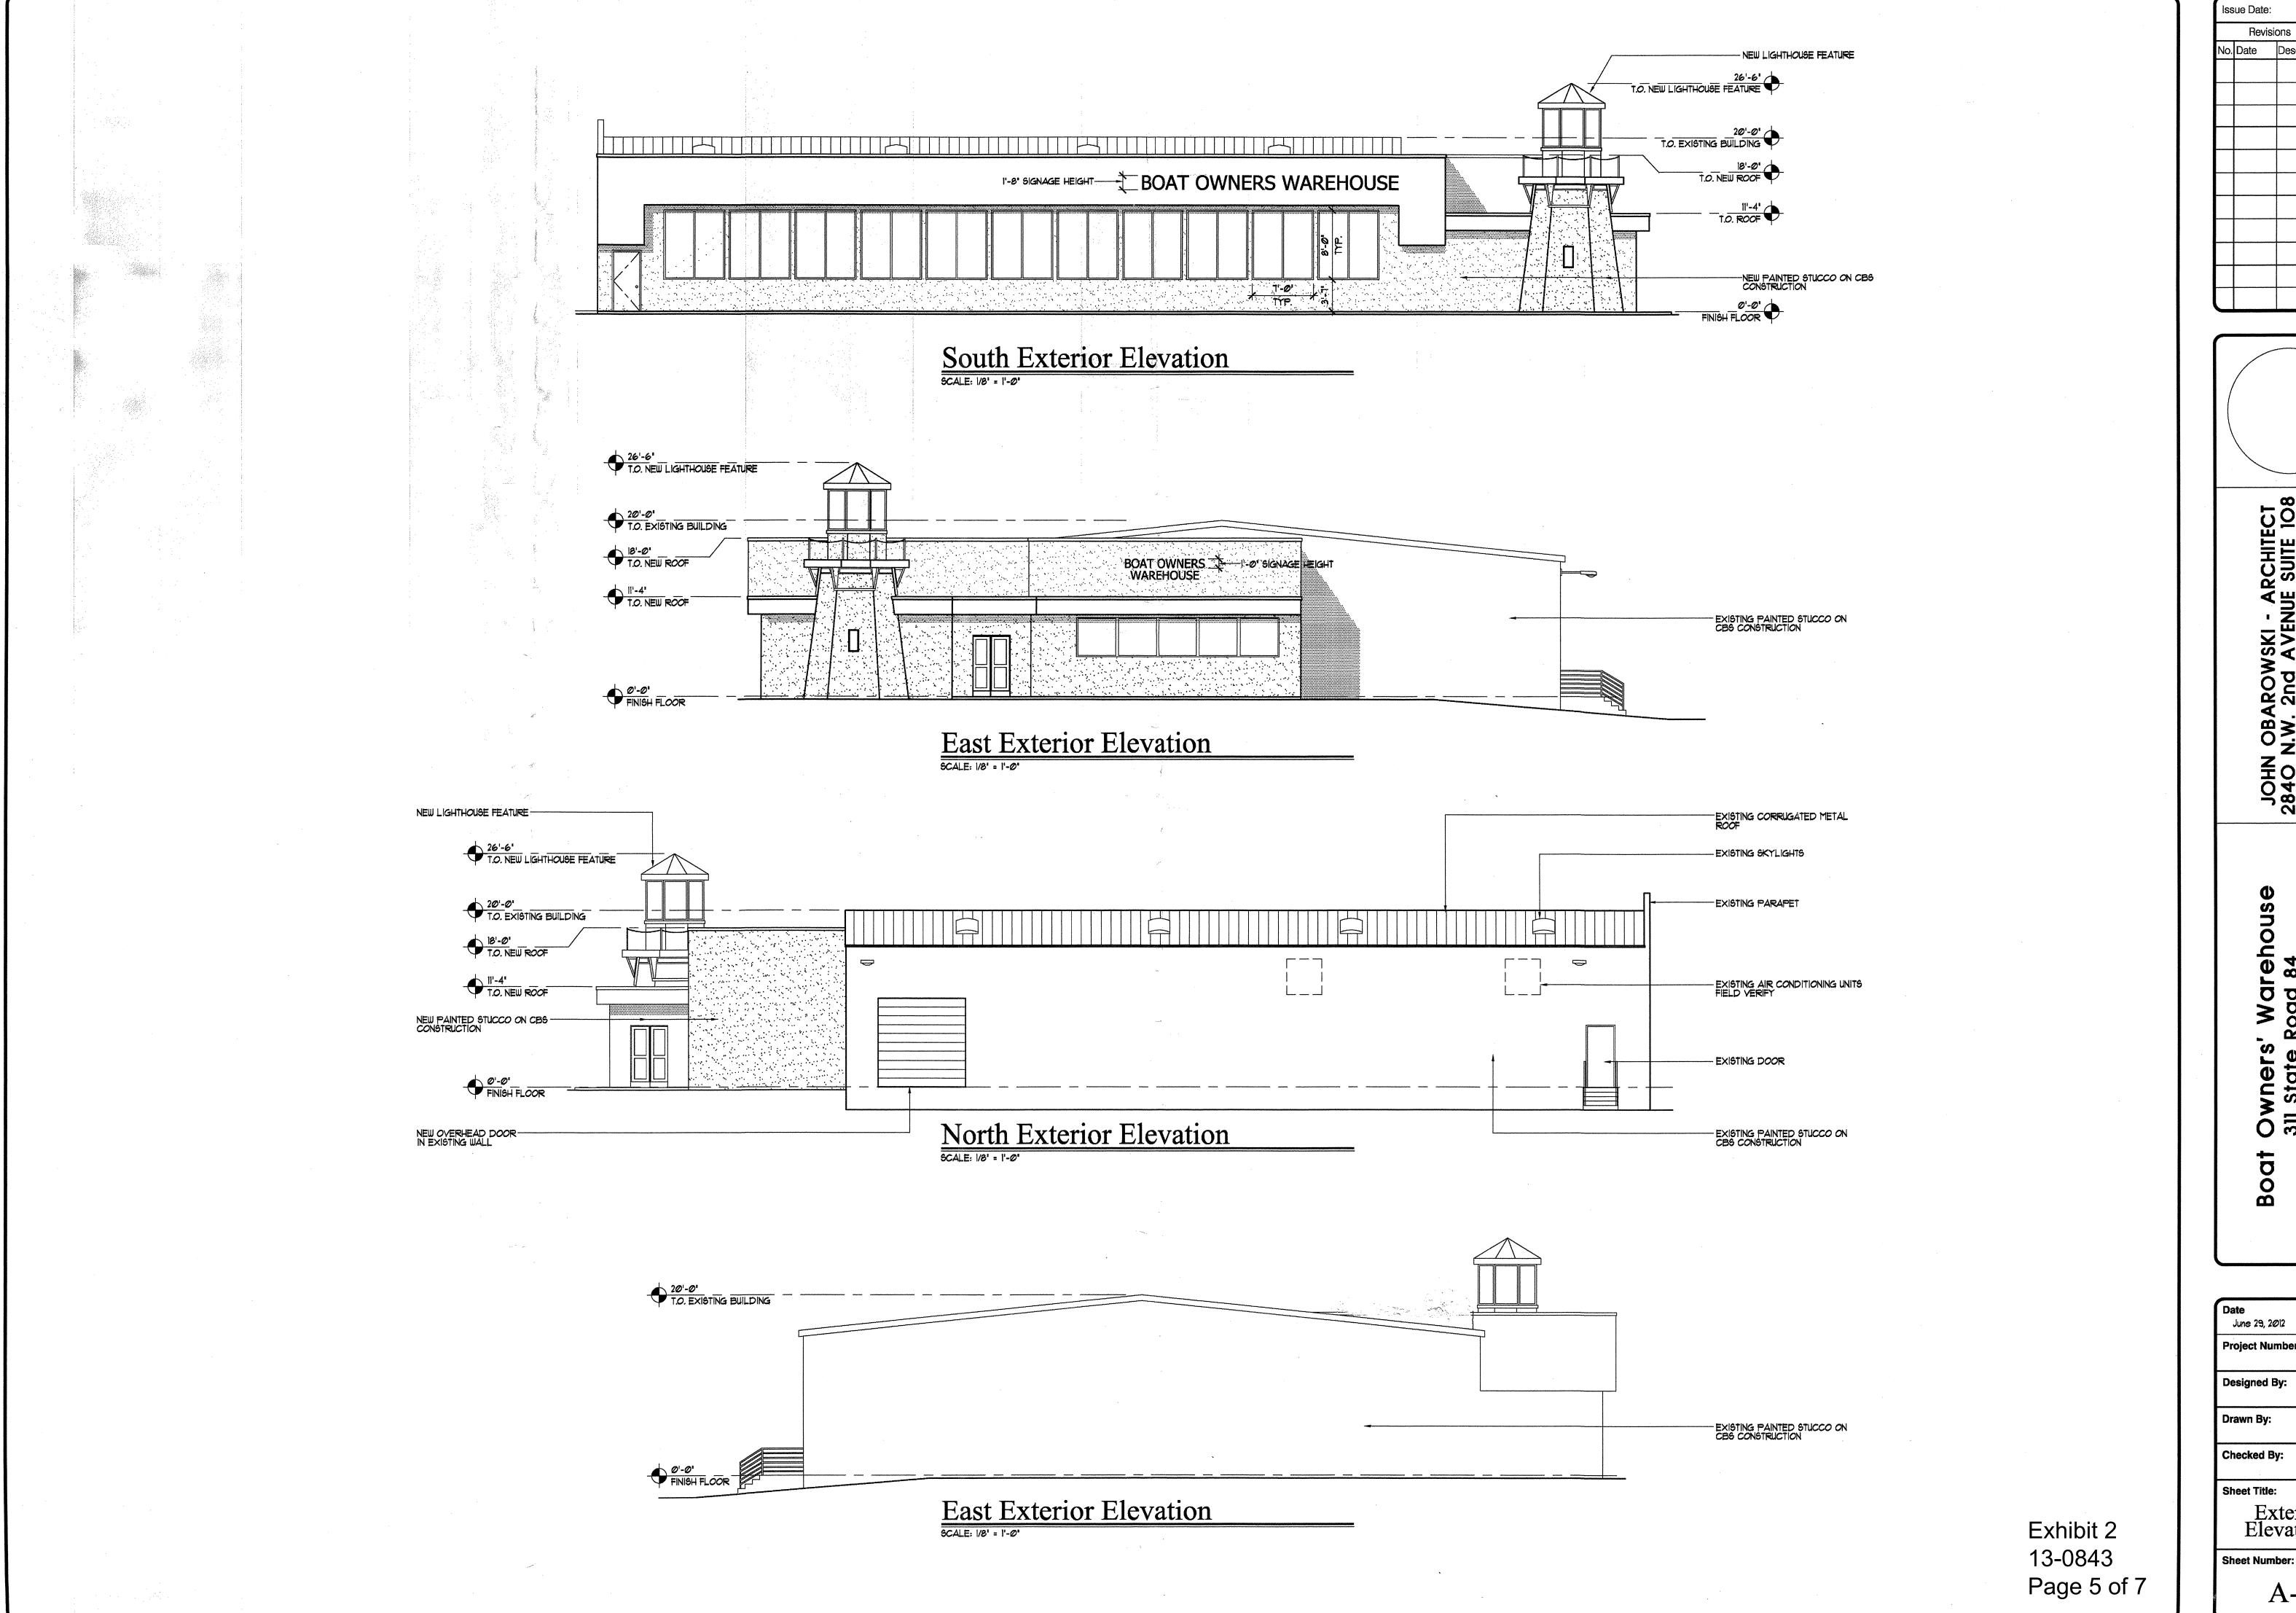


JOHN OBAROWSKI - ARCHITECT 2840 N.W. 2nd AVENUE SUITE 10 BOCA RATON, FLORIDA 33431 561-393-7525


> Boat Owners' Warehouse 311 State Road 84 Fort Lauderdale, Florida

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Exhibit 2 13-0843 Page 4 of 7

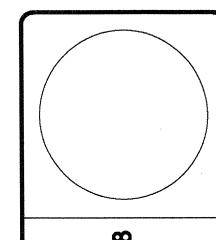

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	Revisions				
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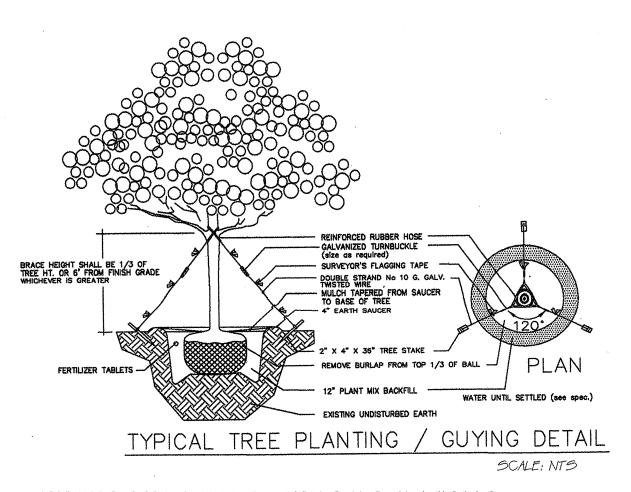
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Owner 311 State rt Laude


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erior itions

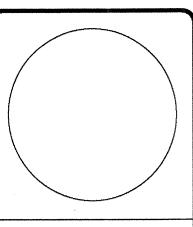A-3



BRACE ME SHT SHALL BE 1/3 OF TREE HE R B' FROM FINISH GRADE WHICHESER IS GREATER TYPICAL TREE PLANTING / STAKING DETAIL SCALE: NTS

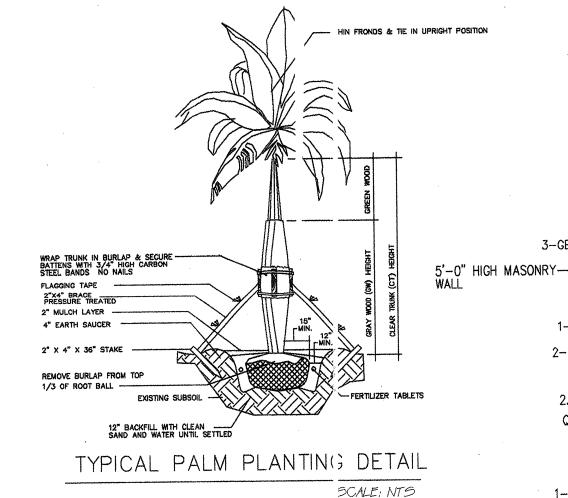

RESIDENTIA_ AREA

SW 23rd St.

E 24TH ST.

STF TE ROAD # 84

NOT TO SCALE)


- 9" PREPARED PLANTING SOIL BACKFILL AND WATER UNTIL SETTLED

EXISTING UNDISTURBED SOIL

SCALE: NTS

TYPICAL SHRUB/GROUNDCOVER PLANTING DETAIL

WOOD POLE-3.4'W. & 0.4'S.

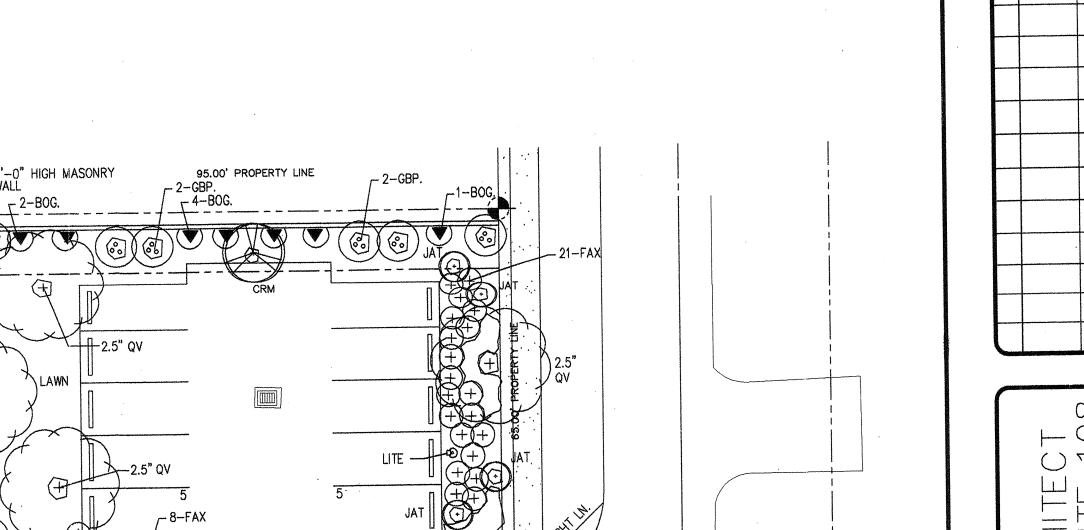



CALCULATION	REQUIRED	
NET LOT AREA TREES 1 PER 1,000 S.F. 9,243 S.F.NET LOT AR.	= 9	= 9
V.U.A. LANDSCAPE AREA = 9,640 S.F. (20% OF GROSS V.U.A.)	= 1,928 S.F.	
PERIMETER LANDSCAPE AREA 317 LIN. FT. @ 10' AVERAGE	= 3,170 S.F.	
INTERIOR LANDSCAPE AREA 30 SF. PER INTERIOR SPACE X 12	= 360 S.F.	
V.U.A. TOTAL TREES = 9,640 S.F. 1 PER 1,000 S.F.	= 10	= 10
STREET TREES 118 LIN. FT. DUTSIDE VUA PERIMETER 200 LIN. FT. TOTAL	= 7	= 7
RES. BUFFER YARDS = 1,500 S.F. 1 PER 300 S.F.	= 5	= 5
TOTAL TREES	= 31	= 31
V.U.A. TOTAL SHRUBS = 9,640 S.F. 6 PER 1,000 S.F.	= 58	= 218
V.U.A. SHADE TREES 3" CAL.	= 3	= 3
V.U.A. SHADE TREES 2- 3" CAL.	= 2	= 2
V.U.A. FLOWERING TREES	= 5	= 2
V.U.A. PALM TREES	= 2	= 2
V.U.A. OPTIONAL TREES	= 1	= 1
STREET SHADE TREES	. = 7	= 7
RES. BUFFER YARDS	= 5	= 5

PROPOSED LANDSCAPE PLANT LIST QUERCUS VIRGINIANA, LIVE DAK

SHRUB & GROUNDCOVER PLANT LIST

4'HT.X 3'SPR.


21 STELITZIA NICOLAI, GIANT BIRD OF PARADISE 6' HT. X 4' SPR. 15 GAL.

18" OA. 3 GAL. CAN,

1,200 S.F. ST. AGUSTINE BITTERBLUE SOLID SOD

GENERAL NOTES:

- I. SEE ARCHITECTURAL SITE PLAN FOR ALL SITE DIMENSIONS
- EXISTING IRRIGATION TO BE UP-GRADED TO PROVIDE 100% COVERAGE TO NEW LANDSCAPE PLANTINGS, SEE PROPOSED IRRIGATION PLANS
- IRRIGATION LAYOUT TO BE ADJUSTED TO FIELD CONDITIONS
- 4. ALL PLANT MATERIAL SHALL BE FLORIDA NO.1 OR BETTER.
- ALL PLANT MATERIAL SHALL BE INSTALLED IN ACCORDANCE WITH GOOD NURSELY PRACTICES.
- THE ZONING OF ALL ADJACENT PROPERTIES IS COMMERCIAL
- SEE ENG. PLANS FOR LOCATION OF ALL UTILITY LINES
- ALL EXISTING TREES ARE SHOWN ON THE LANDSCAPE PLAN
- PRIOR TO COMMENCEMENT OF ANY EXCAVATION, THE CONTRACTOR SHALL COMP_Y WITH FLORIDA STATUTE 553.851 "PROTECTION OF UNDERGROUND GAS PIPELINES."
- NO CONSTRUCTION SHALL COMMENCE UNTIL ALL REQUIRED PERMITS AND APPRIVALS HAVE BEEN SECURED AND THE CONTRACTOR IS ISSUED A NOTICE TO PROCEED.
- 11. ALL VEGETATION DEBRIS, CONCRETE OR OTHER UNSUITABLE MATERIAL SHALL BE DISPOSED OF BY THE CONTRACTOR, IN OFF-SITE AREAS PROVIDED BY HIM.
- 12. THE CONTRACTOR SHALL COMPLY WITH ALL STATE AND LOCAL WATER QUALITY STANDARDS.
- 13. THE LOCATION OF UTILITIES SHOWN ON PLANS ARE APPROXIMATE ONLY. THE EXACT LOCATION SHALL BE DETERMINED BY THE CONTRACTOR AND THE UTILITY OWNER, EXPOSING THE SUBJECT FACILITY SHOULD SUCH ACTION BE DEEMED NECESSARY. THE APPROPRIATE UTILITY COMPANIES SHALL BE NOTIFIED 48 HOURS IN ADVANCE BY THE CONTRACTOR.
- 14. UTILITY OWNERS ARE:
- FLORIDA POWER AND LIGHT (ELECTRIC) SOUTHERN BELL TELEPHONE AND TELEGRAPH COMPANY
- 15. THE CONTRACTOR SHALL CALL U.N.C.L.E. 1-800-432-4770 (TOLL FREE) 48 HOURS BEFORE DIGGING FOR FIELD LOCATIONS OF UNDERGROUND UTILITIES.
- 16. THE CONTRACTOR SHALL EXERCISE EXTREME CAUTION IN AREAS OF BURIED UTILITY CABLES, SANITARY LINES, AND WATER LINES.
- 17. CAUTION SHOULD BE EXERCISED WHILE WORKING IN OR AROUND OVERHEAD
 TRANSMISSION LINES, NEAR EXISTING GROUND MOUNTED AND OVERHEAD SIGNS TO
 PREVENT UNNECESSARY DAMAGE. SIGNS AND STRUCTURES SHALL BE REPLACED BY THE CONTRACTOR AT HIS EXPENSE IF ANY ARE DAMAGED BEYOND USE, AS DETERMINED BY
- 18. ALL PLANT MATERIAL SHALL BE INSTALLED A MINIMUM OF TEN FEET (10') FROM OVERHEAD ANY UNDERGROUND UTILITIES AND NO LESS THAN TWENTY FEET (20') FROM OVERHEAD LINES AND UTILITIES, UNLESS APPROVED BY THE ENGINEER. IF THE INSTALLATION OF ANY PLANT MATERIAL DAMAGES ANY EXISTING UTILITIES, THE CONTRACT OF SHALL DEPOSITE OF THE PROPERTY BE RESPONSIBLE FOR THE REPAIR OF ALL DAMAGE RESULTING FROM THE PLANTING OPERATION.
- 19. WHENEVER THE PLANT MATERIAL AND UTILITIES ARE IN CONFLICT, THE CONTRACTOR SHALL NOTIFY THE ENGINEER IN ORDER TO FIELD ADJUST THE PLACEMENT OF THE PLANT MATERIAL.

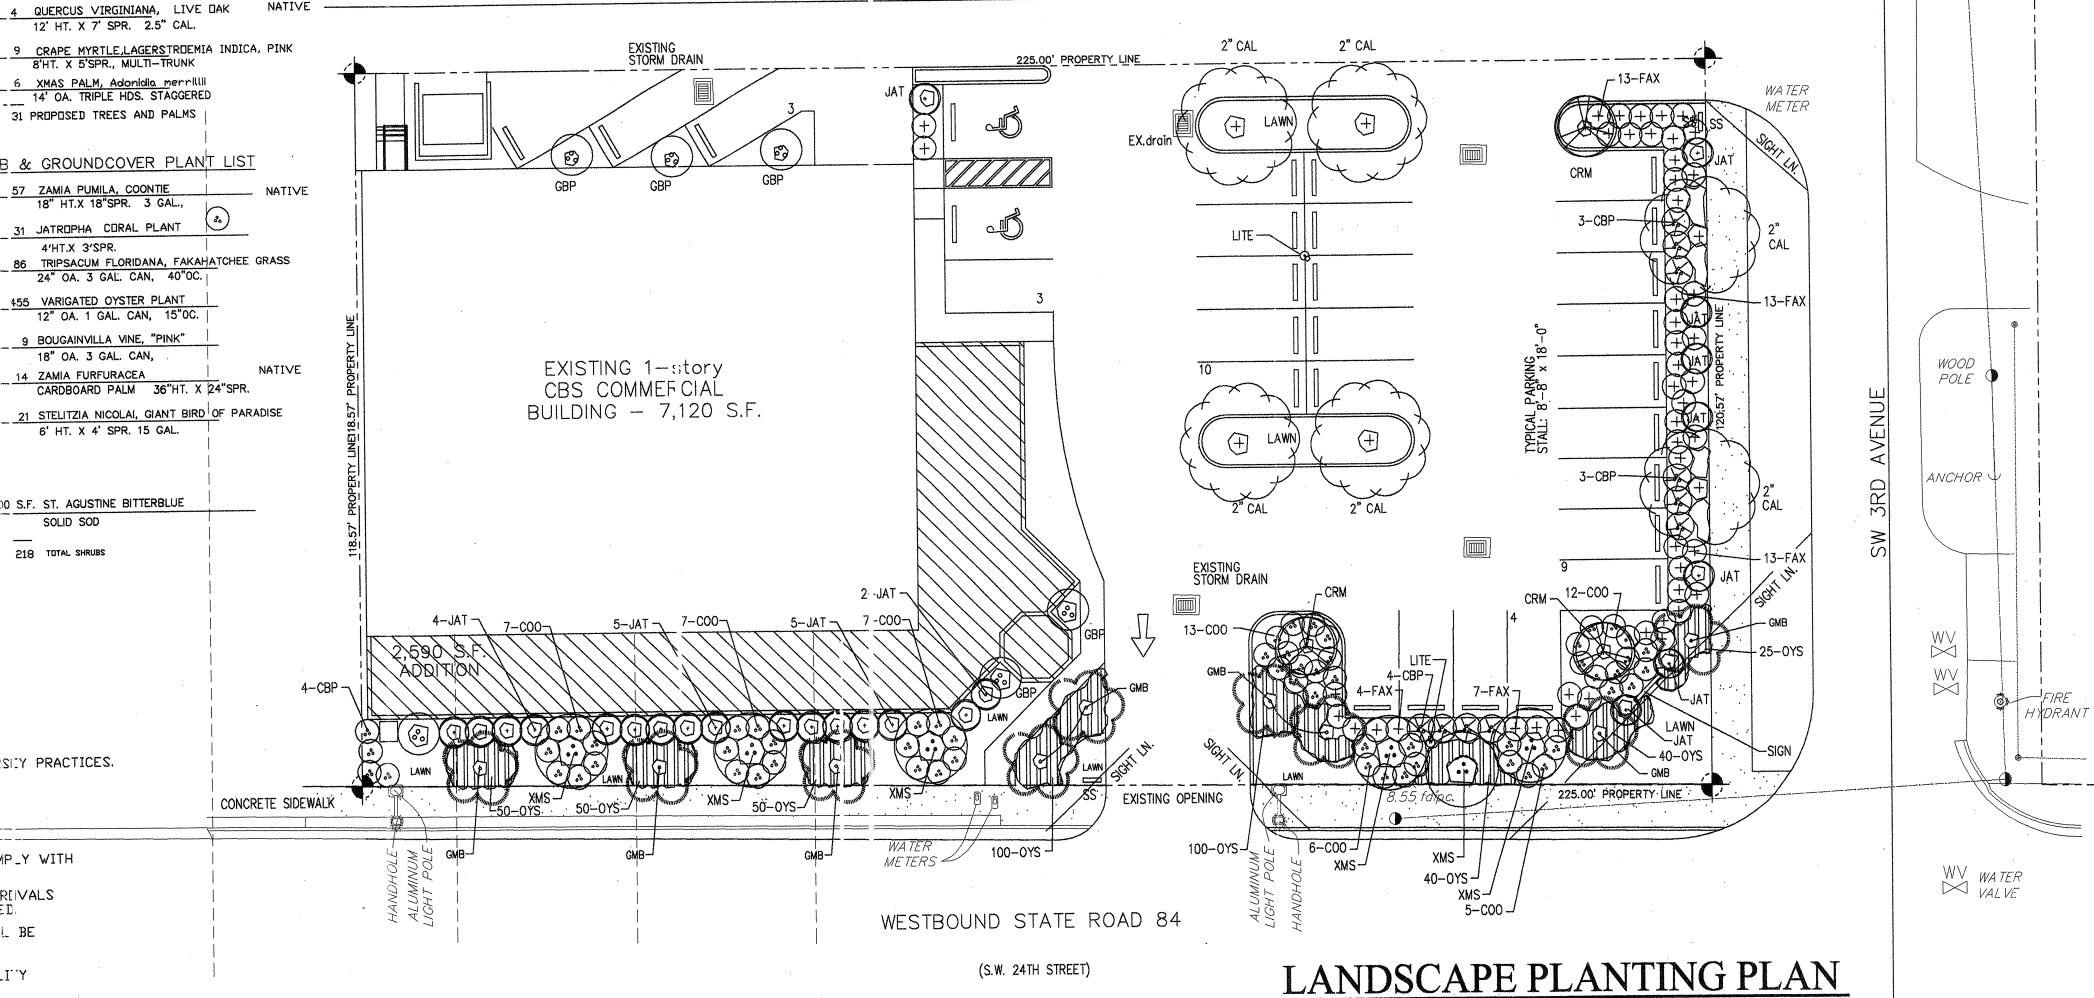

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Issue Date:

WOOD POLE

WOOD LIGHT POLE

Revisions No. Date Description


JAN. 10, 2013 Project Number: Designed By: HKK. RLA Drawn By: HKK. RLA Checked By: HKK. RLA, LCS Sheet Title: LANDSCAPE PLANTING PLAN **Sheet Number:** SH. NO.

SCALE: 1/16" = 1'-0"CONCRETE MEDIAN SITE DATA PROJECT SITE DATA LOCATION ZONING: B-1 RETAIL PARKING: 39 TOTAL SPACES
AREA: 7,120 S.F. EXISTING + 2492 S.F. ADDITION
9,612 S.F. TOTAL TOTAL LOT AREA: 33,078 S.F.
OPEN AREA: 23,466 S.F. = 70.7%
GREEN AREA: 7,705 S.F. = +/-21.8%
BUILDING COVERAGE: 9,612 S.F. = 29.3%

LANDSCAPE ARCHITECTURE SITE PLANN Page 6 Of 227 Goolsby Blvd. Deerfield Beach, Fl. 33442, 954 426-4305 SHEET NO. 1 OF 1

GRAPHIC SCALE

1 inch = 16 ft.

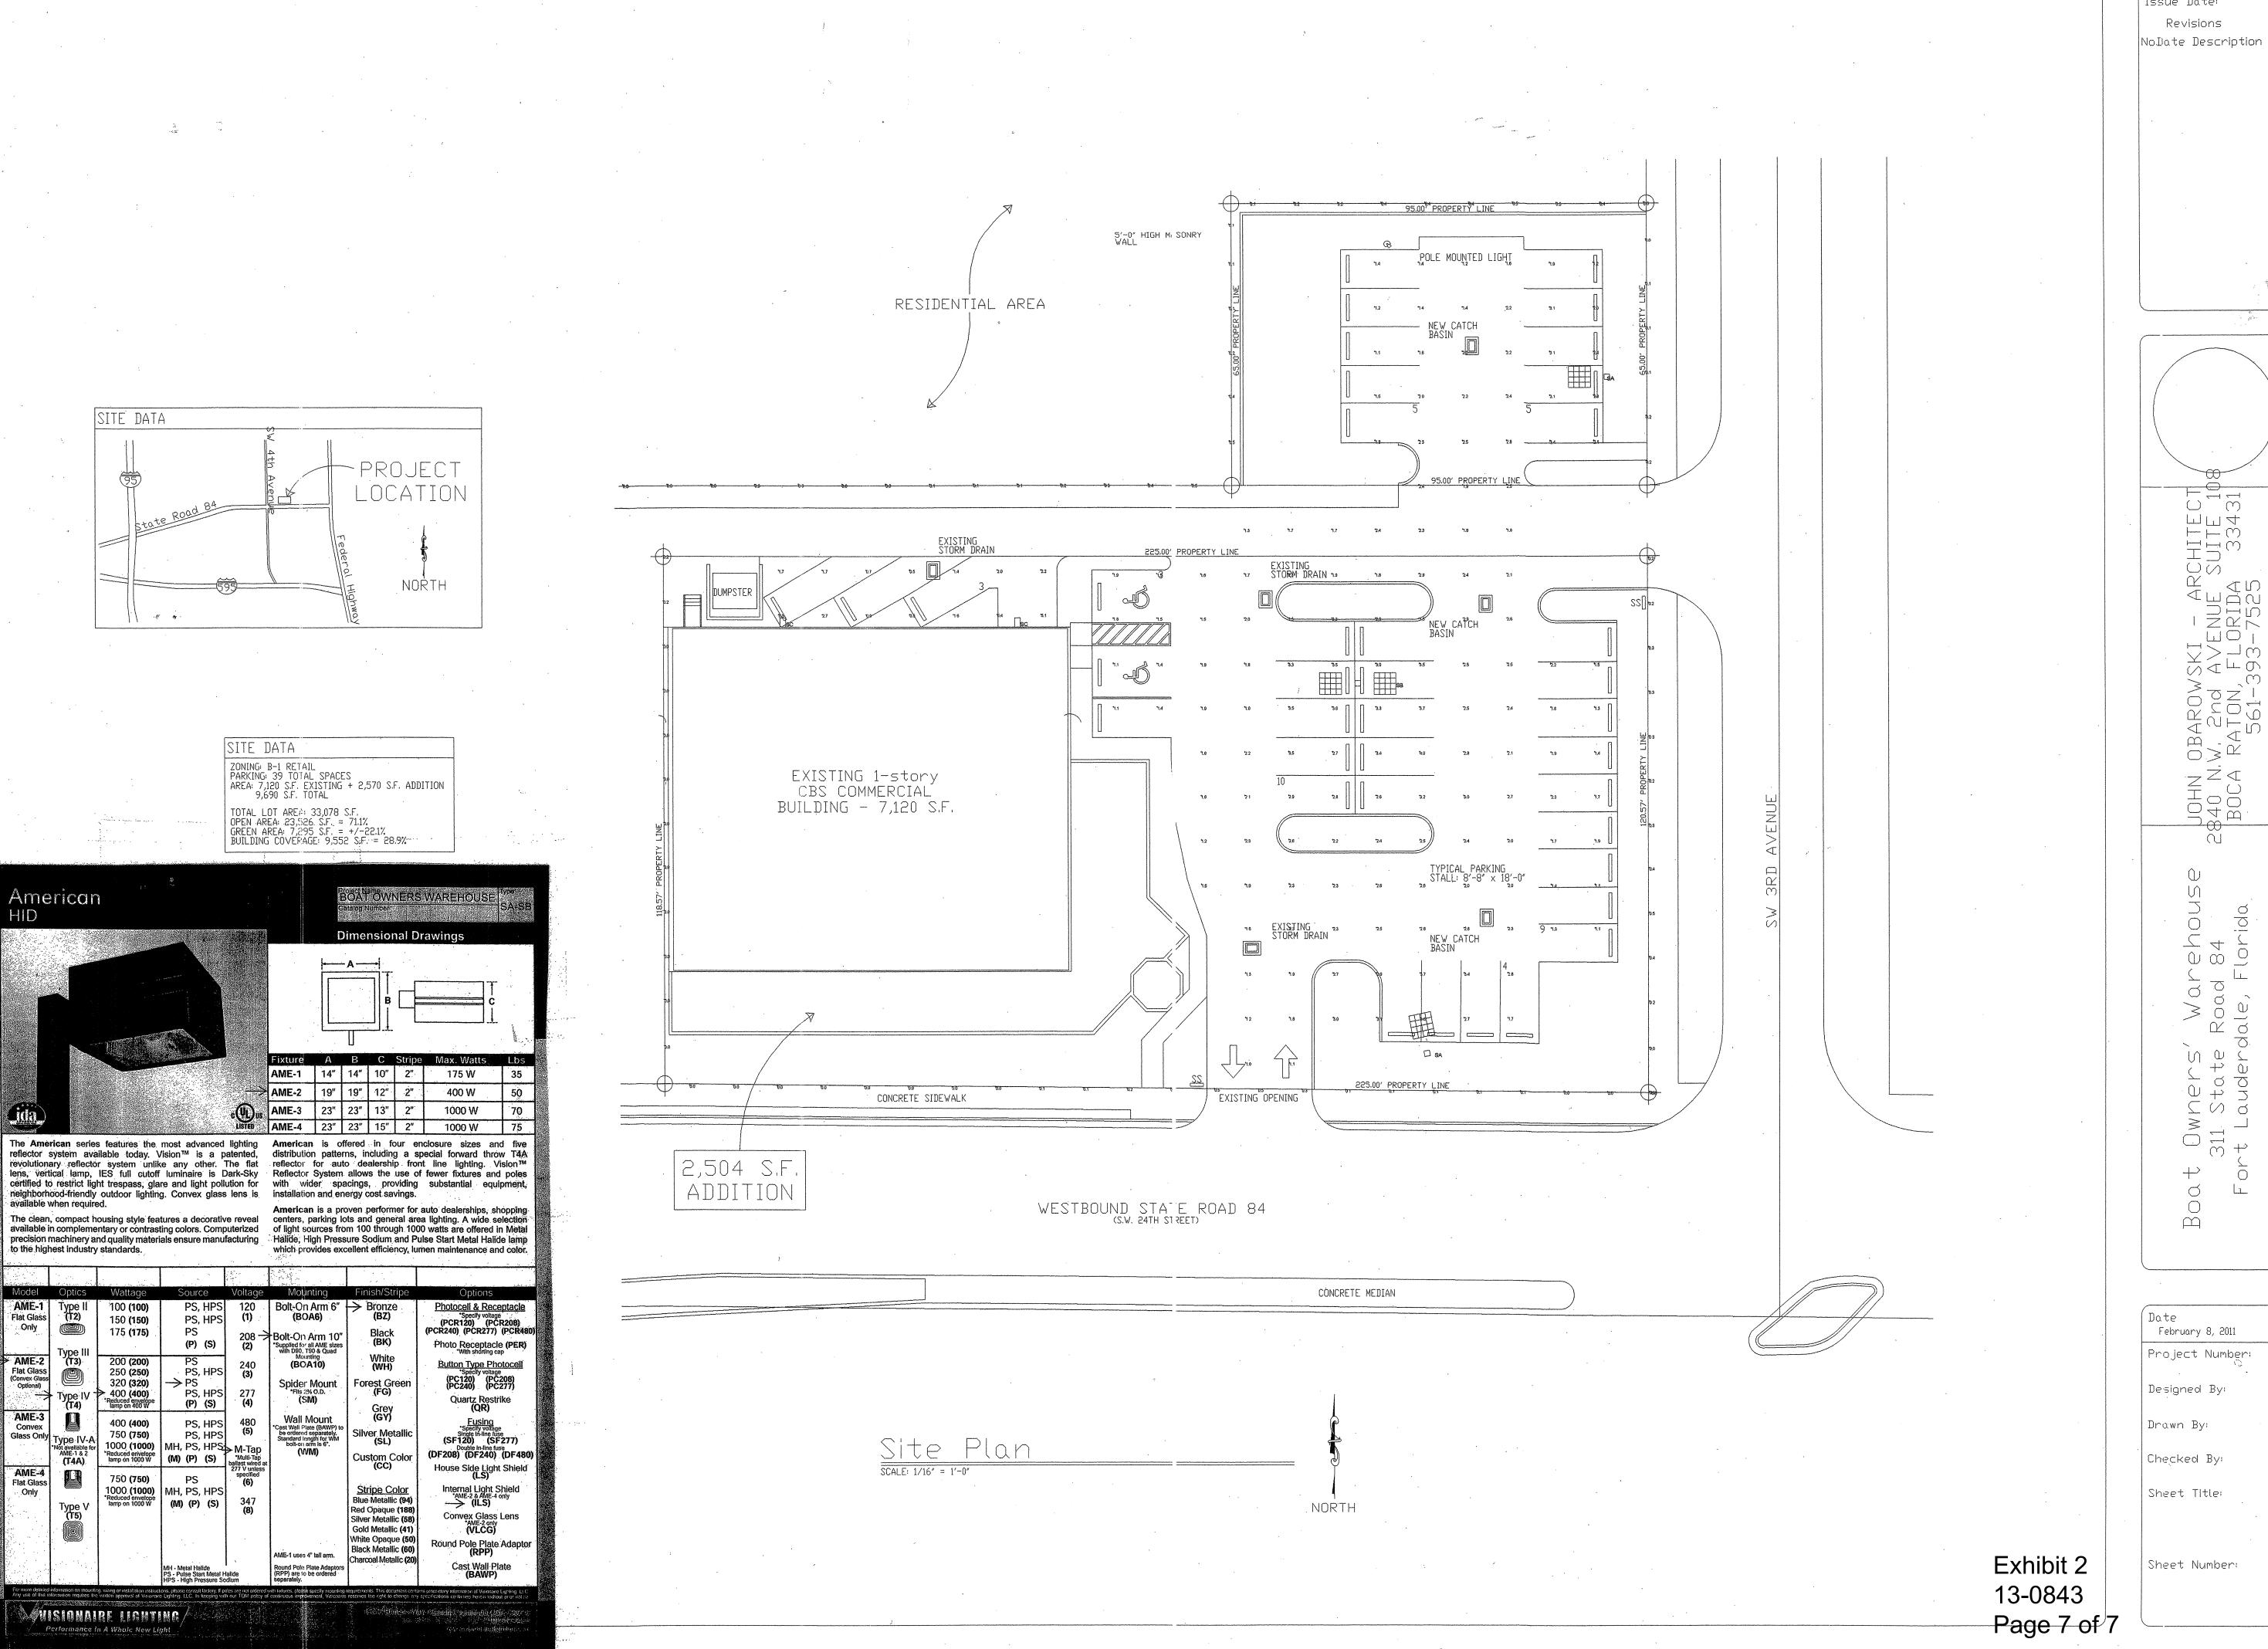

SITE DATA

American

TOTAL LOT AREA: 33,078 S.F.

OPEN AREA: 23,526 S.F. = 71.1%

GREEN AREA: 7,295 S.F. = +/-22.1%

BUILDING COVERAGE: 9,552 S.F. = 28.9%

Dimensional Drawings

AME-1 14" 14" 10" 2" 175 W

400 W

1000 W

AME-2 19" 19" 12" 2"

AME-3 23" 23" 13" 2"

Bolt-On Arm 6" Bronze (BZ)

Forest Green (FG)

Custom Color (CC)

Stripe Color Blue Metallic (94) Red Opaque (188) Silver Metallic (58)

Gold Metallic (41) White Opaque (50)

Black Metallic (60)

Charcoal Metallic (20)

208 Bolt-On Arm 10"
(2) "Supplied for all AME sizes with D90, T90 & Quad Mounting (BOA10)

Spider Mount *Fils :2% O.D. (SM)

Wall Mount
*Cast Wali Plate (BAWP) to
be ordered separately.
Standard length for WM
boll-on aim is 6".
(WM)

PS, HPS PS

PS, HPS PS, HPS

347 (8)

400 (400)
750 (750)
PS, HPS
1000 (1000)
Reduced envelope lamp on 1000 W
(M) (P) (S)
PS
1000 (1000)
Reduced envelope lamp on 1000 W
(M) (P) (S)
PS
1000 (1000)
PS
1000 (1000

1000 (1000)
Reduced envelope lamp on 1000 W

MH, PS, HPS
(M) (P) (S)

150 **(150)**

175 (1**75**)

400 (400)

WISIONAIRE LIGHTING/

Performance in A Whole New Light

AME-2
Flat Glass (Convex Glass Optional)

Type IV

(T4)

250
320 (320)
400 (400)
Reduced envelope lamp on 400 W

AME-3
Convex
Glass Only
Type-IV-A
Not available for
AME-1 & 2
(T4A)

10
Reduceo
lamp on 1

AME-4 Flat Glass

Issue Date: