650 NORTH ANDREWS - MIXED-USE

ADDRESS: 650 NORTH ANDREWS AVENUE, FORT LAUDERDALE, FLORIDA 33311

PROJECT NUMBER: 22-855

DATE: **10-10-2024**

ISSUE FOR: **DEVELOPMENT REVIEW COMMITTEE**







22-855

OWNER / DEVELOPER

BAM PROPERTY DEVELOPMENT LLC 1044 BROADWAY, WOODMERE, NY 11598

STEPHANIE J. TOOTHAKER, ESQ. 401 EAST LAS OLAS BOULEVARD, SUITE 130-154 FORT LAUDERDALE, FLORIDA 33301





ARCHITECT

IDEA ARCHITECT 3323 NE 163RD ST. SUITE 200 NORTH MIAMI BEACH, FL 33160

FLYNN ENGINEERING 241 COMMERCIAL BLVD, LAUDERDALE-BY-THE-SEA, FL 33333 954.522.1004





LANDSCAPE

ARCHITECTURAL ALLIANCE LANDSCAPE 612 SW 4TH AVENUE, FORT LAUDERDALE, FL 33315 954.764.8858


TRAFFIC ENGINEER


DC ENGINEERS, INC. 12743 NW 13TH COURT, CORAL SPRINGS, FL 33071 954.798.0926




SURVEY MCLAUGHLIN ENGINEERING CO. 1700 NW 64TH ST, SUITE 400 FORT LAUDERDALE, FL 33309 954.763.7611

COMCAST	ATAT
FP&L	TECO
CITY OF FORT	LAUDERDALE

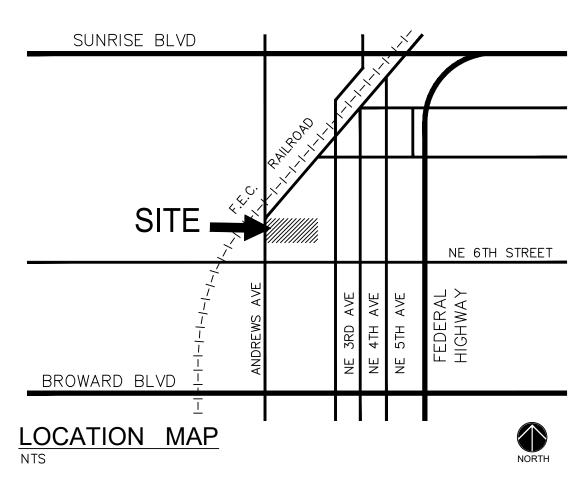

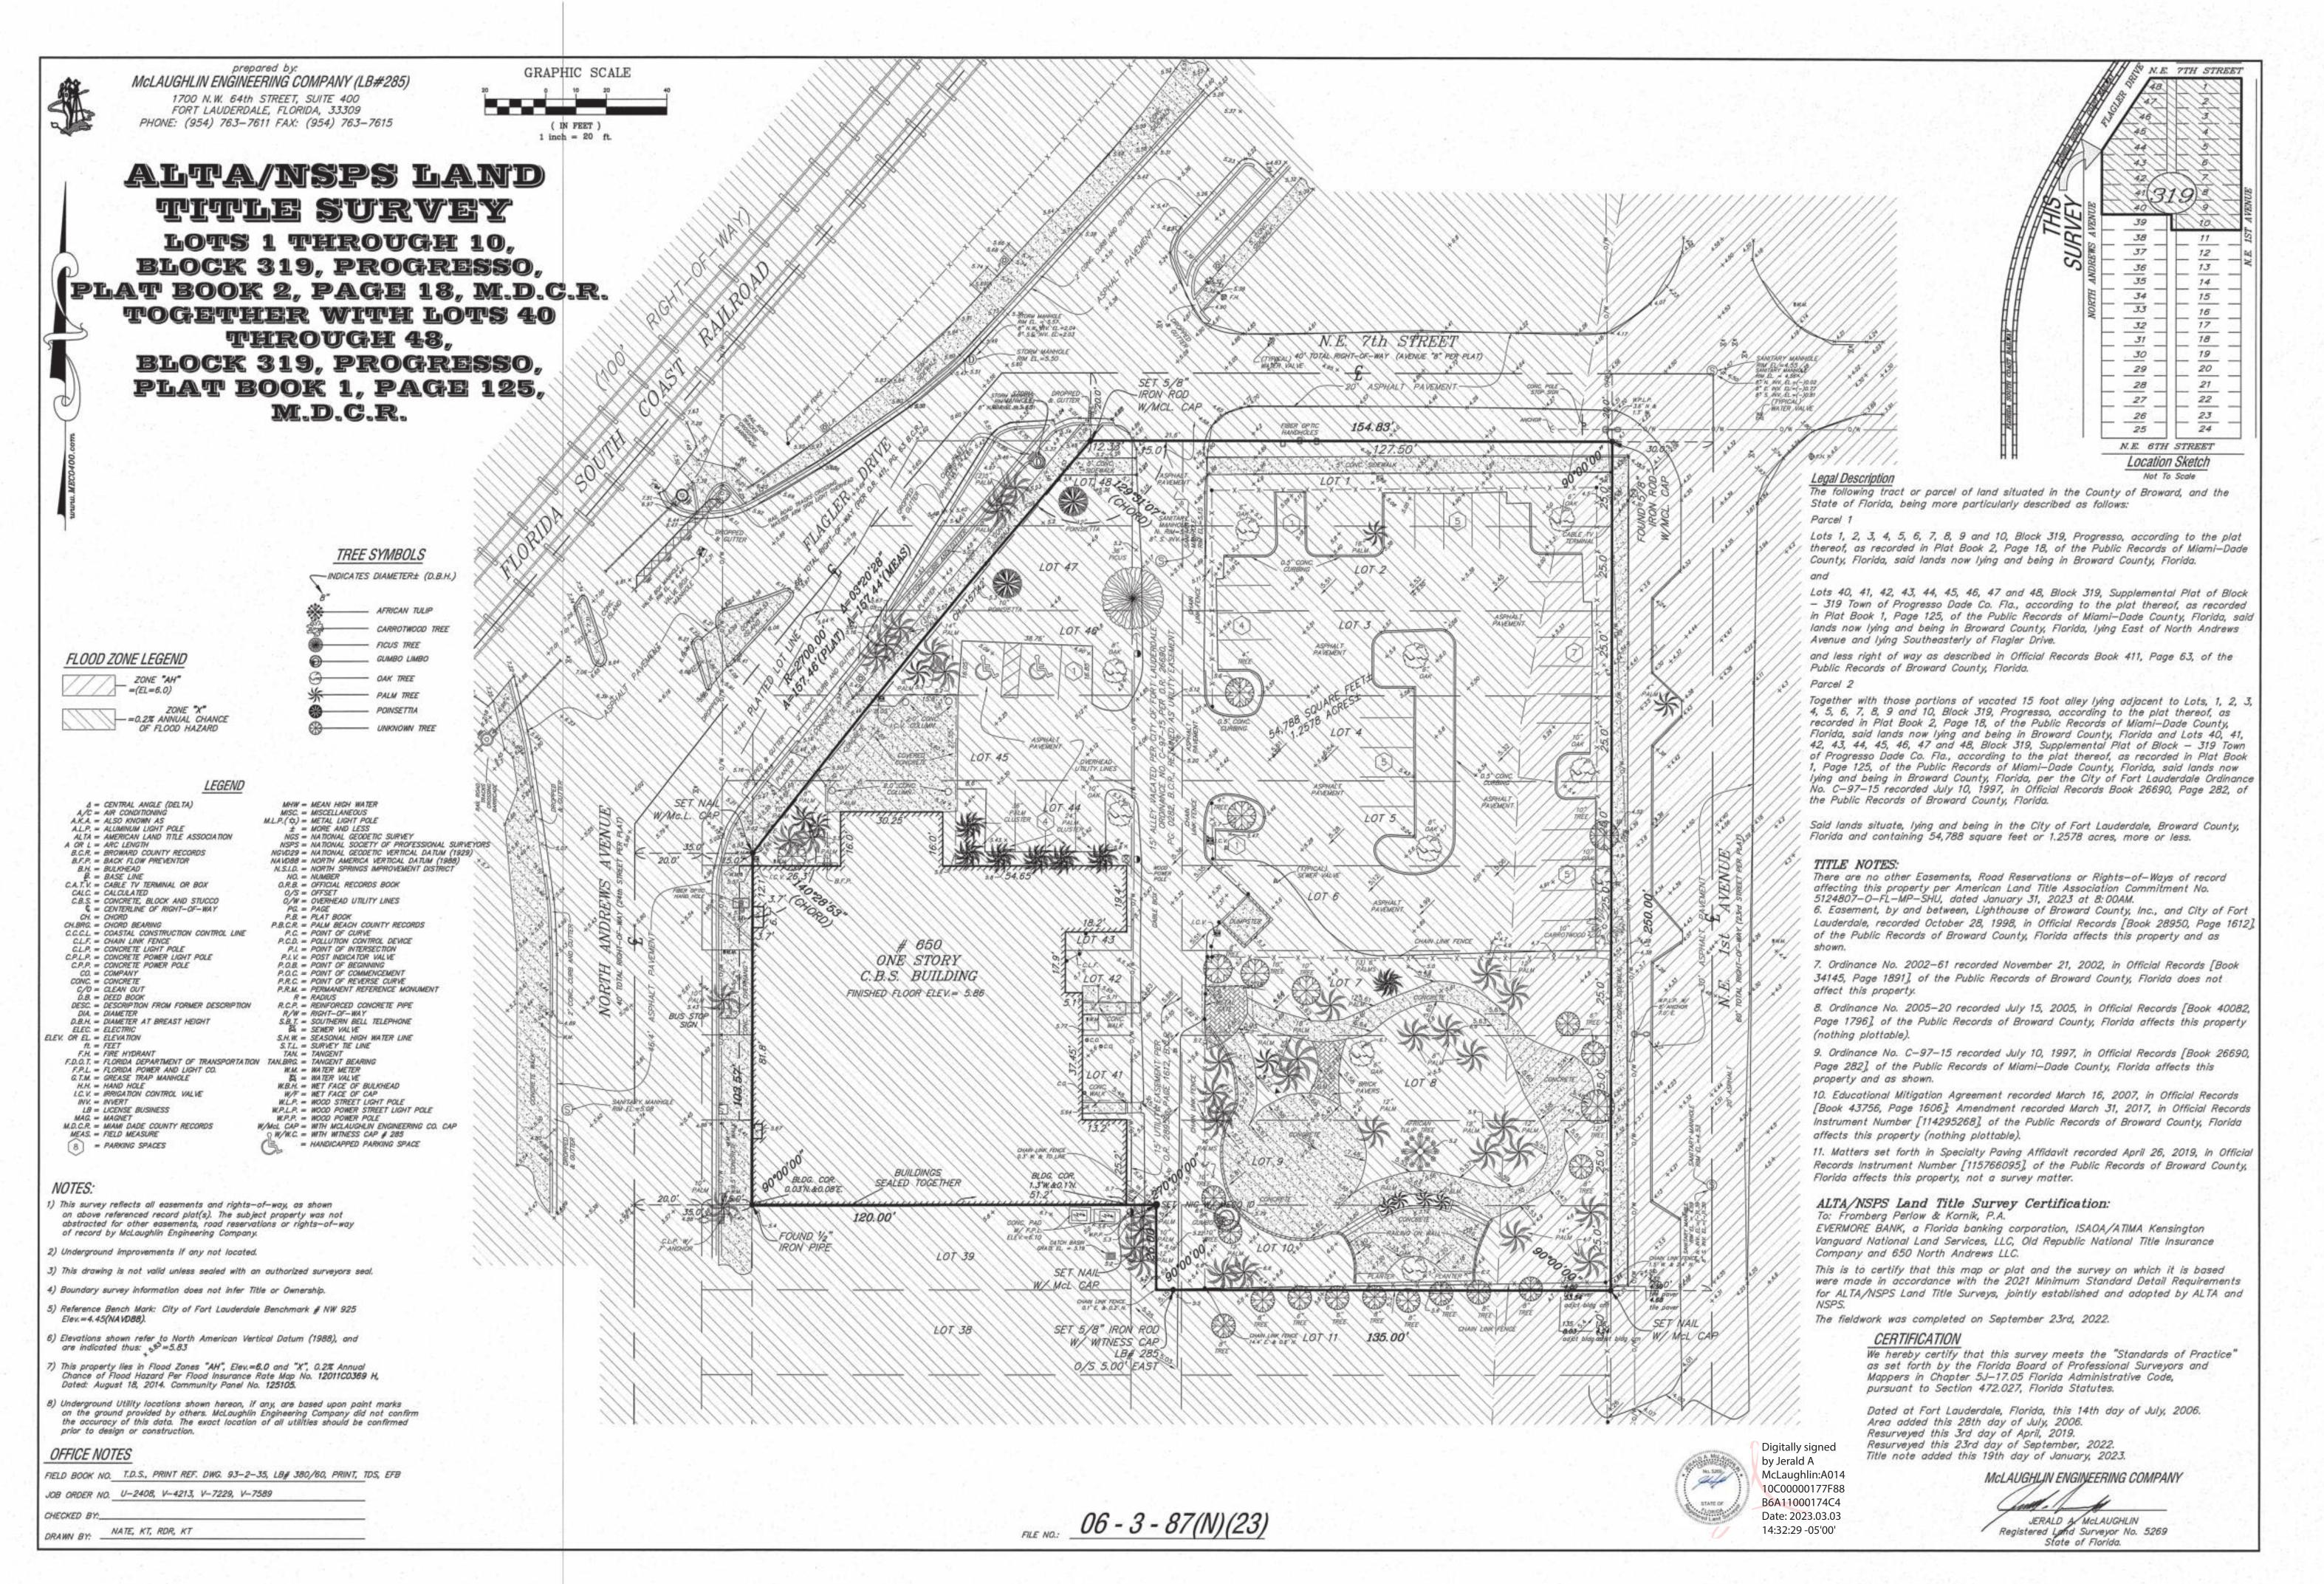

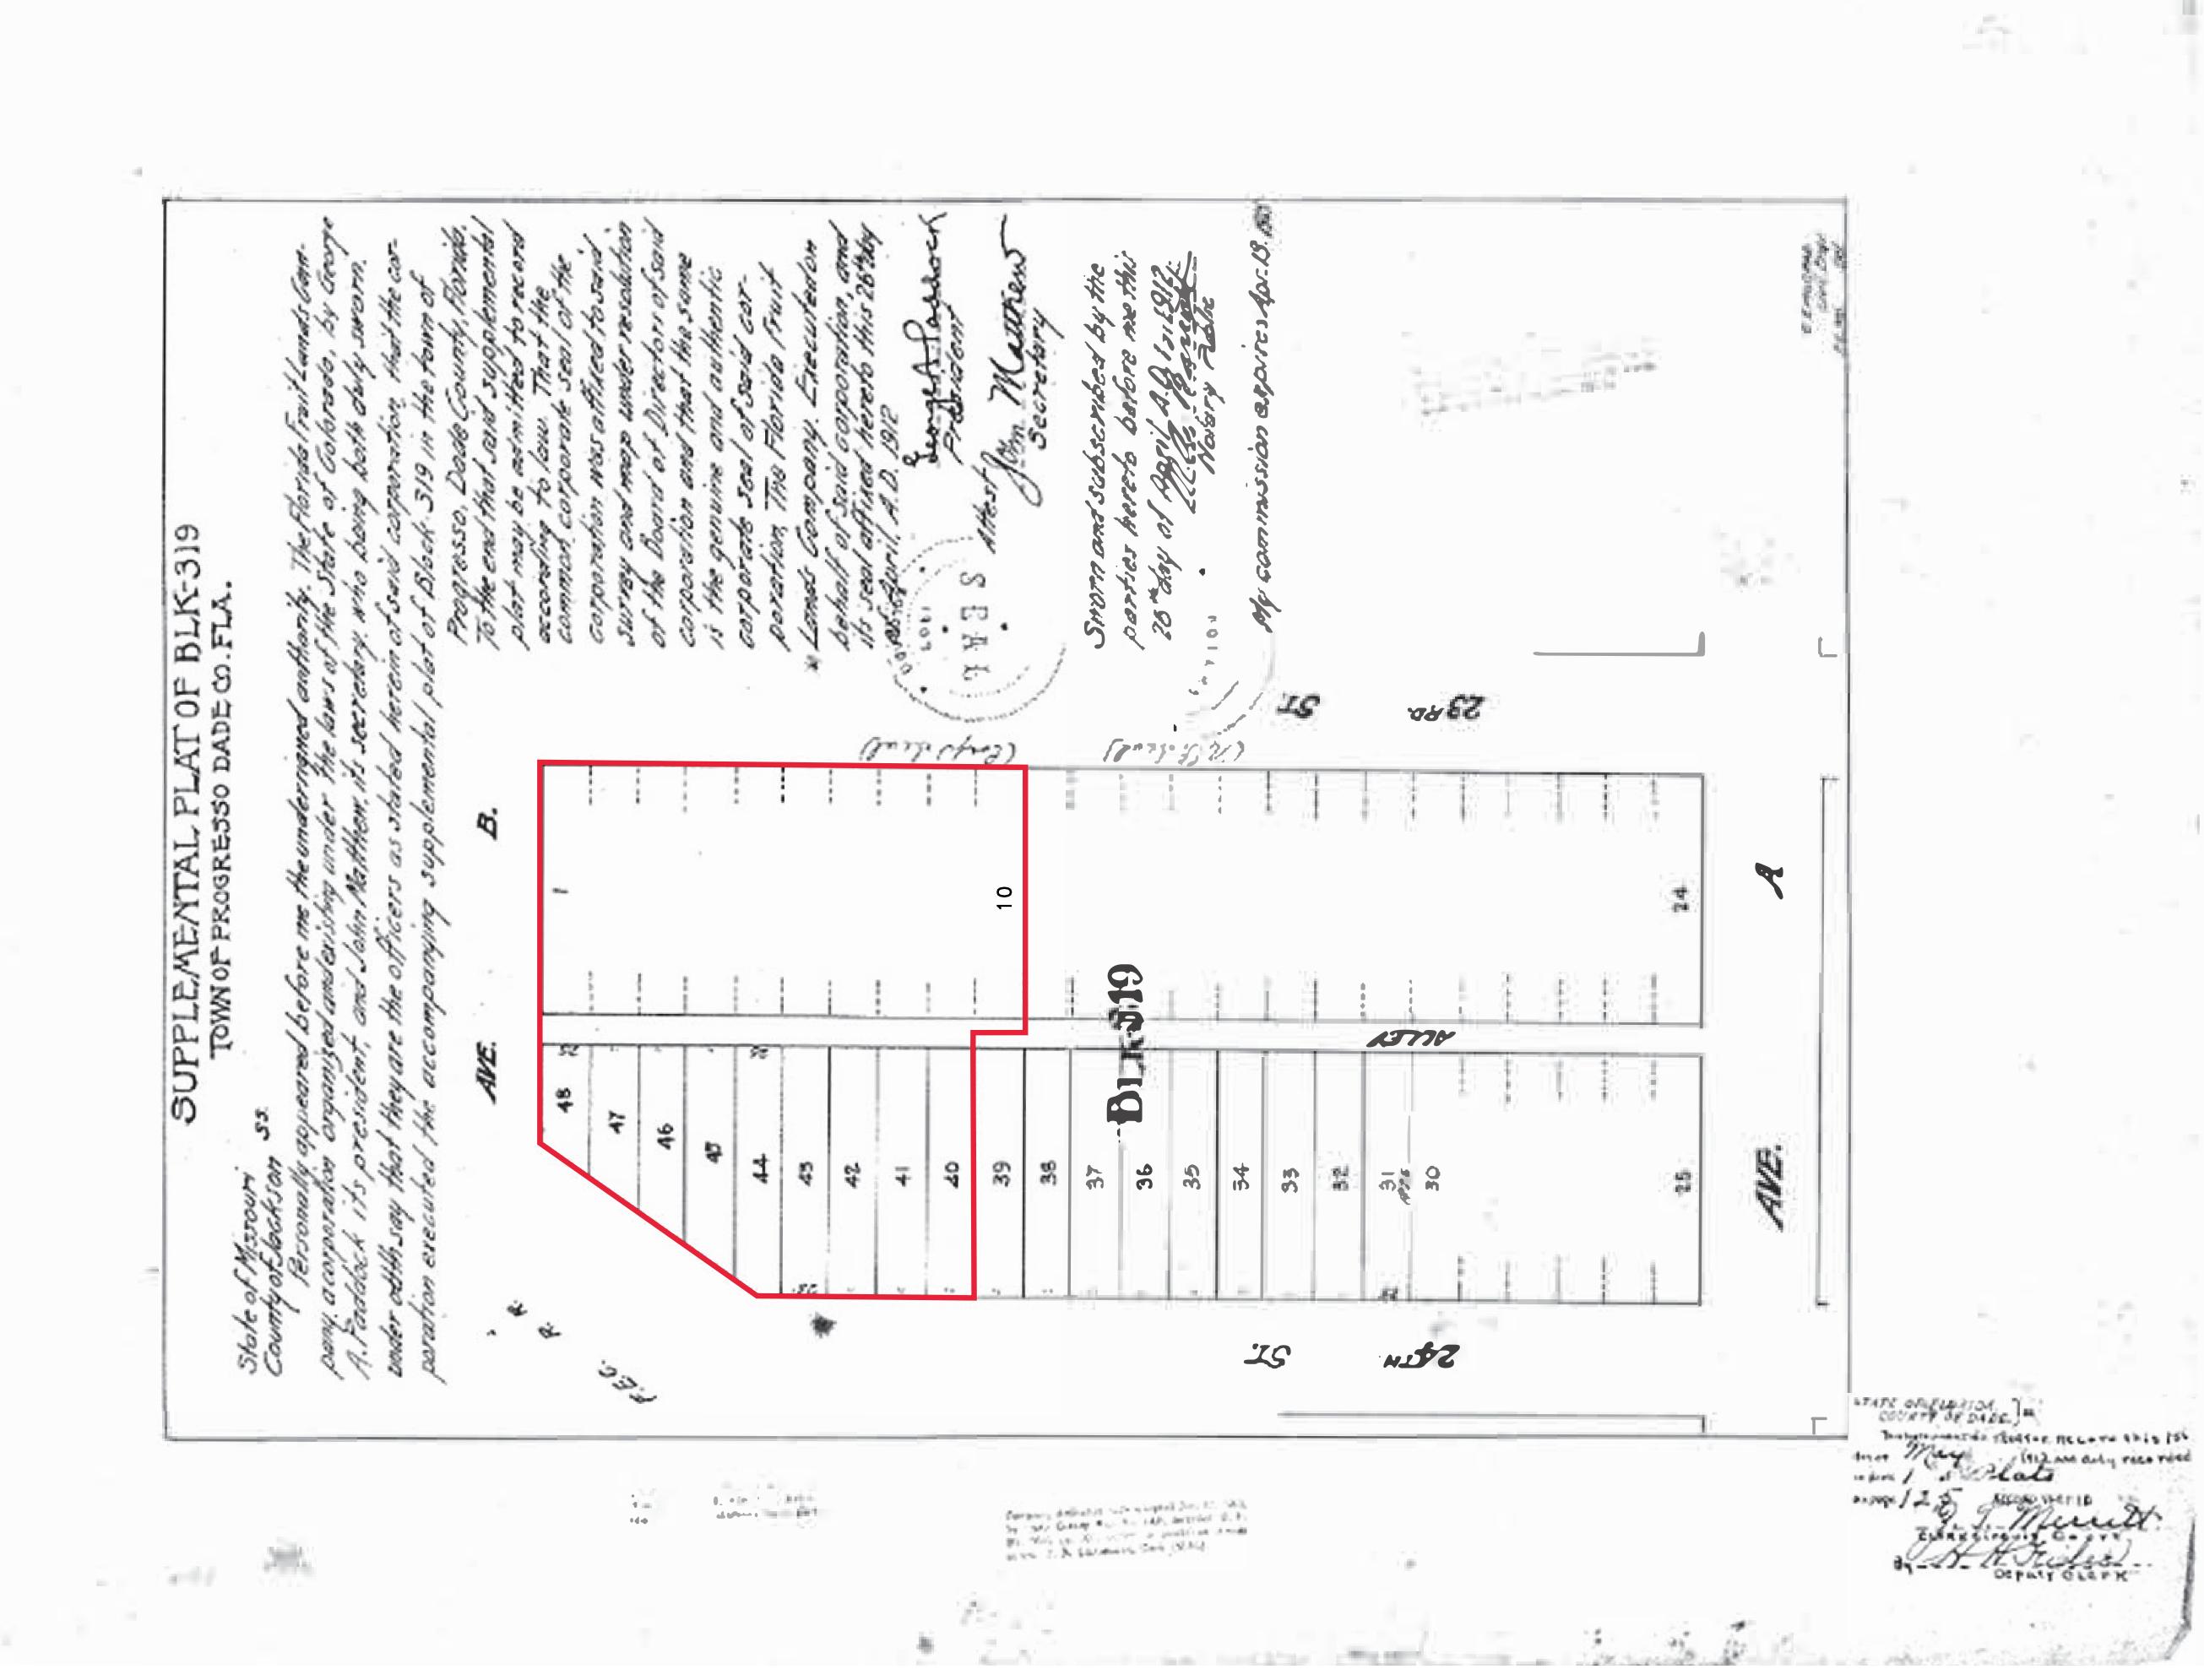

CAM # 24-1102 Exhibit 3 Page 3 of 66


X-YY GROUND FLOOR PHOTOMETRICS X-YY GROUND FLOOR PHOTOMETRICS - EM X-YY PARKING FLOOR PLAN PHOTOMETRICS X-YY PARKING FLOOR PLAN PHOTOMETRICS - EM



LOCATION MAP - 1 (650 NORTH ANDREWS AVENUE, FORTLAUDERDALE, FLORIDA 33311)



LOCATION MAP - 2 (650 NORTH ANDREWS AVENUE, FORTLAUDERDALE, FLORIDA 33311)

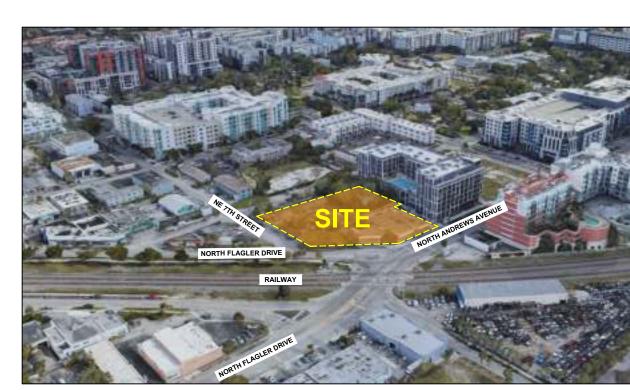

LOCATION MAP - 3 (LOOKING SOUTH - EAST)



.0.

LOCATION MAP - 4 (LOOKING SOUTH - WEST)



22-855 - MIXED-USE NORTH ANDREWS AVENUE - FORT LAUDERDALE



2 GENERAL SITE INFORMATION

(4)	STREET ADDRESS	FOLIO#	SITE AREA	
PARCEL	650 NORTH ANDREWS AVENUE, FORT LAUDERDALE, FLORIDA 33311	FOLIO # 494234150060	54,788 SF - 1.25 AC	L
		TOTAL	54,788 SF - 1.25 AC	





absolute-idea.com

3323 NE 163rd Street, Suite 200 North Miami Beach, FL 33160 (t) 305.792.0015 (f) 305.931.0279 (@) info@absolute-idea.com

TO THE BEST OF MY KNOWLEDGE, THE PLANS AND SPECIFICATIONS COMPLY WITH THE APPLICABLE MINIMUM BUILDING CODES AND THE APPLICABLE FIRE-SAFETY STANDARDS AS DETERMINE BY THE LOCAL AUTHORITY IN ACCORDANCE WITH THIS SECTION AND 633 FLORIDA STATUES. STEPHANE L'ECUYER AR 93637








REV.	DATE	DESCRIPTION
01	10-13-2023	D.R.C. SUBMITTAL
02	12-21-2023	REV. 1 COMMENTS
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ALL MEASUREMENTS MUST BE VERIFIED BEFORE BEGINNING THE WORKS. NO MEASUREMENTS ARE TO BE SCALED DIRECTLY FROM THIS DRAWING.

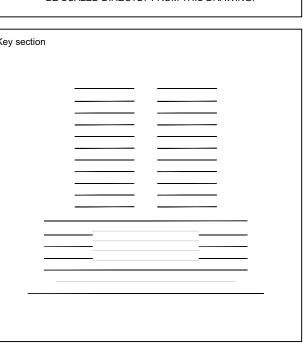

BAM PROPERTY DEVELOPMENT LLC

1044 BROADWAY,

WOODMERE, NY 11598

650 N ANDREWS **MIXED-USE**

650 NORTH ANDREWS AVENUE, **FORT LAUDERDALE, FL 33311**

DRAWING INDEX SITE INFORMATION

J. WU JF. Gervais as shown


S. L'ecuyer Project Manager N. TREMBLAY

22-855

10-07-2024

CAM # 24-1102 Page 4 of 66

ARCHITECTURE

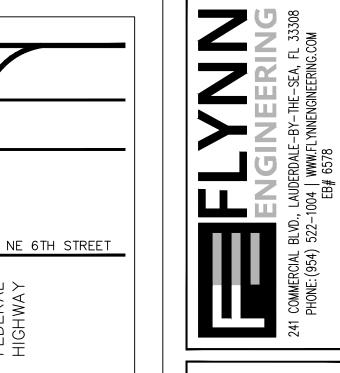


¥ 1619 NW 6TH STF RT LAUDERDALE,

Ó

NORTH

Revisions 12/21/23 REV1 <u>∕</u> 03/06/24 REV2 ∕3√05/15/24 REV3 ∕4\|09/10/24| REV4 ∱ 10/04/24 REV5

Phase: DRC DOCUMENTS

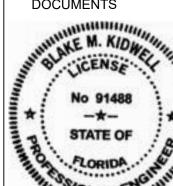

1"=20' 11/14/24 Job No. Plot Date | 22-1728.00 | 11/14/24 Sheet No. Drawn by SROD ^oroj. Mgr. Appr. by

LOTS 1, 2, 3, 4, 5, 6, 7, 8, 9, AND 10, BLOCK 319, PROGRESSO, ACCORDING TO THE PLAT THEREOF, AS RECORDED IN PLAT BOOK 2, PAGE 18, OF THE PUBLIC RECORDS OF DADE COUNTY, FLORIDA,

TOGETHER WITH:

ALL THOSE PORTIONS OF LOTS 40, 41, 42, 43, 44, 45, 46, 47, AND 48, BLOCK 319, PROGRESSO, ACCORDING TO THE PLAT THEREOF, AS RECORDED IN PLAT BOOK 1. PAGE 125. OF THE PUBLIC RECORDS OF DADE COUNTY, FLORIDA, LYING EAST OF NORTH ANDREWS AVENUE

LEGAL DESCRIPTION:

AND LYING SOUTHEASTERLY OF FLAGLER DRIVE, BOTH AS NOW LOCATED AND CONSTRUCTED.

ALSO TOGETHER WITH:

ALL THOSE PORTIONS OF VACATED 15.00 ALLEY LYING ADJACENT TO SAID LOTS 1, 2, 3, 4, 5, 6, 7, 8, 9, AND 10, AND LOTS 40, 41, 42, 43, 44, 45, 46, 47, AND 48.

SAID LANDS SITUATE, LYING AND BEING IN THE CITY OF FORT LAUDERDALE, BROWARD COUNTY, FLORIDA AND CONTAINING 54,788 SQUARE FEET OR 1.2578 ACRES, MORE OR LESS.

> 4942 34 15 0060 INSTITUTIONAL/PARKING LO PROPOSED USE OF PROPERTY MIXED USE CURRENT LAND USE DESIGNATION PROPOSED LAND USE DESIGNATION CURRENT ZONING DESIGNATION RAC-UV PROPOSED ZONING DESIGNATION RAC-UV ADJACENT ZONING DESIGNATION - E, N, S, & W RAC-UV URBAN NEIGHBORHOOD DOWNTOWN CHARACTER AREA

54,788 SF / 1.25 ACRES 75,300 SF / 1.73 ACRES TOTAL SITE AREA (NET) TOTAL SITE AREA (GROSS)

34.2 % TAL IMPERVIOUS PROPOSED 8,154 SF 14.9 % L IMPERVIOUS EXISTING 46.1 % 25,291 SF OTAL BUILDING FOOT PRINT PROPOSED 81.1 % 44,415 SF OTAL BUILDING FOOT PRINT EXISTING 10,767 SF 19.7 % 13.8 % PEDESTRIAN WALKS & PLAZAS 46,411 SF 826 SF 1.5 % VUA AREA

257 UNITS NUMBER OF RESIDENTIAL UNITS WEST TOWER <u> 175' / 14 FLOORS</u> BUILDING WIDTH & LENGTH # RES UNITS

RES UNITS 119 UNITS HEIGHT/# FLOORS
BUILDING WIDTH & LENGTH 175' / 6 FLOORS

PARKING / LOADING / BIKE / STACKING DATA:

COMMERCIAL RESTAURANT

PARKING PER ULDR SEC 47-20.2, * VALET PARKING IS NOT BEING PROVIDED AT THIS TIME.

*LOADING REQ. FOR RESIDENTIAL USES ARE NOT REQUIRED (ULDR SEC 47-20.2).

5% OF TOTAL PARKING SPACES WILL BE ELECTRIC CAR CHARGING STATIONS,

UP TO 20% OF TOTAL PARKING SPACES WILL BE FUTURE EV CHARGING COMPATIBLE.

UT-BOUND PROVIDED

FLOOD DATA:

* CITY OF FORT LAUDERDALE

SEE SHEET C2

- SIDEWALK LANDING FOR **FUTURE CONNECTION**

COBRA HEAD

SIGHT TRIANGLE (TYP)

STRUCTURAL

SOIL (TYP)

BALCONY

PROJECTION

TRAVEL

RELOCATED

Control LIGHT POLE

COBRA HEAD

COBRA HEAD

LIGHT POLE TO BE RELOCATED

RAI CONY TO CL

(E)

-10'X10' SIGHT

TRIANGLE (TYP)

10' PEDESTRIAN

SIGHT TRIANGLE

(NO BLDG)

→ BLDG. TO CL

-5TH-14TH LEVE

(EAST TOWER)

LIGHT POLE

_BLDG. TO CL

—10'X10' SIGHT

<u>C</u>OMMERCIAL BICYCLES ROOM

T 16 BIKES

RECYCLE

(1) 2 YD

TRASH BINS

PACKAGES ROOM

—(2 IN∕2 OUT

14 STORY

MIXED USE

FFE =

7.40 NAVD

12.0

ONE -

TRIANGLE (TYP)

42.5'

-BALCONY

STOP SIGN

O REMAIN-

LEVEL 1 1075 SQ. FT. LEVEL 1.5

LEVEL 1 600 SQ. FT. LEVEL 1.5 200 SQ. FT. TOTAL 800 SQ. FT.

STAIRCASE 3

2 BDS LOFT

LEVEL 1 600 SQ. FT. LEVEL 1.5 200 SQ. FT. TOTAL 800 SQ. FT.

2 BDS LOFT

FIRE COMMAN ROOM 200 SF

BDS LOFT

(L-B1) LEVEL 1 615 SQ. FT. LEVEL 1.5 200 SQ. FT. TOTAL 800 SQ. FT.

-FDOT CURB

RAMPS (TYP.)

-EXISTING UTILITY

(CONTRACTOR TO

COORDINATE WITH

UTILITY COMPANIES

FOR REMOVAL AND

OVERHEAD WIRES

UNDERGROUND.)

-FDOT CURB RAMPS (TYP.)

RELOCATION OF

REMOVED.

POLE AND OVERHEAD

WATER/WASTEWATER SERVICE PROVIDER:

SETBACK TABLE REQUIRED PROVIDED TO CL FRONT YARD (WEST) - N ANDREWS AVENUE 49.0' FROM CL TÓ CL 44.1'(BLDG) TO CL FRONT YARD (WEST) - N FLAGLER DRIVE 35.0' FROM CL 39.1' (BALCONY) TO CL 35.0' (BLDG) TO CL REAR YARD (EAST) - N.E. 1ST AVENUE 35.0' FROM CL 30.0' (BALCONY) TO CL 47.5' (BLDG) 35.0' FROM CL 42.5' (BALCONY) SIDE YARD (NORTH) - N.E. 7TH STREET

BUILDING DATA:

SIDE YARD (SOUTH) - ADJ. PROPERTY

SEE SHEET (arch)

OPEN SPACE - PROVIDED & REQUIRED

 REQUIRED:
 PROPOSED:

 7,530 SF
 30,888 SF
 OPEN SPACE (EXHIBIT PROVIDED ON SHEET X4)

STRUCTURAL SOIL:

STRUCTURAL SOIL WILL BE USED UNDER THE PUBLIC SIDEWALK AS REQUIRED PER THE CITY OF FORT LAUDERDALE ULDR. STRUCTURAL SOIL AND PAVER GRATE DETAILS PROVIDED ON LANDSCAPE PLANS.

SOLID WASTE / RECYCLING MANAGEMENT:

THE SOLID WASTE AND RECYCLING WILL BE COLLECTED BY A PRIVATE LICENSED CONTRACTOR 2 TIMES PER WEEK OR MORE AS NEEDED.

THE COLLECTION WILL OCCUR BY ACCESS FROM EITHER NE 1ST AVE OR NE 7TH ST. SERVICE TURNING RADII SHOWN ON CIRCULATION EXHIBIT (SHEET X5). THE TRASH AND RECYCLE CONTAINERS WILL BE STORED AT ALL TIMES WITHIN THE TRASH ROOM INSIDE THE BUILDING. ON-SITE PERSONNEL WILL PLACE CONTAINERS FROM HE TRASH ROOM TO THE AREA OUTSIDE THE BUILDING FOR

SOLID WASTE TRANSPORT TO TRASH ROOMS SHALL BE PERFORMED INSIDE THE BUILDING VIA TRASH CHUTE (RESIDENTIAL ONLY).

THE WASTE SYSTEM WILL MEET THE CAPACITY REQUIREMENT OF THE BUILDING ORDINANCE REQUIREMENTS.

THE BUILDING WILL CONTAIN THE FOLLOWING EQUIPMENT: •• WASTE REMOVAL WILL BE 3 DAYS/WK OR AS NEEDED-(4) 2YD CONTAINERS •• RECYCLE REMOVAL WILL BE 2 DAYS/WK OR AS NEEDED-(4) 2YD

**THE WASTE SYSTEMS WILL MEET THE CAPACITY REQUIREMENTS OF BUILDING ORDINANCE REQUIRMENTS AND COMPLY WITH ULDR 4719.4 AS APPLICABLE.

Digitally signed by Blake M dnQualifier=A01410C000001 8E75F903E100026EDE,

This document has been digitally signed and sealed by

9 HANDICAP Blake M Kidwell DN: c=US, o=Unaffiliated,

TYPE

47S + 1HC

75S + 2HC

75S + 2HC

Blake M. Kidwell on 11/14/2024.

FROM PL DOMESTIC PUMP ROOM BLDG. TO PL --UTILITY EASEMENT (CITY) (S) 235.0 BALCONY 135.00° BUILDING WIDTH ENCROACHMENT -SERVICE AREA BLDG SEPARATION DRT TABLE (URBAN NEIGHBORHOOD) REQUIREMENT COMPLIES/ALTERNATIVE DESIGN: REQUIRED: PROPOSED: 12 Floors** Max. Bldg Height 14 Floors (East & West towers) Deviation Requested Max. Bldg Streetwall Length N Andrews: 104' - 11' Complies Flagler Dr.: 141' - 0" ON-STREET PKG: NE 7th St.: 140' - 0" NONE OF THE ON-STREET SPACES ARE RESERVED FOR THE DEVELOPMENT AND NE 1st Ave: 227' - 3" MAY BE USED BY ANY MEMBER OF THE PUBLIC. ON-STREET SPACES WILL NOT COUNT TOWARDS THE PARKING REQUIREMENTS FOR THE PROJECT; THE SPACES Max. Gross SF of Residential: 10,000 square feet 9,200 square feet (West tower) Deviation Requested for East Tower MAY BE REMOVED AT ANY TIME FOR ANY REASON AND THE CITY OF FORT Non-Residential: 16,000 square feet Bldg Tower Floor Plate Size 10,680 square feet (East tower) LAUDERDALE WILL NOT RELOCATE DISPLACED ON-STREET PARKING. THE CITY RESERVES THE RIGHT TO METER ON-STREET PARKING STALLS ON THE PUBLIC RIGHT-OF-WAY AT ANY TIME. Max Bldg Podium Height 6 Floors 3 Floors Complies Min. Bldg Tower Step Back Flagler Drive: 0' or 12' with 5' balcony projection Deviation Requested for NE 7th Street Andrews Ave: 12' with 5' balcony projection and Flager Drive with 5' balcony projections NE 7th St.: 0' PARKING GARAGE DATA: NE 1st St.: 15' -8" RESIDENTIAL / PARKING BY LEVEL PARKING PROVIDED 60 Feet between towers in same parcel; | Min. 60' between E/W Tower's balconies Min. Separation between Complies 30 Feet min if adjacent to abutting lot Blda Towers: Min. 38-2" East Tower Face to South PL under separate ownership; PARKING Min. 33'-2" East Tower Balcony to South PL Complies PARKING 3 LEVEL PARKING 77 75S + 2HC 4 LEVEL Min. 31'-2" West Tower Face to South PL 77 75S + 2HC 5 LEVEL PARKING Deviation Requested for 5' balcony projection Min. 26'-2" West Tower Balcony to South PL TOTAL _ 347 STANDARD Minimum Residential Unit Size 400 square feet 450 square feet Complies * Heights above six (6) floors and up to twelve (12) floors in the Urban Neighborhood Character Area and RAC-RPO zoning districts shall be reviwed subject to the requirements of Section 47-24.3, Conditional Use Permit, except that parcels abutting Andrews Ave. and Federal Hwy. shall be exempt from Conditional Use Review for height.

-EXISTING STOP SIGN

-SW ESMT

140 0

STREETWALL

LENGTH

N.E. 7th STREET

40' TOTAL RIGHT-OF-WAY (AVENUE "8" PER PLAT)

TO REMAIN

-STRUCTURAL

SOIL (TYP)

ROW ESMT (CITY)

PLAZA

FLUSH SIDEWALK CONDITION

ELECTRICAL ROOM (24' X 15'-2")

FPL VAULT (26'-6" X 34'-6")

RESTAURANT

1,250 SQ. FT.

TRASH ROOM 1 (30' X 14')

UVERHEAD UTILITY LINES

RESIDENTIAL 27 BIKES

(REFER TO ARCHITECTURE

PLANS FOR DETAILS)-

25'X25' SIGHT <

TRIANGLE (TYP)

SW ESMT

BALCONY

12.0'

STEPBACK

-PEDESTRIAN

LIGHT POLE (TYP)

STEPBACK

5TH-14TH LEVEL

120.00'

(WEST TOWER) -

TO PL

TO PL RETAIL A

2,700 SQ. FT

+ MEZZ

800 SQ. FT.

3,500 SQ. FT.

3,900 SQ. FT

1,100 SQ.

TOTAL

5,000 SQ.

BLDG SEPARATION

REQUIREMENT

+ MEZZ

CONNECT

TO EXIST-

STRUCTURAL

LOSE EXIST

ORIDA EV-

LIGHT POLE

BALCONIES

30' COUNTY CORNER

9.0' ROW ESMT.

(COUNTY)-

EXIST BUS

CURB

45.0'

35.0

5.0'

BALCONY

ENCROACHMENT

☼≒₫

EXISTING

STOP SIGN (

TO REMAIN!

CHORD & SIGHT TRIANGLE -

TO REMAIN

SOIL (TYP)-

Printed copies of this document are not considered signed and sealed.

BROWARD BLVD **LOCATION MAP** SITE DATA TABLE: 650 N. ANDREWS AVE PARCEL ID# CURRENT USE OF PROPERTY

CITY OF FORT LAUDERDALE WATER & WASTEWATER SERVICE PROVIDER

SITE AREA:

SUNRISE BLVD

PERVIOUS / IMPERVIOUS: TOTAL PERVIOUS PROPOSED (LANDSCAPE) TAL PERVIOUS EXISTING 18,730 SF

HEIGHT/# FLOORS 62' / 14 FLOORS

225'0" X 235'0 # RES UNITS

LOT DENSITY (257 DU / 1.25 AC)	205.6 DU/AC
 FLOOR AREA RATIO (F.A.R.) = (307,775 GSF / 54,788)	5.61
TOTAL BUILDING SQUARE FOOTAGE (NIC PKG/LOADING/BALC.)	307,775 GROSS
TOTAL RESIDENTIAL	215,350 SF
TOTAL AMENITY/TENANT STORAGE/COMMON	74,585 SF
TOTAL COMMERCIAL	9,750 SF

TOTAL PARKING AND LOADING (NIC)	136,800 SF
TOTAL BALCONIES TERRACES (NIC)	25,105 SF

TOTAL SERVICE

		UNITS	RATIO	REQUIRED	PROVIDE
RESIDENTIAL	STUDIO / 1 BEDROOM	151	1.2	181.2	
	2 BEDROOM	101	1.2	121.2	
	3 BEDROOM	5	1.2	6.0	
		=257	SUBTOTAL	308.4	309
		ΔRFΔ	PATIO	DEOLUDED	DDOVIDE

AREA	RATIO	_	REQUIRED	PROVID
8,500 SF	1/250 SF		34.0	34
1,250 SF	1/100 SF		12.5	13
	SUBTOTAL		46.5	47
TOTAL GARAGE	PARKING		355	356
* PARKING PER LILDR	SEC. 47-20.2			


9,185 SF

RESIDENTIAL (GROUND FLOOR LEVEL COMMERCIAL (GROUND FLOOR LEVEL


LOADING REQUIREMENTS:	GSF	REQUIRED	PROVIDE
RESIDENTIAL	*	0	1 110 112
COMMERCIAL	9,750 SF	0*	
		0.	
TOTAL	9,750 SF	0	0
*LOADING REQ. FOR NON-RESIDENTIAL <15,000 NOT REQUIRED.			

ESTABLISH NEW TON NESTABLISHINE SOES THE NOT N	Eddines (OEDIN C	20.2).		
STACKING REQUIREMENTS:	IN-BOUND	IN-BOUND	OUT-BOUND	OU ⁻
	REQUIRED	PROVIDED	REQUIRED	Ρ
NW 4 1 AVE			_	


NW 1st AVE		2	2	1	1
NW 7th ST		2	2	1	1
* STACKING REQUIREMENT PER ULDR SEC 47-20.	5.0	2.6.			
EV NOTE:					

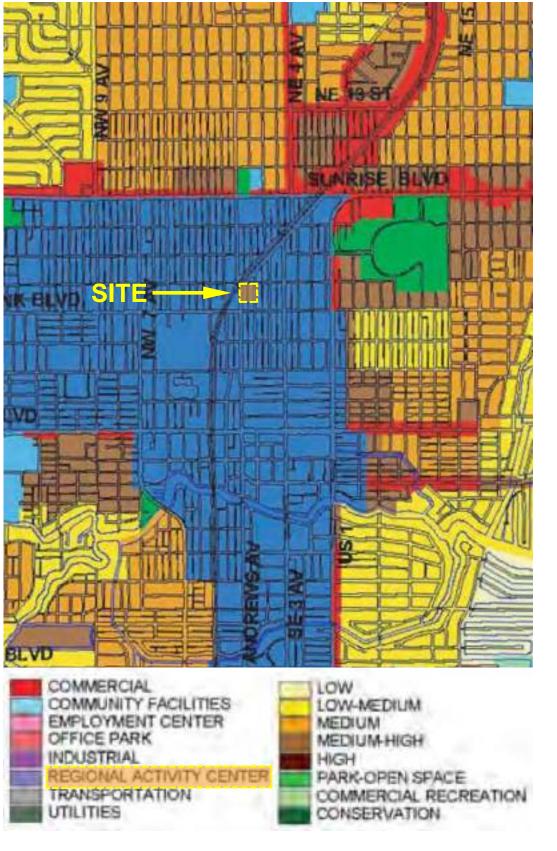




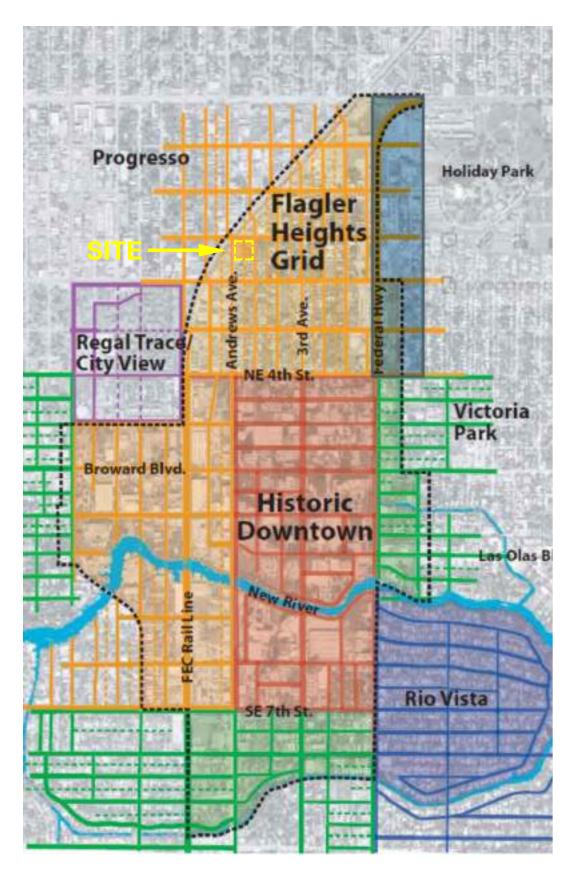


NEIGHBORHOOD STREET PATTERNS 4 FLAGLER HEIGHTS GRID A-001 SCALE: NTS

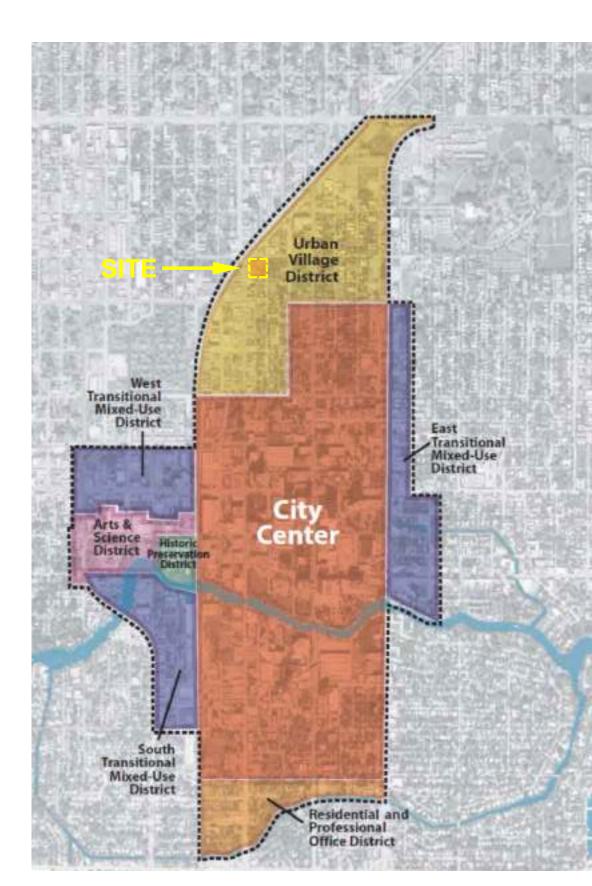

ZONING DISTRICT DESIGNATION URBAN VILLAGE DISTRICT

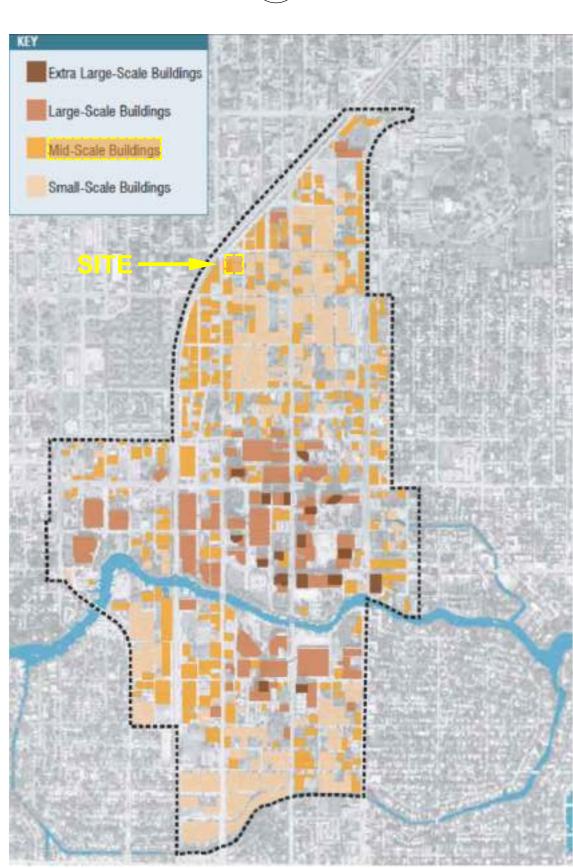


BUILDING TYPES DIAGRAM MID-SCALE BUILDING A-001 SCALE: NTS

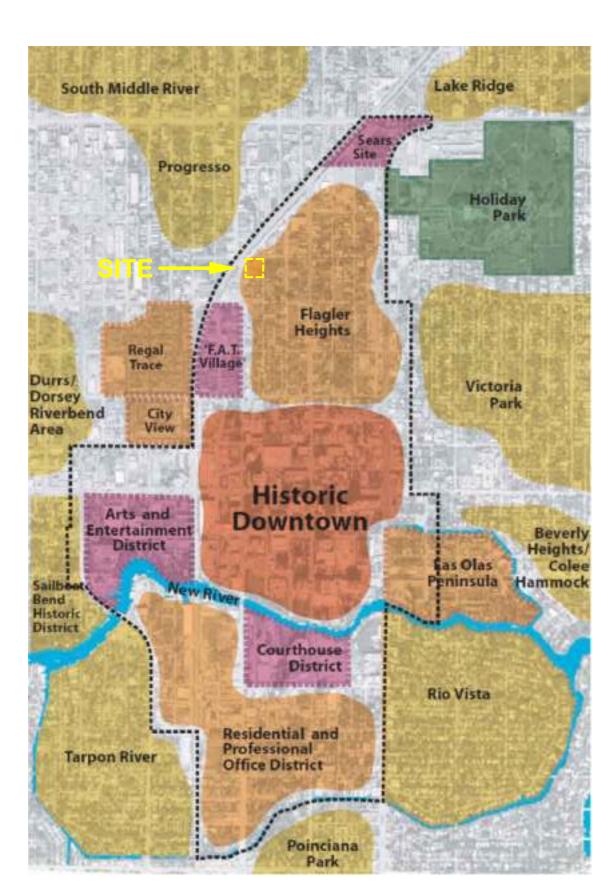

NEIGHBORHOOD IDENTITY FLAGLER HEIGHTS



RETAIL DIVERSITY DIAGRAM GROUND FLOOR RETAIL PROPOSED A-001 SCALE: NTS

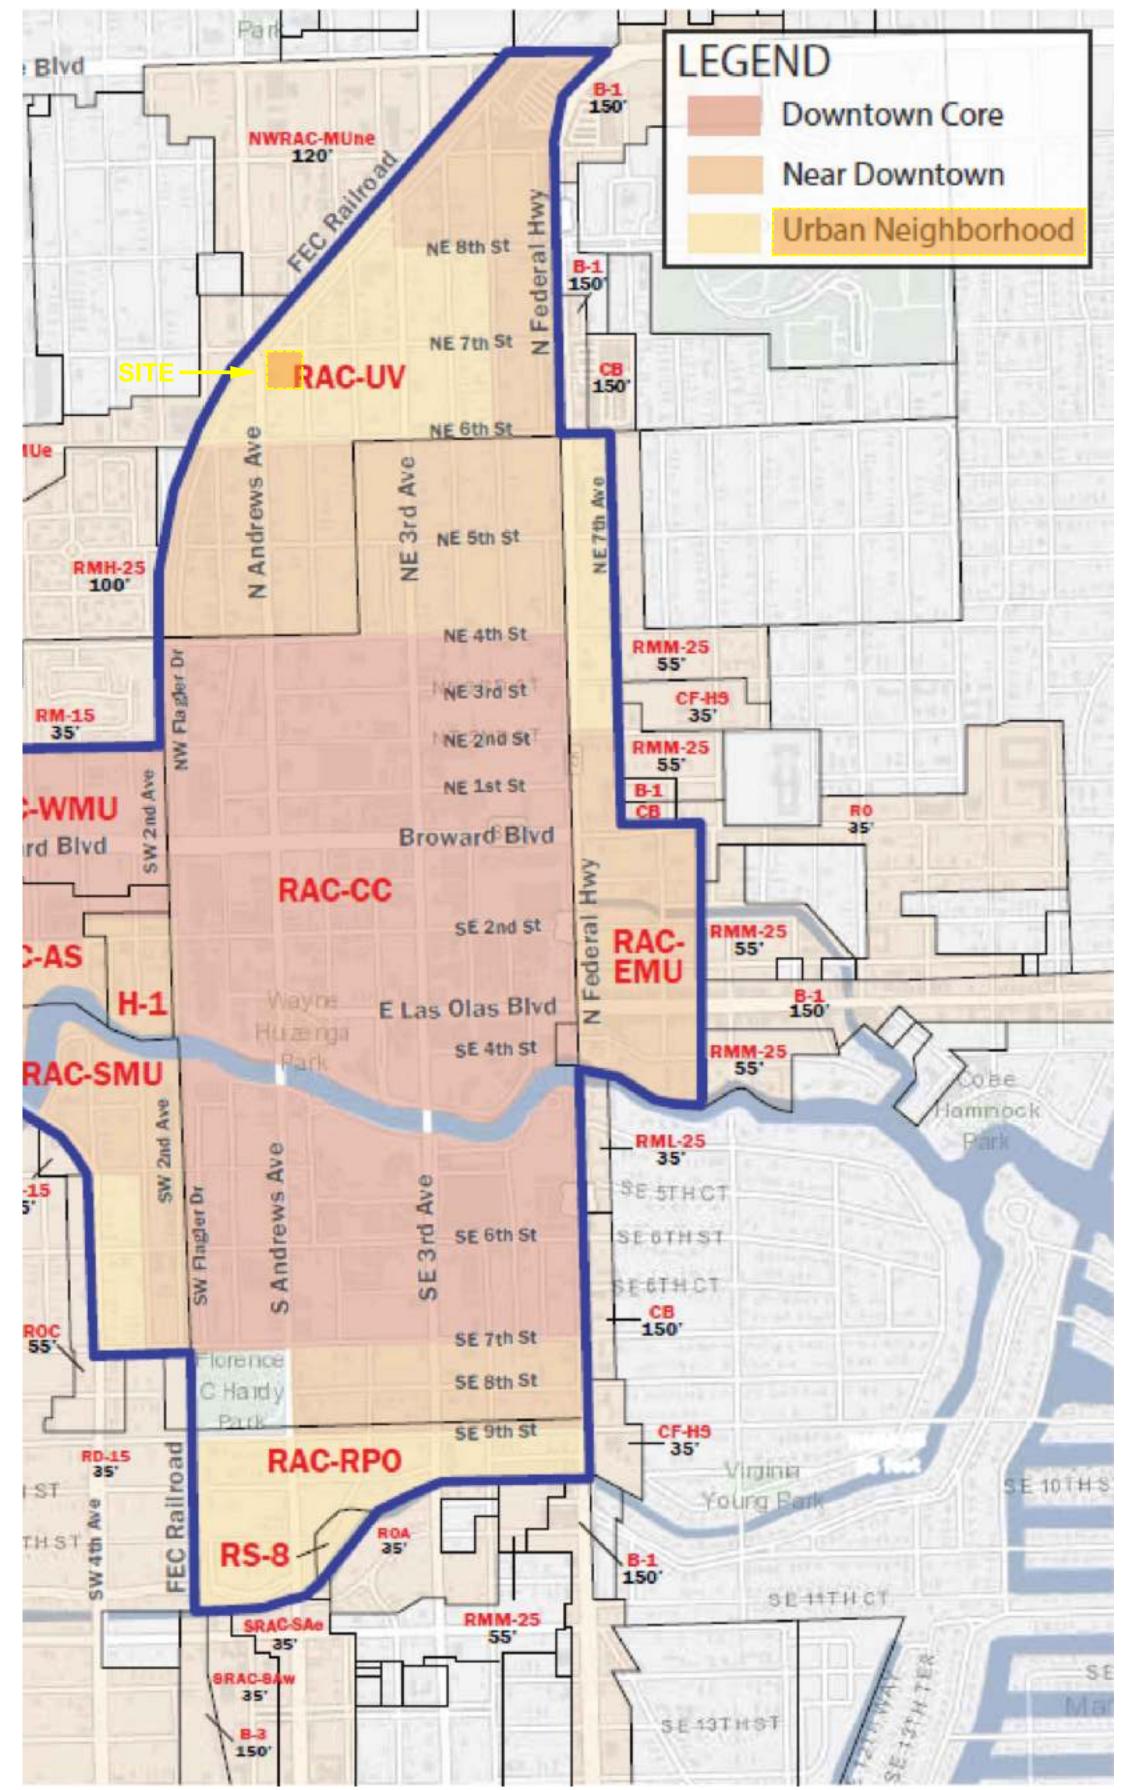

ZONING CHARACTER MAP 7 RAC-UV (URBAN NEIGHBORHOOD) A-001 SCALE: NTS




3323 NE 163rd Street, Suite 200 North Miami Beach, FL 33160 (t) 305.792.0015 (f) 305.931.0279 (@) info@absolute-idea.com

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BY THE LOCAL AUTHORITY IN ACCORDANCE WITH THIS SECTION AND 633 FLORIDA STATUES. STEPHANE L'ECUYER AR 93637



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BAM PROPERTY DEVELOPMENT LLC 1044 BROADWAY, WOODMERE, NY 11598

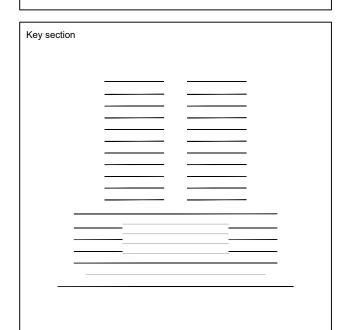

LAND USE REGULATING PLANS Field

J. WU **ARCHITECTURE** JF. Gervais as shown S. L'ecuyer 10-10-2024

Project Manager N. TREMBLAY A-001 22-855

Exhibit 3
Page 6 of 66



URBAN NEIGHBORHOOD

DOWNTOWN CORE

Use:

Mixed use "center" More commercial/civic

High density housing

Form: Verticality and density characterized by slender towers with minimal step-backs among mixed lower buildings. A 'central-business-district' feeling is created by the 'forest-like' arrangement of verti-

cal towers and a strong skyline image.

Use:

Institutional, retail, and office

NEAR DOWNTOWN

More housing variety

Form:

Strong framing of the street defined by emphasis on 6-8 story building 'shoulders' with towers stepped back above.


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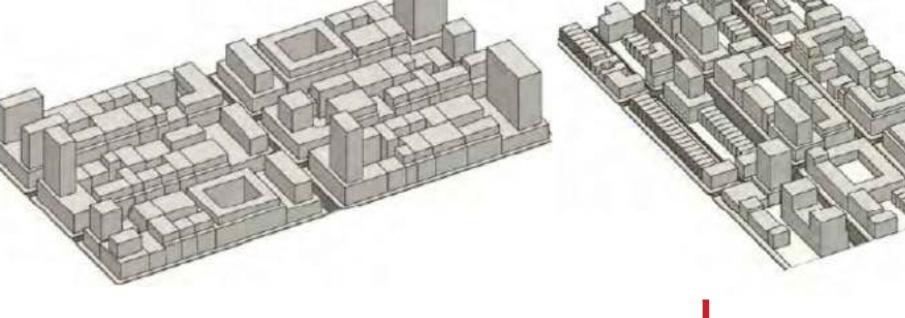
Primarily residential


Community retail & employment

Form:

A varied neighborhood scale including a mix of housing types such as townhouses and apartment buildings. Buildings step back above defined bases, and vertical elements emphasize primary streets.



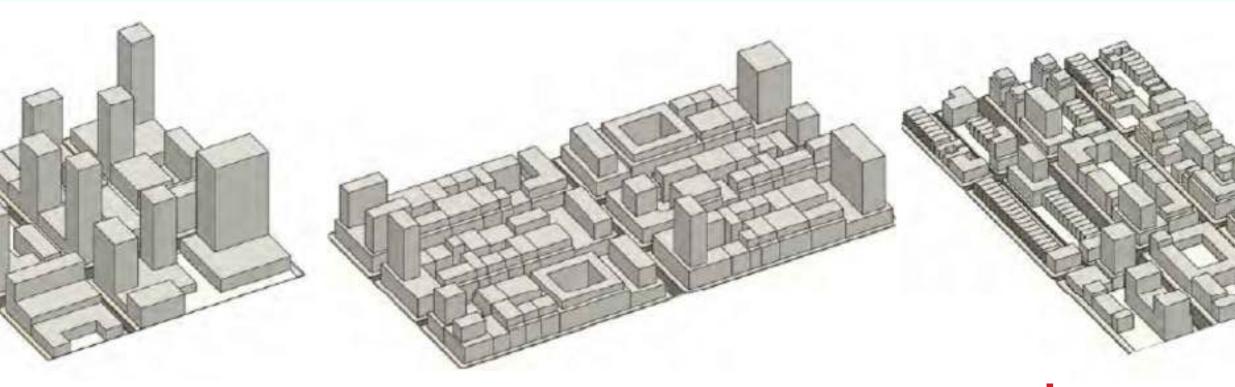

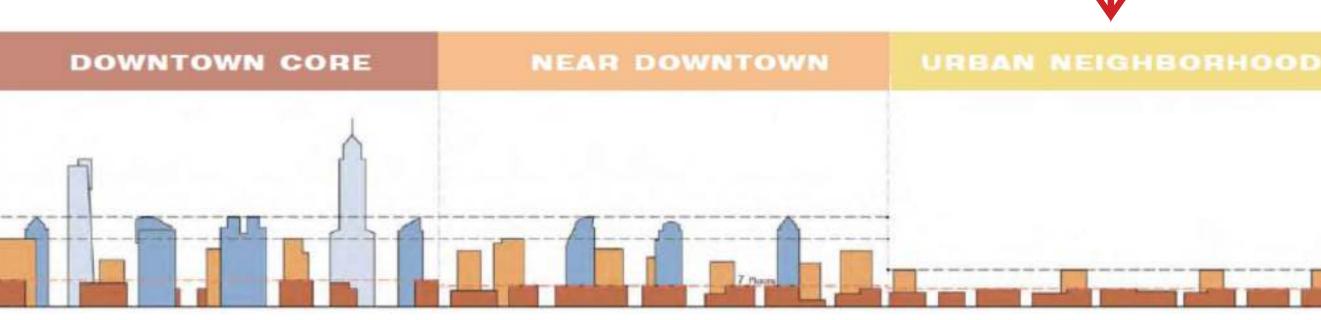

KEY

30+ Floors

Max. Height: no height limit

Max. Height: 30 floors (Preferred)

Max. Height: 6 floors (Preferred) 12 floors by "conditional use process" per ULDR (where allowances for additional height are permitted for specific locations pursuant to the ULDR, then the ULDR shall control)

Building Type: Building shoulders and

Building Type: building shoulders, stage 1, Building Type: Building Shoulders, Stage stage 2, and stage 3 towers.

1 and stage 2 towers.

Special Review for projects above 37 floors

Preferred Max. Floorplate Size:

32,000 SF Office: no max to 9 floors

12,500 - 18,000 SF Residential:

Stage 2 Tower (22-30 Floors)

Building Shoulders

Stage 1 Tower (shoulder-22 Floors)

no max to 9 floors

Stage 3 Tower (30+ Floors) Signaure Tower

Office:

Residential:

no max to 7 floors

Preferred Max. Floorplate Size:

32,000 SF no max to 7 floors

12,500 - 18,000 SF

Preferred Max. Floorplate Size:

stage 1 towers.


16,000 SF Office:

no max to 5 floors

10,000 SF Residential:


no max to 5 floors

BUILDING TYPES 1 DESIGN GUIDELINES A-002 SCALE: NTS

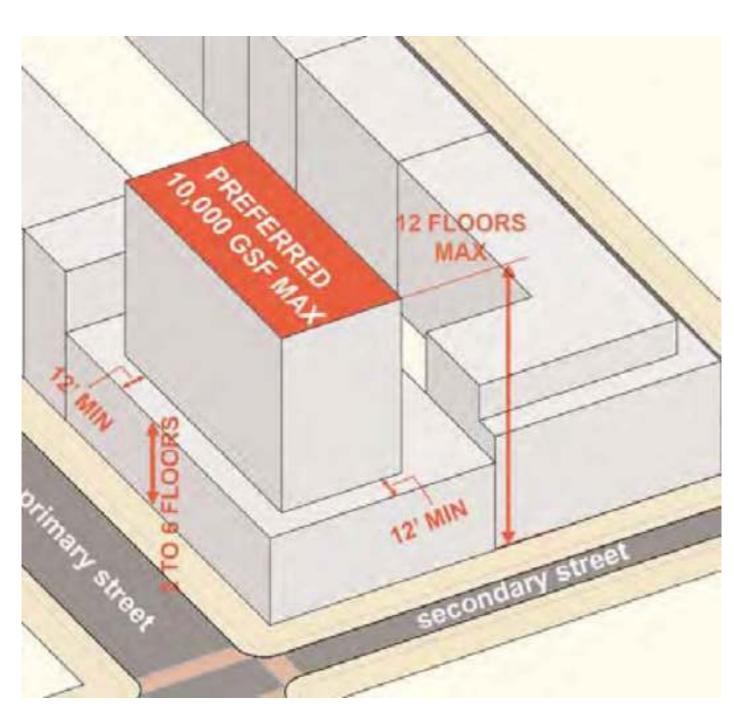


BUILDING "SHOULDER" AND TOWER GUIDELINES: SHOULDERS: ENCOURAGE HEIGHT LIMIT OF 6 FLOORS. ENCOURAGE MAXIMUM OF 12 FLOORS, CONSISTENT WITH THE CONDITIONAL USE PROCESS OUTLINED IN THE CITY'S ULDR.

> "SHOULDER" & TOWER DESIGN GUIDELINES

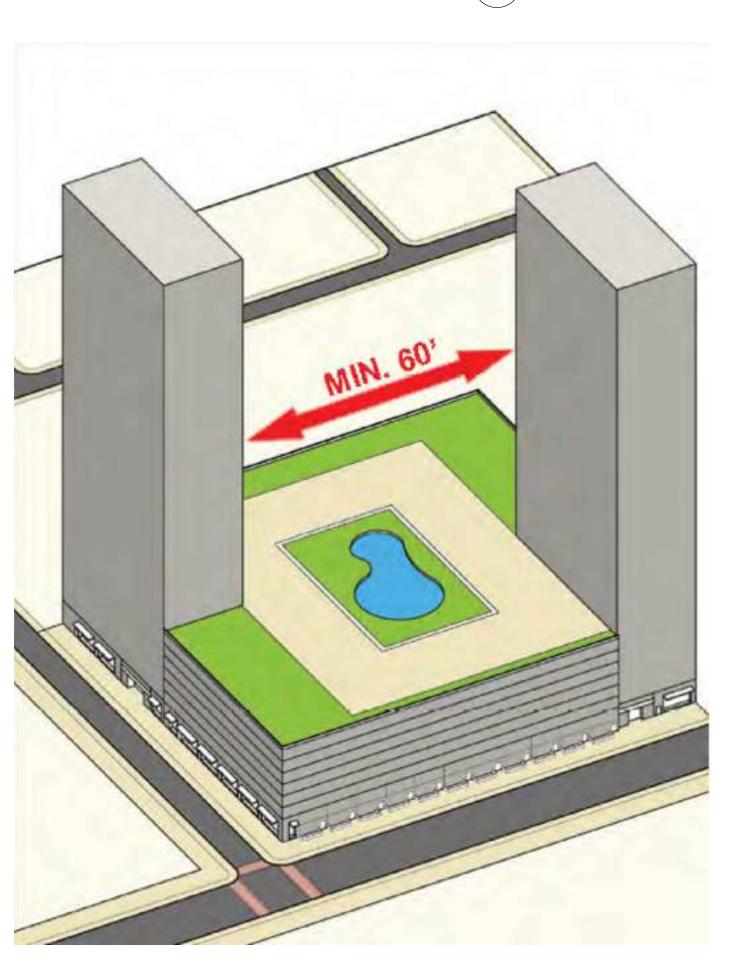

VERTICAL OPEN SPACE BETWEEN MULTIPLE TOWERS ON A SINGLE LARGE DEVELOPMENT SITE: MAXIMUM FLOORPLATE AREAS APPLY MULTIPLE TOWERS NO LESS THAN 60' APART

> VERTICAL OPEN SPACE DESIGN GUIDELINES A-002 SCALE: NTS

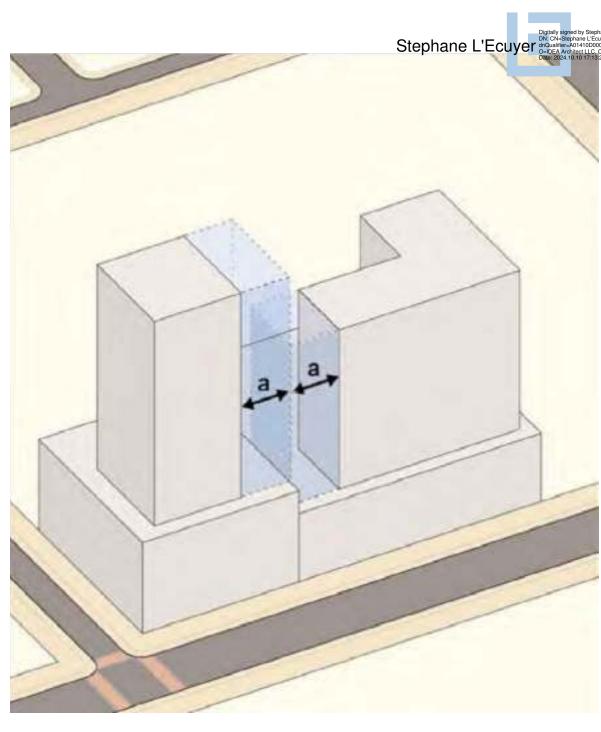

VERTICAL OPEN SPACE BETWEEN TOWERS ON ADJACENT LOTS: TOWERS ARE ENCOURAGED TO MAINTAIN VERTICAL OPEN SPACE ALONG SIDE AND REAR LOT LINES: MINIMUM HORIZONTAL DISTANCE 'A' = 30 FEET*

> VERTICAL OPEN SPACE DESIGN GUIDELINES



ENCOURAGE 15' MINIMUM FLOOR TO FLOOR HEIGHT AND, ENCOURAGE INTERIOR GROUND FLOOR FLUSH WITH ADJACENT PUBLIC SIDEWALK

> STOREFRONT DESIGN GUIDELINES







ENCOURAGE PEDESTRIAN SHADING DEVICES OF VARIOUS TYPES (MIN. 5' DEPTH)


PEDESTRIAN SHADING DEVICE DESIGN GUIDELINES A-002 SCALE: NTS



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TO THE BEST OF MY KNOWLEDGE, THE PLANS AND SPECIFICATIONS COMPLY WITH THE APPLICABLE MINIMUM BUILDING CODES AND THE APPLICABLE FIRE-SAFETY STANDARDS AS DETERMINE BY THE LOCAL AUTHORITY IN ACCORDANCE WITH THIS SECTION AND 633 FLORIDA






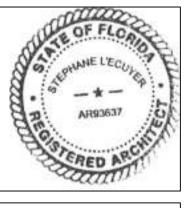

REV.	DATE	DESCRIPTION
01	10-13-2023	D.R.C. SUBMITTAL
02	12-21-2023	REV. 1 COMMENTS
03	04-23-2024	REV. 2 COMMENTS
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05	10-10-2024	REV. 4 COMMENTS

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BAM PROPERTY DEVELOPMENT LLC 1044 BROADWAY, WOODMERE, NY 11598

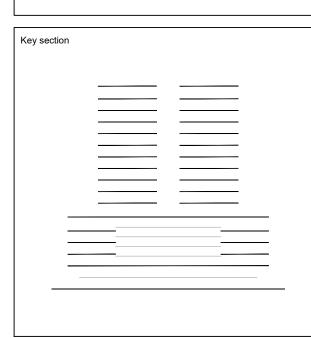650 N ANDREWS MIXED-USE 650 NORTH ANDREWS AVENUE,

FORT LAUDERDALE, FL 33311

BUILDING DESIGN GUIDELINES ARCHITECTURE

as shown S. L'ecuyer 10-10-2024


Project Manager N. TREMBLAY

22-855

NORTH ANDREWS AVENUE - STREET DESIGN EXAMPLE & PROPOSED STREET DESIGN





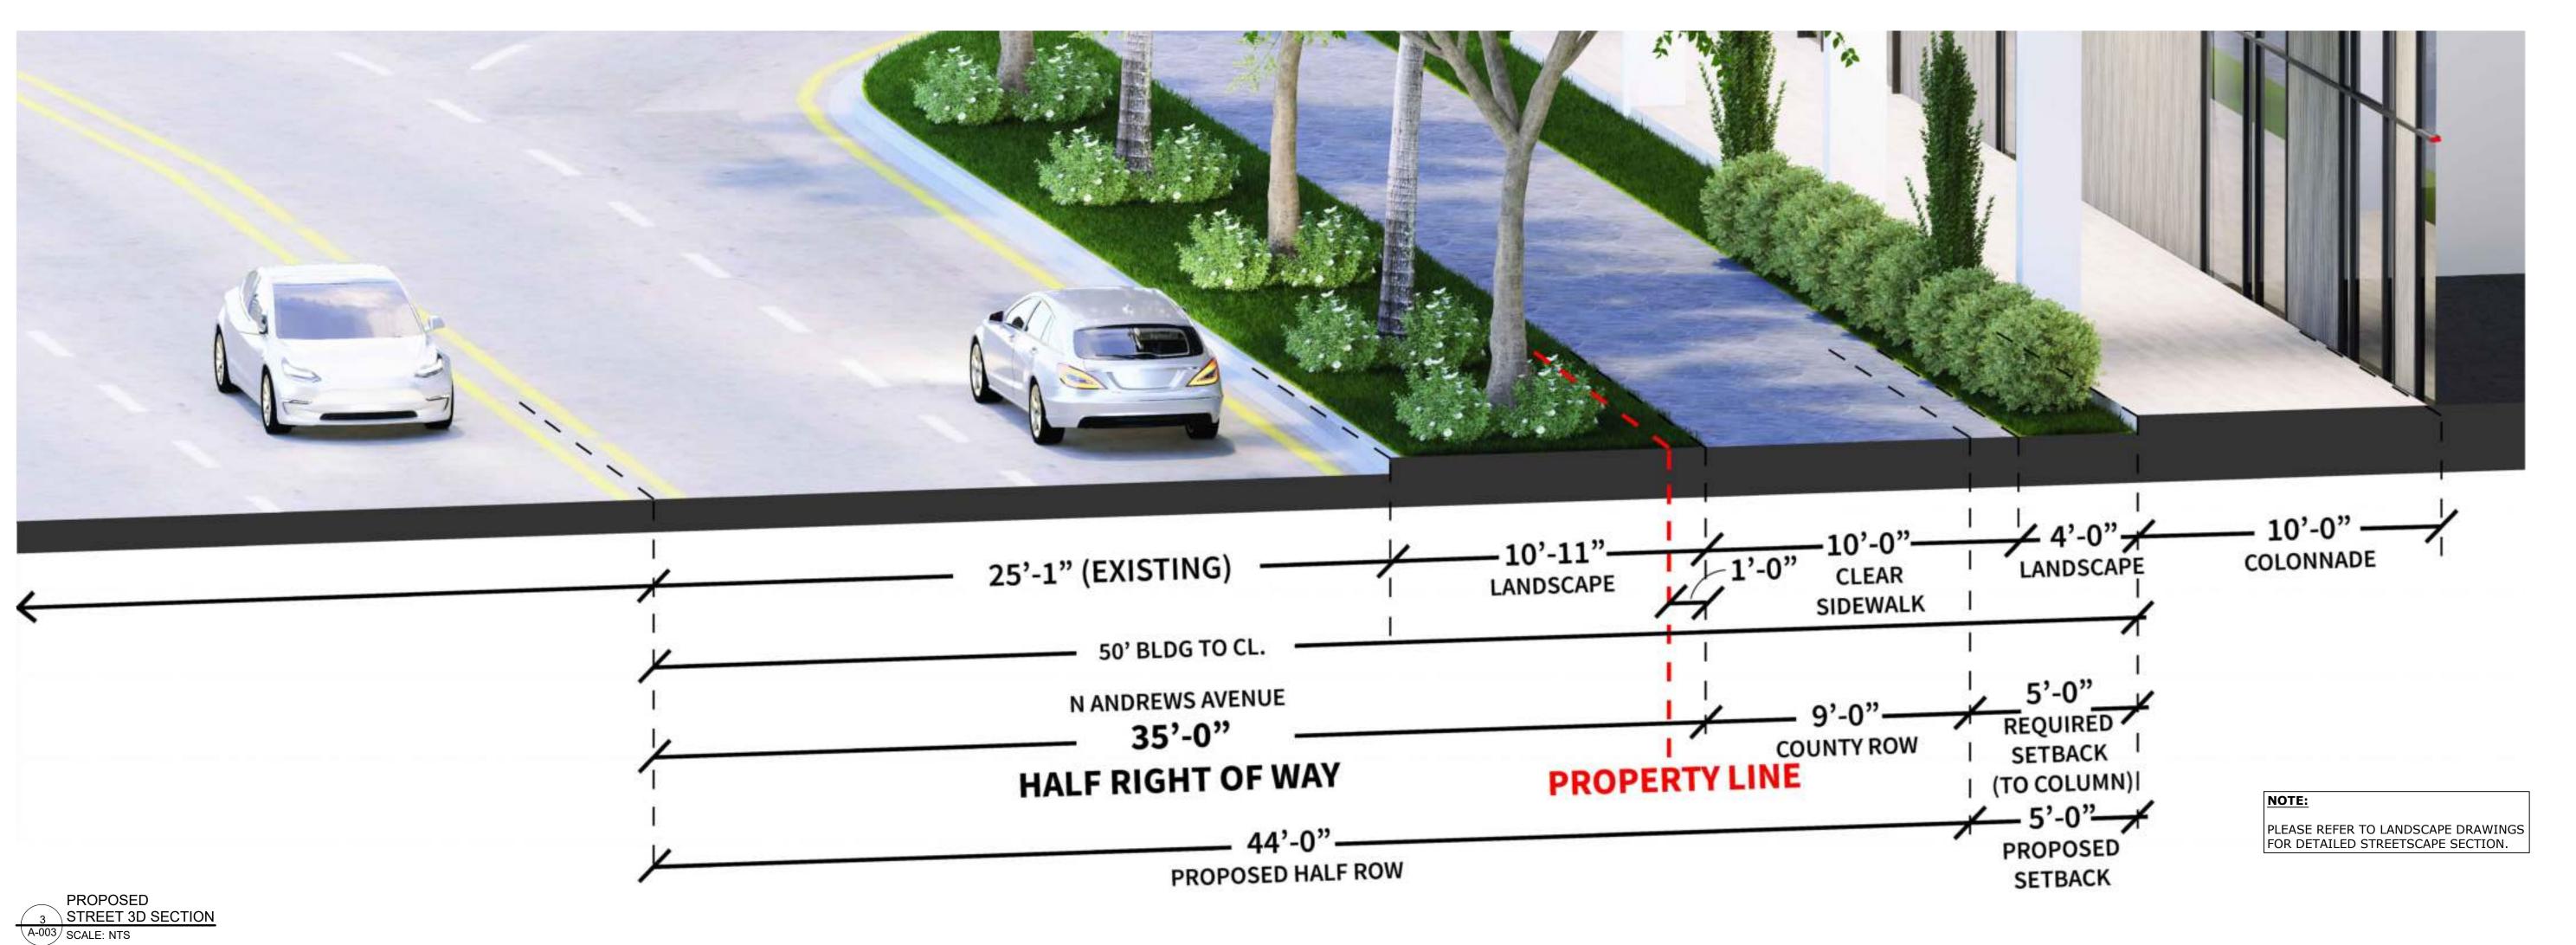



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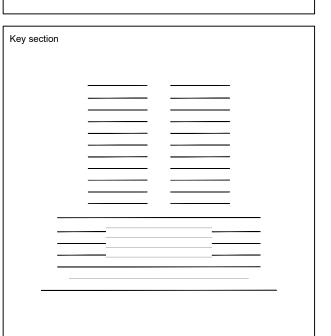
STEPHANE L'ECUYER AR 93637





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BAM PROPERTY DEVELOPMENT LLC 1044 BROADWAY, WOODMERE, NY 11598

650 N ANDREWS MIXED-USE 650 NORTH ANDREWS AVENUE, FORT LAUDERDALE, FL 33311

NORTH ANDREWS AVENUE STREET DESIGN ARCHITECTURE

JF. Gervais S. L'ecuyer

Project Manager N. TREMBLAY A-003 22-855


as shown

10-10-2024

NE 7TH STREET - STREET DESIGN EXAMPLE & PROPOSED STREET DESIGN





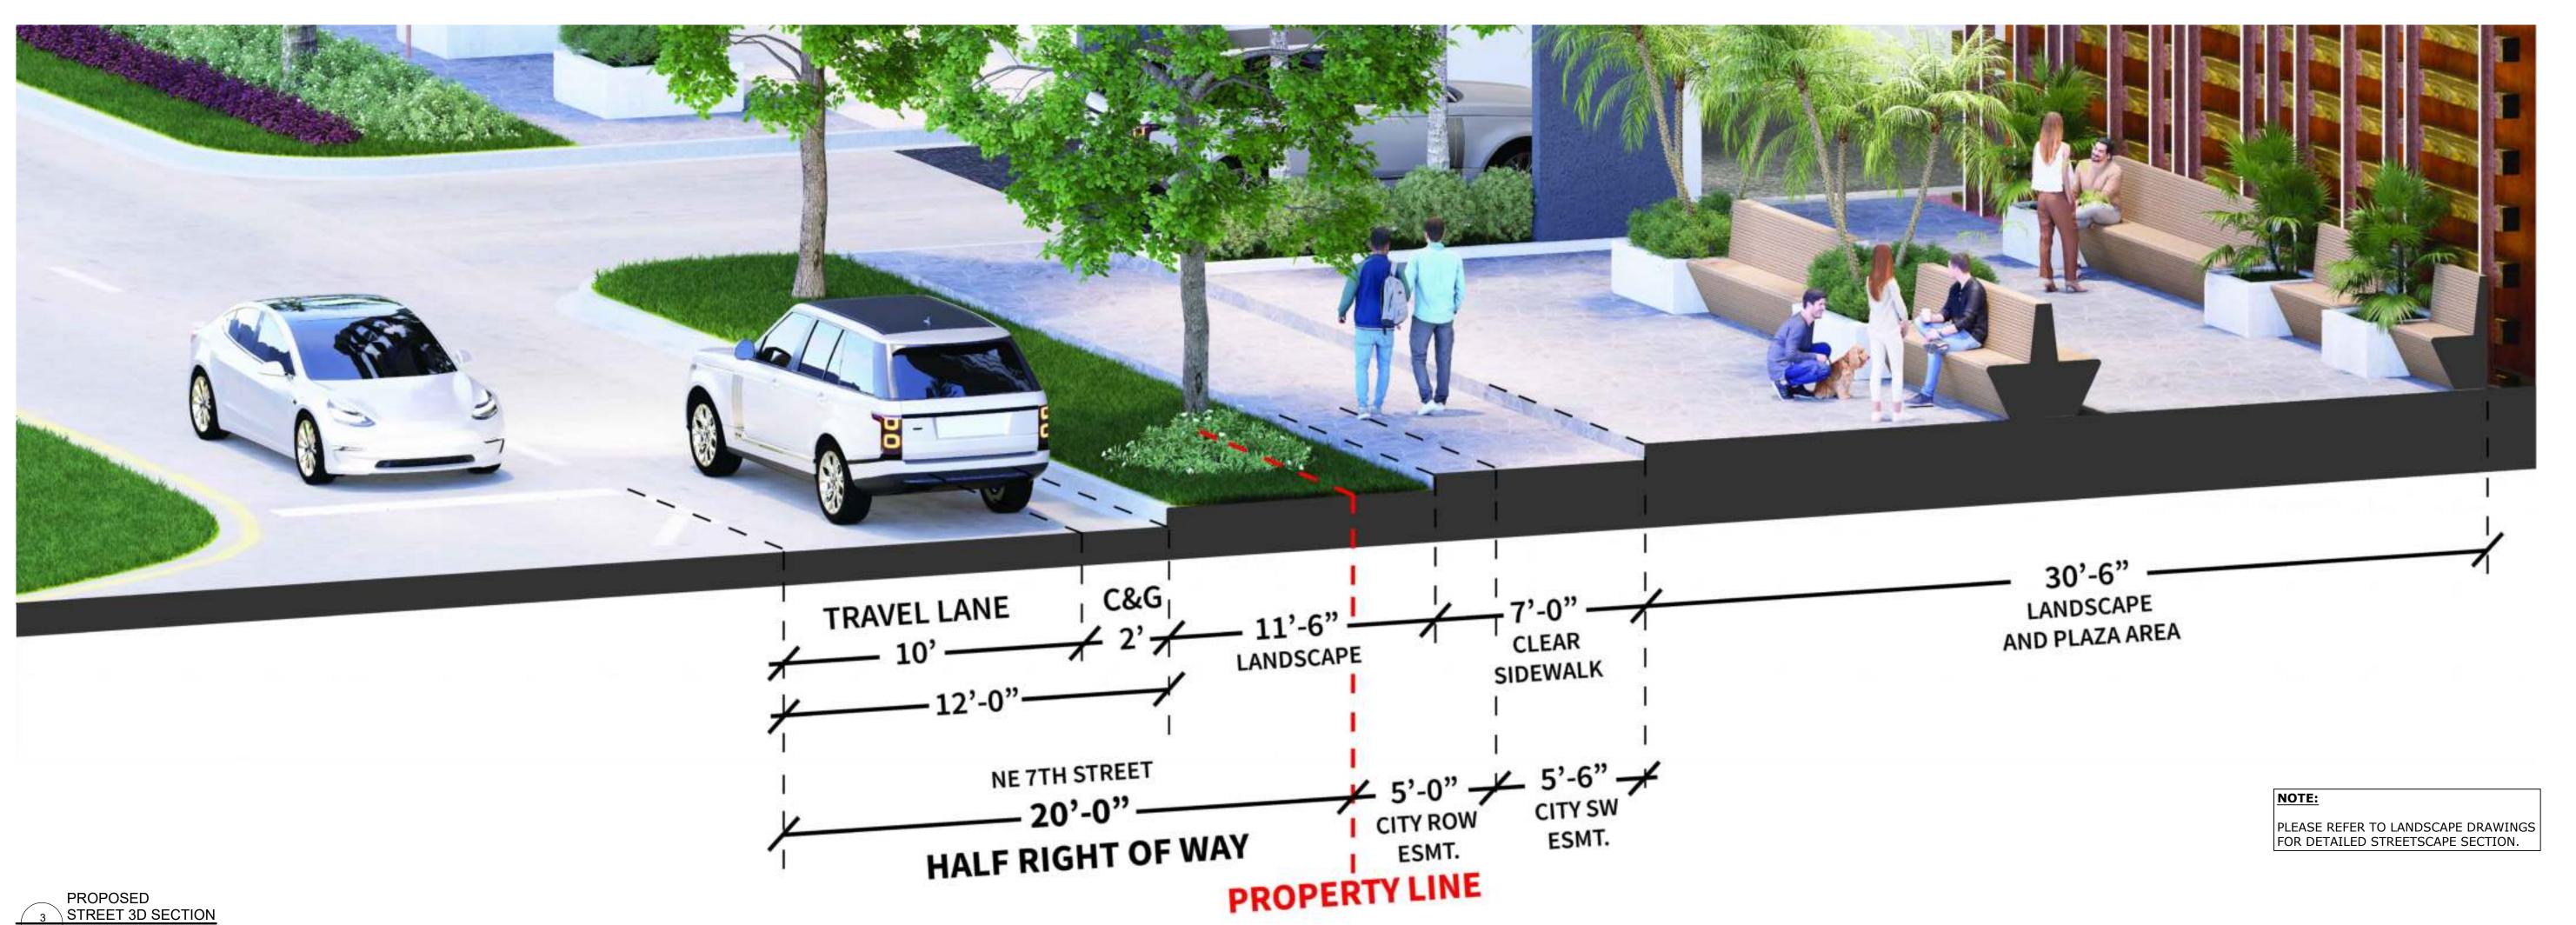

A-004 SCALE: NTS




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SEAL

TO THE BEST OF MY
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APPLICABLE MINIMUM
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APPLICABLE FIRE-SAFETY
STANDARDS AS DETERMINED
BY THE LOCAL AUTHORITY IN
ACCORDANCE WITH THIS
SECTION AND 633 FLORIDA
STATUES.

STEPHANE L'ECUYER
AR 93637




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BAM PROPERTY DEVELOPMENT LLC 1044 BROADWAY, WOODMERE, NY 11598

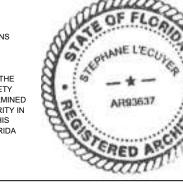650 N ANDREWS MIXED-USE 650 NORTH ANDREWS AVENUE, FORT LAUDERDALE, FL 33311

NE 7TH STREET
STREET DESIGN

Drawn
Field
J. WU
ARCHITECTURE
Verified
Scale

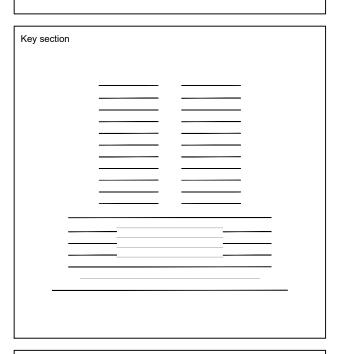JF. Gervais as shown
Approved Date
S. L'ecuyer 10-10-2024

Project Manager

N. TREMBLAY

Project

22-855


A-004

M # 24-1102 Exhibit 3

NE 1ST AVENUE - STREET DESIGN EXAMPLE & PROPOSED STREET DESIGN





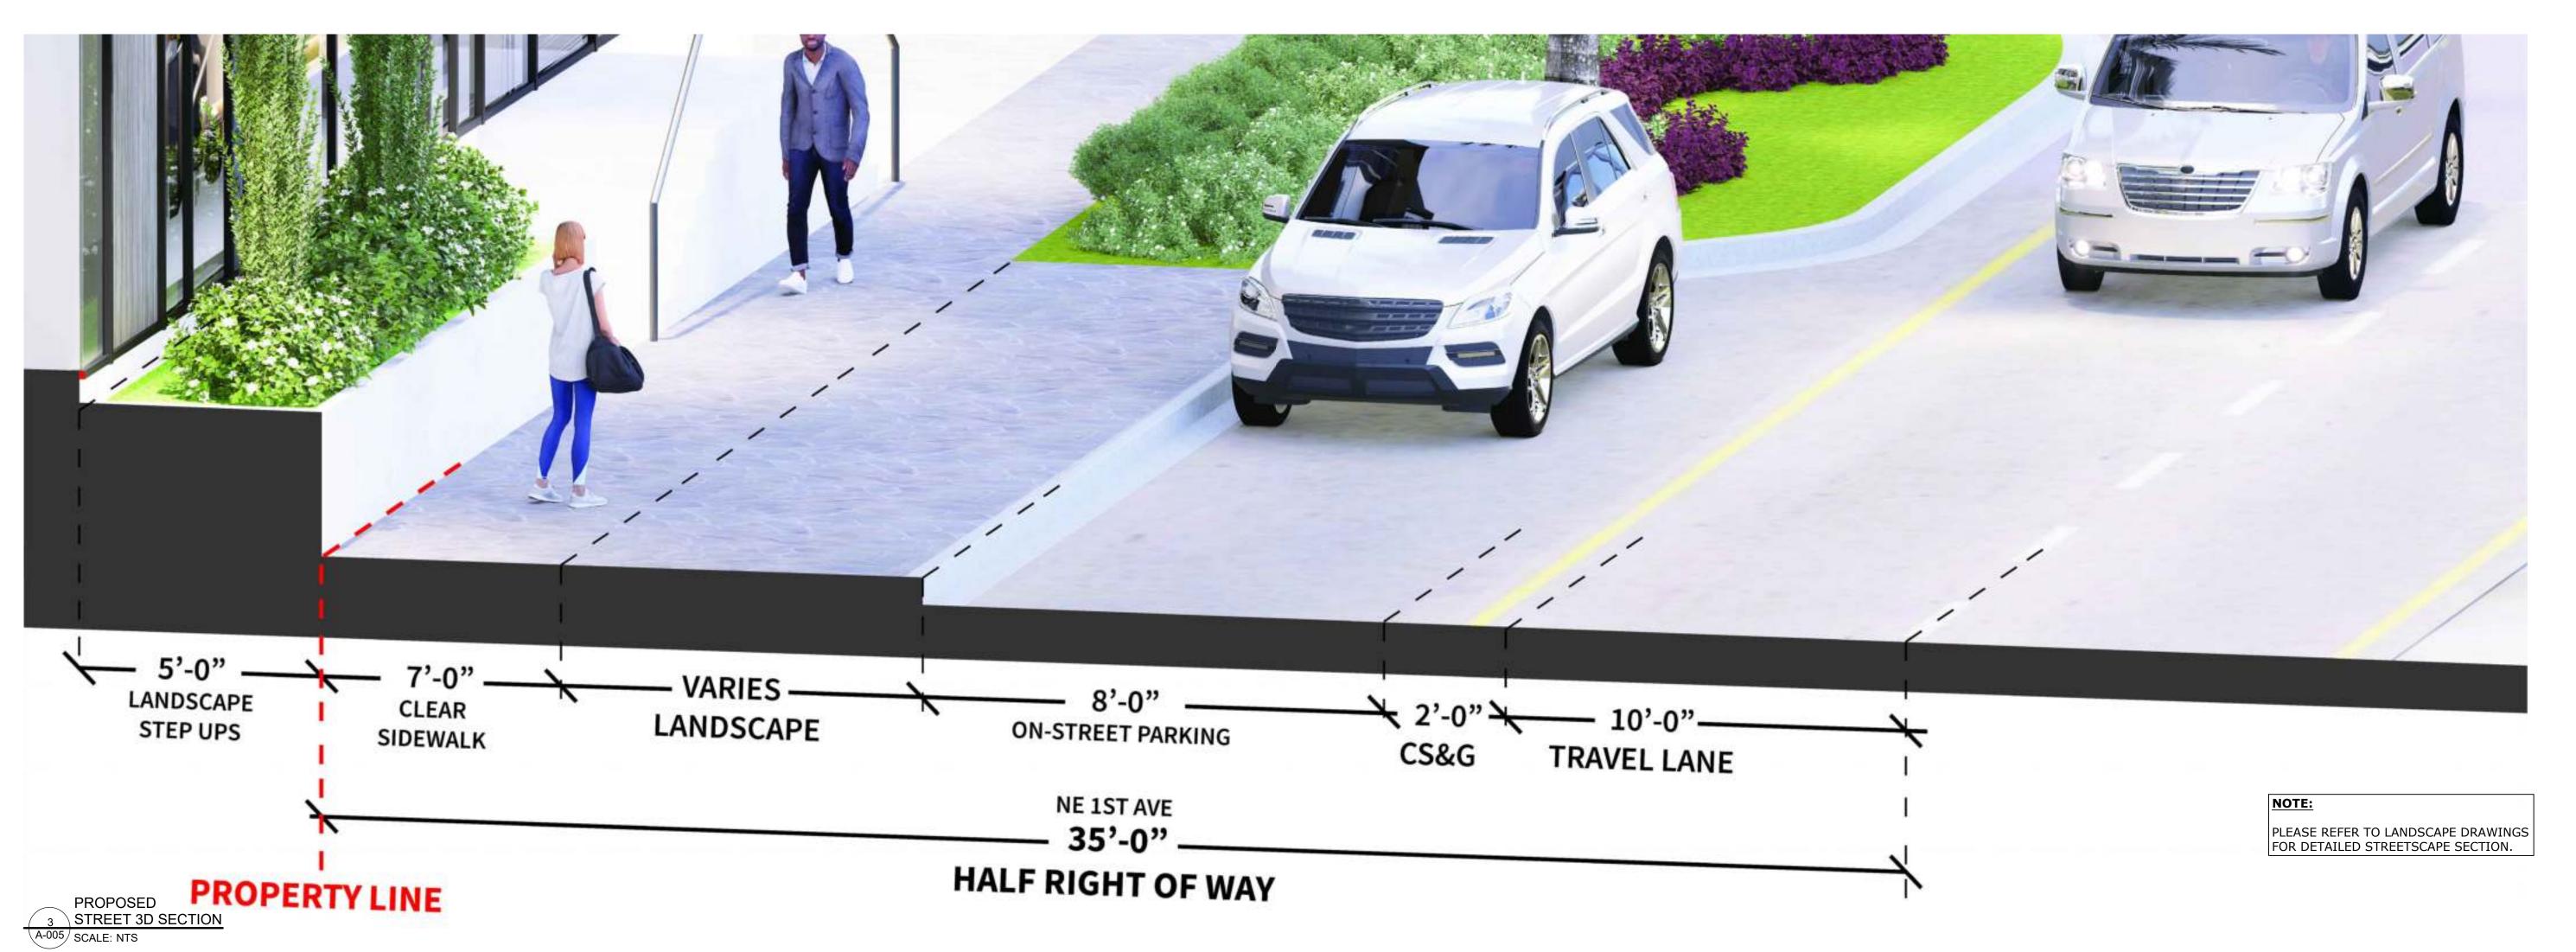



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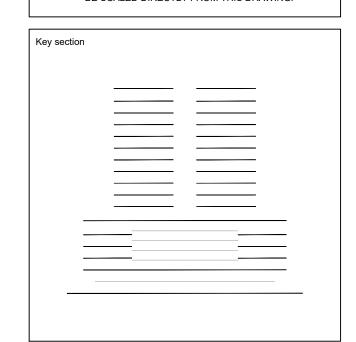
TO THE BEST OF MY KNOWLEDGE, THE PLANS AND SPECIFICATIONS COMPLY WITH THE
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BUILDING CODES AND THE APPLICABLE FIRE-SAFETY STANDARDS AS DETERMINED BY THE LOCAL AUTHORITY IN ACCORDANCE WITH THIS SECTION AND 633 FLORIDA STEPHANE L'ECUYER AR 93637



AND USE : DEVELOPMENT : POLITICA STRATEGY - PROCUREMENT

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BAM PROPERTY DEVELOPMENT LLC 1044 BROADWAY, WOODMERE, NY 11598

650 N ANDREWS **MIXED-USE** 650 NORTH ANDREWS AVENUE, FORT LAUDERDALE, FL 33311

NE 1ST AVENUE STREET DESIGN **ARCHITECTURE** JF. Gervais as shown S. L'ecuyer 10-10-2024


Project Manager N. TREMBLAY 22-855

A-005

FLAGLER DRIVE - STREET DESIGN EXAMPLE & PROPOSED STREET DESIGN





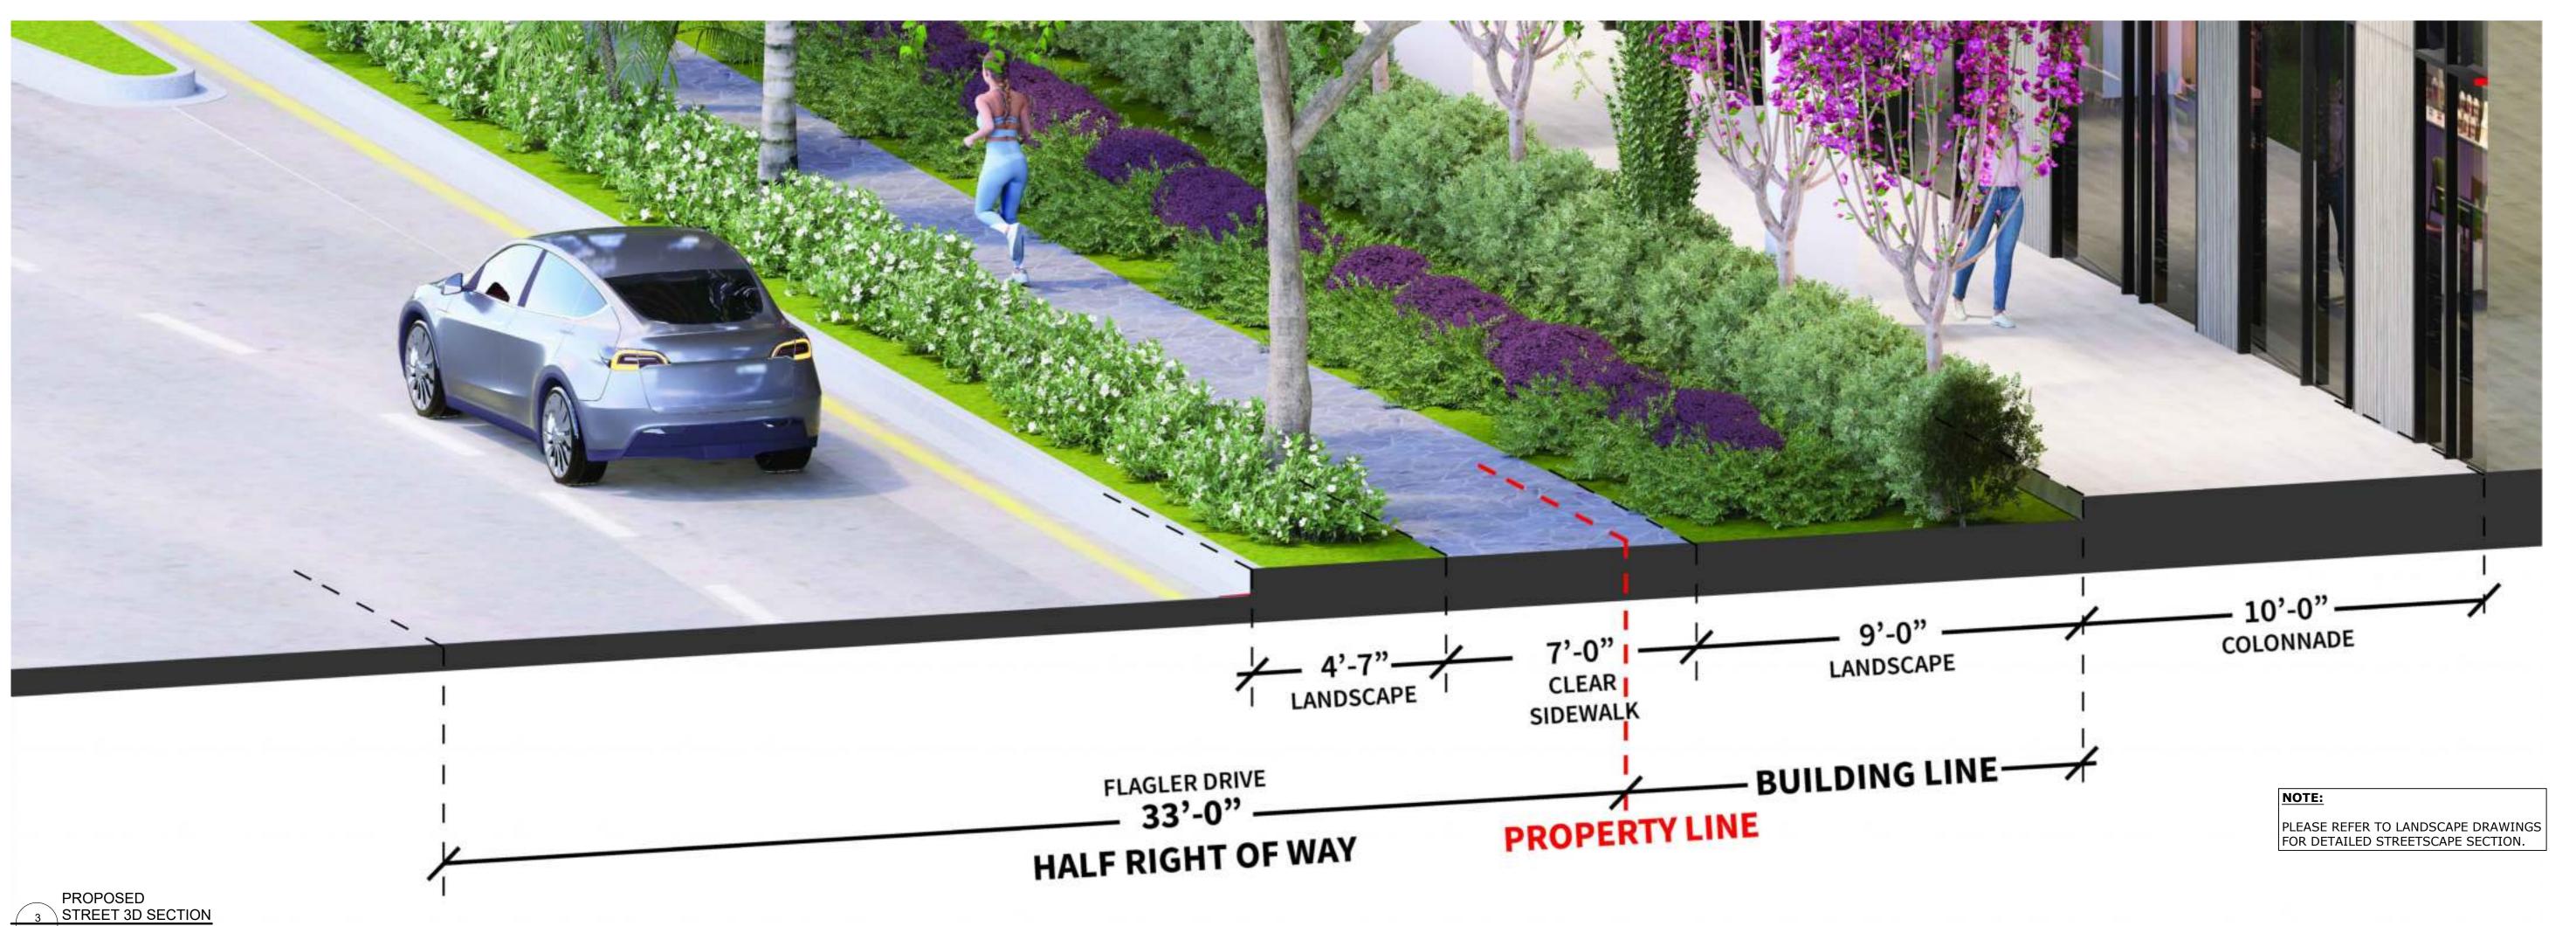

A-006 SCALE: NTS



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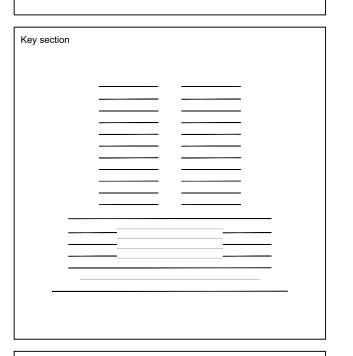
3323 NE 163rd Street, Suite 200 North Miami Beach, FL 33160 (t) 305.792.0015 (f) 305.931.0279 (@) info@absolute-idea.com

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BAM PROPERTY DEVELOPMENT LLC 1044 BROADWAY, WOODMERE, NY 11598

650 N ANDREWS MIXED-USE 650 NORTH ANDREWS AVENUE, FORT LAUDERDALE, FL 33311

_	ER DRIVE T DESIGN
Drawn	Field
J. WU	ARCHITECTURE
Verified	Scale
JF. Gervais	as shown
Approved	Date
S. L'ecuyer	10-10-2024
Project Manager	Dwg. no.

N. TREMBLAY

22-855

A-006






 CANAL PARK

 3323 NE 163rd Street, Suite 200
 North Miami Beach, FL 33160

 (t) 305.792.0015
 (f) 305.931.0279


 (@) info@absolute-idea.com

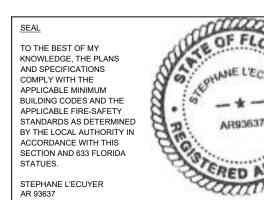



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BAM PROPERTY DEVELOPMENT LLC 1044 BROADWAY, WOODMERE, NY 11598

650 N ANDREWS MIXED-USE 650 NORTH ANDREWS AVENUE, FORT LAUDERDALE, FL 33311

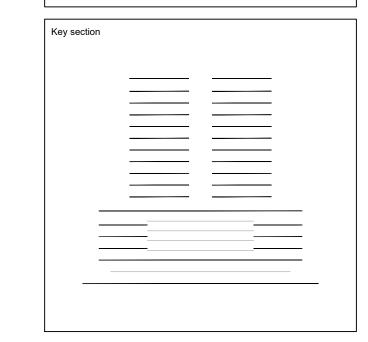_	EPTUAL S SECTION
Drawn	Field
J. WU	ARCHITECTURE
Verified	Scale
JF. Gervais	as shown
Approved	Date
S. L'ecuyer	10-10-2024
Project Manager	Dwg. no.
N. TREMBLAY	A 000
Project 22-855	A-008


		то	OWER SETBACK				60'-0"				TOWER SETBACK		
		SE	EE ELEVATIONS	V	VEST TO)WER	TOWER SEPARATION	EAST	TOWE	R	SEE ELEVATIONS		
		1111											
	1-1-0"	ERTY LIN		///////////////////////////////////////	/ / / / / / / / / / / / / / / / / / /	UNITS ////////		//////////////////////////////////////	RESIDENTIAL UNITS			11'-0"	175'-0" \ ROOF 182.4 N
	10-0"	PROP		///////////////////////////////////////	10 (X) RESIDENTIAL UNITS		11 (X) F	RESIDENTIAL UNITS		PROPI		164'-0"	
	10-0"			//////////////////////////////////////	UNITS //////////	//////////////////////////////////////		///////	10-0.	LEVEL 13 (144'-0" √ 151.4 N			
	100.					ÚNÍTS		//////////////////////////////////////				100	134'-0" 141.4 N
	10-0"					11111111111						10-0	124'-0" \\ LEVEL 10
	113:-0"			////////	/ / 10 (X) RESIDENTIAL	UNITS		///////////11/(X) [*] F	RESIDENTIAL UNITS	////////		113:-0"	114'-0" \ LEVEL 9
	10-0	PODIUM SETBACK SEE SEE ELEVATIONS	TOWER STEP-BACK SEE S ELEVATIONS	///////////////////////////////////////		///////////////////////////////////////		11 (X) F	RESIDENTIAL UNITS	///////// ///////// ///////	TOWER PODII STEP-BACK SETBA SEE SEE ELEVATIONS ELEVAT	E	104'-0" \ LEVEL 8
	0-01			1//////////////////////////////////////	/ 10 (X) RESIDENTIAL				RESIDENTIAL UNITS	////////		10-10-1	94'-0" V LEVEL 7
	-0-	1			//////////////////////////////////////			11'(X) F	RESIDENTIAL UNITS RESIDENTIAL UNITS			- 10.	84'-0" V 91.4 N
		-			10 (X) RESIDENTIAL	AMENITIES		AMENITIES	<u> </u>	//////////////////////////////////////			74'-0" 81.4 N
68'-8" EVEL 4			////////		ENTIAL UNITS	/ / /1,825 SQ.FT./ / / / /	POOL DECK	/ / / / /2,000 \$Q,FT./ / /	9 (X) RESIDE	///////	1///////	1 2 2	62'-0" V LEVEL 4 69.4 N
60'-0" EL P5		+		//////////////////////////////////////	 =	=======	P5 - 77 PARKING SPACES ====================================	=========	:======	//////////////////////////////////////		12.0	50'-0" 57.4 N
50'-0" EL P4 /		†		ENTIAL UNITS / / = = = = = = = = = = = = = = = = =							RESIDENTIAL UNITS		40'-0" V 47.4 N
40'-0" EL P3 30'-0" EL P2	8'-4" - 62'-0"	Ī				P2 - 77 PARKING SPACES			(//////////////////////////////////////	0,		30'-0" 7 37.4 N	
			/ / / / / / / / / / / / / / / 6 (X) PESIDEI	NTIAL UNITS	_=====	_=======	P1 - 48 PARKING SPACES		======	7 (X) RESID	ENTIAL UNITS	0,-0	20'-0" 27.4 N



SIGN LEGEND & NOTE

- S1 SIGNAGE FOR RESTAURANT
- S2 SIGNAGE FOR RETAIL A *
- S3 SIGNAGE FOR WEST TOWER LOBBY
- S4 SIGNAGE FOR RETAIL B *
- S5 SIGNAGE FOR EAST TOWER LOBBY

* IF A RETAIL SPACE IS DIVIDED LATER IN THE DESIGN PROCESS, NEW SIGNAGE WILL BE PROVIDED FOR THE NEW RETAIL SPACE

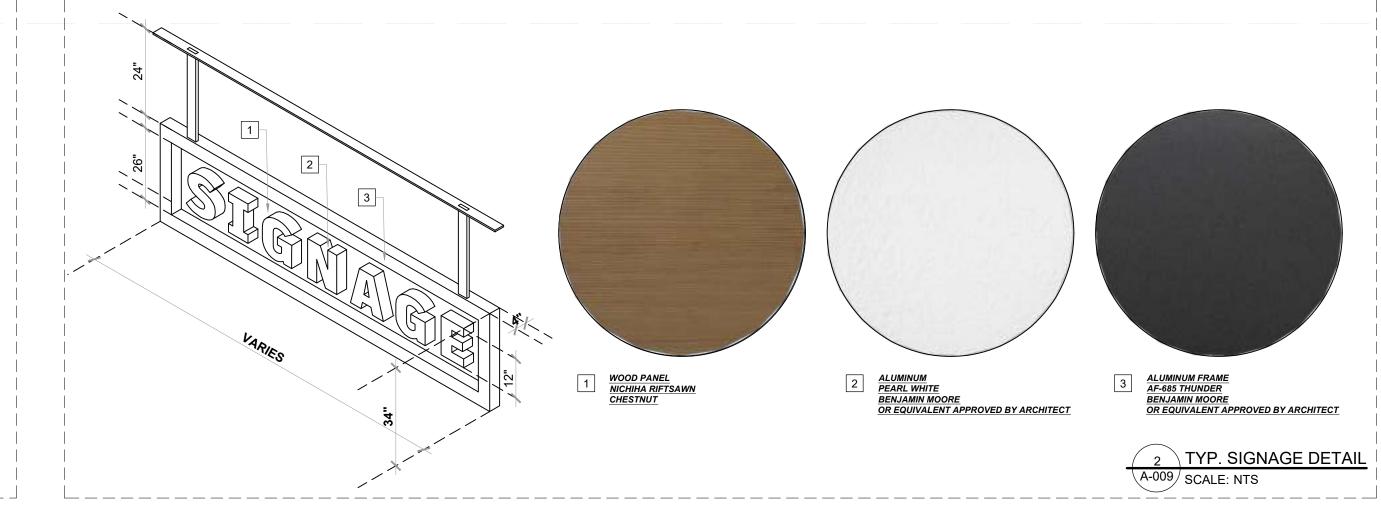



R1-A (S1 SIGNAGE 3D VIEW)



R2-A (S2 SIGNAGE 3D VIEW)



R3-A (S3 SIGNAGE 3D VIEW)



R4-A (S4 SIGNAGE 3D VIEW)





R2-B (S2 SIGNAGE 3D VIEW)



R3-B (S3 SIGNAGE 3D VIEW)



R4-B (S4 SIGNAGE 3D VIEW)




1 SIGNAGE 3D VIEWS A-009 SCALE: 1" = 20'-0"



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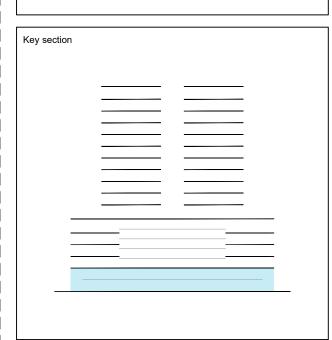
TO THE BEST OF MY KNOWLEDGE, THE PLANS AND SPECIFICATIONS COMPLY WITH THE APPLICABLE MINIMUM
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BAM PROPERTY DEVELOPMENT LLC 1044 BROADWAY, WOODMERE, NY 11598

650 N ANDREWS **MIXED-USE**

650 NORTH ANDREWS AVENUE, FORT LAUDERDALE, FL 33311

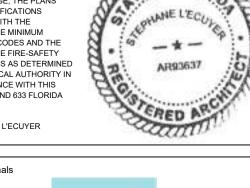
MASTER SIGN PLAN

J. WU **ARCHITECTURE** JF. Gervais as shown

S. L'ecuyer 10-10-2024 Project Manager

N. TREMBLAY A-009 22-855

CAM # 24-1102 Exhibit 3 Page 13 of 66

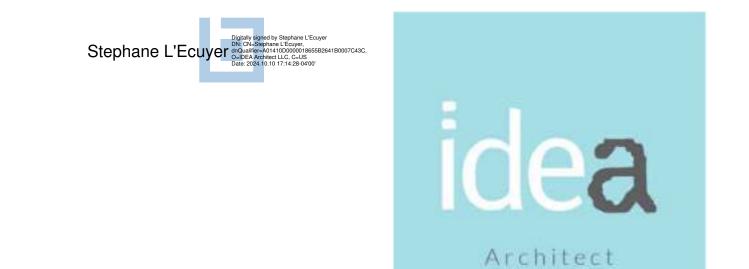


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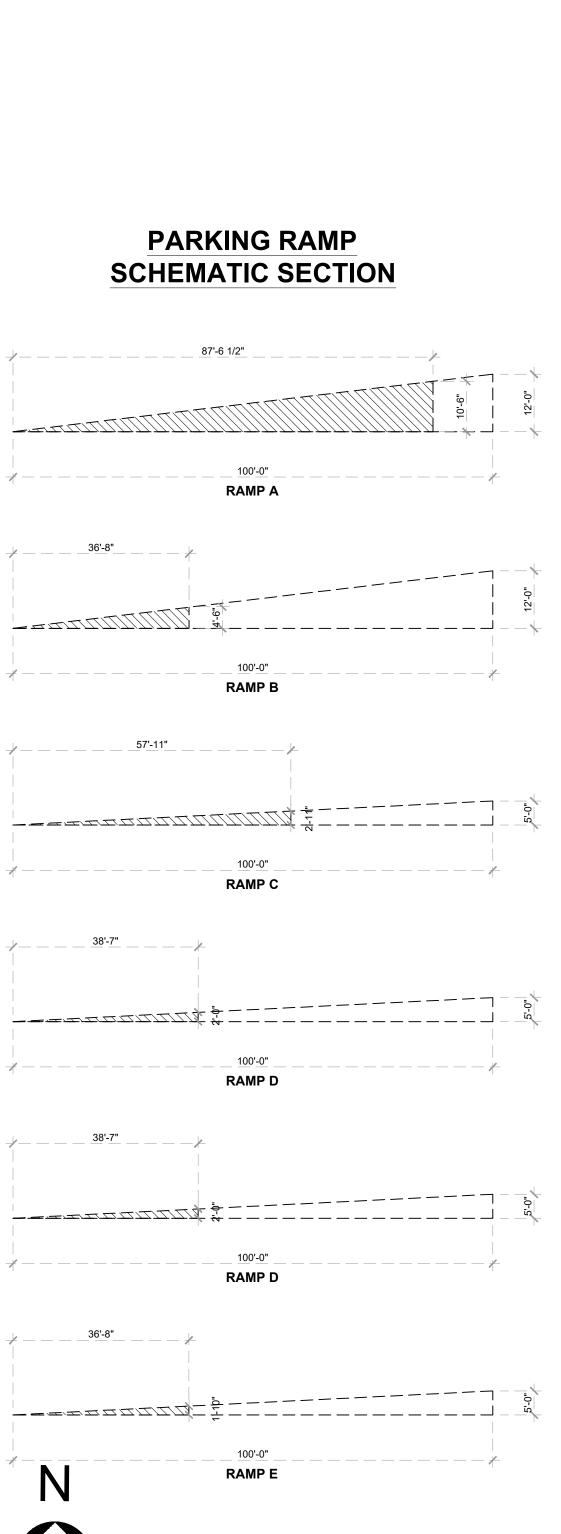



BAM PROPERTY DEVELOPMENT LLC 1044 BROADWAY, WOODMERE, NY 11598



RETAIL & RESIDENTIAL LOFTS GROUND FLOOR PLAN J. WU ARCHITECTURE Verified JF. Gervais as shown S. L'ecuyer 10-10-2024 Project Manager N. TREMBLAY A-201


22-855

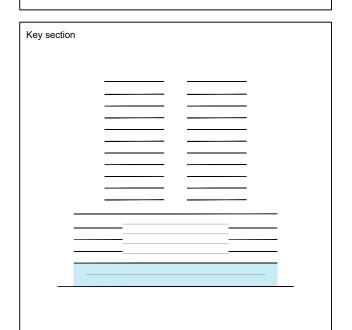


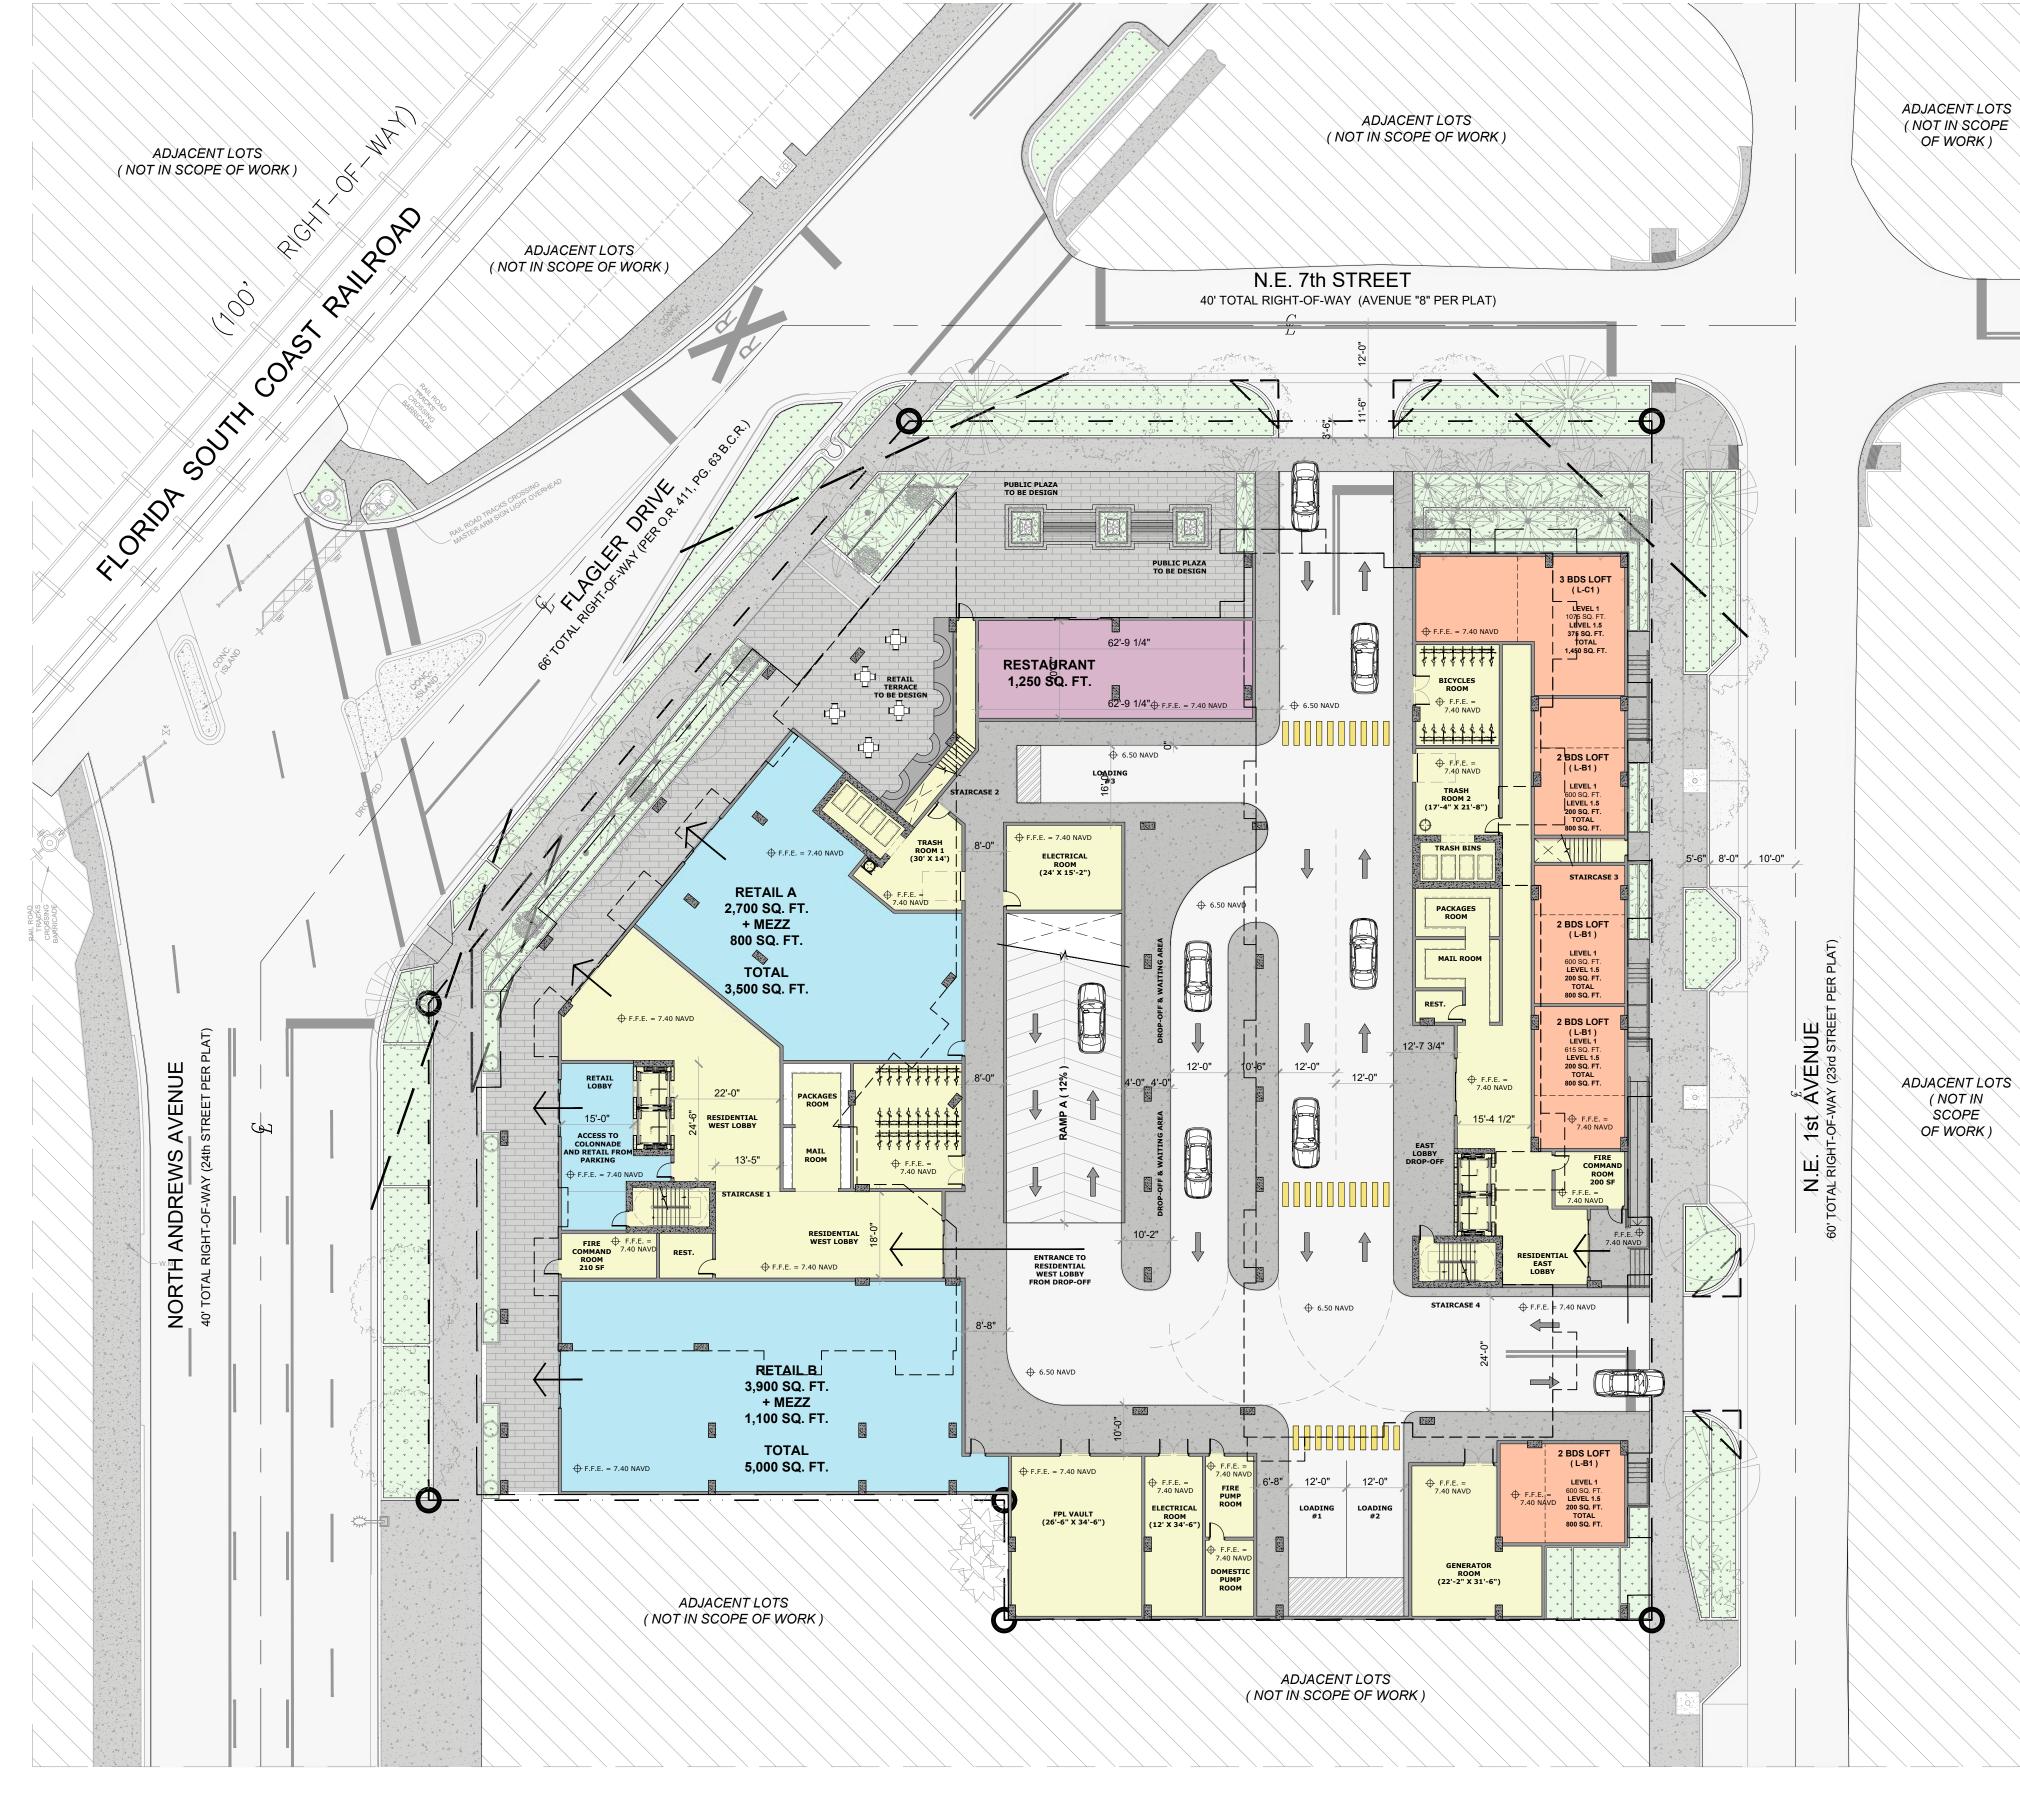

LEVEL 01 **05 RESIDENTIAL UNITS**


11,400 SQ. FT. - RETAIL

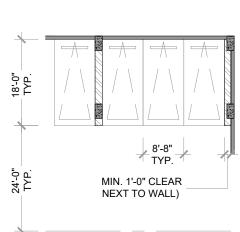

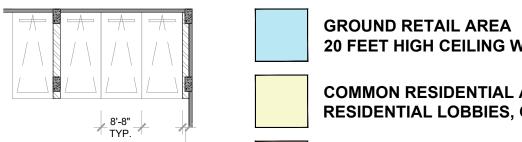

20 FEET HIGH CEILING WITH 30% MEZZANINE COMMON RESIDENTIAL AND SHARED AREA RESIDENTIAL LOBBIES, CIRCULATIONS AND SERVICES RESIDENTIAL UNITS (LOFTS) 20 FEET HIGH CEILING WITH 30% MEZZANINE **GROUND LEVEL RESTAURANT**

20 FEET HIGH CEILING

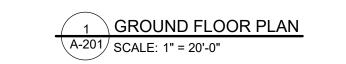










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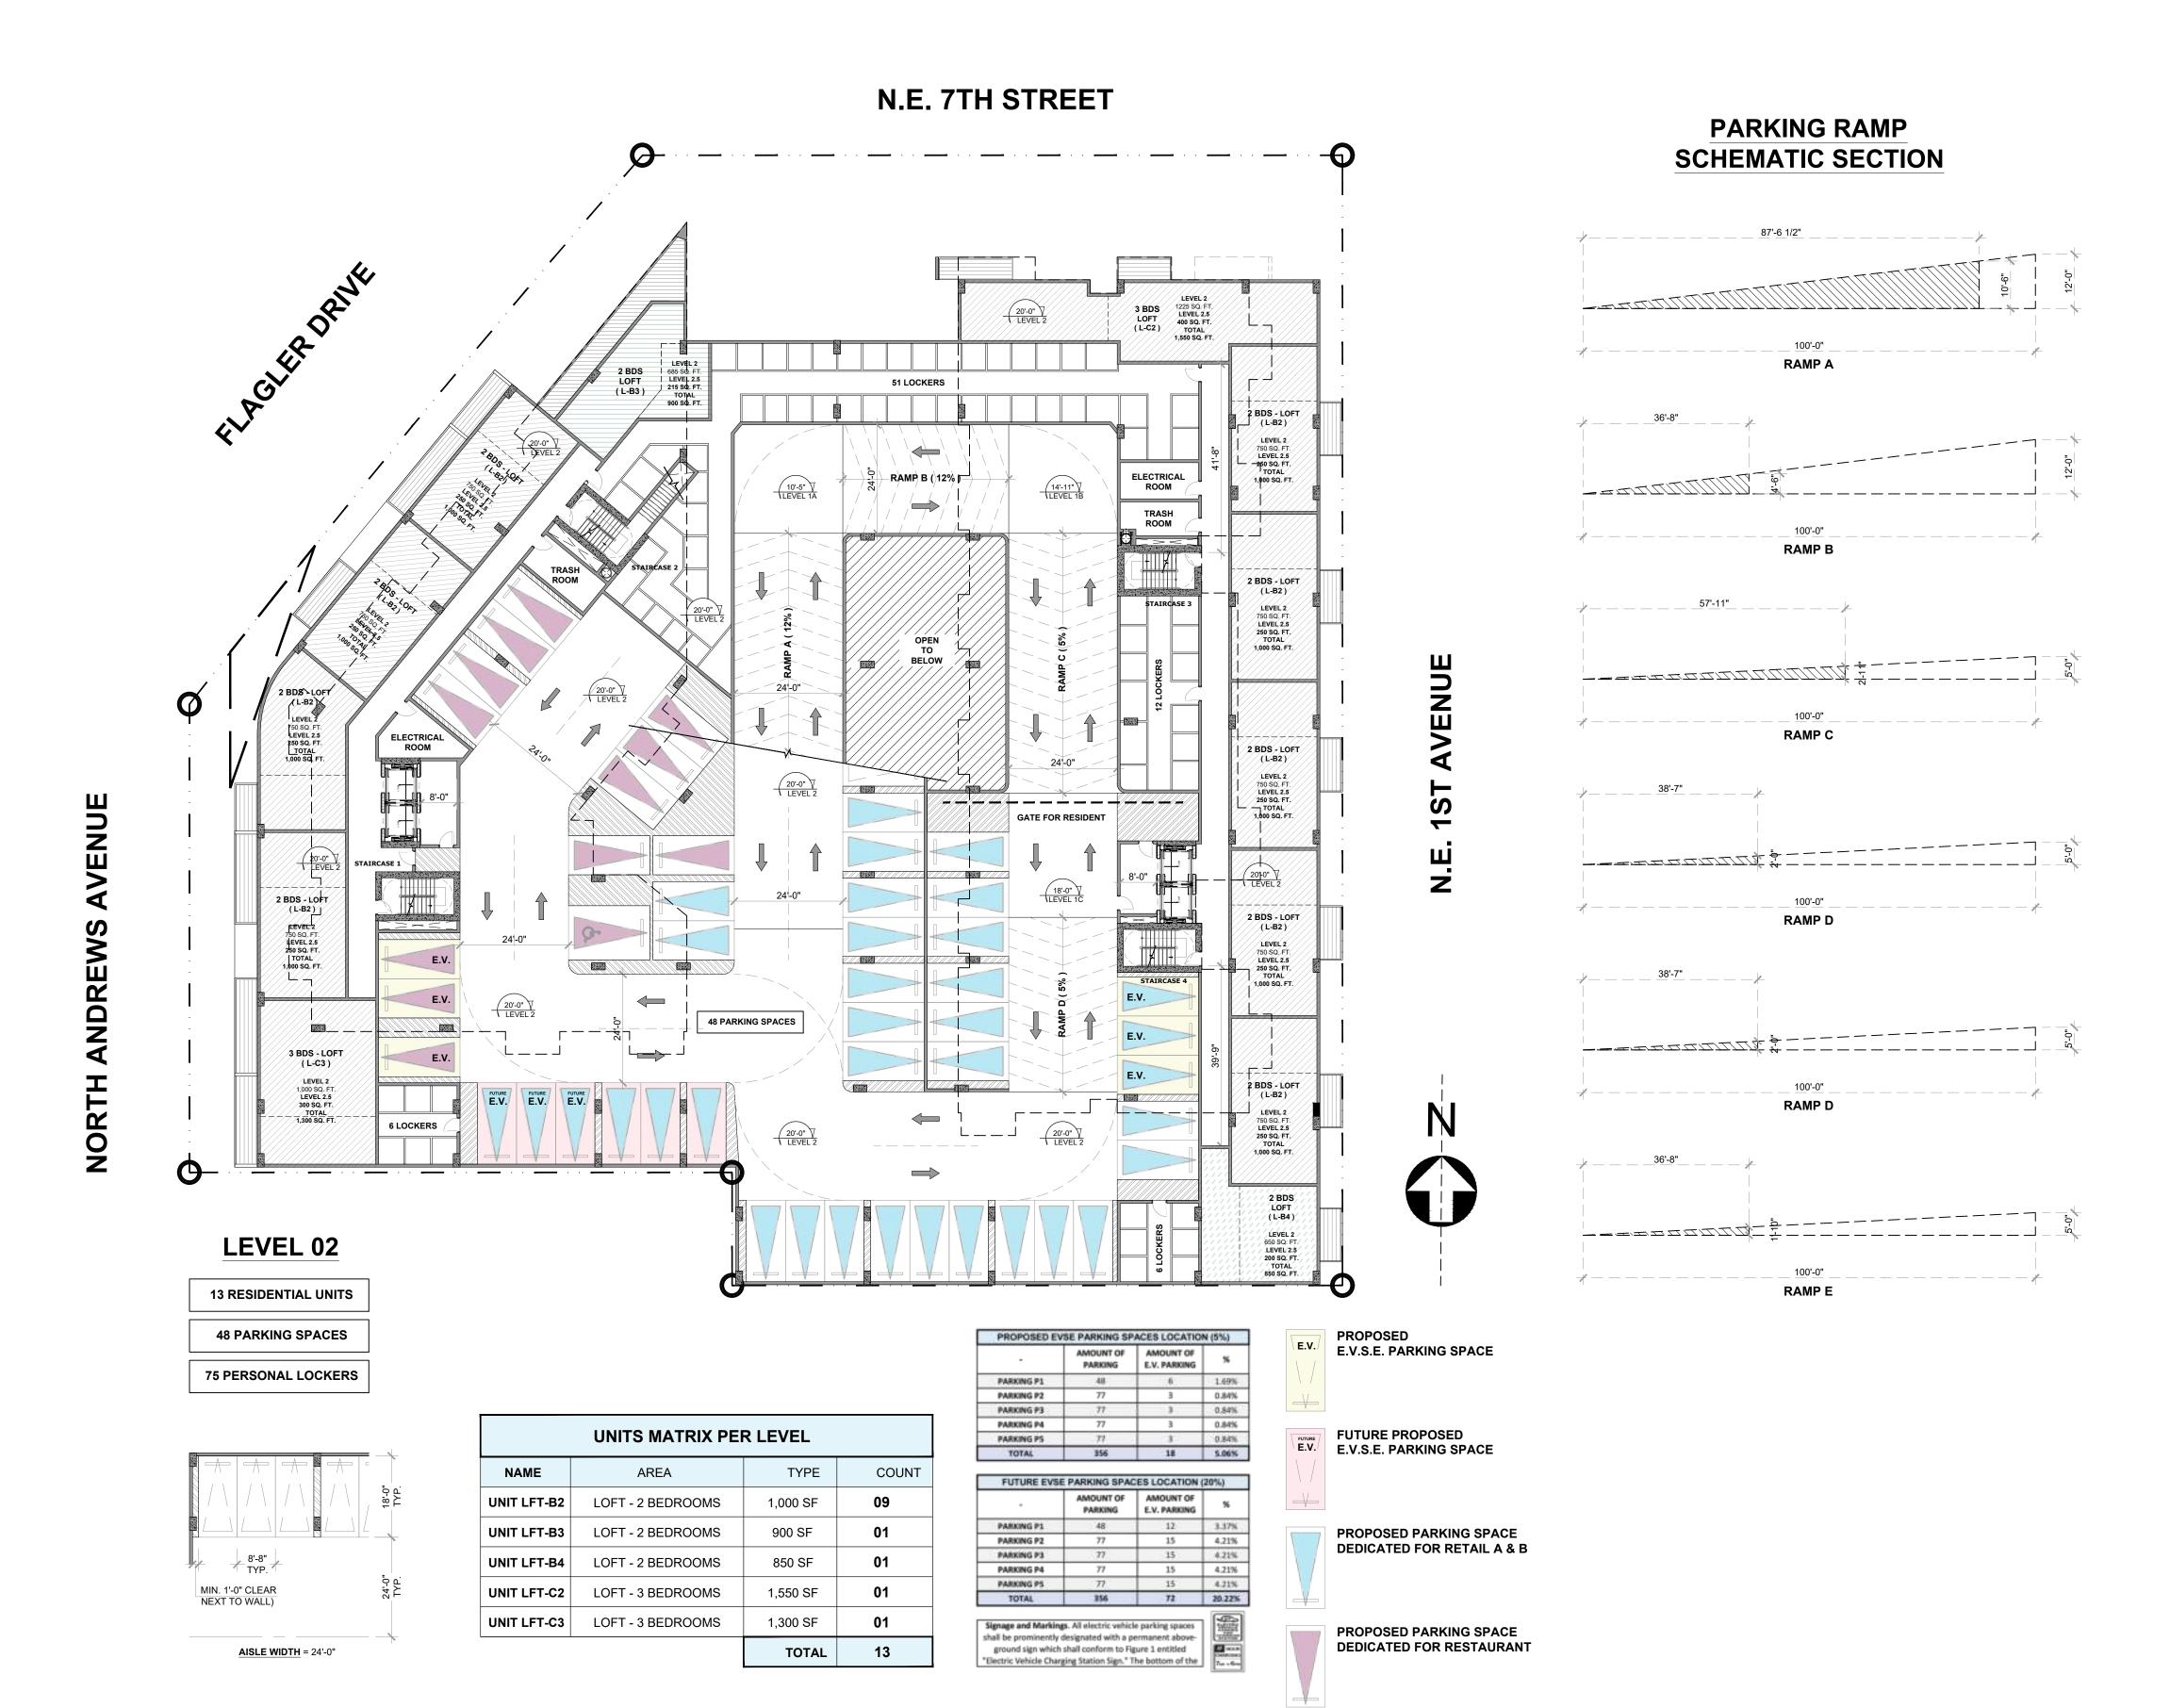


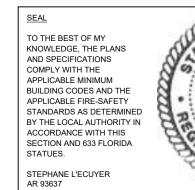BAM PROPERTY DEVELOPMENT LLC 1044 BROADWAY, WOODMERE, NY 11598

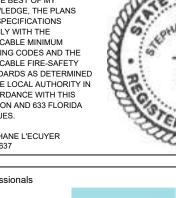650 N ANDREWS **MIXED-USE** 650 NORTH ANDREWS AVENUE, FORT LAUDERDALE, FL 33311

PARKING LAYOUT & LINER **LEVEL 02 FLOOR PLAN** J. WU **ARCHITECTURE** Verified JF. Gervais as shown S. L'ecuyer 10-10-2024 Project Manager

N. TREMBLAY 22-855

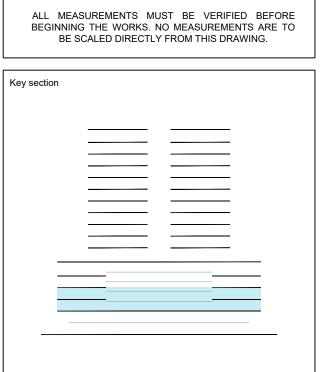







3323 NE 163rd Street, Suite 200 North Miami Beach, FL 33160

TO THE BEST OF MY NO THE BEST OF MY
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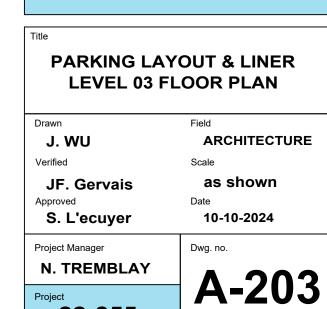
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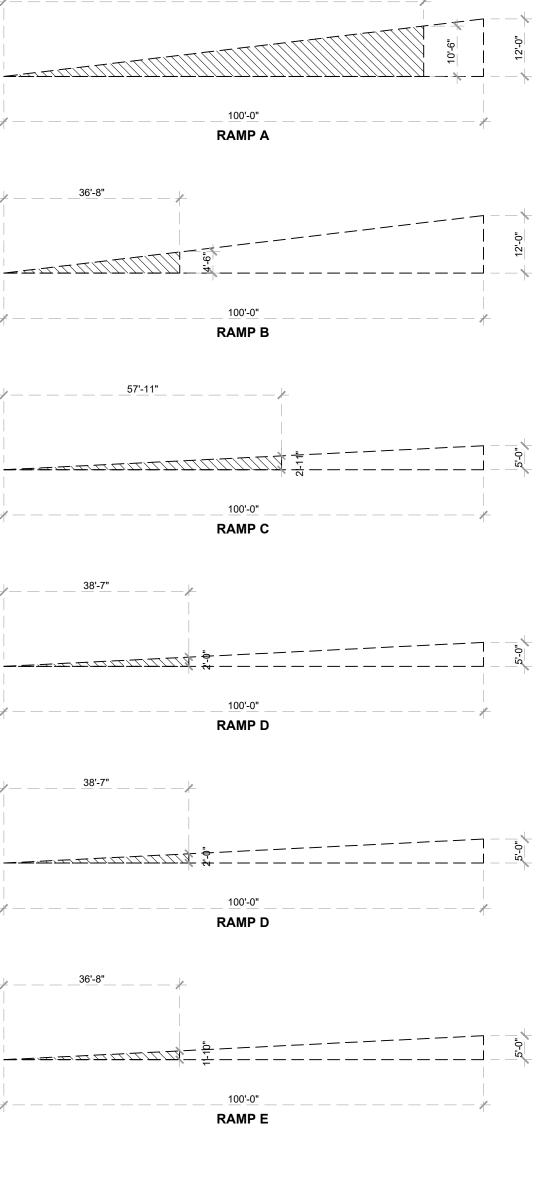




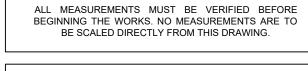


22-855

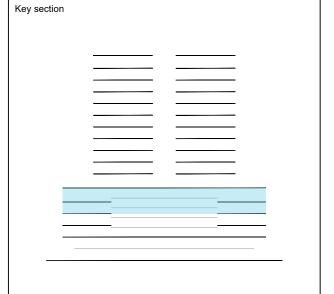



PARKING RAMP

SCHEMATIC SECTION

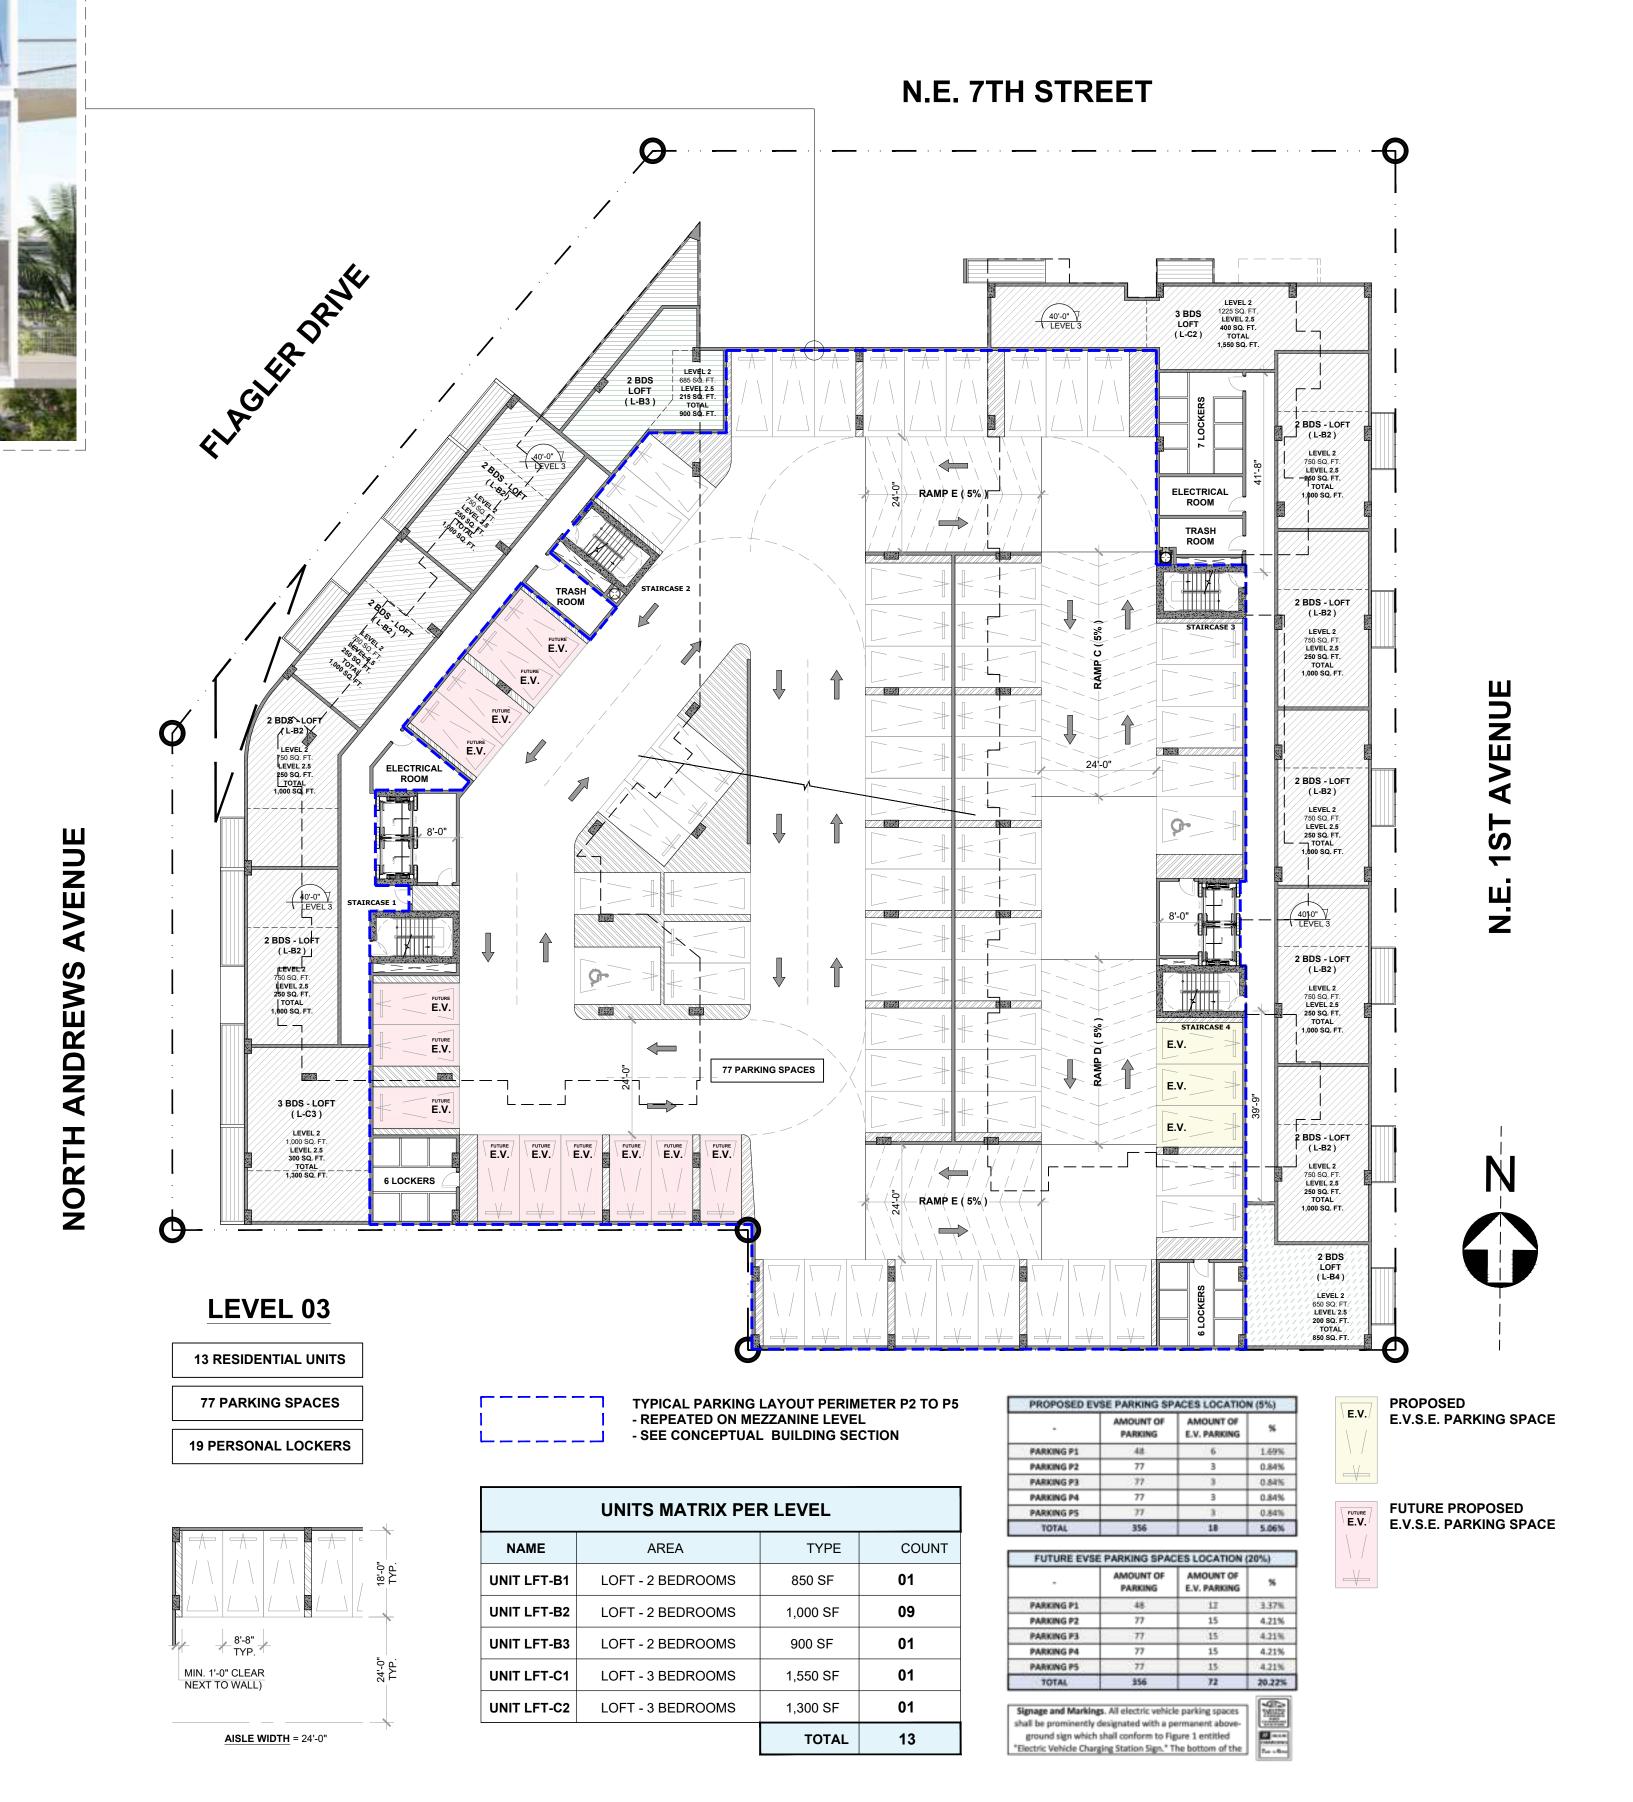



STEEL RAIL

RAILWAY SLEEPER 4" X 8" WOOD

PAINTED STUCCO

8" CONCRETE MASONRY WALL

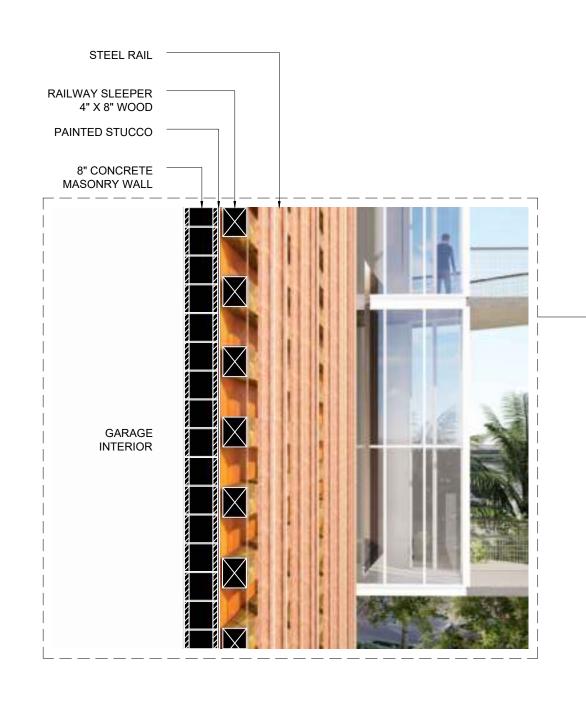

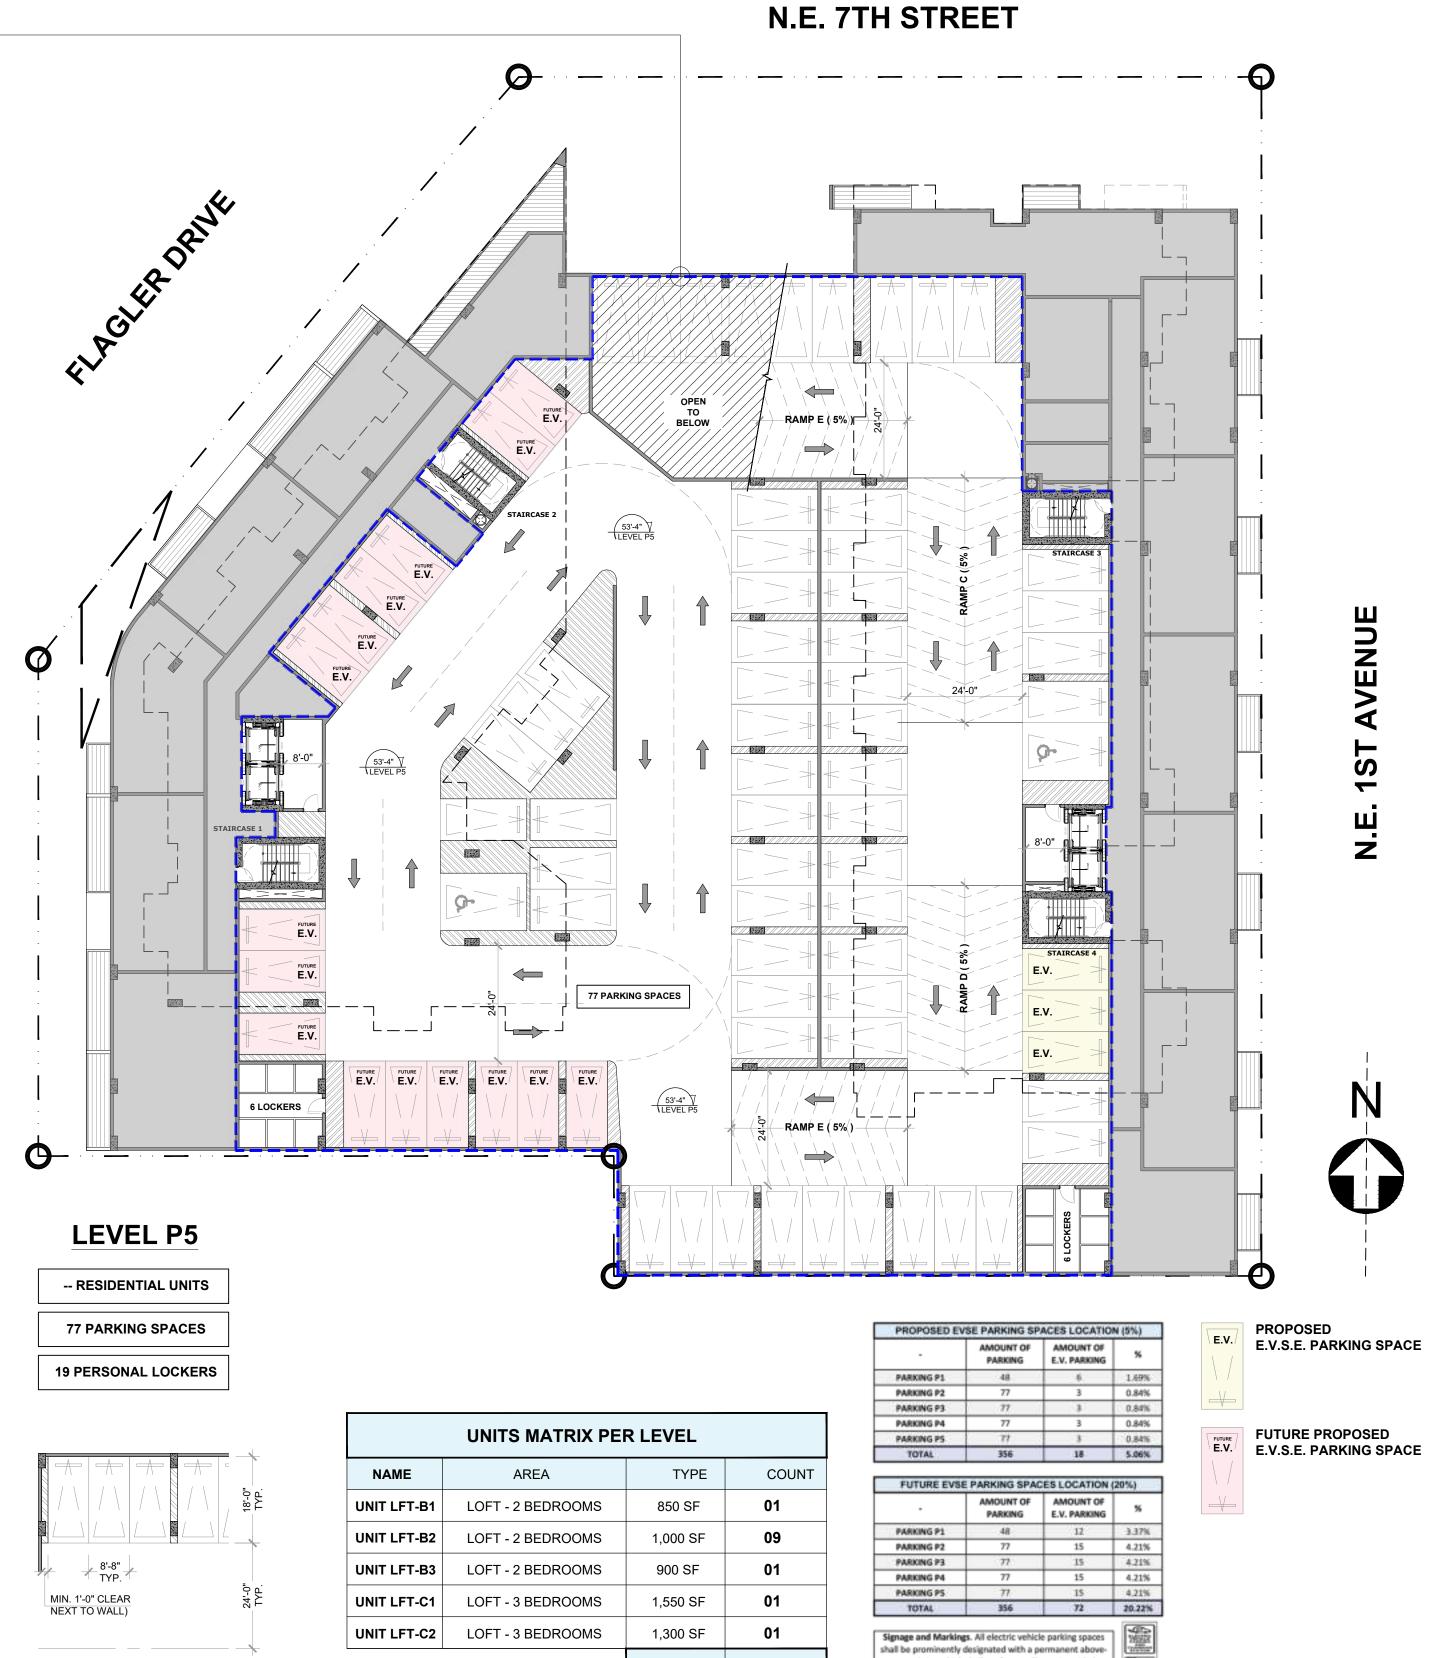


TOTAL

<u>AISLE WIDTH</u> = 24'-0"

ground sign which shall conform to Figure 1 entitled
"Electric Vehicle Charging Station Sign." The bottom of the

PARKING RAMP SCHEMATIC SECTION

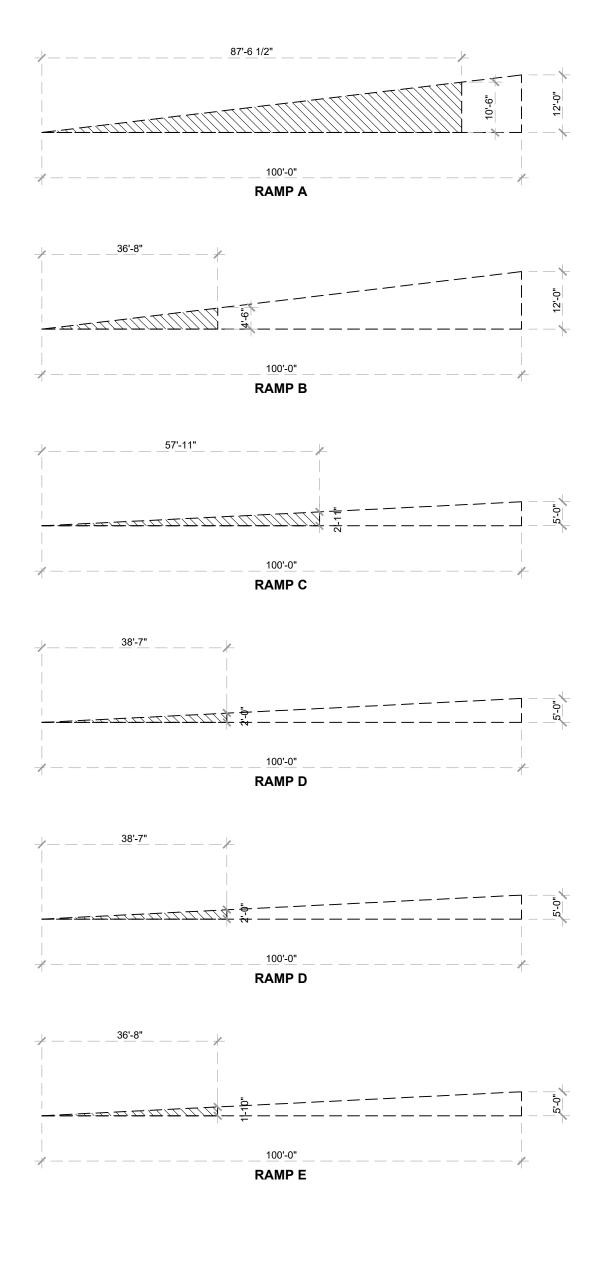





3323 NE 163rd Street, Suite 200 North Miami Beach, FL 33160 (t) 305.792.0015 (f) 305.931.0279 (@) info@absolute-idea.com

TO THE BEST OF MY
KNOWLEDGE, THE PLANS
AND SPECIFICATIONS
COMPLY WITH THE
APPLICABLE MINIMUM
BUILDING CODES AND THE
APPLICABLE FIRE-SAFETY STANDARDS AS DETERMINED BY THE LOCAL AUTHORITY IN ACCORDANCE WITH THIS SECTION AND 633 FLORIDA STATUES. STEPHANE L'ECUYER AR 93637



		<u>, </u>
REV.	DATE	DESCRIPTION
01	10-13-2023	D.R.C. SUBMITTAL
02	12-21-2023	REV. 1 COMMENTS
03	04-23-2024	REV. 2 COMMENTS
04	08-13-2024	REV. 3 COMMENTS
05	10-10-2024	REV. 4 COMMENTS
Ste	phane L'Ec	Digitally signed by Stephane L'Ecuyer DN: CN=Stephane L'Ecuyer, dn: CN=Stephane L'Ecuyer, dn: CN=Stephane L'Ecuyer, dn: Die Architect LLC, C=US Date: 2024.11.19 14:25:09-05:00'

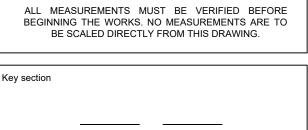

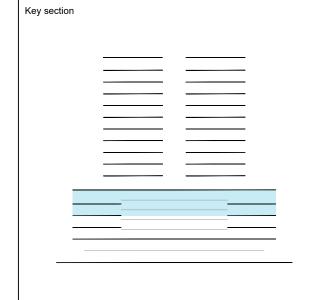

BAM PROPERTY DEVELOPMENT LLC 1044 BROADWAY, WOODMERE, NY 11598

650 N ANDREWS **MIXED-USE** 650 NORTH ANDREWS AVENUE,

FORT LAUDERDALE, FL 33311 PARKING LAYOUT **LEVEL P5 FLOOR PLAN ARCHITECTURE** J. WU Verified as shown JF. Gervais S. L'ecuyer 10-28-2024 Project Manager N. TREMBLAY

22-855


1 LEVEL P5 FLOOR PLAN A-203B SCALE: 1" = 20'-0"





3323 NE 163rd Street, Suite 200 North Miami Beach, FL 33160

(† 305.792.0015 († 305.931.0279 (@ info@absolute-idea.com

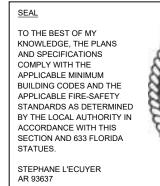






ΞV.	DATE	DESCRIPTION
1	10-13-2023	D.R.C. SUBMITTAL
2	12-21-2023	REV. 1 COMMENTS
3	04-23-2024	REV. 2 COMMENTS
4	08-13-2024	REV. 3 COMMENTS
5	10-10-2024	REV. 4 COMMENTS
	·	

ALL MEASUREMENTS MUST BE VERIFIED BEFORE BEGINNING THE WORKS. NO MEASUREMENTS ARE TO BE SCALED DIRECTLY FROM THIS DRAWING.

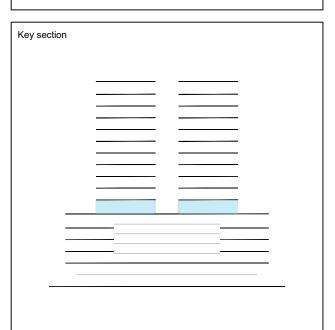

BAM PROPERTY
DEVELOPMENT LLC
1044 BROADWAY,
WOODMERE, NY 11598

650 N ANDREWS
MIXED-USE
650 NORTH ANDREWS AVENUE,
FORT LAUDERDALE, FL 33311

AMENITIES & POOL DECK
LEVEL 04 FLOOR PLAN


Drawn
J. WU
ARCHITECTURE
Verified
Scale
JF. Gervais
Approved
Approved
S. L'ecuyer
Project Manager
N. TREMBLAY


Dug. no.

Date
Dug. no.

22-855

N.E. 7TH STREET

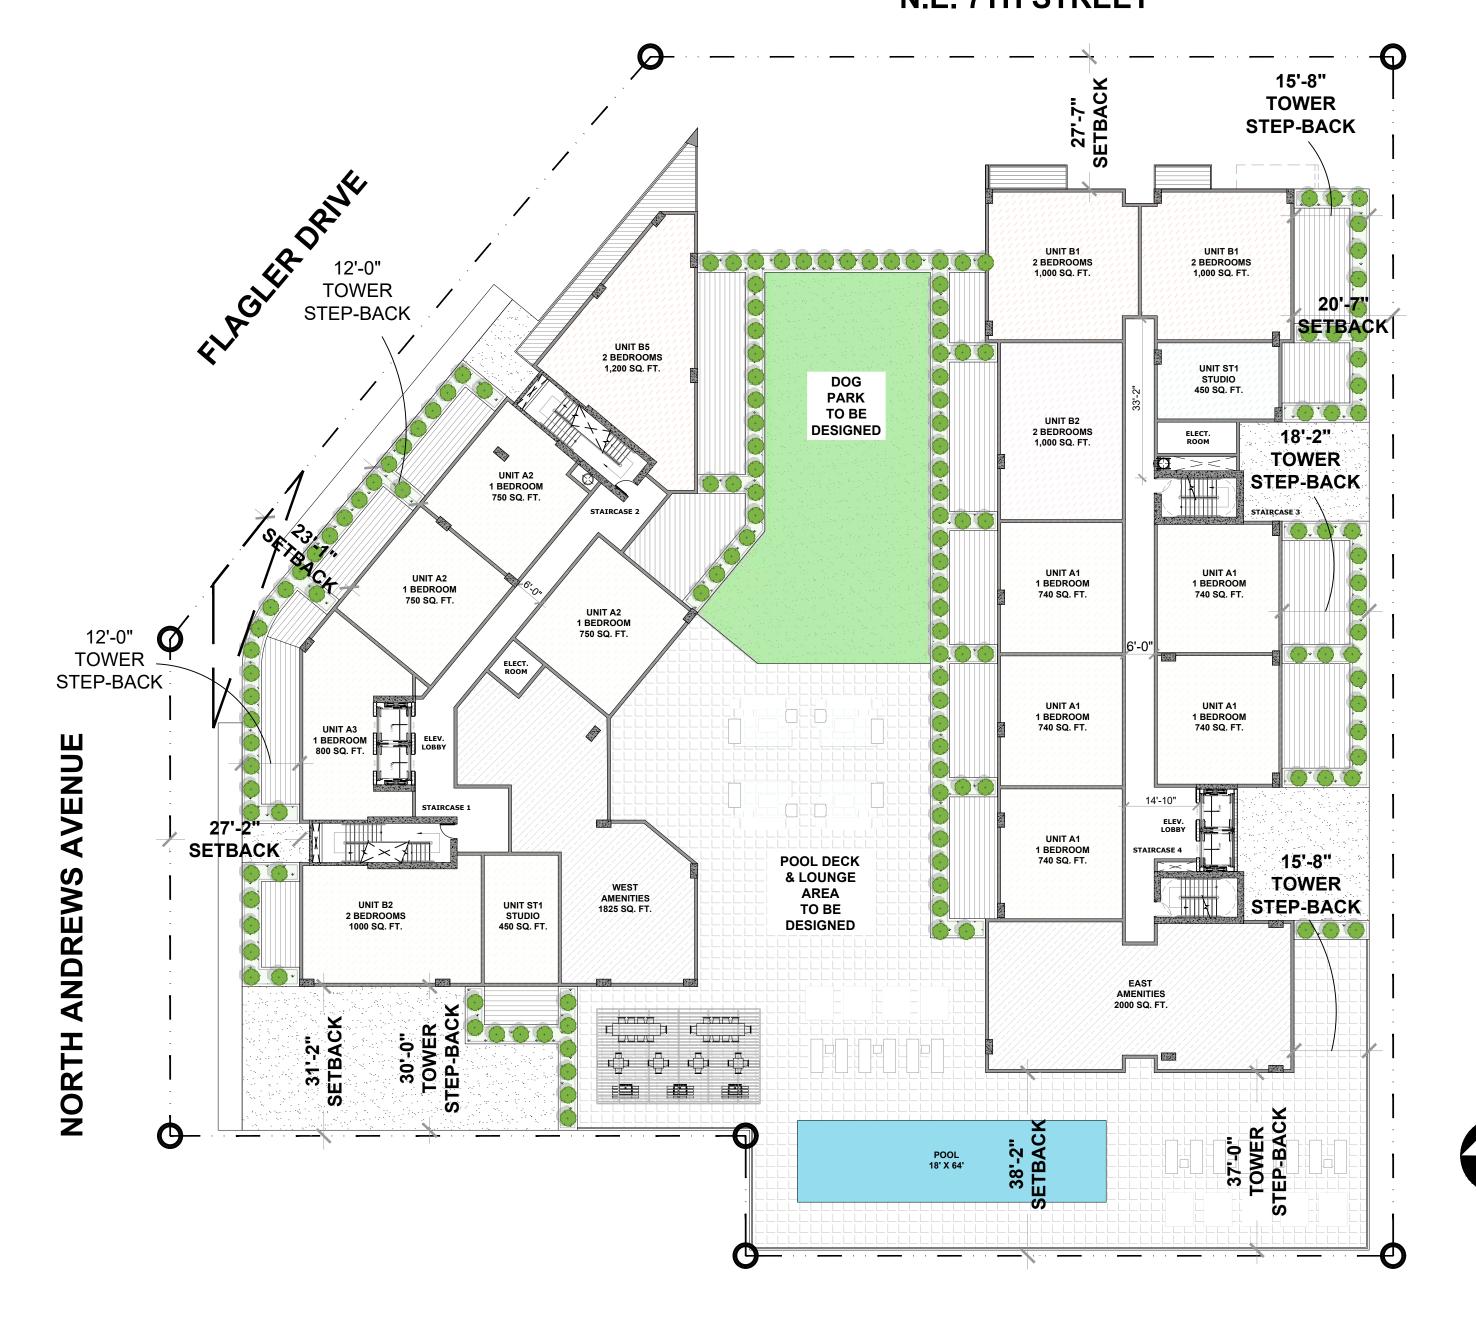

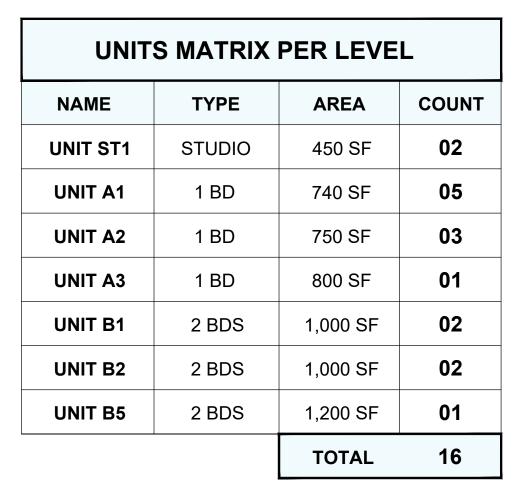


INTERIOR AMENITIES		
NAME	AREA	
WEST TOWER	1,825 SF	
EAST TOWER	2,000 SF	
TOTAL	3,825 SF	

EXTERIOR AMENITIES		
NAME	AREA	
POOL DECK	10,000 SF	
DOG PARK & GARDEN	3,000 SF	
TOTAL	13,000 SF	







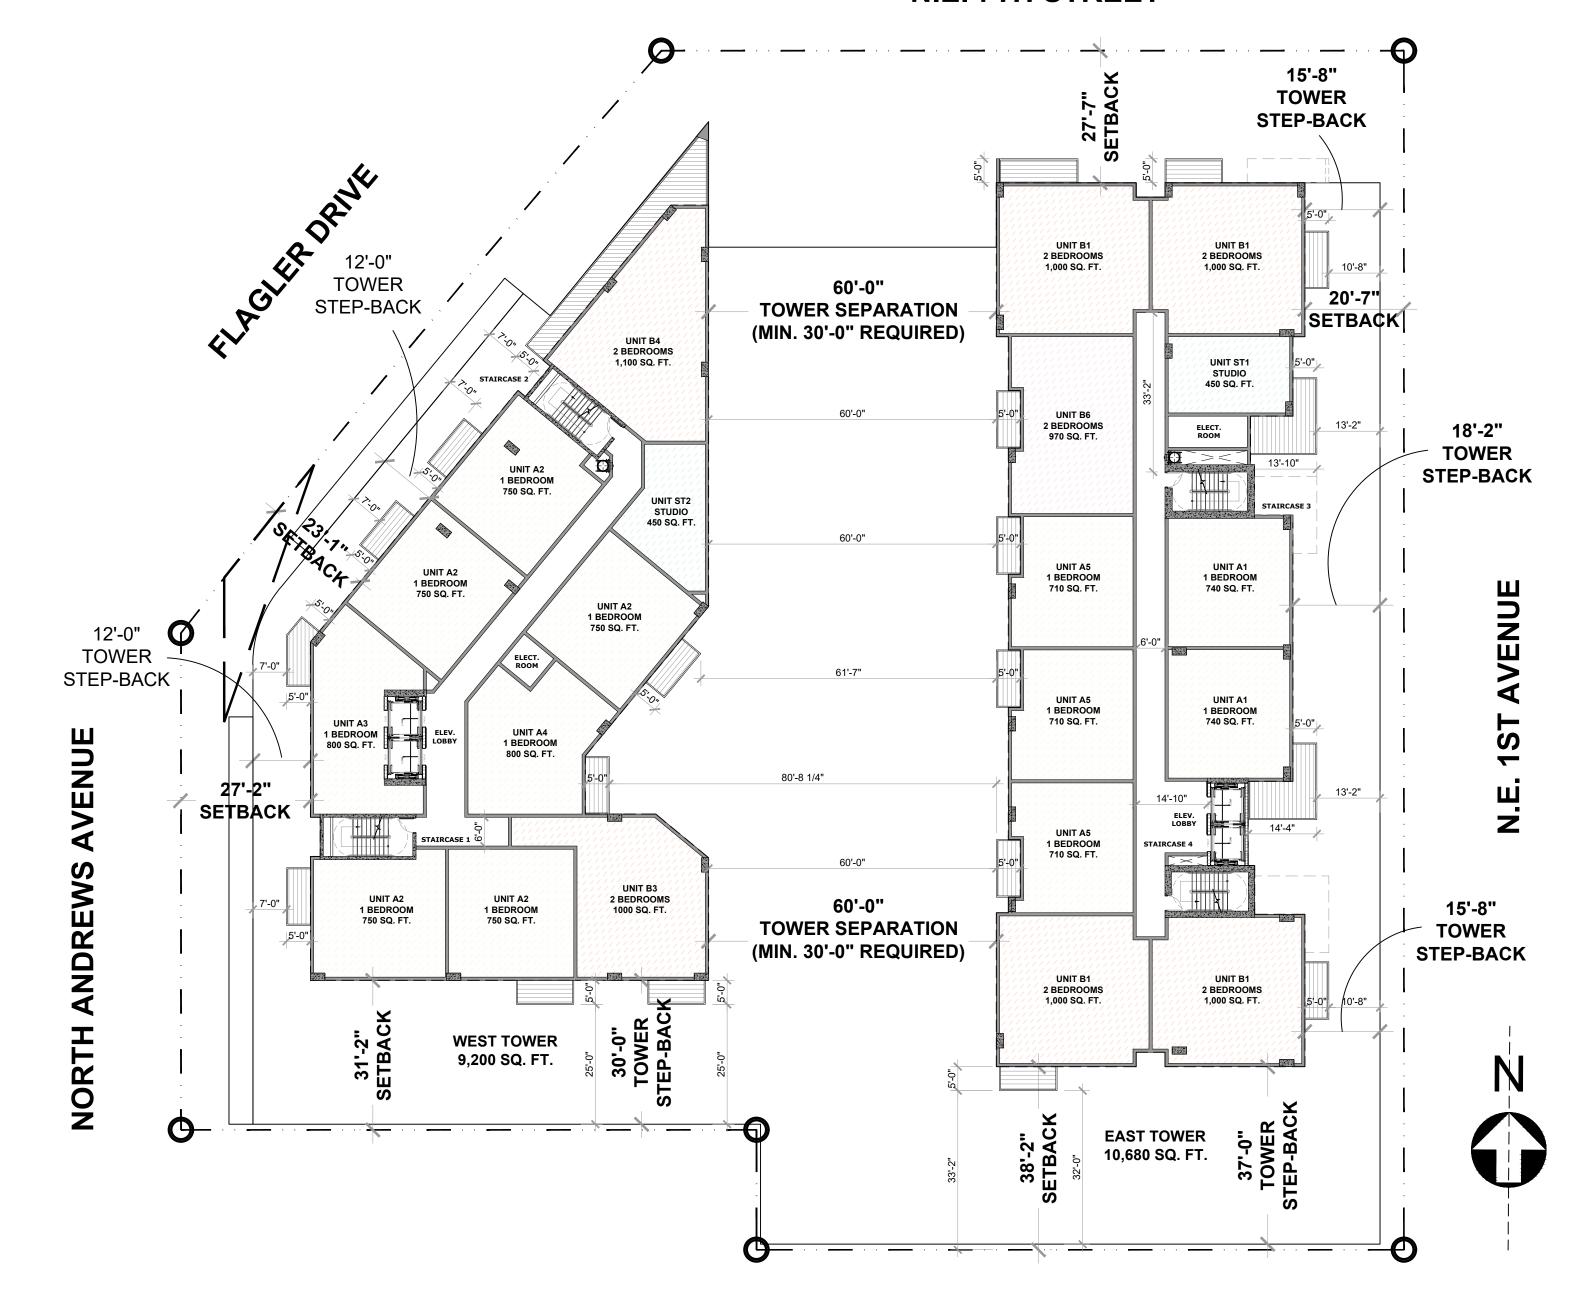


UNITS MATRIX PER LEVEL				
NAME	TYPE	AREA	COUNT	
UNIT ST1	STUDIO	450 SF	01	
UNIT ST2	STUDIO	450 SF	01	
UNIT A1	1 BD	740 SF	02	
UNIT A2	1 BD	750 SF	05	
UNIT A3	1 BD	800 SF	01	
UNIT A4	1 BD	800 SF	01	
UNIT A5	1 BD	710 SF	03	
UNIT B1	2 BDS	1,000 SF	04	
UNIT B3	2 BDS	1,000 SF	01	
UNIT B4	2 BDS	1,100 SF	01	
UNIT B6	2 BDS	970 SF	01	
		TOTAL	21	

TOWER FLOORPLATE		
NAME	AREA	
WEST TOWER	9,200 SF	
EAST TOWER	10,680 SF	
TOTAL	19,880 SF	



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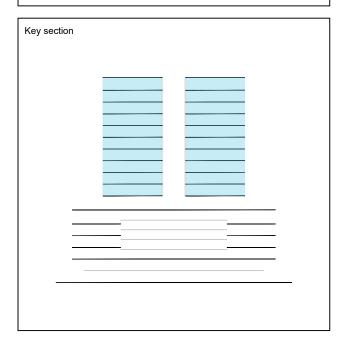




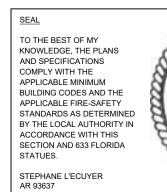

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BAM PROPERTY DEVELOPMENT LLC 1044 BROADWAY, WOODMERE, NY 11598

650 N ANDREWS **MIXED-USE** 650 NORTH ANDREWS AVENUE, FORT LAUDERDALE, FL 33311

TYPICAL RESIDENTIAL LEVEL 05 - 14 FLOOR PLAN

J. WU **ARCHITECTURE** Scale as shown JF. Gervais S. L'ecuyer 10-28-2024

Project Manager N. TREMBLAY 22-855

Dwg. no.







ROOFTOP COOLING TOWER IMAGERY



TYPICAL MECHANICAL SCREEN DETAIL

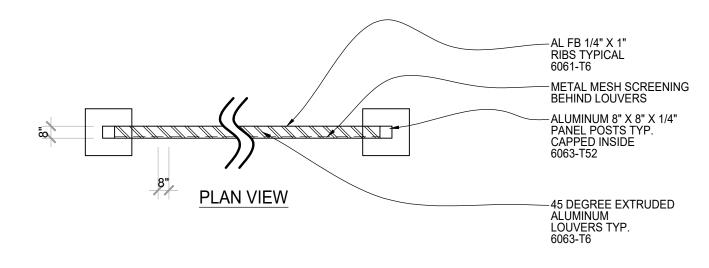

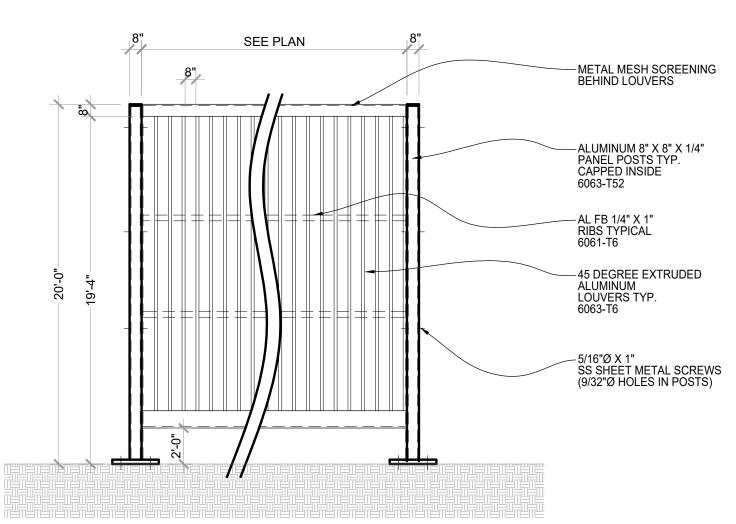

ELEVATION VIEW



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 3323 NE 163rd Street, Suite 200
 North Miami Beach, FL 33160

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 (f) 305.931.0279
 (a) info@absolute-idea.com

SEAL

TO THE BEST OF MY
KNOWLEDGE, THE PLANS
AND SPECIFICATIONS
COMPLY WITH THE
APPLICABLE MINIMUM
BUILDING CODES AND THE
APPLICABLE FIRE-SAFETY
STANDARDS AS DETERMINED
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SECTION AND 633 FLORIDA
STATUES.

STEPHANE L'ECUYER
AR 93637



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y section	

BAM PROPERTY
DEVELOPMENT LLC
1044 BROADWAY,
WOODMERE, NY 11598

650 N ANDREWS MIXED-USE 650 NORTH ANDREWS AVENUE, FORT LAUDERDALE, FL 33311

	EPTUAL PLAN
Drawn	Field
J. WU	ARCHITECTURE
Verified	Scale
JF. Gervais	as shown
Approved	Date
S. L'ecuyer	10-28-2024
Project Manager	Dwg. no.
N. TREMBLAY	A 206
Project	A-206
22-855	

ROOF PLAN NOTES:


** ROOFTOP MECHANICAL EQUIPMENTS (COOLING TOWERS) WILL BE HIDDEN BEHIND SCREEN. FINAL DESIGN WILL BE COORDINATED WITH MEP DURING DESIGN DOCUMENT STAGE.





SMOOTH STUCCO FINISH
SW-7005 PURE WHITE
SHERWIN-WILLIAMS
OR EQUIVALENT APPROVED BY ARCHITECT

7 RAILWAY TRACK

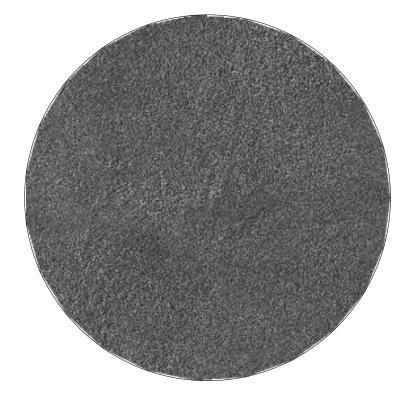

2 SMOOTH STUCCO FINISH
AF-685 THUNDER
BENJAMIN MOORE
OR EQUIVALENT APPROVED BY ARCHITECT



3 SMOOTH STUCCO FINISH RUSTED ORANGE COLOR OR EQUIVALENT APPROVED BY ARCHITECT



4 TINTED GLASS FOR STOREFRONTS, WINDOWS, BALCONY DOORS
VIRACON OPTIGRAY



5 ALUMINUM FRAME
PEARL WHITE
BENJAMIN MOORE
OR EQUIVALENT APPROVED BY ARCHITECT



6 METAL MESH RAILING




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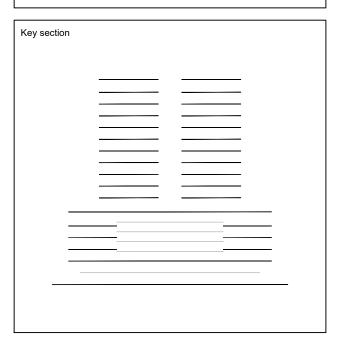


AR93637



	1	
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BAM PROPERTY DEVELOPMENT LLC 1044 BROADWAY, WOODMERE, NY 11598

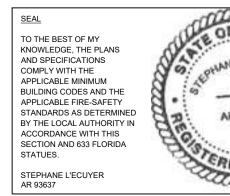650 N ANDREWS MIXED-USE 650 NORTH ANDREWS AVENUE, FORT LAUDERDALE, FL 33311

NORTH ELEVATION				
Descue	F:-IJ			
Drawn	Field			
J. WU	ARCHITECTURE			
Verified	Scale			
JF. Gervais	as shown			
Approved	Date			
S. L'ecuyer	10-28-2024			
Project Manager	Dwg. no.			

N. TREMBLAY
Project
22-855

A-50

60'-0" TOWER SEPARATION (BALCONIES ARE NOT IN THE TOWER SEPARATION) 20'-7" SEE SHEET A-205 27'-2" **194'-0" 201.4 NAVD** FOR BALCONIES LOCATION TOWER SETBACK TOP OF MECH. EQUIP. 5'-0" **184'-0" 191.4 NAVD** ARCHITECTURAL ARCHITECTURAL TOP OF STAIRCASE **175'-0" 182.4 NAVD** ROOF **164'-0" 171.4 NAVD** LEVEL 14 2 **154'-0" 161.4 NAVD** LEVEL 13 2 **144'-0" 151.4 NAVD** LEVEL 12 **134'-0"** √ 141.4 NAVD LEVEL 11 1 **124'-0" 131.4 NAVD** LEVEL 10 **114'-0" 121.4 NAVD** LEVEL 9 **104'-0" 111.4 NAVD** 12'-0" 6 15'-2" – TOWER PODIUM STEP-BACK SETBACK 4'-11" 15'-8"
PODIUM TOWER
SETBACK STEP-BACK LEVEL 8 94'-0" \ 101.4 NAVD LEVEL 7 84'-0" 91.4 NAVD \ LEVEL 6 74'-0" 🗸 81.4 NAVD LEVEL 5 62'-0" V 69.4 NAVD 50'-0" 57.4 NAVD LEVEL 3.5 40'-0" 47.4 NAVD LEVEL 3 30'-0" 37.4 NAVD LEVEL 2.5 20'-0" **27.4 NAVD** LEVEL 2 10'-0" 🗸 17.4 NAVD LEVEL 1.5 [/] 0'-0" 7.4 NAVD



8 COMPOSITE WOOD SLATS



GROUND LEVEL /



SMOOTH STUCCO FINISH SW-7005 PURE WHITE SHERWIN-WILLIAMS OR EQUIVALENT APPROVED BY ARCHITECT



SMOOTH STUCCO FINISH AF-685 THUNDER BENJAMIN MOORE OR EQUIVALENT APPROVED BY ARCHITECT



SMOOTH STUCCO FINISH RUSTED ORANGE COLOR OR EQUIVALENT APPROVED BY ARCHITECT



TINTED GLASS FOR STOREFRONTS, WINDOWS, BALCONY DOORS
VIRACON OPTIGRAY




ALUMINUM FRAME PEARL WHITE BENJAMIN MOORE OR EQUIVALENT APPROVED BY ARCHITECT



6 METAL MESH RAILING




CANAL PARK 3323 NE 163rd Street, Suite 200 North Miami Beach, FL 33160 (t) 305.792.0015 (f) 305.931.0279 (@) info@absolute-idea.com

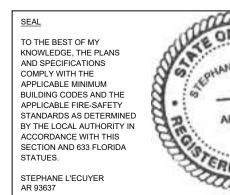



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BAM PROPERTY DEVELOPMENT LLC 1044 BROADWAY, WOODMERE, NY 11598

650 N ANDREWS MIXED-USE 650 NORTH ANDREWS AVENUE, FORT LAUDERDALE, FL 33311

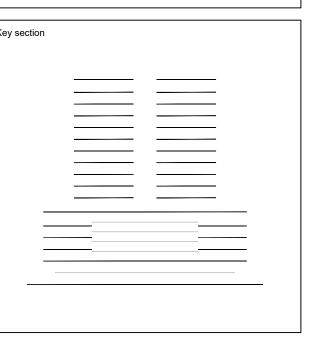
Title	
WEST EL	EVATION
Drawn	Field ARCHITECTURE
J. WU	ARCHITECTURE
Verified	Scale
JF. Gervais	as shown
Approved	Date
S. L'ecuyer	10-10-2024
Project Manager	Dwg. no.
N. TREMBLAY	A F00
Project	A-502

22-855

1 WEST ELEVATION A-502 SCALE: 1/16" = 1'-0"



7 RAILWAY TRACK

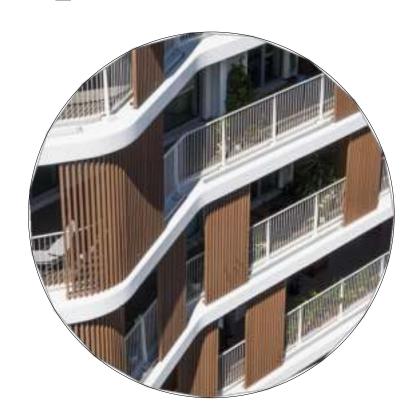

8 COMPOSITE WOOD SLATS




WOOD PANEL
NICHIHA RIFTSAWN
CHESTNUT





SMOOTH STUCCO FINISH
SW-7005 PURE WHITE
SHERWIN-WILLIAMS
OR EQUIVALENT APPROVED BY ARCHITECT

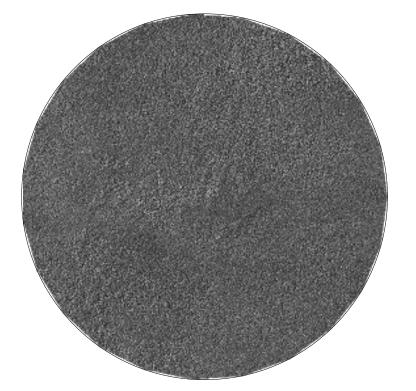

2 SMOOTH STUCCO FINISH
AF-685 THUNDER
BENJAMIN MOORE
OR EQUIVALENT APPROVED BY ARCHITECT



3 SMOOTH STUCCO FINISH RUSTED ORANGE COLOR OR EQUIVALENT APPROVED BY ARCHITECT



4 TINTED GLASS FOR STOREFRONTS, WINDOWS, BALCONY DOORS
VIRACON OPTIGRAY



5 ALUMINUM FRAME
PEARL WHITE
BENJAMIN MOORE
OR EQUIVALENT APPROVED BY ARCHITECT



6 METAL MESH RAILING




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(1) 305 792 0015 (1) 305 931 0279 (2) info@absolute.idea.com

(t) 305.792.0015 (f) 305.931.0279 (@) info@absolute-idea.com




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	ı	T
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BAM PROPERTY DEVELOPMENT LLC 1044 BROADWAY, WOODMERE, NY 11598

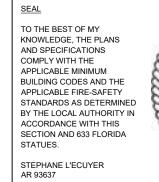650 N ANDREWS MIXED-USE 650 NORTH ANDREWS AVENUE, FORT LAUDERDALE, FL 33311

riue	
EAST E	LEVATION
Drawn	Field
J. WU	ARCHITECTUR
Verified	Scale
JF. Gervais	as shown
Approved	Date
S. L'ecuyer	10-10-2024
Project Manager	Dwg no


N. TREMBLAY
Project
22-855

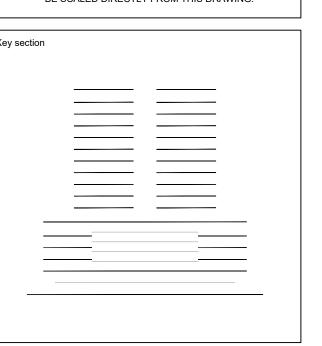A-50

1 EAST ELEVATION A-503 SCALE: 1/16" = 1'-0"



7 RAILWAY TRACK

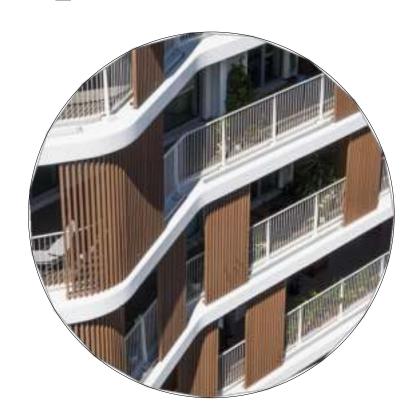

8 COMPOSITE WOOD SLATS




9 WOOD PANEL
NICHIHA RIFTSAWN
CHESTNUT





SMOOTH STUCCO FINISH SW-7005 PURE WHITE SHERWIN-WILLIAMS OR EQUIVALENT APPROVED BY ARCHITECT

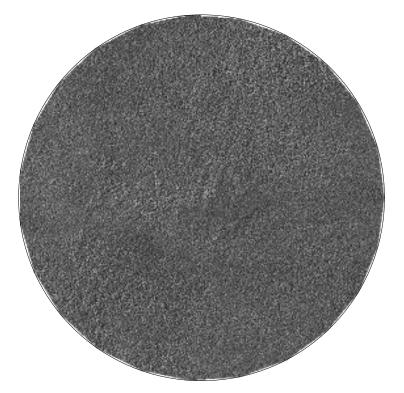

SMOOTH STUCCO FINISH AF-685 THUNDER BENJAMIN MOORE OR EQUIVALENT APPROVED BY ARCHITECT



SMOOTH STUCCO FINISH RUSTED ORANGE COLOR OR EQUIVALENT APPROVED BY ARCHITECT



TINTED GLASS FOR STOREFRONTS, WINDOWS, BALCONY DOORS
VIRACON OPTIGRAY



ALUMINUM FRAME PEARL WHITE **BENJAMIN MOORE** OR EQUIVALENT APPROVED BY ARCHITECT



6 METAL MESH RAILING




Stephane L'Ecuyer diqualifier-A01410D0000188655B2641B0007C43C, O-DEFA Architect LLC, C-US Date: 2024.11.20 09:16:26-05'00'

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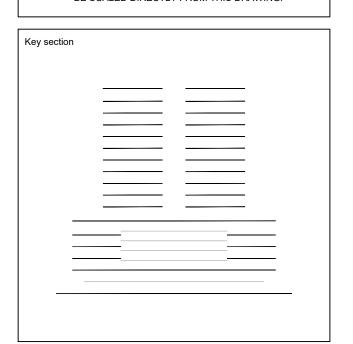
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BAM PROPERTY DEVELOPMENT LLC 1044 BROADWAY, WOODMERE, NY 11598



Title		
SOUTH ELEVATION		
Drawn	Field	
J. WU	ARCHITECTURE	
Verified	Scale	
JF. Gervais	as shown	
Approved	Date	
S. L'ecuyer	10-28-2024	
Project Manager	Dwg. no.	
N. TREMBLAY	A EOA	
Project	A-504	

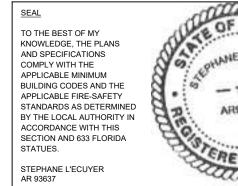22-855

1 SOUTH ELEVATION A-504 SCALE: 1/16" = 1'-0"



7 RAILWAY TRACK




8 COMPOSITE WOOD SLATS




WOOD PANEL NICHIHA RIFTSAWN CHESTNUT






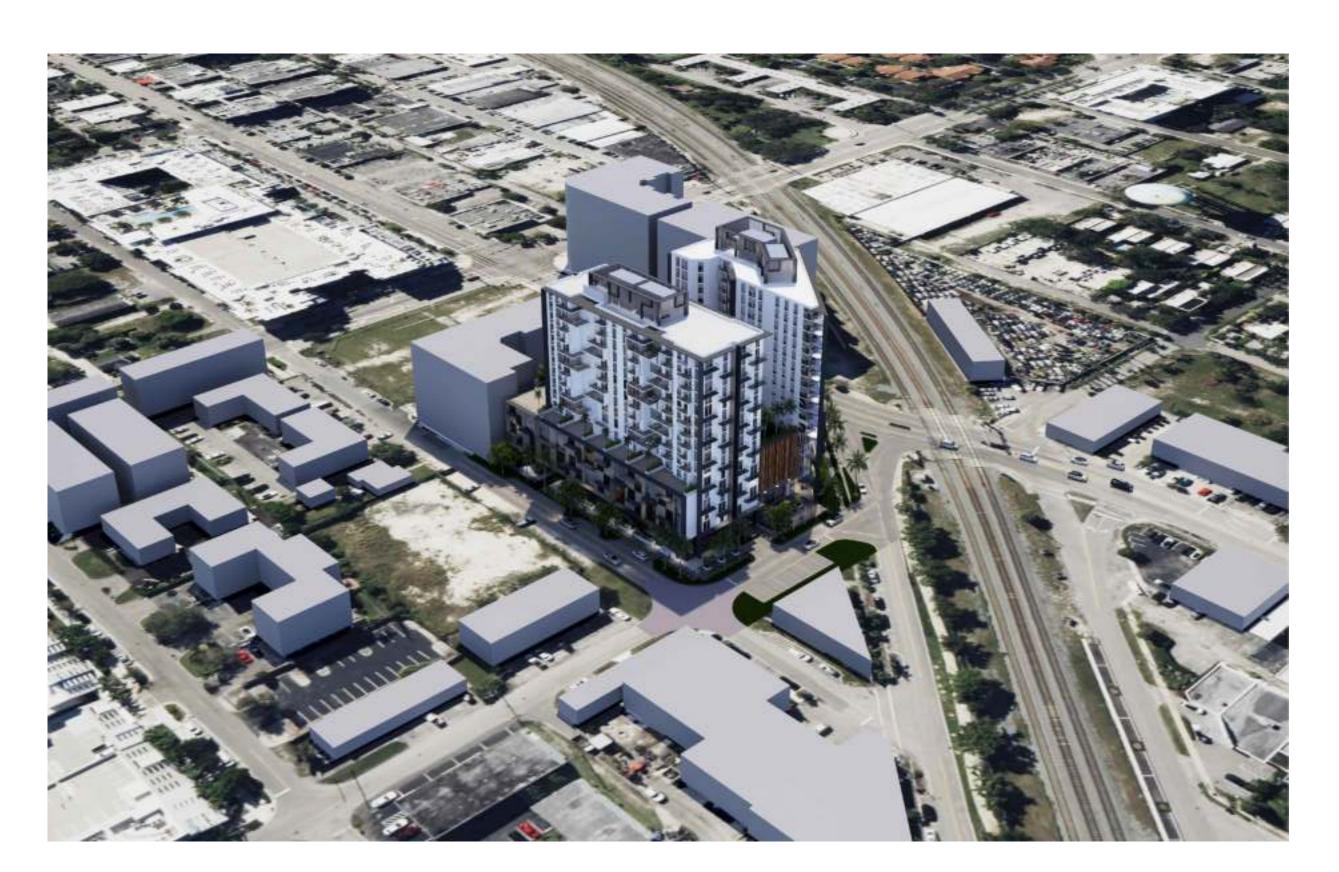


CONCEPTUAL AERIAL VIEW
1 LOOKING SOUTH-WEST A-901 SCALE: NTS

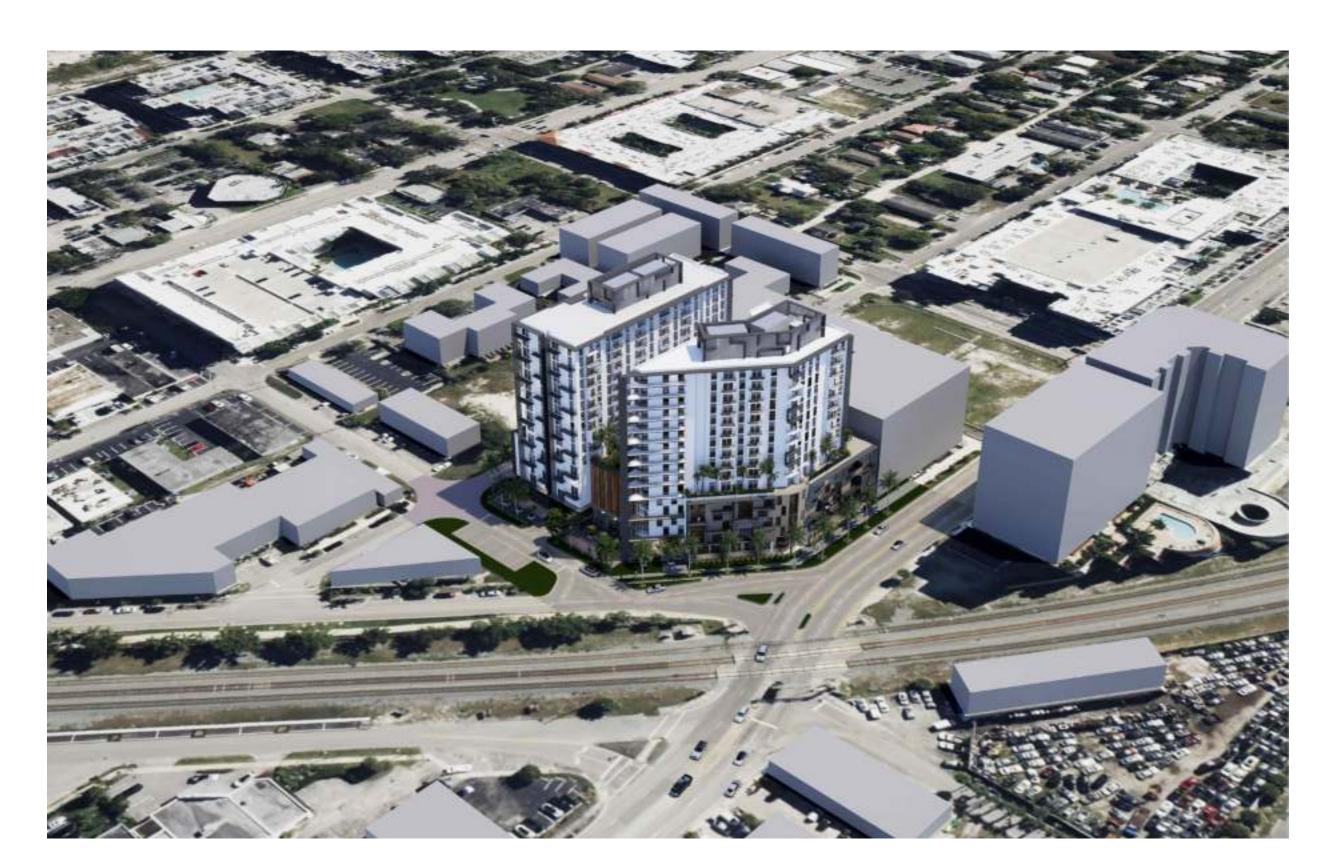

CONCEPTUAL AERIAL VIEW LOOKING SOUTH-EAST A-901 SCALE: NTS

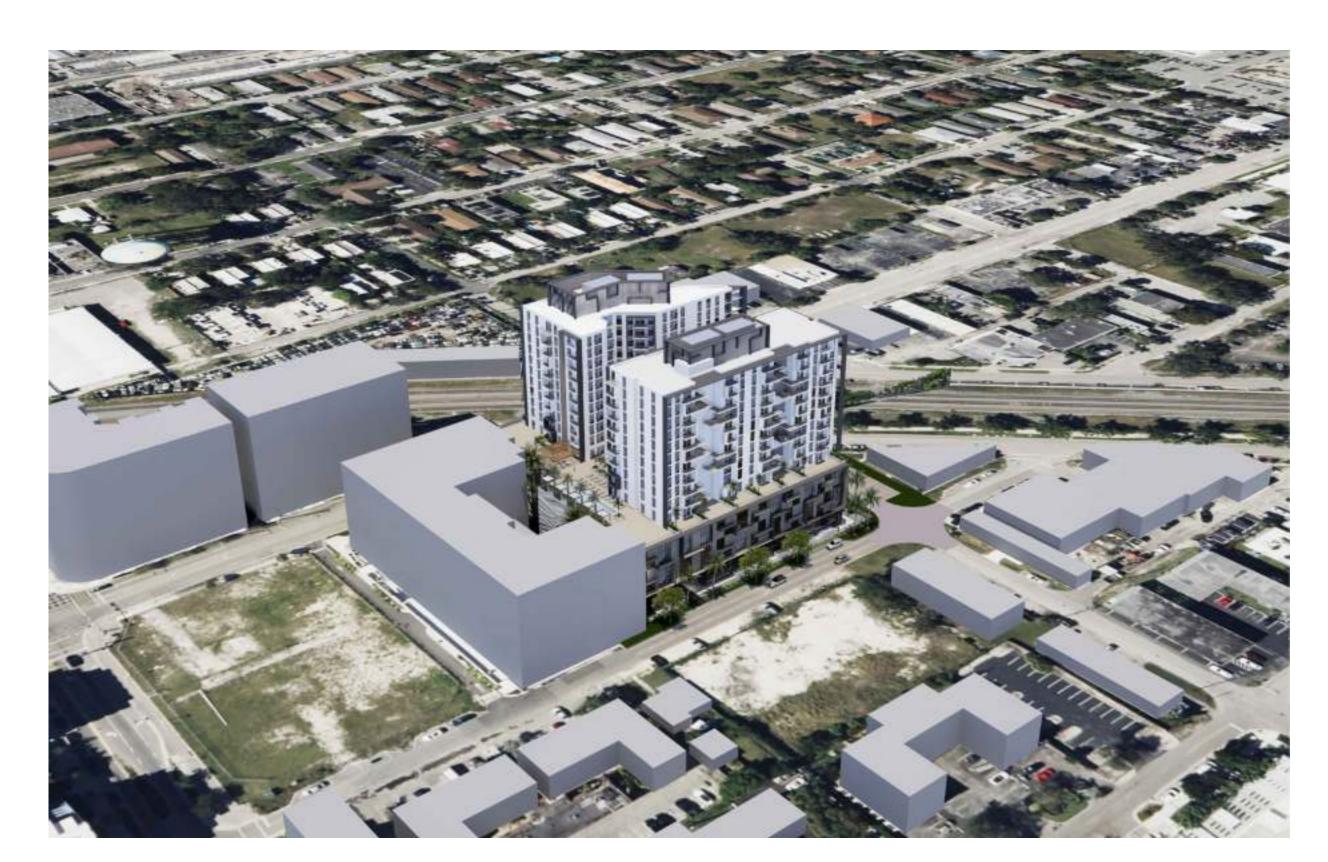



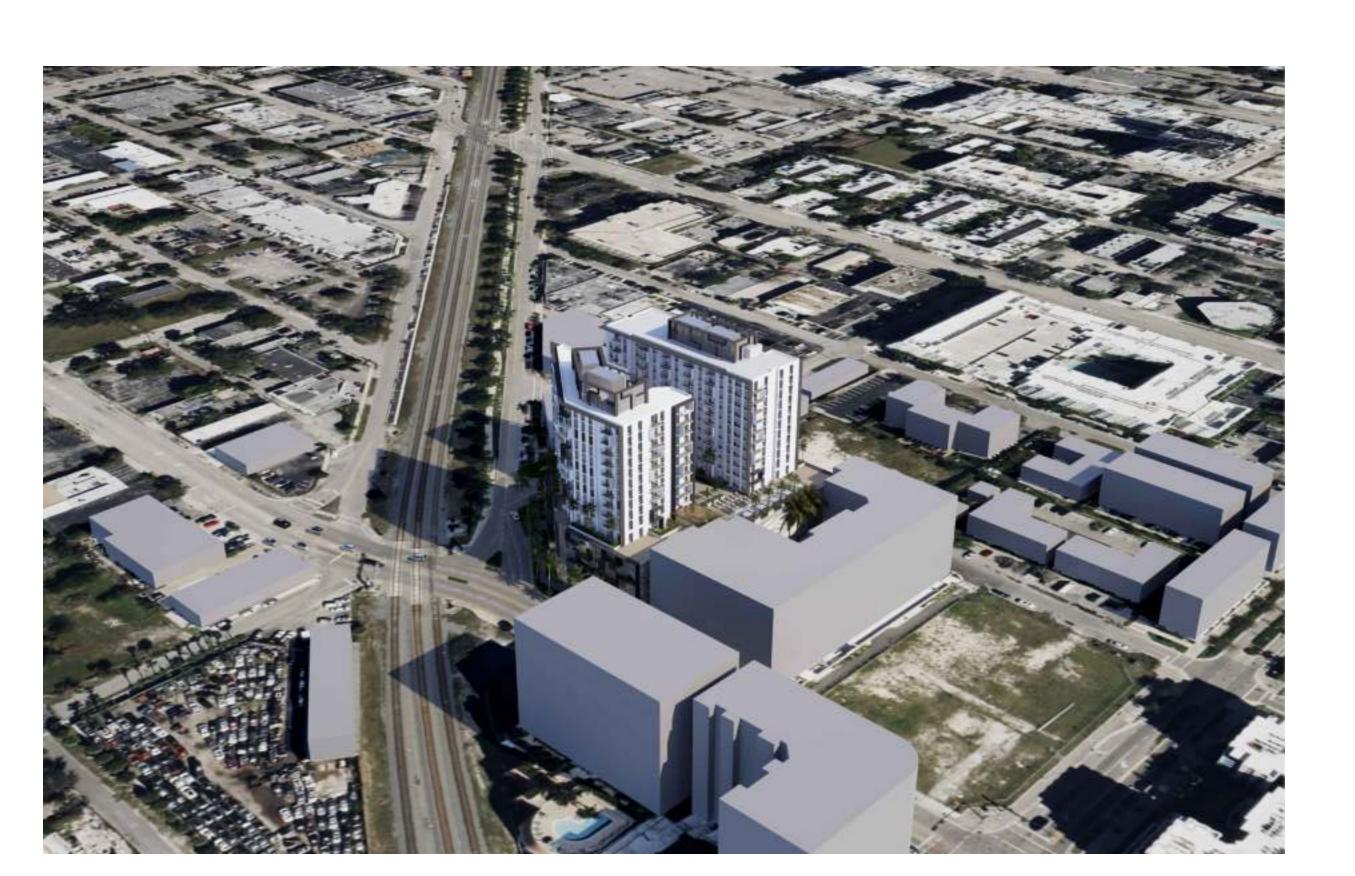






3323 NE 163rd Street, Suite 200 North Miami Beach, FL 33160 (t) 305.792.0015 (f) 305.931.0279 (@) info@absolute-idea.com

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BY THE LOCAL AUTHORITY IN
ACCORDANCE WITH THIS
SECTION AND 633 FLORIDA
STATUES. STEPHANE L'ECUYER AR 93637



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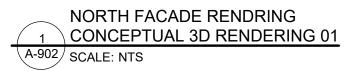


CONCEPTUAL **AERIAL VIEWS** J. WU **ARCHITECTURE** JF. Gervais as shown S. L'ecuyer 10-10-2024 Project Manager N. TREMBLAY

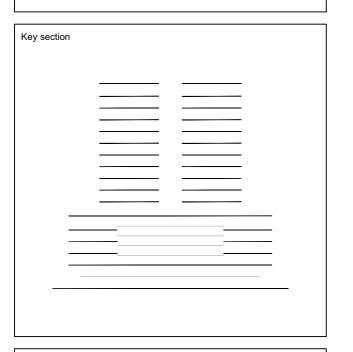A-901 22-855










3323 NE 163rd Street, Suite 200 North Miami Beach, FL 33160 (t) 305.792.0015 (f) 305.931.0279 (@) info@absolute-idea.com

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KNOWLEDGE, THE PLANS
AND SPECIFICATIONS
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BUILDING CODES AND THE
APPLICABLE FIRE-SAFETY
STANDARDS AS DETERMINED
BY THE LOCAL AUTHORITY IN
ACCORDANCE WITH THIS
SECTION AND 633 FLORIDA
STATUES. STEPHANE L'ECUYER AR 93637



REV.	DATE	DESCRIPTION
01	10-13-2023	D.R.C. SUBMITTAL
02	12-21-2023	REV. 1 COMMENTS
03	04-23-2024	REV. 2 COMMENTS
04	08-13-2024	REV. 3 COMMENTS
05	10-10-2024	REV. 4 COMMENTS

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BAM PROPERTY DEVELOPMENT LLC 1044 BROADWAY, WOODMERE, NY 11598

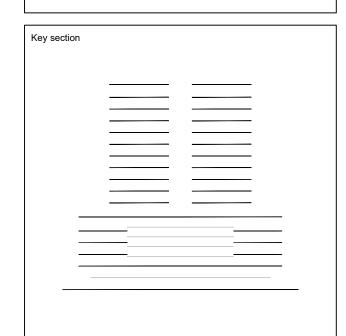650 N ANDREWS MIXED-USE 650 NORTH ANDREWS AVENUE, FORT LAUDERDALE, FL 33311

CONCEPTUAL **3D RENDERING 01** J. WU **ARCHITECTURE** JF. Gervais as shown S. L'ecuyer 10-10-2024

Project Manager N. TREMBLAY

A-902 22-855





STREET VIEW OF NORTH FACADE

1 CONCEPTUAL 3D RENDERING 02

A-903 SCALE: NTS



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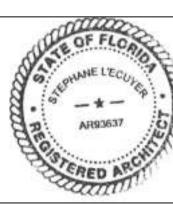
CANAL PARK

3323 NE 163rd Street, Suite 200 North Miami Beach, FL 33160 (t) 305.792.0015 (f) 305.931.0279 (@) info@absolute-idea.com

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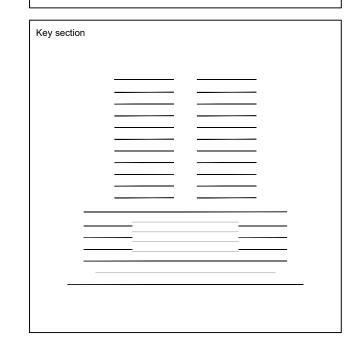
STEPHANE L'ECUYER
AR 93637





REV.	DATE	DESCRIPTION
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BAM PROPERTY DEVELOPMENT LLC 1044 BROADWAY, WOODMERE, NY 11598

650 N ANDREWS MIXED-USE 650 NORTH ANDREWS AVENUE, FORT LAUDERDALE, FL 33311

CONCEPTUAL
3D RENDERING 02

Drawn Field

J. WU ARCHITECTURE

Verified Scale

JF. Gervais as shown
Approved Date
S. L'ecuyer 10-10-2024

Project Manager Dwg. no.

A-903
22-855





STREET VIEW OF NORTH PLAZA

1 CONCEPTUAL 3D RENDERING 03 A-904 SCALE: NTS




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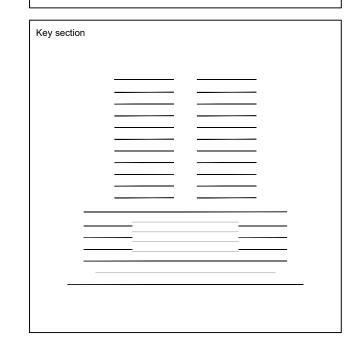
TO THE BEST OF MY
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STATUES. STEPHANE L'ECUYER AR 93637





REV.	DATE	DESCRIPTION
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BAM PROPERTY DEVELOPMENT LLC 1044 BROADWAY, WOODMERE, NY 11598

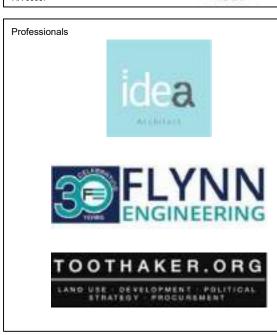650 N ANDREWS MIXED-USE 650 NORTH ANDREWS AVENUE, FORT LAUDERDALE, FL 33311

CONCEPTUAL 3D RENDERING 03 J. WU ARCHITECTURE

JF. Gervais S. L'ecuyer


Project Manager N. TREMBLAY

A-904 22-855

as shown

10-10-2024



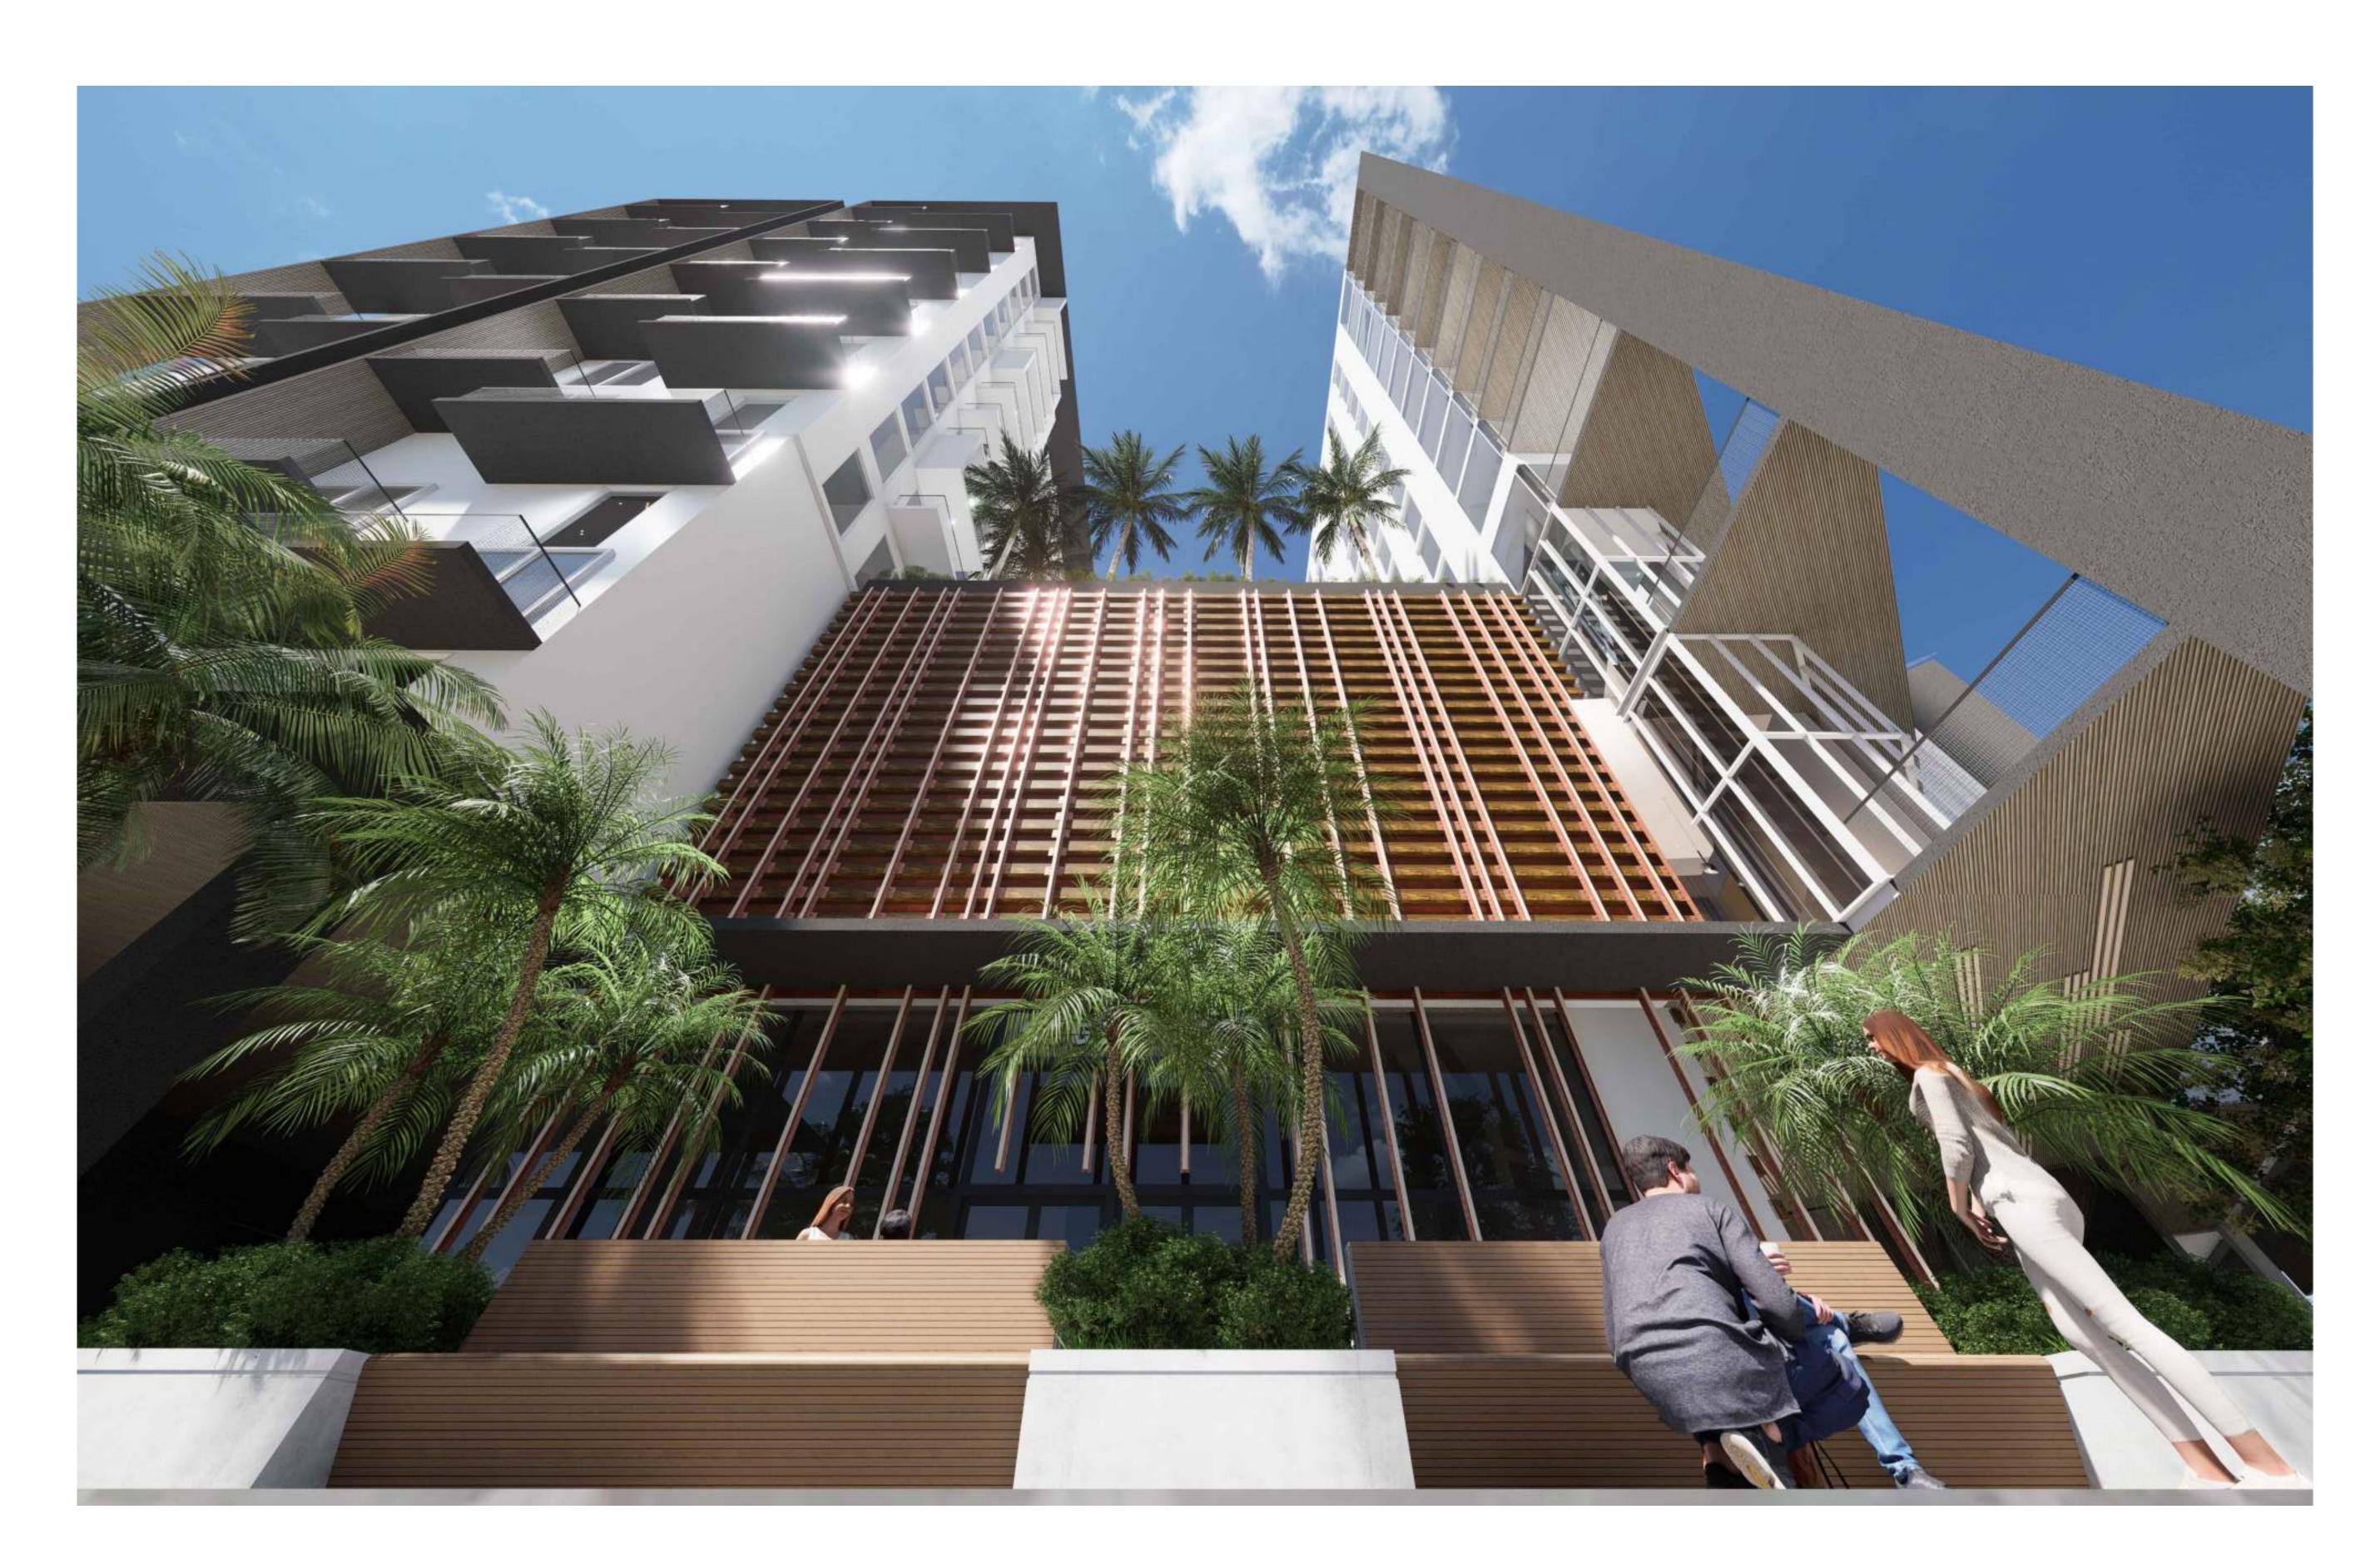

STREET VIEW LOOKING UP - NORTH FACADE


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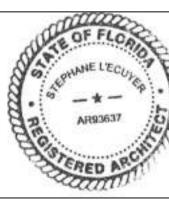


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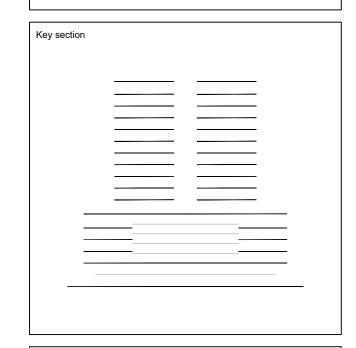






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01	10-13-2023	D.R.C. SUBMITTAL
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BAM PROPERTY DEVELOPMENT LLC 1044 BROADWAY, WOODMERE, NY 11598

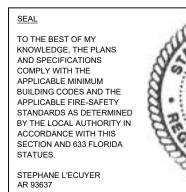
650 N ANDREWS MIXED-USE 650 NORTH ANDREWS AVENUE, FORT LAUDERDALE, FL 33311

_	EPTUAL ERING 04
Drawn	Field
J. WU	ARCHITECTURE
Verified	Scale
JF. Gervais Approved S. L'ecuyer	as shown Date 10-10-2024
Project Manager N. TREMBLAY	Dwg. no.
Project	A-905

Project **22-855**





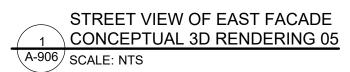



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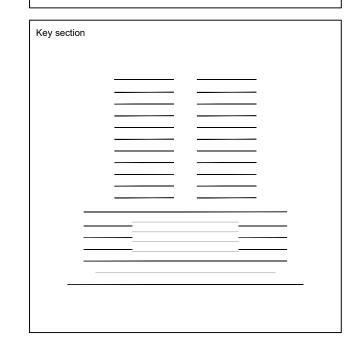
TO THE BEST OF MY
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SECTION AND 633 FLORIDA
STATUES. STEPHANE L'ECUYER AR 93637





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BAM PROPERTY DEVELOPMENT LLC 1044 BROADWAY, WOODMERE, NY 11598

650 N ANDREWS MIXED-USE 650 NORTH ANDREWS AVENUE, FORT LAUDERDALE, FL 33311


	EPTUAL ERING 05
Drawn	Field
J. WU	ARCHITECTURE
Verified	Scale
JF. Gervais Approved S. L'ecuyer	as shown Date 10-10-2024
Project Manager N. TREMBLAY	Dwg. no.
Project	A-906

Project **22-855**

CAM # 24-1102 Exhibit 3 Page 30 of 66





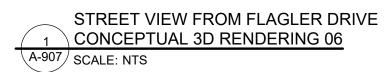




3323 NE 163rd Street, Suite 200 North Miami Beach, FL 33160 (t) 305.792.0015 (f) 305.931.0279 (@) info@absolute-idea.com


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STATUES. STEPHANE L'ECUYER AR 93637



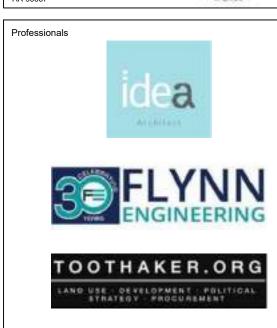

REV.	DATE	DESCRIPTION
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02	12-21-2023	REV. 1 COMMENTS
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BAM PROPERTY DEVELOPMENT LLC 1044 BROADWAY, WOODMERE, NY 11598

650 N ANDREWS MIXED-USE 650 NORTH ANDREWS AVENUE, FORT LAUDERDALE, FL 33311

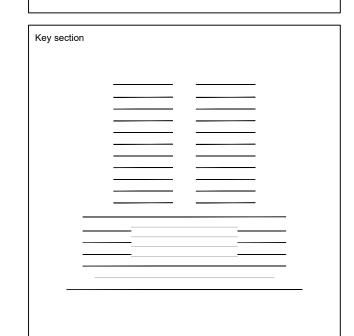CONCEPTUAL 3D RENDERING 06			
Drawn J. WU	Field ARCHITECTUR		
Verified	Scale		
JF. Gervais Approved S. L'ecuyer	as shown Date 10-10-2024		
Project Manager	Dwg. no.		

A-907 Project **22-855**





CORNER VIEW LOOKING SOUTH-EAST


1 CONCEPTUAL 3D RENDERING 07 A-908 SCALE: NTS




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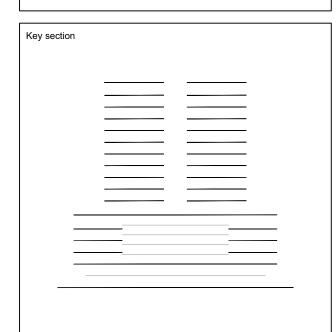
TO THE BEST OF MY
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STATUES. STEPHANE L'ECUYER AR 93637



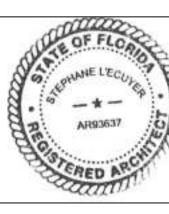

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05	10-10-2024	REV. 4 COMMENTS
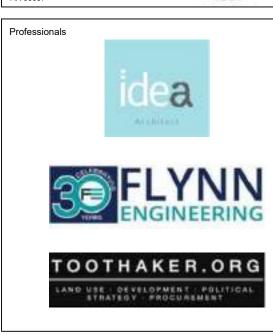
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BAM PROPERTY DEVELOPMENT LLC 1044 BROADWAY, WOODMERE, NY 11598



	SEPTUAL DERING 07
Drawn	Field
J. WU	ARCHITECTU
Verified	Scale
JF. Gervais	as shown
Approved	Date
S. L'ecuyer	10-10-2024
Project Manager	Dwg. no.

N. TREMBLAY A-908 Project **22-855**





STREET VIEW FROM NORTH ANDREWS

1 CONCEPTUAL 3D RENDERING 08

A-909 SCALE: NTS



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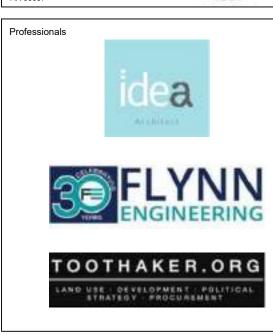
(t) 305.792.0015 (f) 305.931.0279 (@) info@absolute-idea.com

SEAL

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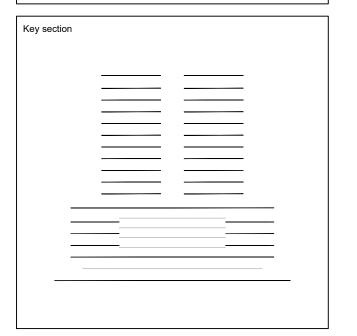
STEPHANE L'ECUYER
AR 93637





03 04-23-2024 REV. 2 COMMENTS 04 08-13-2024 REV. 3 COMMENTS			
01 10-13-2023 D.R.C. SUBMITTAL 02 12-21-2023 REV. 1 COMMENTS 03 04-23-2024 REV. 2 COMMENTS 04 08-13-2024 REV. 3 COMMENTS		1	I
02 12-21-2023 REV. 1 COMMENTS 03 04-23-2024 REV. 2 COMMENTS 04 08-13-2024 REV. 3 COMMENTS	REV.	DATE	DESCRIPTION
03 04-23-2024 REV. 2 COMMENTS 04 08-13-2024 REV. 3 COMMENTS	01	10-13-2023	D.R.C. SUBMITTAL
04 08-13-2024 REV. 3 COMMENTS	02	12-21-2023	REV. 1 COMMENTS
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05 10-10-2024 REV. 4 COMMENTS	04	08-13-2024	REV. 3 COMMENTS
	05	10-10-2024	REV. 4 COMMENTS

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BAM PROPERTY DEVELOPMENT LLC 1044 BROADWAY, WOODMERE, NY 11598

650 N ANDREWS
MIXED-USE
650 NORTH ANDREWS AVENUE,
FORT LAUDERDALE, FL 33311

CONCEPTUAL
3D RENDERING 08

Drawn
J. WU
ARCHITECTURE
Verified
Scale
JF. Gervais
Approved
S. L'ecuyer
Project Manager
N. TREMBLAY
Project

A-909

22-855

CAM # 24-1102 Exhibit 3 Page 33 of 66





STREET CORNER VIEW FROM 7TH AVENUE

1 CONCEPTUAL 3D RENDERING 09

A-910 SCALE: NTS



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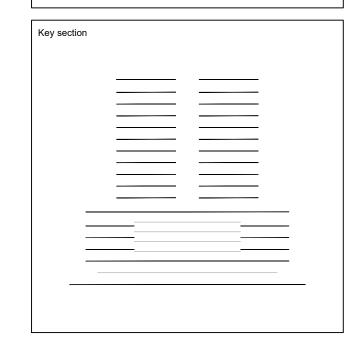
STEPHANE L'ECUYER
AR 93637





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BAM PROPERTY DEVELOPMENT LLC 1044 BROADWAY, WOODMERE, NY 11598



Title	
	EPTUAL DERING 09
Drawn	Field
J. WU	ARCHITECTU
Verified	Scale
JF. Gervais	as shown
Approved	Date
S. L'ecuyer	10-10-2024
Project Manager	Dwg. no.

N. TREMBLAY

Project

22-855

A-910





ENLARGED VIEW OF RESIDENTIAL LINER

1 CONCEPTUAL 3D RENDERING 10

A-911 SCALE: NTS



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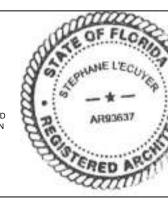
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STEPHANE L'ECUYER
AR 93637





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BAM PROPERTY DEVELOPMENT LLC 1044 BROADWAY, WOODMERE, NY 11598

650 N ANDREWS MIXED-USE 650 NORTH ANDREWS AVENUE, FORT LAUDERDALE, FL 33311

CONCEPTUAL
3D RENDERING 10

Drawn Field

J. WU ARCHITECTURE

Verified Scale

JF. Gervais as shown
Approved Date
S. L'ecuyer 10-10-2024

Project Manager Dwg. no.

A-911
22-855





ENLARGED VIEW OF MONUMENT NORTH FACADE


1 CONCEPTUAL 3D RENDERING 11 A-912 SCALE: NTS



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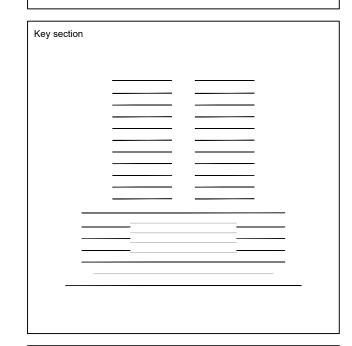
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STATUES. STEPHANE L'ECUYER AR 93637



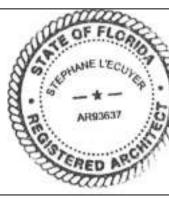

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BAM PROPERTY DEVELOPMENT LLC 1044 BROADWAY, WOODMERE, NY 11598


650 N ANDREWS **MIXED-USE** 650 NORTH ANDREWS AVENUE, FORT LAUDERDALE, FL 33311

CONCEPTUAL **3D RENDERING 11** J. WU **ARCHITECTURE** Verified JF. Gervais as shown S. L'ecuyer 10-10-2024

Project Manager N. TREMBLAY

A-912 22-855



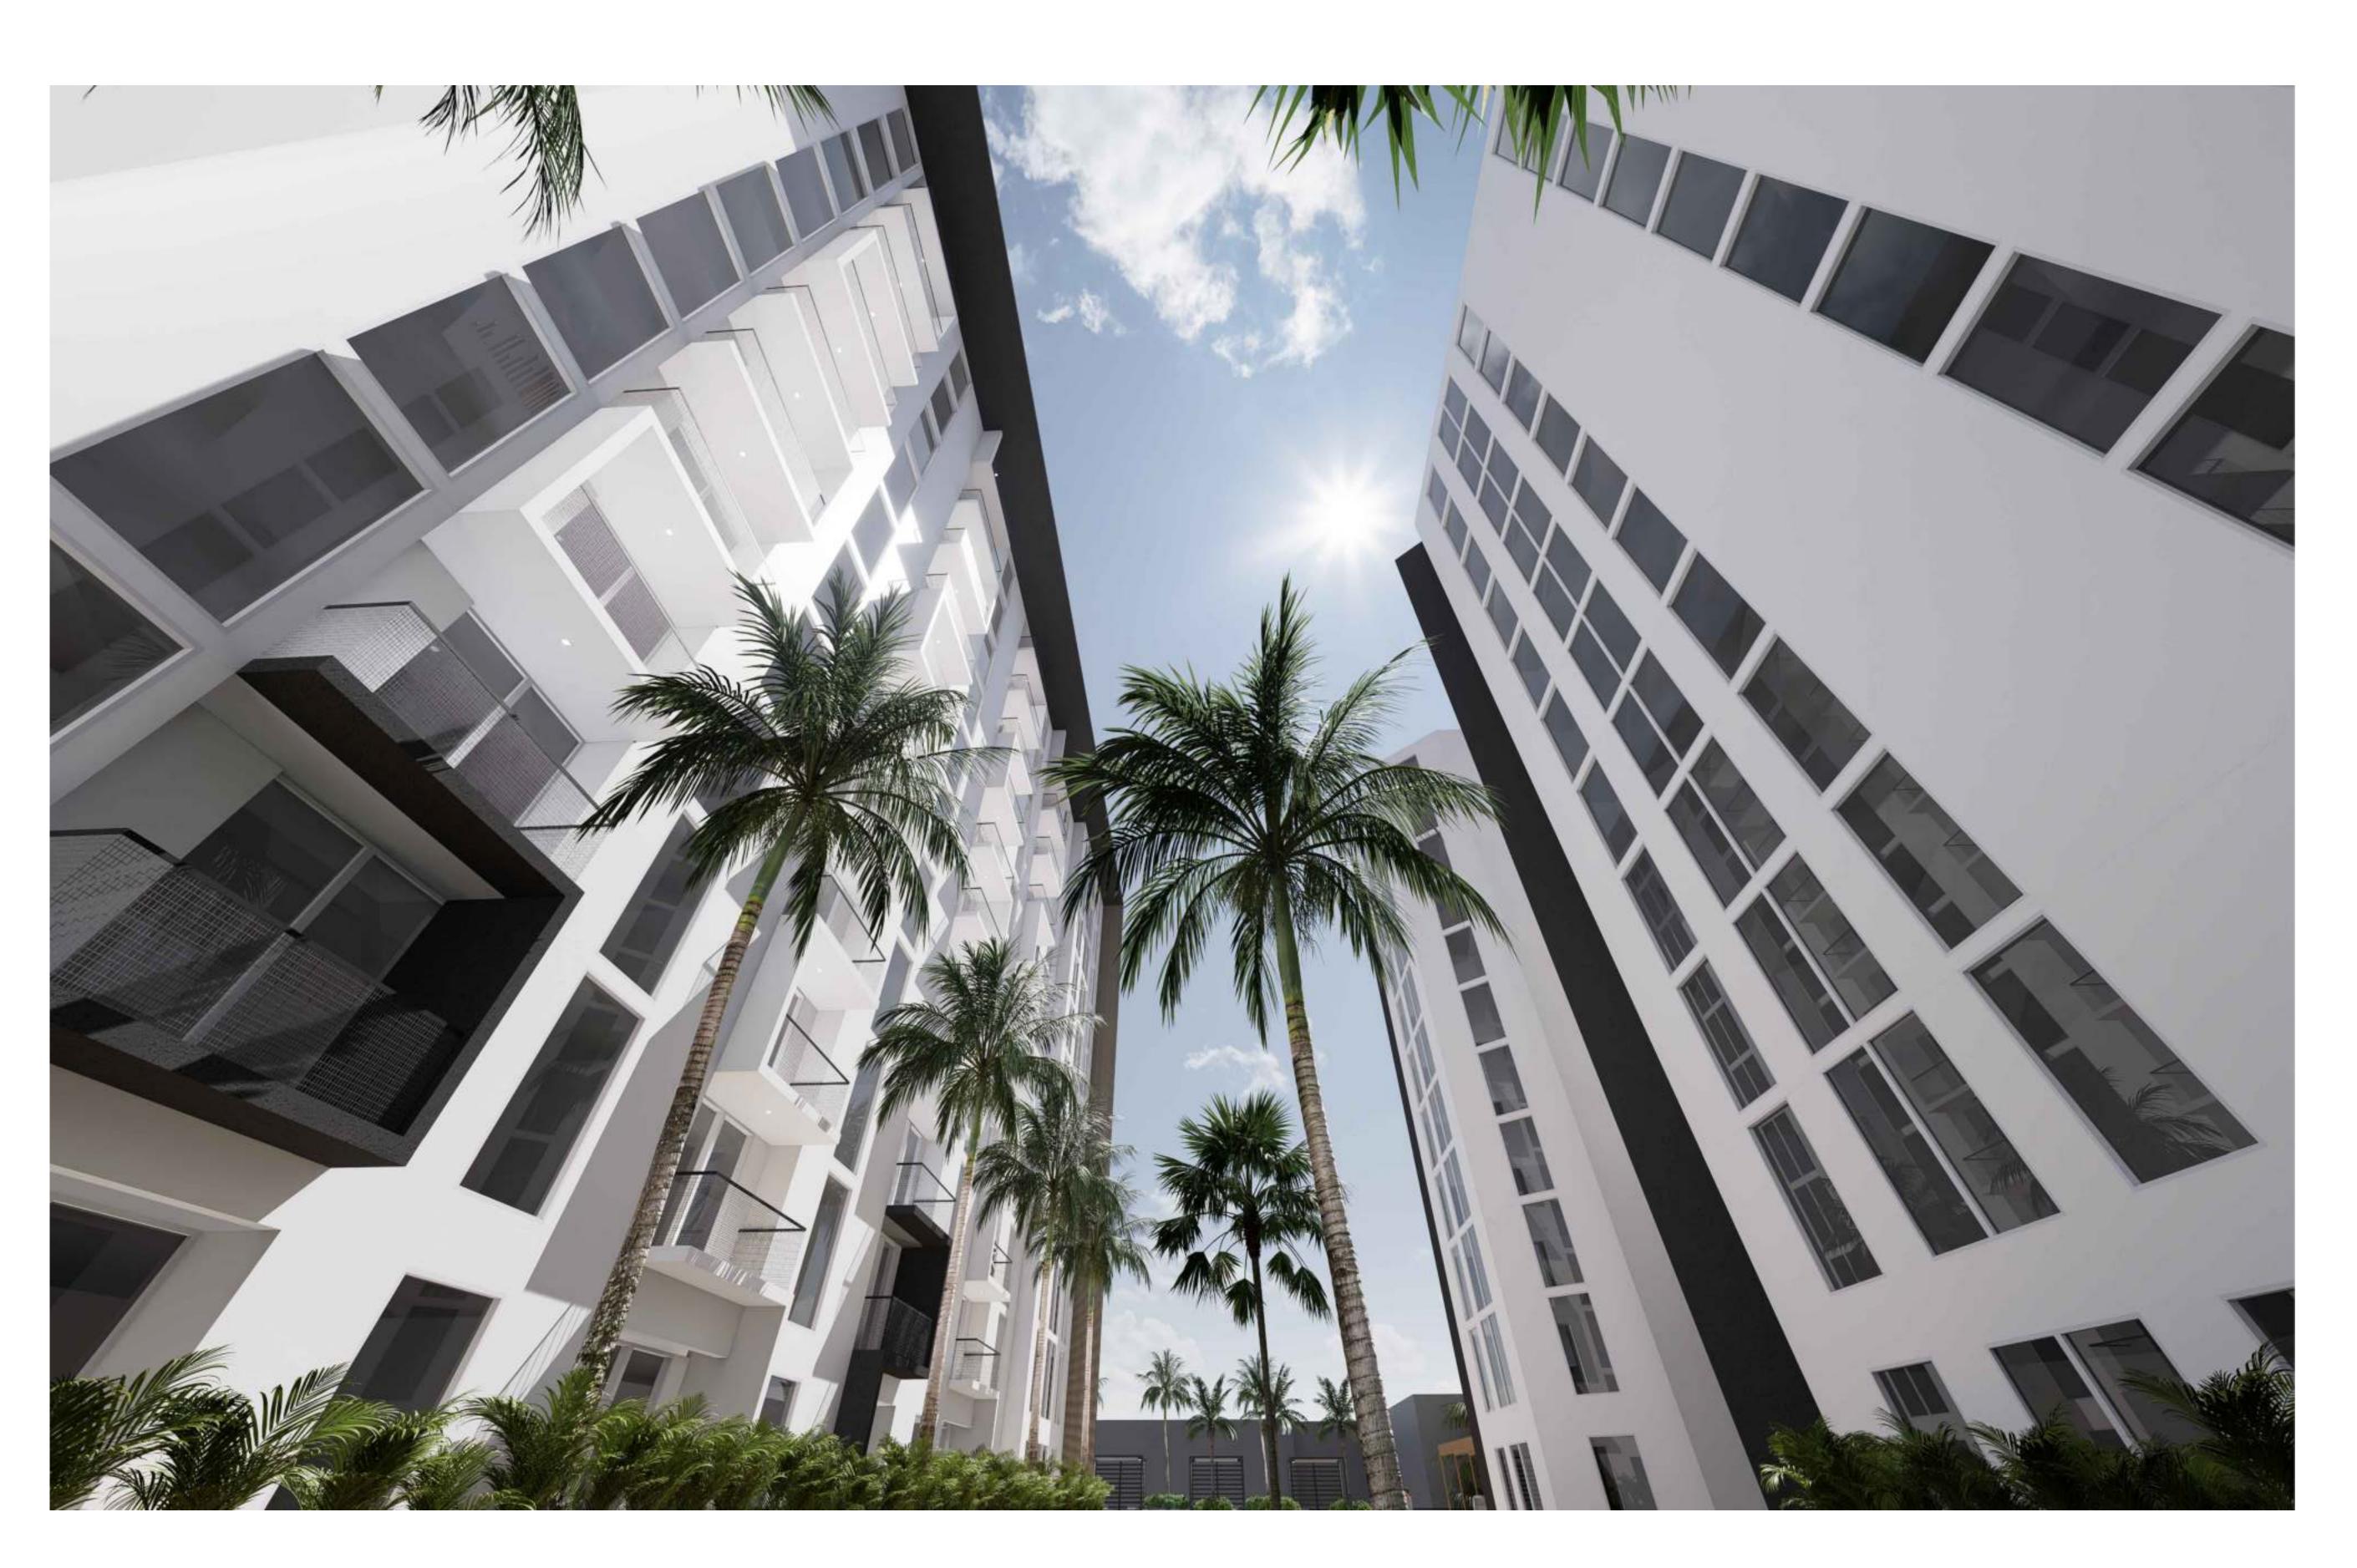

VIEW FROM POOL DECK - TOWER SEPARATION

1 CONCEPTUAL 3D RENDERING 12 A-913 SCALE: NTS




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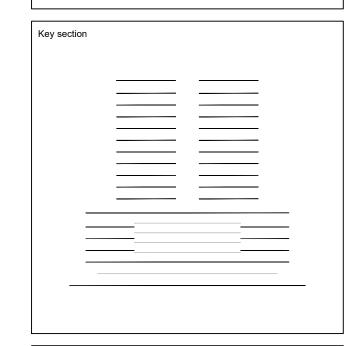






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BAM PROPERTY DEVELOPMENT LLC 1044 BROADWAY, WOODMERE, NY 11598

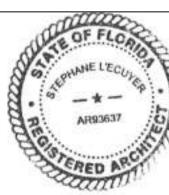650 N ANDREWS MIXED-USE 650 NORTH ANDREWS AVENUE, FORT LAUDERDALE, FL 33311

Title	
	EPTUAL DERING 12
Drawn	Field
J. WU	ARCHITECTURE
Verified	Scale
JF. Gervais	as shown
Approved	Date
S. L'ecuyer	10-10-2024
Project Manager	Dwg. no.

N. TREMBLAY A-913 Project **22-855**





ENLARGED VIEW OF NORTH PLAZA

CONCEPTUAL 3D RENDERING 13 A-914 SCALE: NTS



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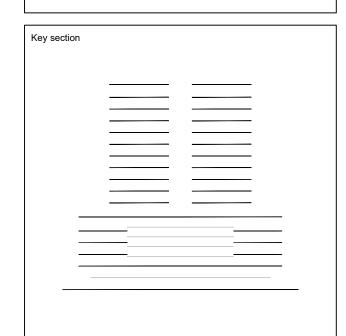
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04	08-13-2024	REV. 3 COMMENTS
05	10-10-2024	REV. 4 COMMENTS

ALL MEASUREMENTS MUST BE VERIFIED BEFORE BEGINNING THE WORKS. NO MEASUREMENTS ARE TO BE SCALED DIRECTLY FROM THIS DRAWING.




BAM PROPERTY DEVELOPMENT LLC 1044 BROADWAY, WOODMERE, NY 11598



EPTUAL DERING 13
Field
ARCHITECTUR
Scale
as shown
Date
10-10-2024
Dwg. no.

A-914 Project **22-855**



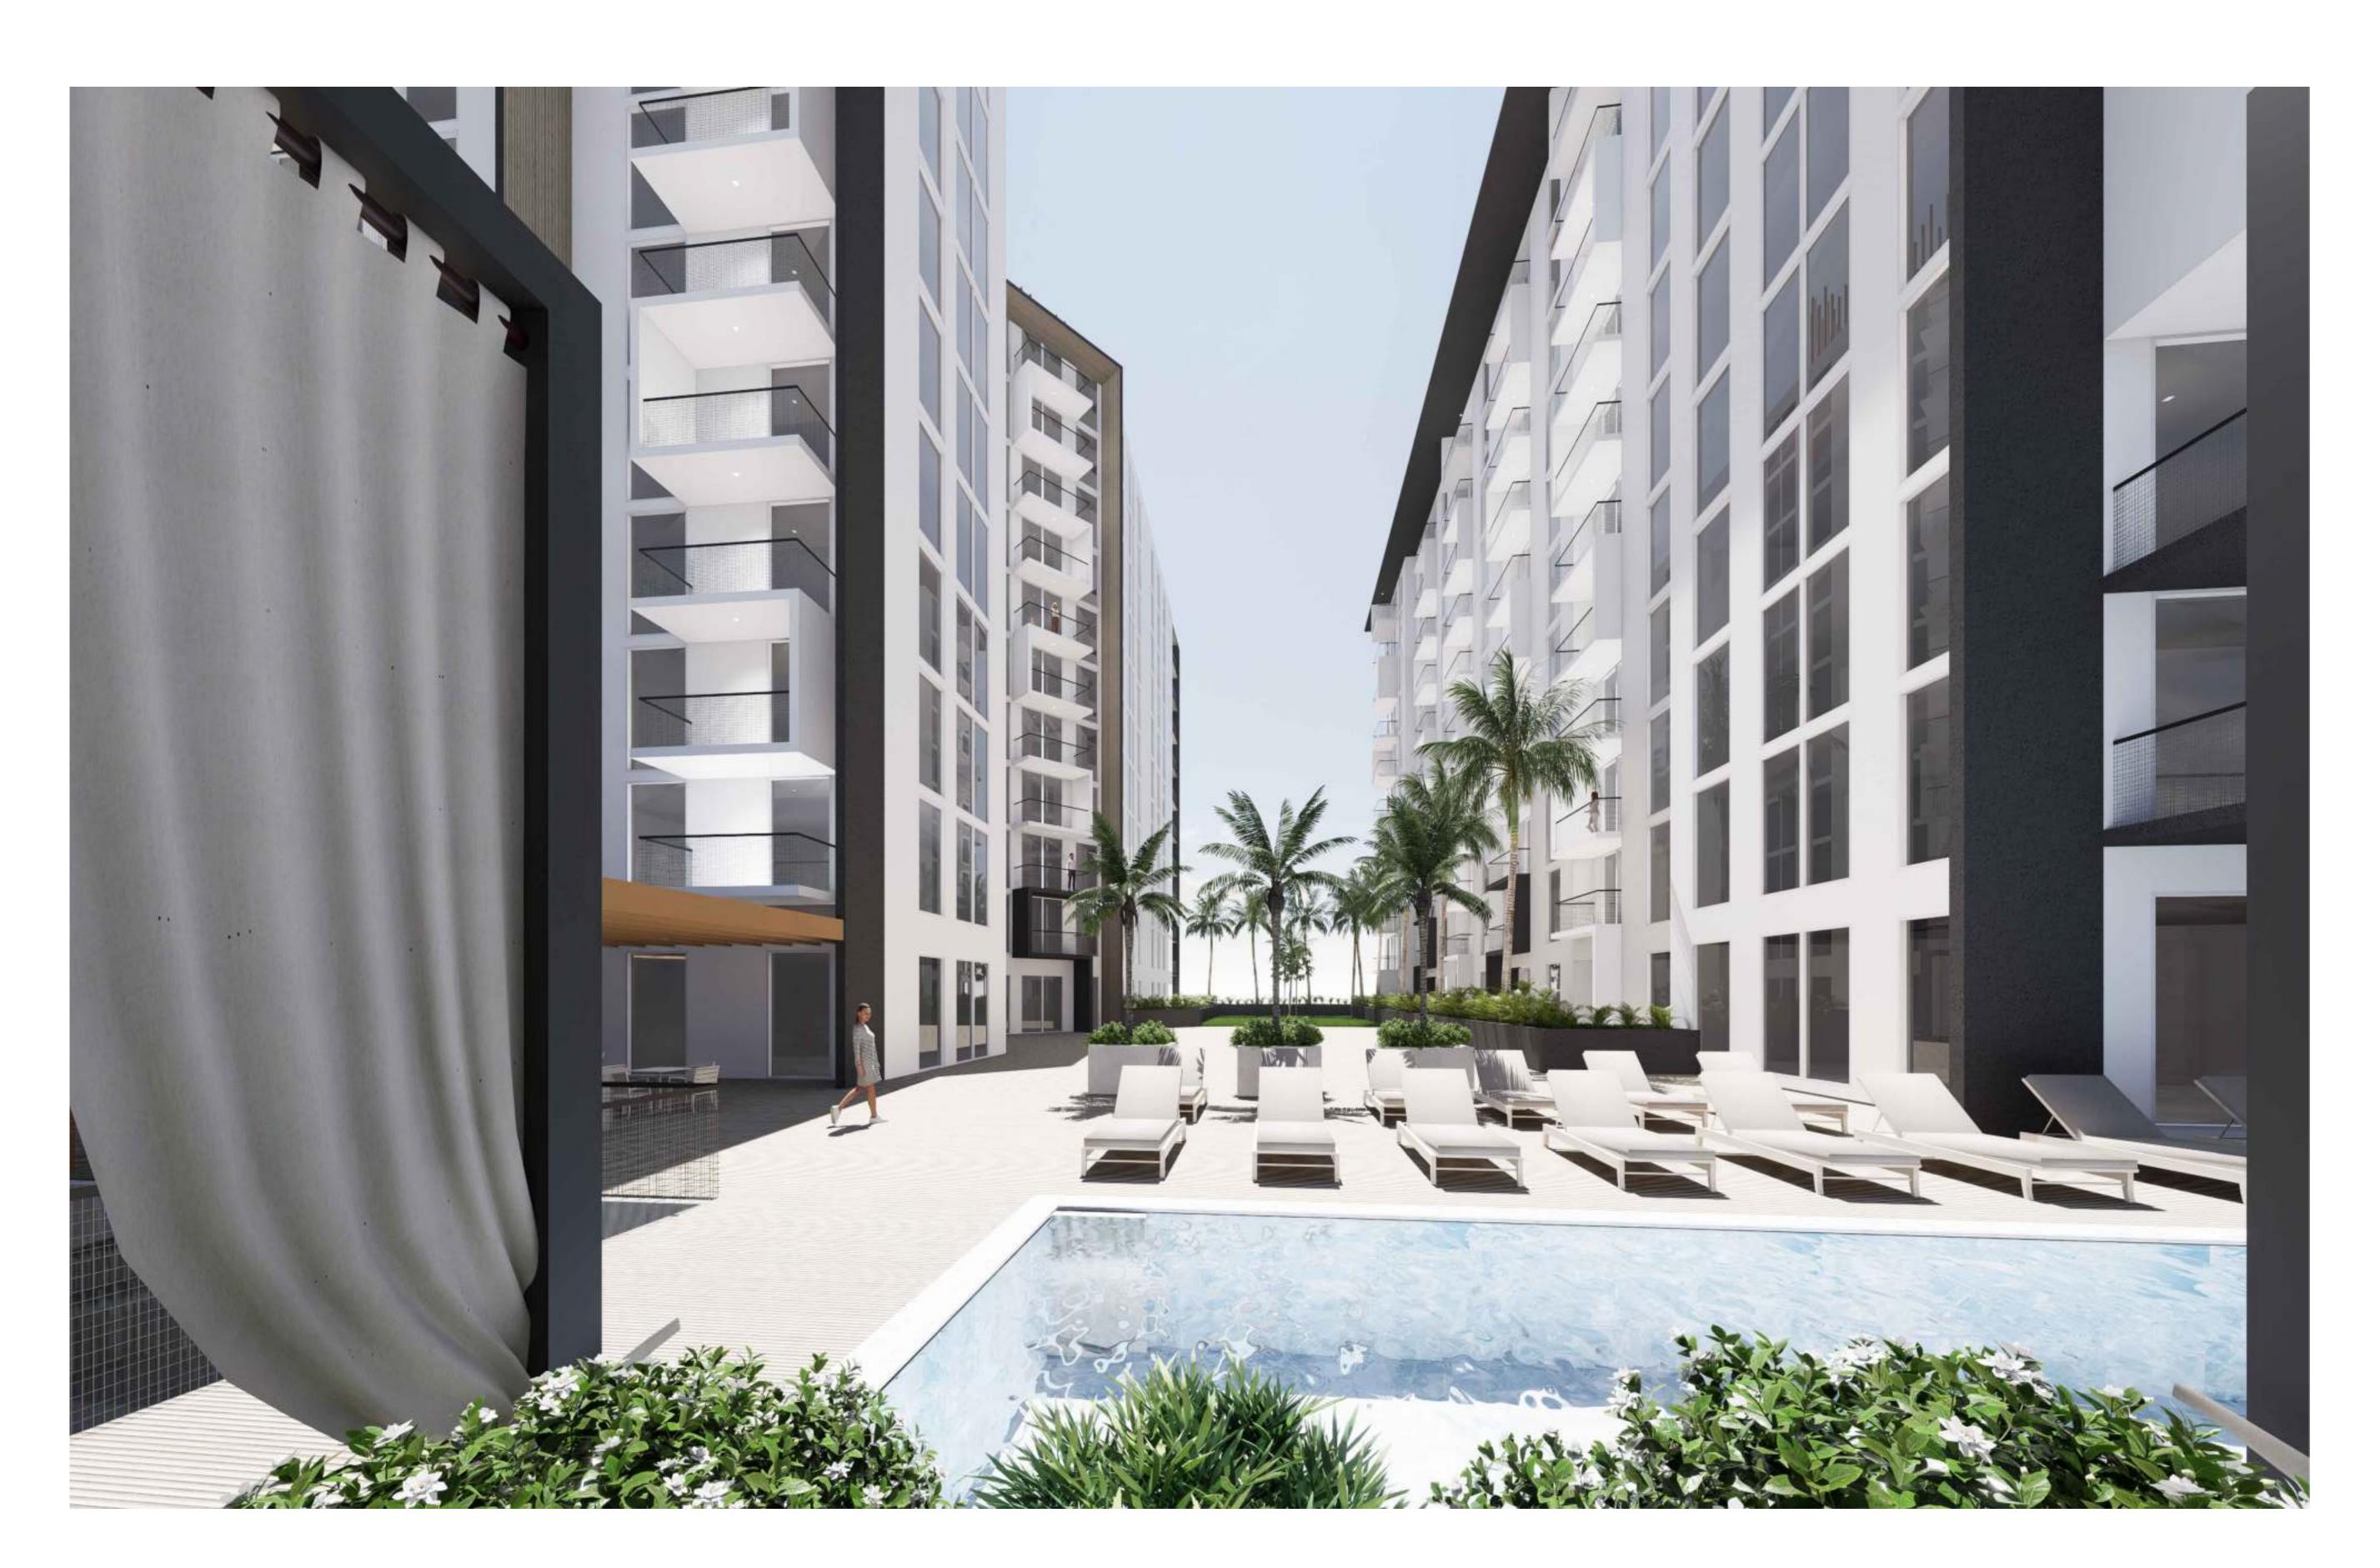

VIEW OF THE POOL DECK LEVEL 4

1 CONCEPTUAL 3D RENDERING 14 A-915 SCALE: NTS



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TO THE BEST OF MY
KNOWLEDGE, THE PLANS
AND SPECIFICATIONS
COMPLY WITH THE
APPLICABLE MINIMUM
BUILDING CODES AND THE
APPLICABLE FIRE-SAFETY
STANDARDS AS DETERMINED
BY THE LOCAL AUTHORITY IN
ACCORDANCE WITH THIS
SECTION AND 633 FLORIDA
STATUES. STEPHANE L'ECUYER AR 93637






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REV.	DATE	DESCRIPTION
01	10-13-2023	D.R.C. SUBMITTAL
02	12-21-2023	REV. 1 COMMENTS
03	04-23-2024	REV. 2 COMMENTS
04	08-13-2024	REV. 3 COMMENTS
05	10-10-2024	REV. 4 COMMENTS

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BAM PROPERTY DEVELOPMENT LLC 1044 BROADWAY, WOODMERE, NY 11598

650 N ANDREWS MIXED-USE 650 NORTH ANDREWS AVENUE, FORT LAUDERDALE, FL 33311

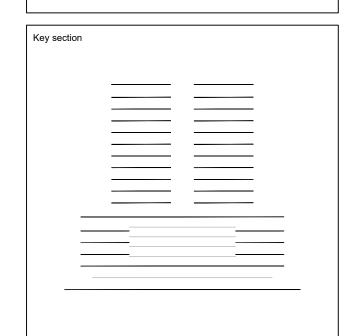
CONCEPTUAL **3D RENDERING 14** J. WU **ARCHITECTURE** JF. Gervais as shown

S. L'ecuyer Project Manager N. TREMBLAY

A-915 22-855

10-10-2024



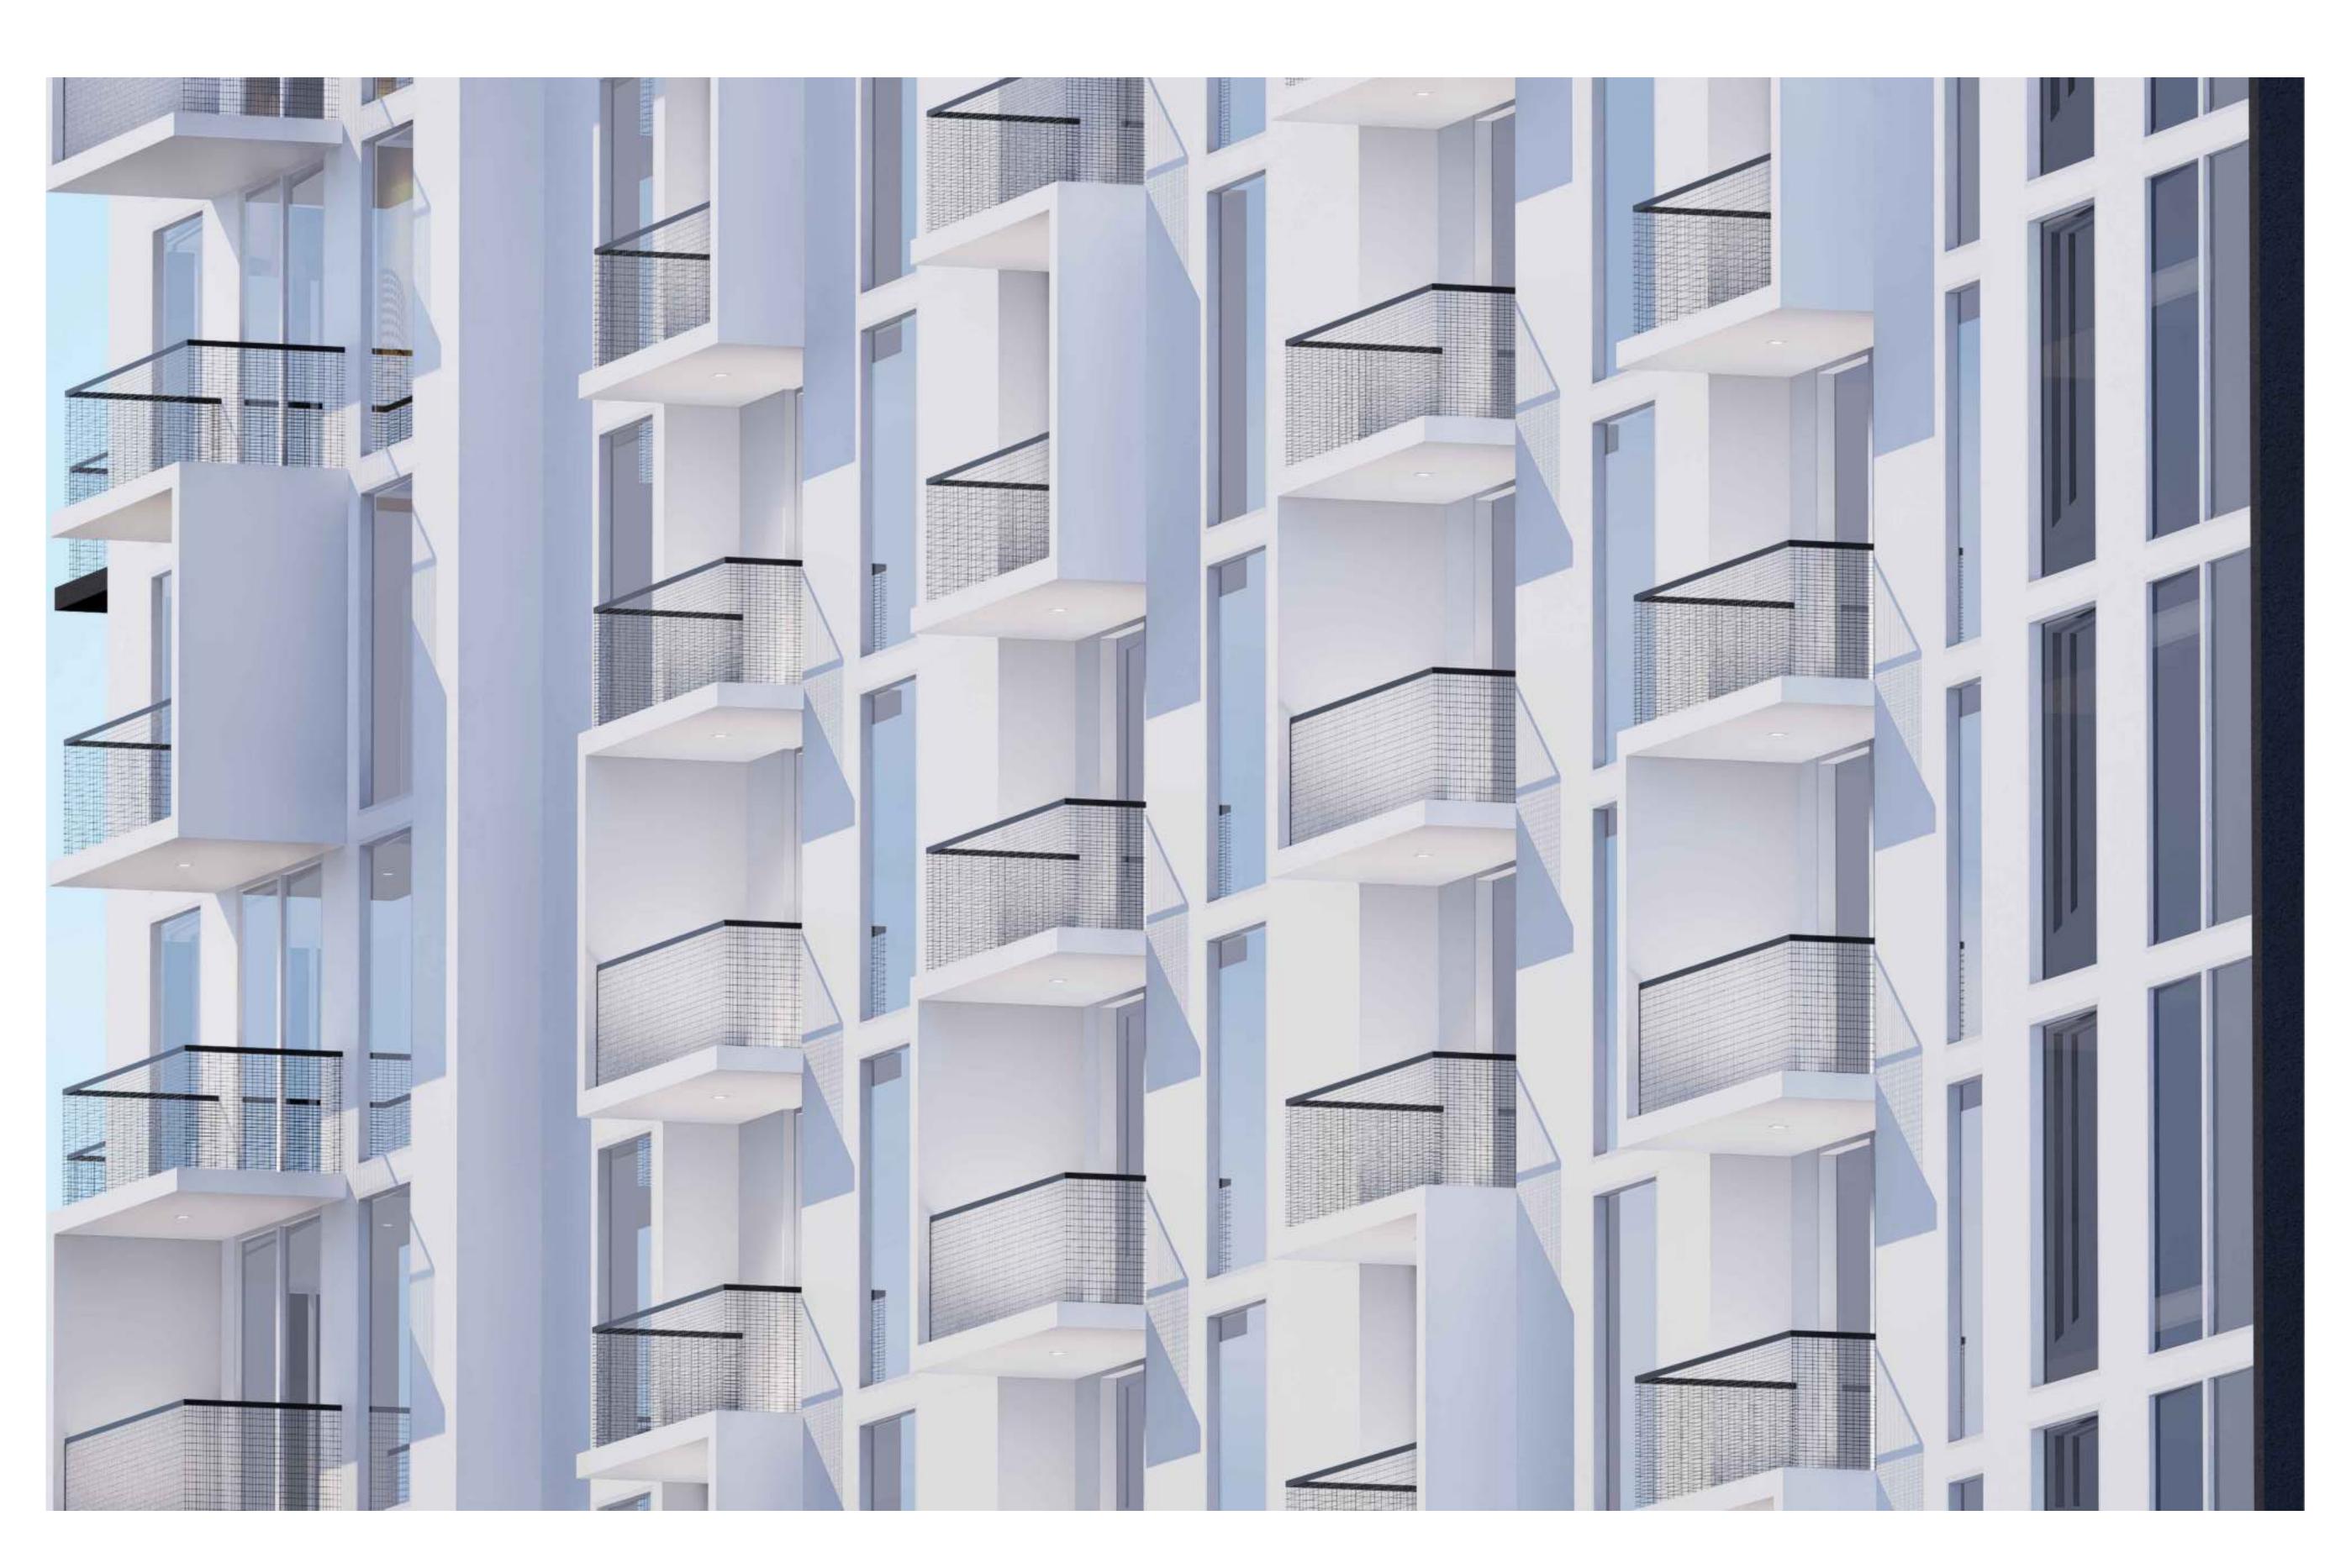

ENLARGED VIEW OF BALCONIES DESIGN 1

1 CONCEPTUAL 3D RENDERING 15 A-916 SCALE: NTS



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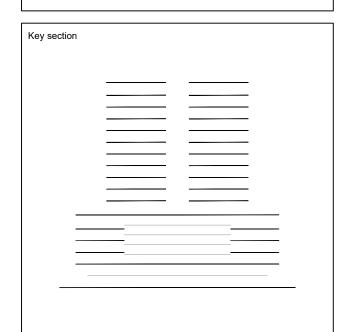
TO THE BEST OF MY
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STATUES. STEPHANE L'ECUYER AR 93637





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04	08-13-2024	REV. 3 COMMENTS
05	10-10-2024	REV. 4 COMMENTS

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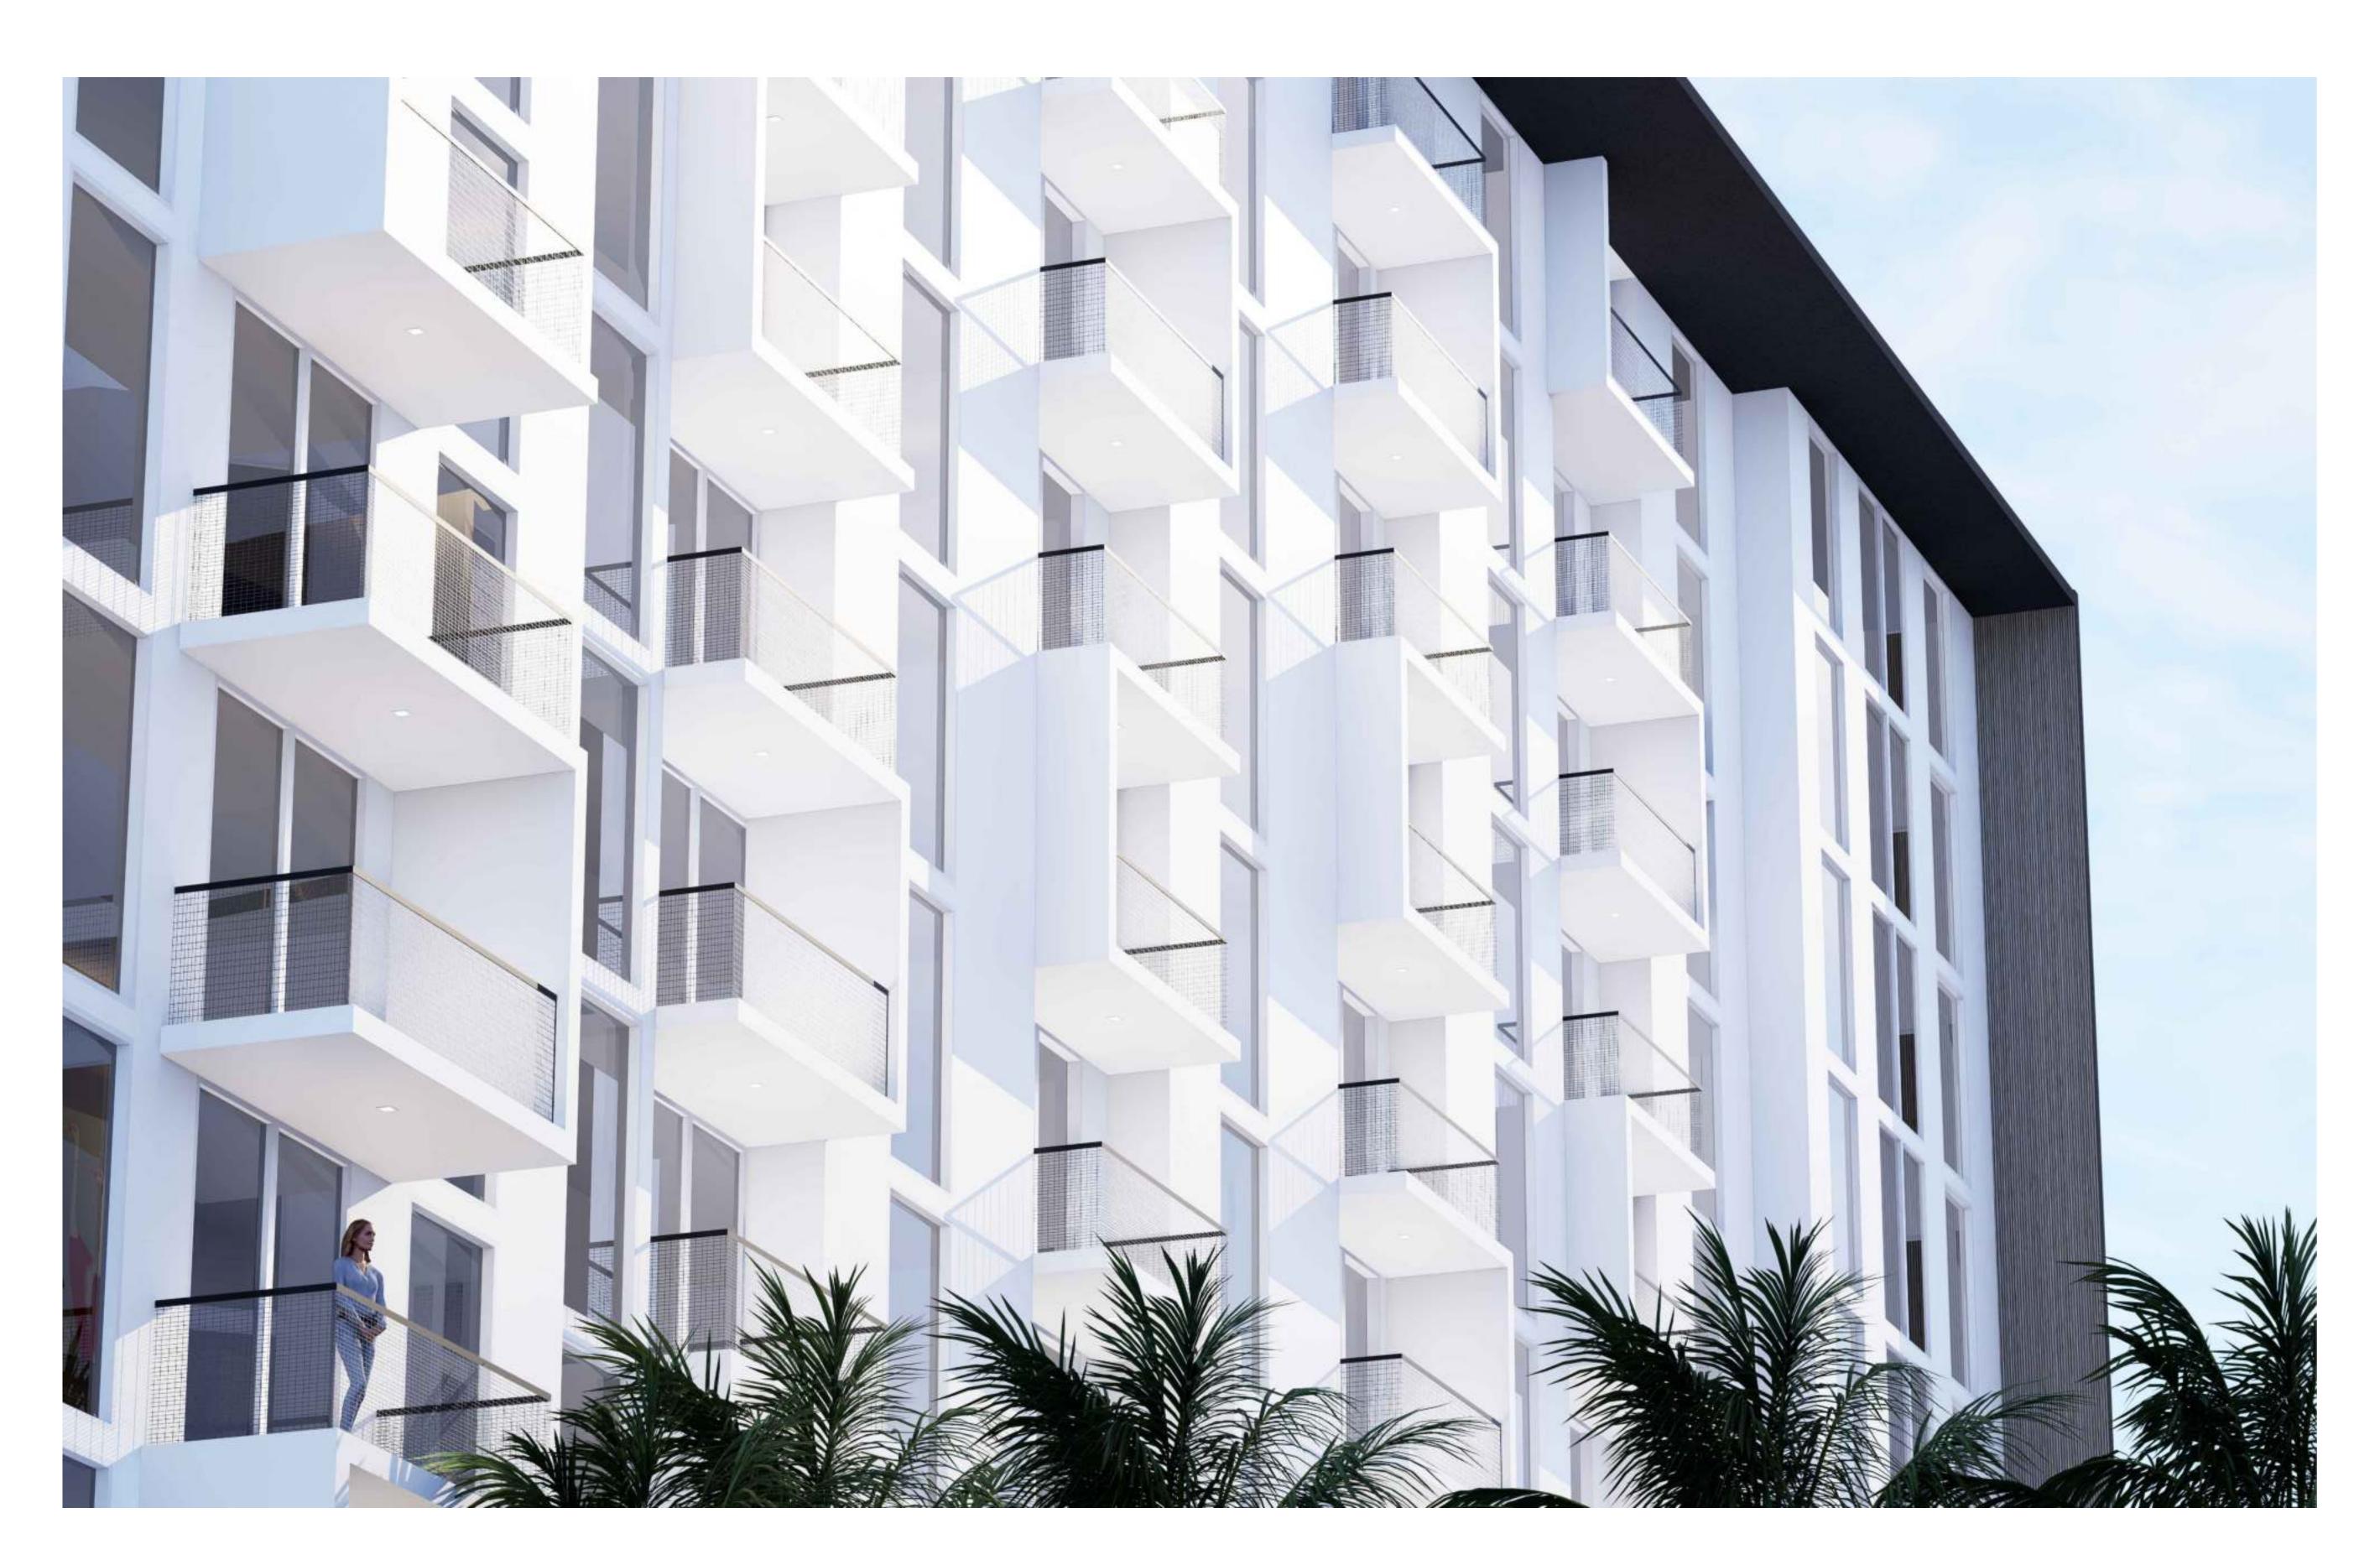
BAM PROPERTY DEVELOPMENT LLC 1044 BROADWAY, WOODMERE, NY 11598

650 N ANDREWS MIXED-USE 650 NORTH ANDREWS AVENUE, FORT LAUDERDALE, FL 33311

CONCEPTUAL **3D RENDERING 15** J. WU **ARCHITECTURE** Verified Scale JF. Gervais as shown S. L'ecuyer 10-10-2024 Project Manager

N. TREMBLAY A-916 22-855





ENLARGED VIEW OF BALCONIES DESIGN 2

1 CONCEPTUAL 3D RENDERING 16

A-917 SCALE: NTS



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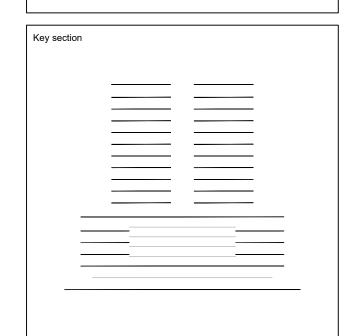
TO THE BEST OF MY
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STATUES.





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03	04-23-2024	REV. 2 COMMENTS
04	08-13-2024	REV. 3 COMMENTS
05	10-10-2024	REV. 4 COMMENTS

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BAM PROPERTY DEVELOPMENT LLC 1044 BROADWAY, WOODMERE, NY 11598

650 N ANDREWS MIXED-USE 650 NORTH ANDREWS AVENUE, FORT LAUDERDALE, FL 33311

CONCEPTUAL 3D RENDERING 16	
Drawn	Field ARCHITECTU
J. WU Verified	Scale
JF. Gervais Approved S. L'ecuyer	as shown Date 10-10-2024
Project Manager	Dwg. no.

A-917 Project **22-855**





NIGHT VIEW OF NORTH FACADE

1 CONCEPTUAL 3D RENDERING 17 A-918 SCALE: NTS



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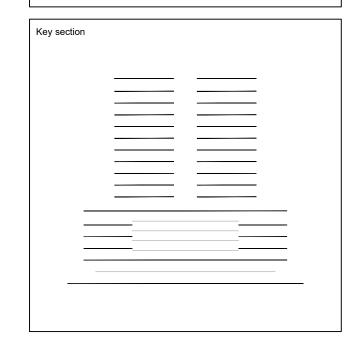
TO THE BEST OF MY
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STATUES. STEPHANE L'ECUYER AR 93637





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BAM PROPERTY DEVELOPMENT LLC 1044 BROADWAY, WOODMERE, NY 11598

650 N ANDREWS MIXED-USE 650 NORTH ANDREWS AVENUE, FORT LAUDERDALE, FL 33311

CONCEPTUAL **3D RENDERING 17** J. WU **ARCHITECTURE** JF. Gervais as shown S. L'ecuyer 10-10-2024

Project Manager N. TREMBLAY

A-918 22-855





VIEW FROM NEIGHBOR'S POOL DECK

1 CONCEPTUAL 3D RENDERING 18


A-919 SCALE: NTS



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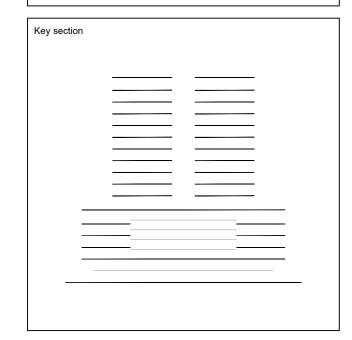
TO THE BEST OF MY
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BAM PROPERTY DEVELOPMENT LLC 1044 BROADWAY, WOODMERE, NY 11598

650 N ANDREWS MIXED-USE 650 NORTH ANDREWS AVENUE, FORT LAUDERDALE, FL 33311

CONCEPTUAL 3D RENDERING 18	
Drawn	Field
J. WU	ARCHITECTUR
Verified	Scale
JF. Gervais	as shown
Approved	Date
S. L'ecuyer	10-10-2024

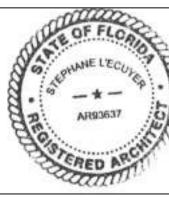N. TREMBLAY 22-855





VIEW FROM STREET LOOKING TO THE PLAZA


1 CONCEPTUAL 3D RENDERING 19 A-920 SCALE: NTS



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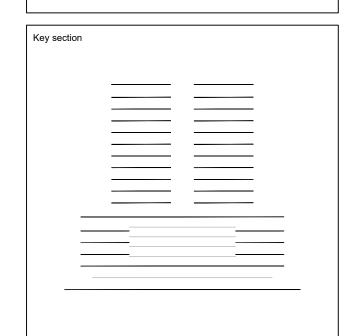
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05	10-10-2024	REV. 4 COMMENTS

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BAM PROPERTY DEVELOPMENT LLC 1044 BROADWAY, WOODMERE, NY 11598

650 N ANDREWS **MIXED-USE** 650 NORTH ANDREWS AVENUE, FORT LAUDERDALE, FL 33311

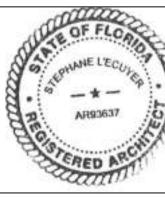CONCEPTUAL **3D RENDERING 19** J. WU **ARCHITECTURE** JF. Gervais as shown S. L'ecuyer 10-10-2024

Project Manager N. TREMBLAY

A-920 22-855





VIEW FROM COVERED PLAZA

1 CONCEPTUAL 3D RENDERING 20 A-921 SCALE: NTS




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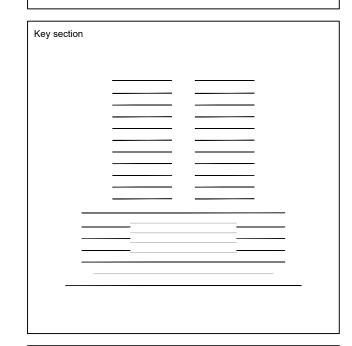
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05	10-10-2024	REV. 4 COMMENTS

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BAM PROPERTY DEVELOPMENT LLC 1044 BROADWAY, WOODMERE, NY 11598

650 N ANDREWS MIXED-USE 650 NORTH ANDREWS AVENUE, FORT LAUDERDALE, FL 33311


CONCEPTUAL **3D RENDERING 20** J. WU **ARCHITECTURE** JF. Gervais as shown S. L'ecuyer 10-10-2024

Project Manager N. TREMBLAY

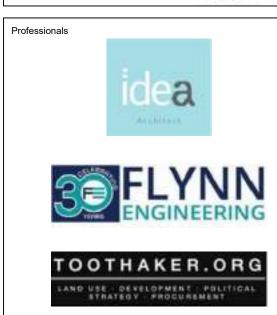A-921 22-855





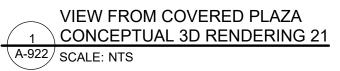



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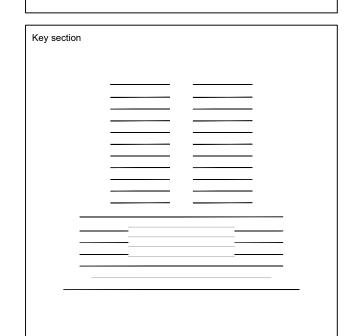
TO THE BEST OF MY
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03	04-23-2024	REV. 2 COMMENTS
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05	10-10-2024	REV. 4 COMMENTS

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BAM PROPERTY DEVELOPMENT LLC 1044 BROADWAY, WOODMERE, NY 11598

650 N ANDREWS **MIXED-USE** 650 NORTH ANDREWS AVENUE, FORT LAUDERDALE, FL 33311

CONCEPTUAL **3D RENDERING 21** J. WU **ARCHITECTURE** JF. Gervais as shown S. L'ecuyer 10-10-2024

Project Manager N. TREMBLAY

22-855





VIEW OF VERTICAL ELEMENT

1 CONCEPTUAL 3D RENDERING 22


A-923 SCALE: NTS




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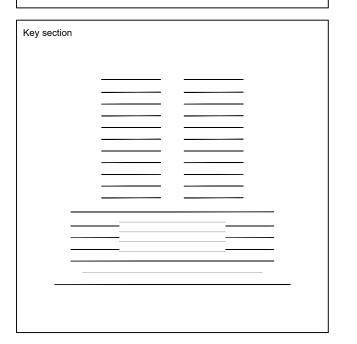
TO THE BEST OF MY
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03	04-23-2024	REV. 2 COMMENTS
04	08-13-2024	REV. 3 COMMENTS
05	10-10-2024	REV. 4 COMMENTS

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BAM PROPERTY DEVELOPMENT LLC 1044 BROADWAY, WOODMERE, NY 11598

650 N ANDREWS MIXED-USE 650 NORTH ANDREWS AVENUE, FORT LAUDERDALE, FL 33311

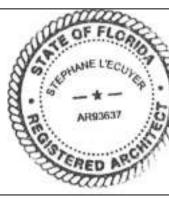Title	
	EPTUAL ERING 22
Drawn	Field
J. WU	ARCHITECTURE
Verified	Scale
JF. Gervais Approved S. L'ecuyer	as shown Date 10-10-2024
Project Manager N. TREMBLAY	Dwg. no.
Project	A-923

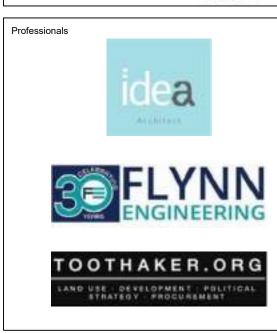Project **22-855**





VIEW OF BALCONY DETAILS / EAST FACADE

1 CONCEPTUAL 3D RENDERING 23 A-924 SCALE: NTS



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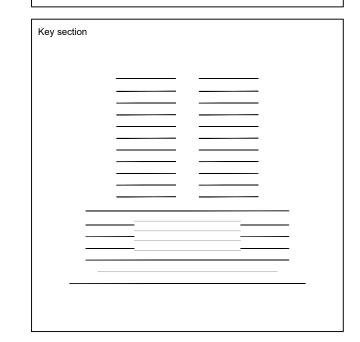
TO THE BEST OF MY
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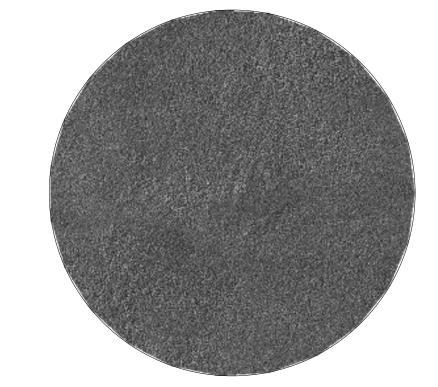
650 N ANDREWS **MIXED-USE** 650 NORTH ANDREWS AVENUE, FORT LAUDERDALE, FL 33311

CONCEPTUAL **3D RENDERING 23** J. WU **ARCHITECTURE** Verified Scale JF. Gervais as shown S. L'ecuyer 10-10-2024

Project Manager N. TREMBLAY 22-855

A-924





PAINT COLOR AF-685 THUNDER BENJAMIN MOORE OR EQUIVALENT APPROVED BY ARCHITECT



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STEPHANE L'ECUYER AR 93637








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(02	12-21-2023	REV. 1 COMMENTS
(03	04-23-2024	REV. 2 COMMENTS
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BAM PROPERTY DEVELOPMENT LLC 1044 BROADWAY, WOODMERE, NY 11598

650 N ANDREWS **MIXED-USE**

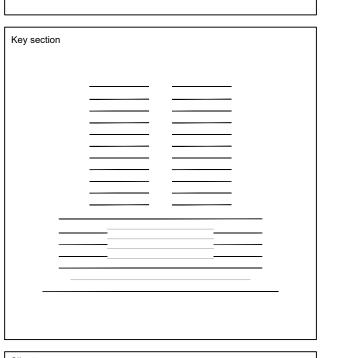
650 NORTH ANDREWS AVENUE, FORT LAUDERDALE, FL 33311


CONCEPTUAL **3D RENDERING 24 & 25**

> **ARCHITECTURE** as shown JF. Gervais S. L'ecuyer 10-10-2024

Project Manager N. TREMBLAY

9 WOOD-POLYPROPYLENE COMPOSITE
NICHIHA RIFTSAWN
CHESTNUT

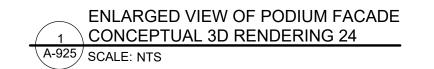

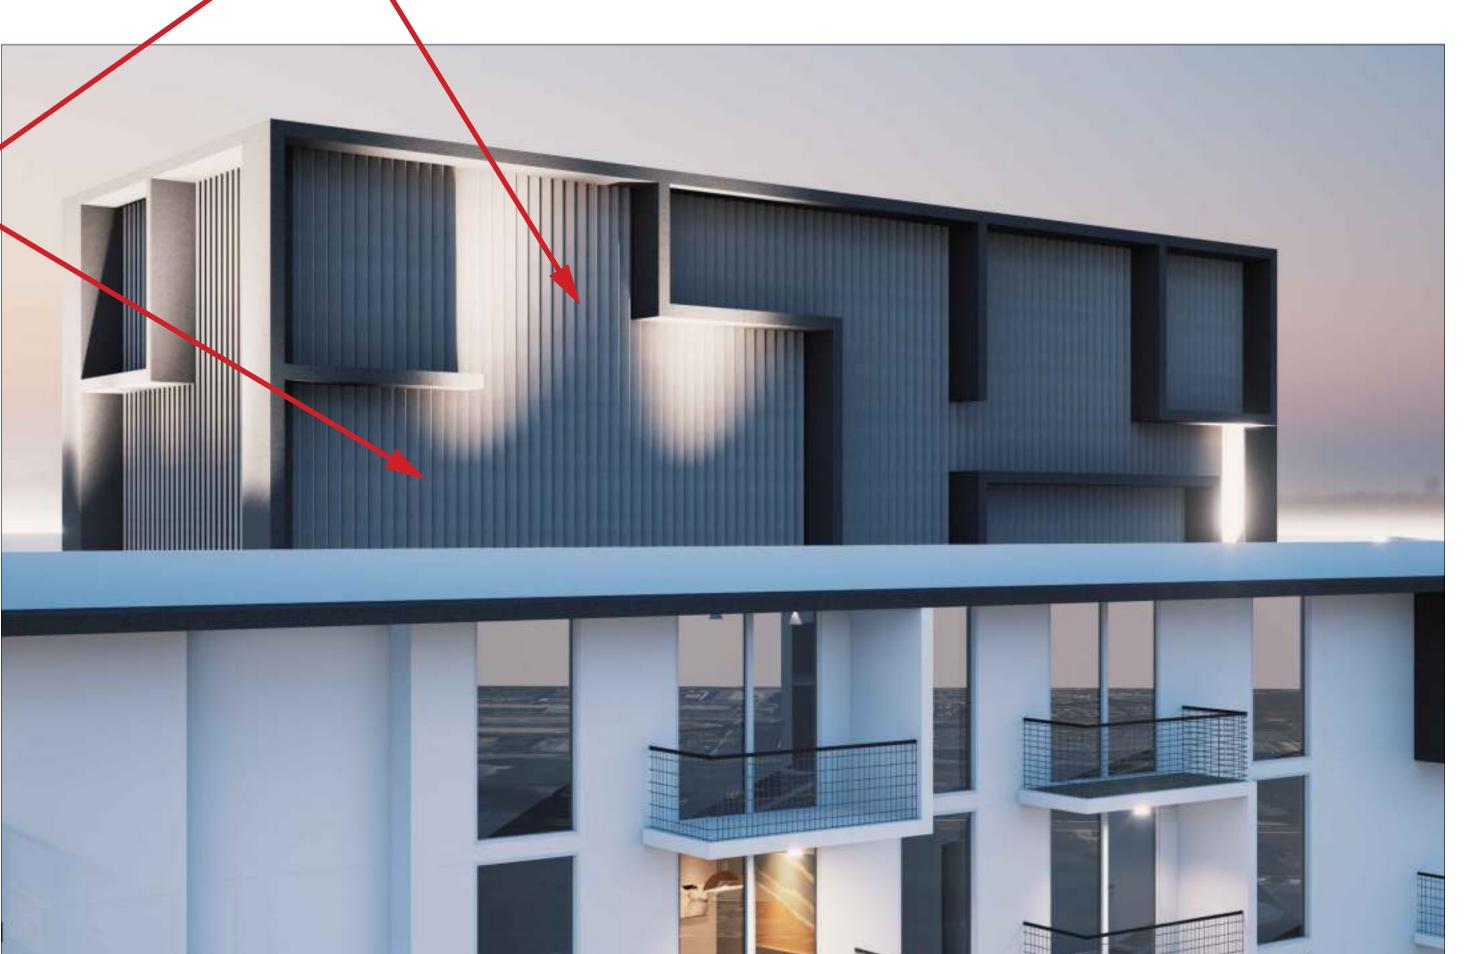


ENLARGED VIEW OF ROOF SCREEN

CONCEPTUAL 3D RENDERING 25

A-925 SCALE: NTS

22-855

CAM # 24-1102 Exhibit 3 Page 49 of 66

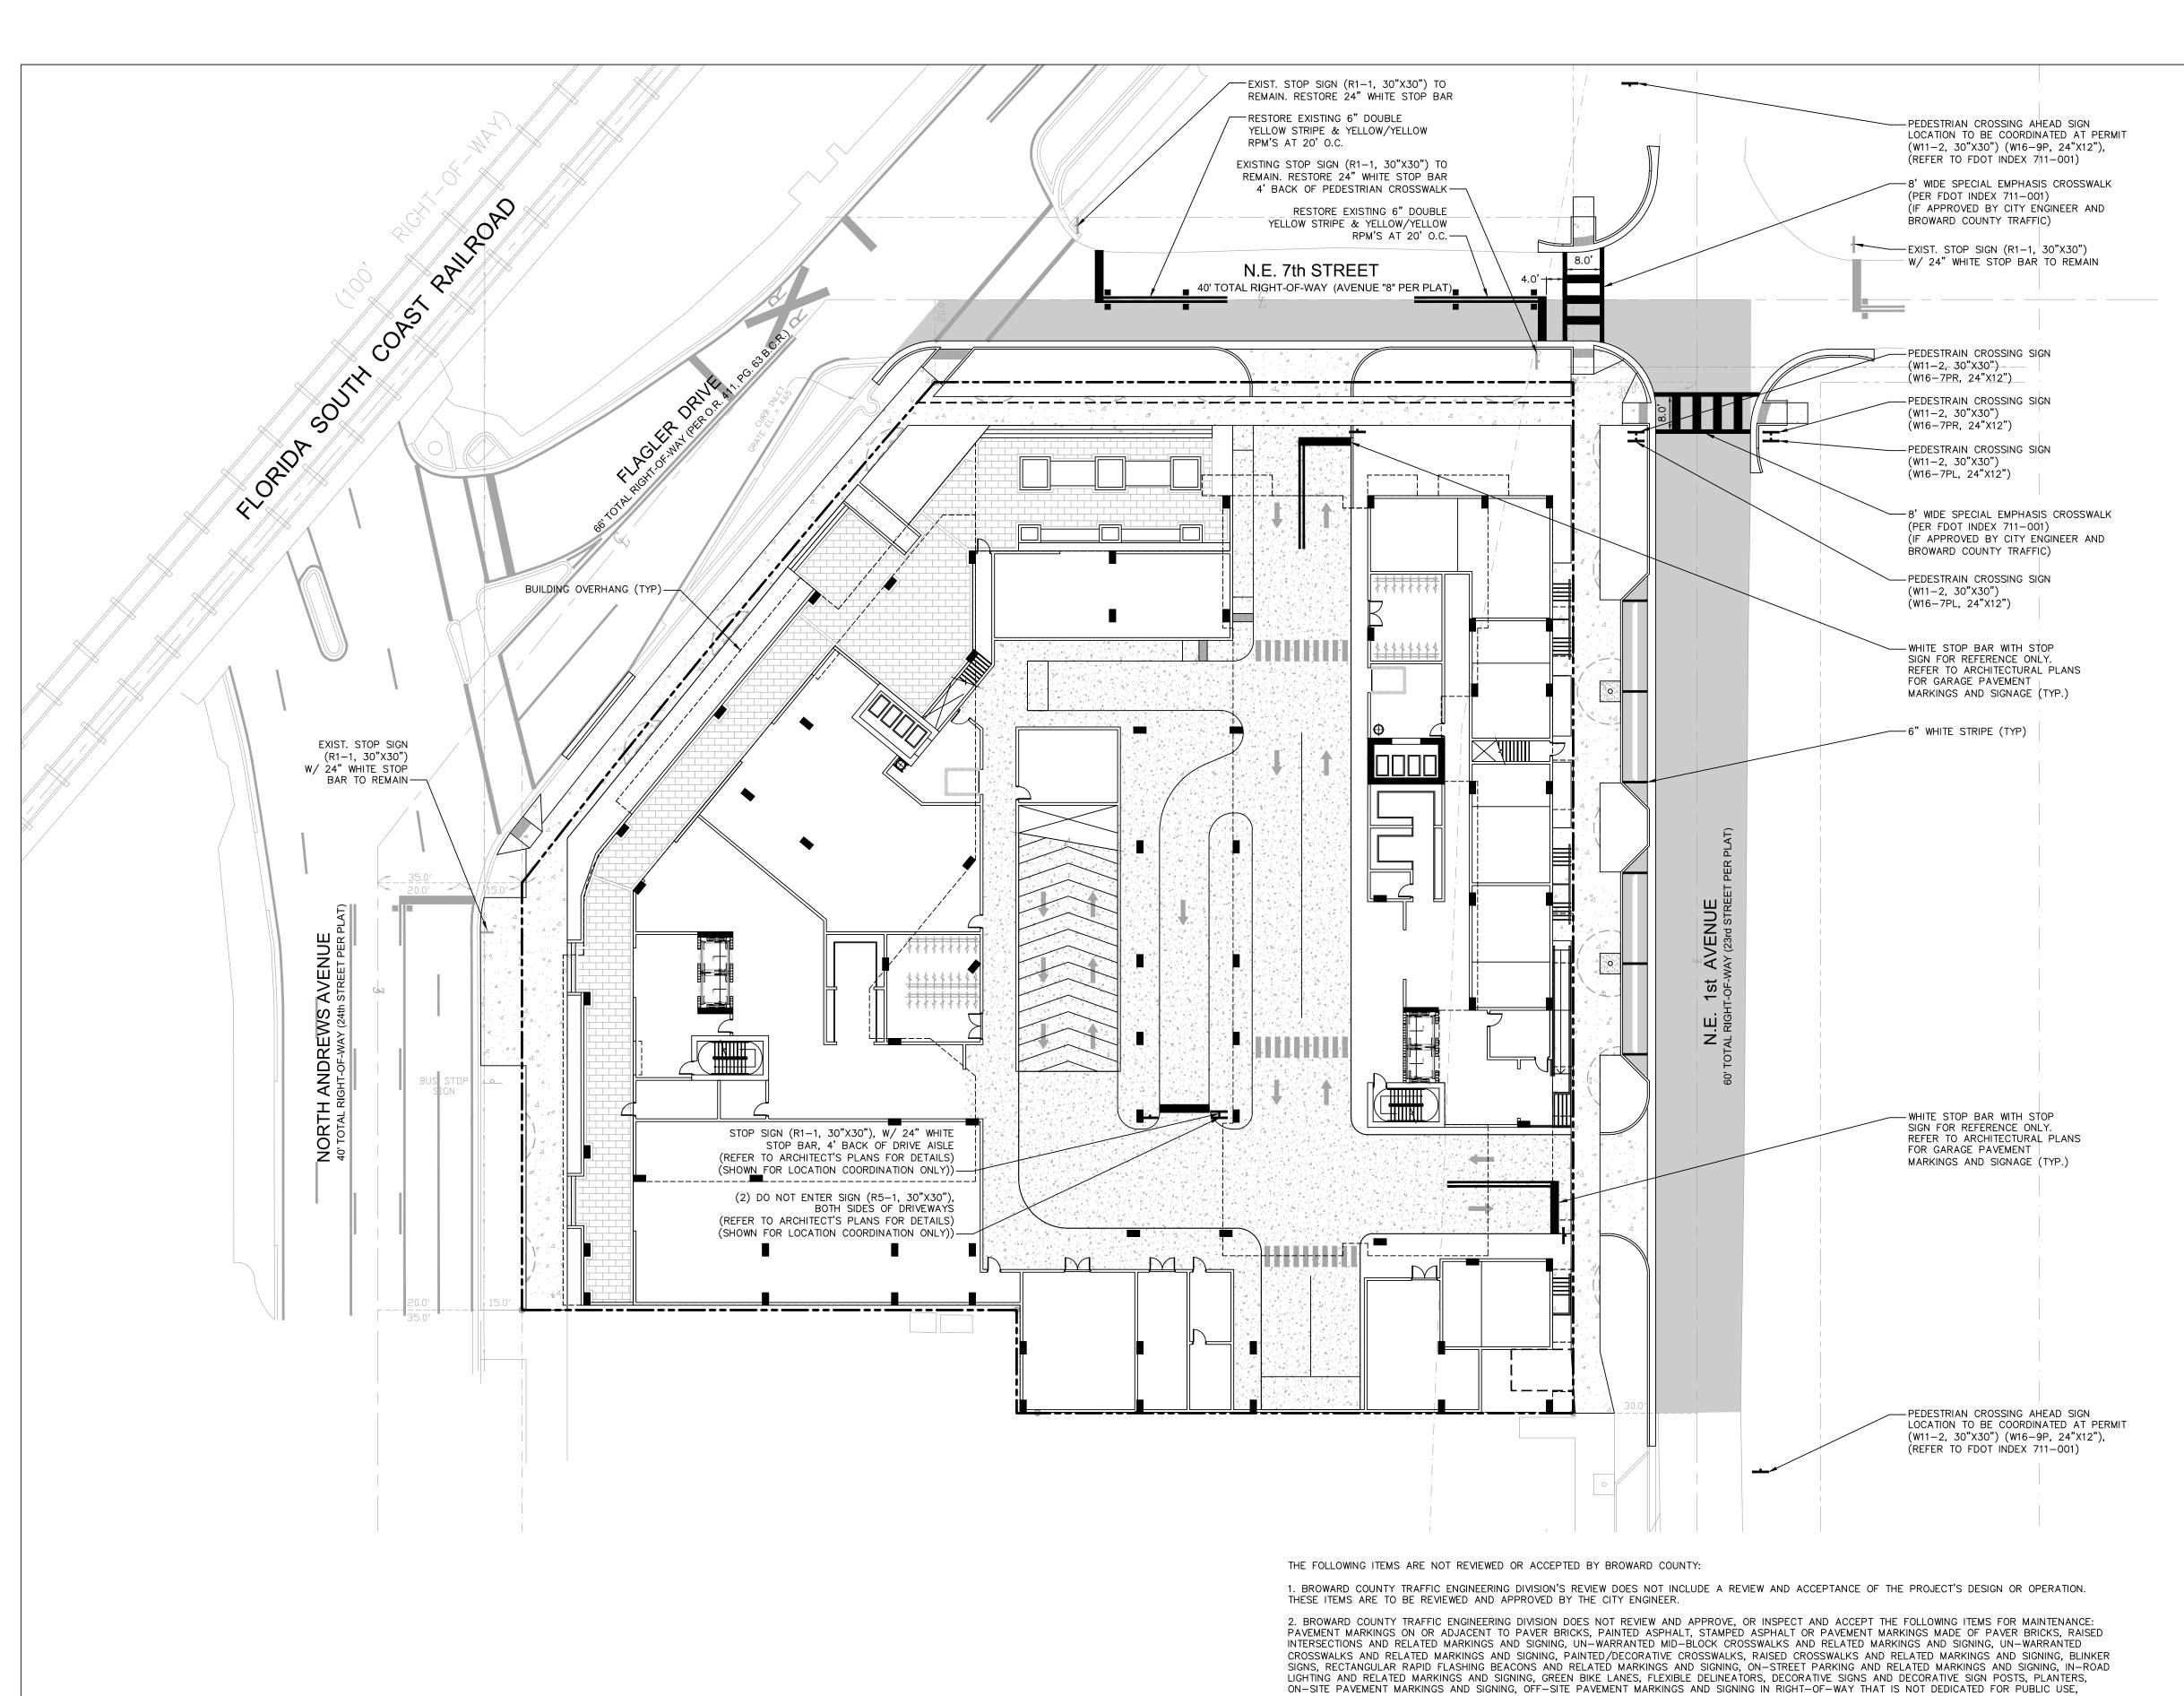

This document has been digitally

signed and sealed by Blake M. Kidwell on 10/10/2024.

Printed copies of this document are not

considered signed and sealed.

SUNRISE BLVD NE 6TH STREET BROWARD BLVD **LOCATION MAP**

LEGEND:

0.00 PROPOSED ELEVATION (NAVD)

\$\phi 5.32 EXISTING ELEVATION (NAVD) PROPOSED CATCH BASIN PROPOSED PLUG

--|_t|-- TEE WATER METER

DOUBLE DETECTOR CHECK W/ WAFER CHECK VALVE ON DOWNSTREAM SIDE REDUCED PRESSURE BACKFLOW PREVENTOR

DIRECTIONAL FLOW ARROW AND GRAVITY SEWER

PROPOSED MANHOLE

— W — WATER MAIN -FM - SANITARY FORCE MAIN

VALVE FIRE HYDRANT SIAMESE CONNECTION CLEANOUT

EDGE OF PROPOSED PAVEMENT (ASPHALT) DIRECTION OF SURFACE DRAINAGE SAMPLE POINT

EXIST. UTILITY LINE TO BE ABANDONED IN PLACE

--W-- EXIST. WATER MAIN


SIGNAGE AND MARKING NOTES:

1. ALL SIGNAGE AND PAVEMENT MARKINGS SHALL CONFORM TO THE MANUAL OF UNIFORM TRAFFIC CONTROL DEVICES, (MUTCD) AND B.C.T.E.D. STANDARDS (CURRENT EDITION).

2. ALL PAVEMENT MARKING AND SIGNAGE DAMAGED DURING CONSTRUCTION, SHALL BE RESTORED TO BROWARD COUNTY TRAFFIC ENGINEERING STANDARD (CURRENT EDITION).

3. REMOVAL OF PAVEMENT MARKINGS SHALL BE BY SAND OR HYDROBLASTING AS REQUIRED BY B.C.T.E.D.

4. ALL PAVEMENT MARKINGS ON ASPHALT SHALL BE THERMOPLASTIC WITH THE EXCEPTION OF PARKING STALL STRIPING WHICH SHALL BE REGULAR PAINT.

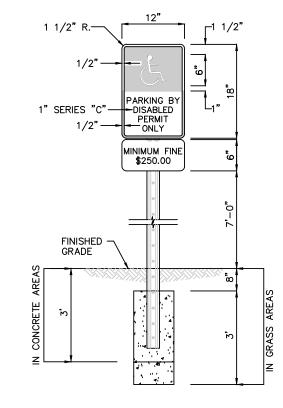

NOTES:

1> SIGN MUST BE POSTED AND THE BOTTOM OF THE SIGN MUST BE AT LEAST 7'-0" ABOVE FINISHED GRADE 2) LOCATE SIGN @ CENTERLINE AND HEAD OF EACH HANDICAP STALL WHERE APPLICABLE.


3) SIGNS IN CONCRETE AREAS ARE TO BE EMBEDDED FOR A DEPTH OF 3' HANDICAPPED PARKING SIGN


FTP-25 W/ SUPPLEMENTAL 12"x6" "MINIMUM FINE \$250.00" SIGN


SIDEWALK WORK OR ASPHALT WORK. 3. THE CITY ENGINEER IS RESPONSIBLE FOR THE REVIEW AND APPROVAL OF THE DESIGN AND OPERATION OF THE PROJECT AND FOR THE INSPECTION AND ACCEPTANCE OF THE FOLLOWING ITEMS THAT WILL BE MAINTAINED BY THE CITY: PAVEMENT MARKINGS ON OR ADJACENT TO PAVER BRICKS, PAINTED ASPHALT, STAMPED ASPHALT OR PAVEMENT MARKINGS MADE OF PAVER BRICKS, PAVEMENT MARKINGS ON OR ADJACENT TO PAVER BRICKS. STAMPED ASPHALT OR PAVEMENT MARKINGS MADE OF PAVER BRICKS, RAISED INTERSECTIONS AND RELATED MARKINGS AND SIGNING, UN-WARRANTED MID-BLOCK CROSSWALKS AND RELATED MARKINGS AND SIGNING, UN-WARRANTED CROSSWALKS AND RELATED MARKINGS AND SIGNING, PAINTED/DECORATIVE CROSSWALKS, RAISED CROSSWALKS AND RELATED MARKINGS AND SIGNING, BLINKER SIGNS, RECTANGULAR RAPID FLASHING BEACONS AND RELATED MARKINGS AND SIGNING,

ON-STREET PARKING AND RELATED MARKINGS AND SIGNING, IN-ROAD LIGHTING AND RELATED MARKINGS AND SIGNING, GREEN BIKE LANES, FLEXIBLE DELINEATORS, DECORATIVE SIGNS AND DECORATIVE SIGN POSTS, PLANTERS, ON-SITE PAVEMENT MARKINGS AND SIGNING, OFF-SITE PAVEMENT MARKINGS AND SIGNING IN RIGHT-OF WAY THAT IS NOT DEDICATED FOR PUBLIC USE, SIDEWALK WORK OR ASPHALT WORK.

4. ALL TRAFFIC CONTOL DEVICES THAT ARE MAINTAINED BY BROWARD COUNTY, THAT ARE REMOVED OR DAMAGED BY CONSTRUCTION, SHALL BE REPLACED BY CONTRACTOR USING CURRENT BROWARD COUNTY TRAFFIC ENGINEERING DESIGN STANDARDS.

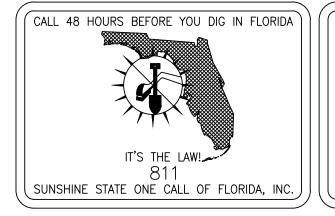

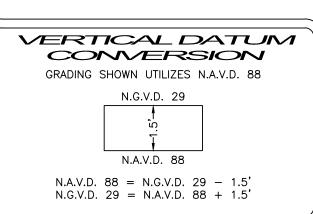


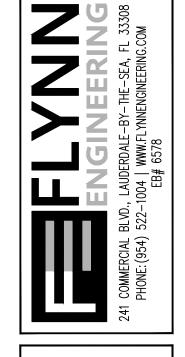


EME SIGI


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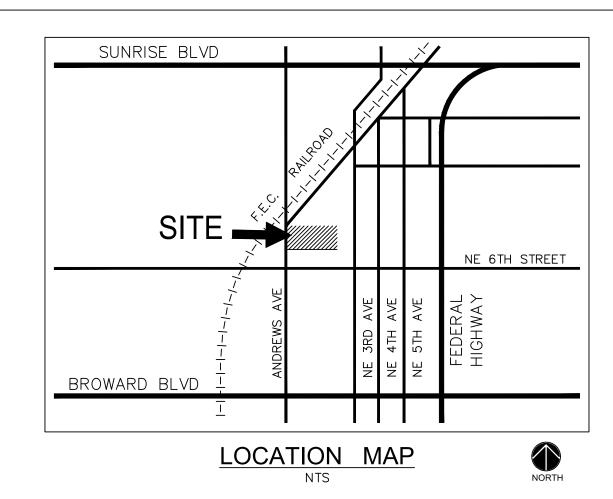
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LEGEND:

0.00 PROPOSED ELEVATION (NAVD)\$5.32 EXISTING ELEVATION (NAVD)

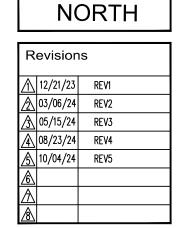PROPOSED CATCH BASIN

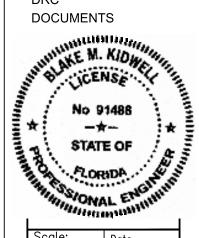[PROPOSED PLUG

TEE

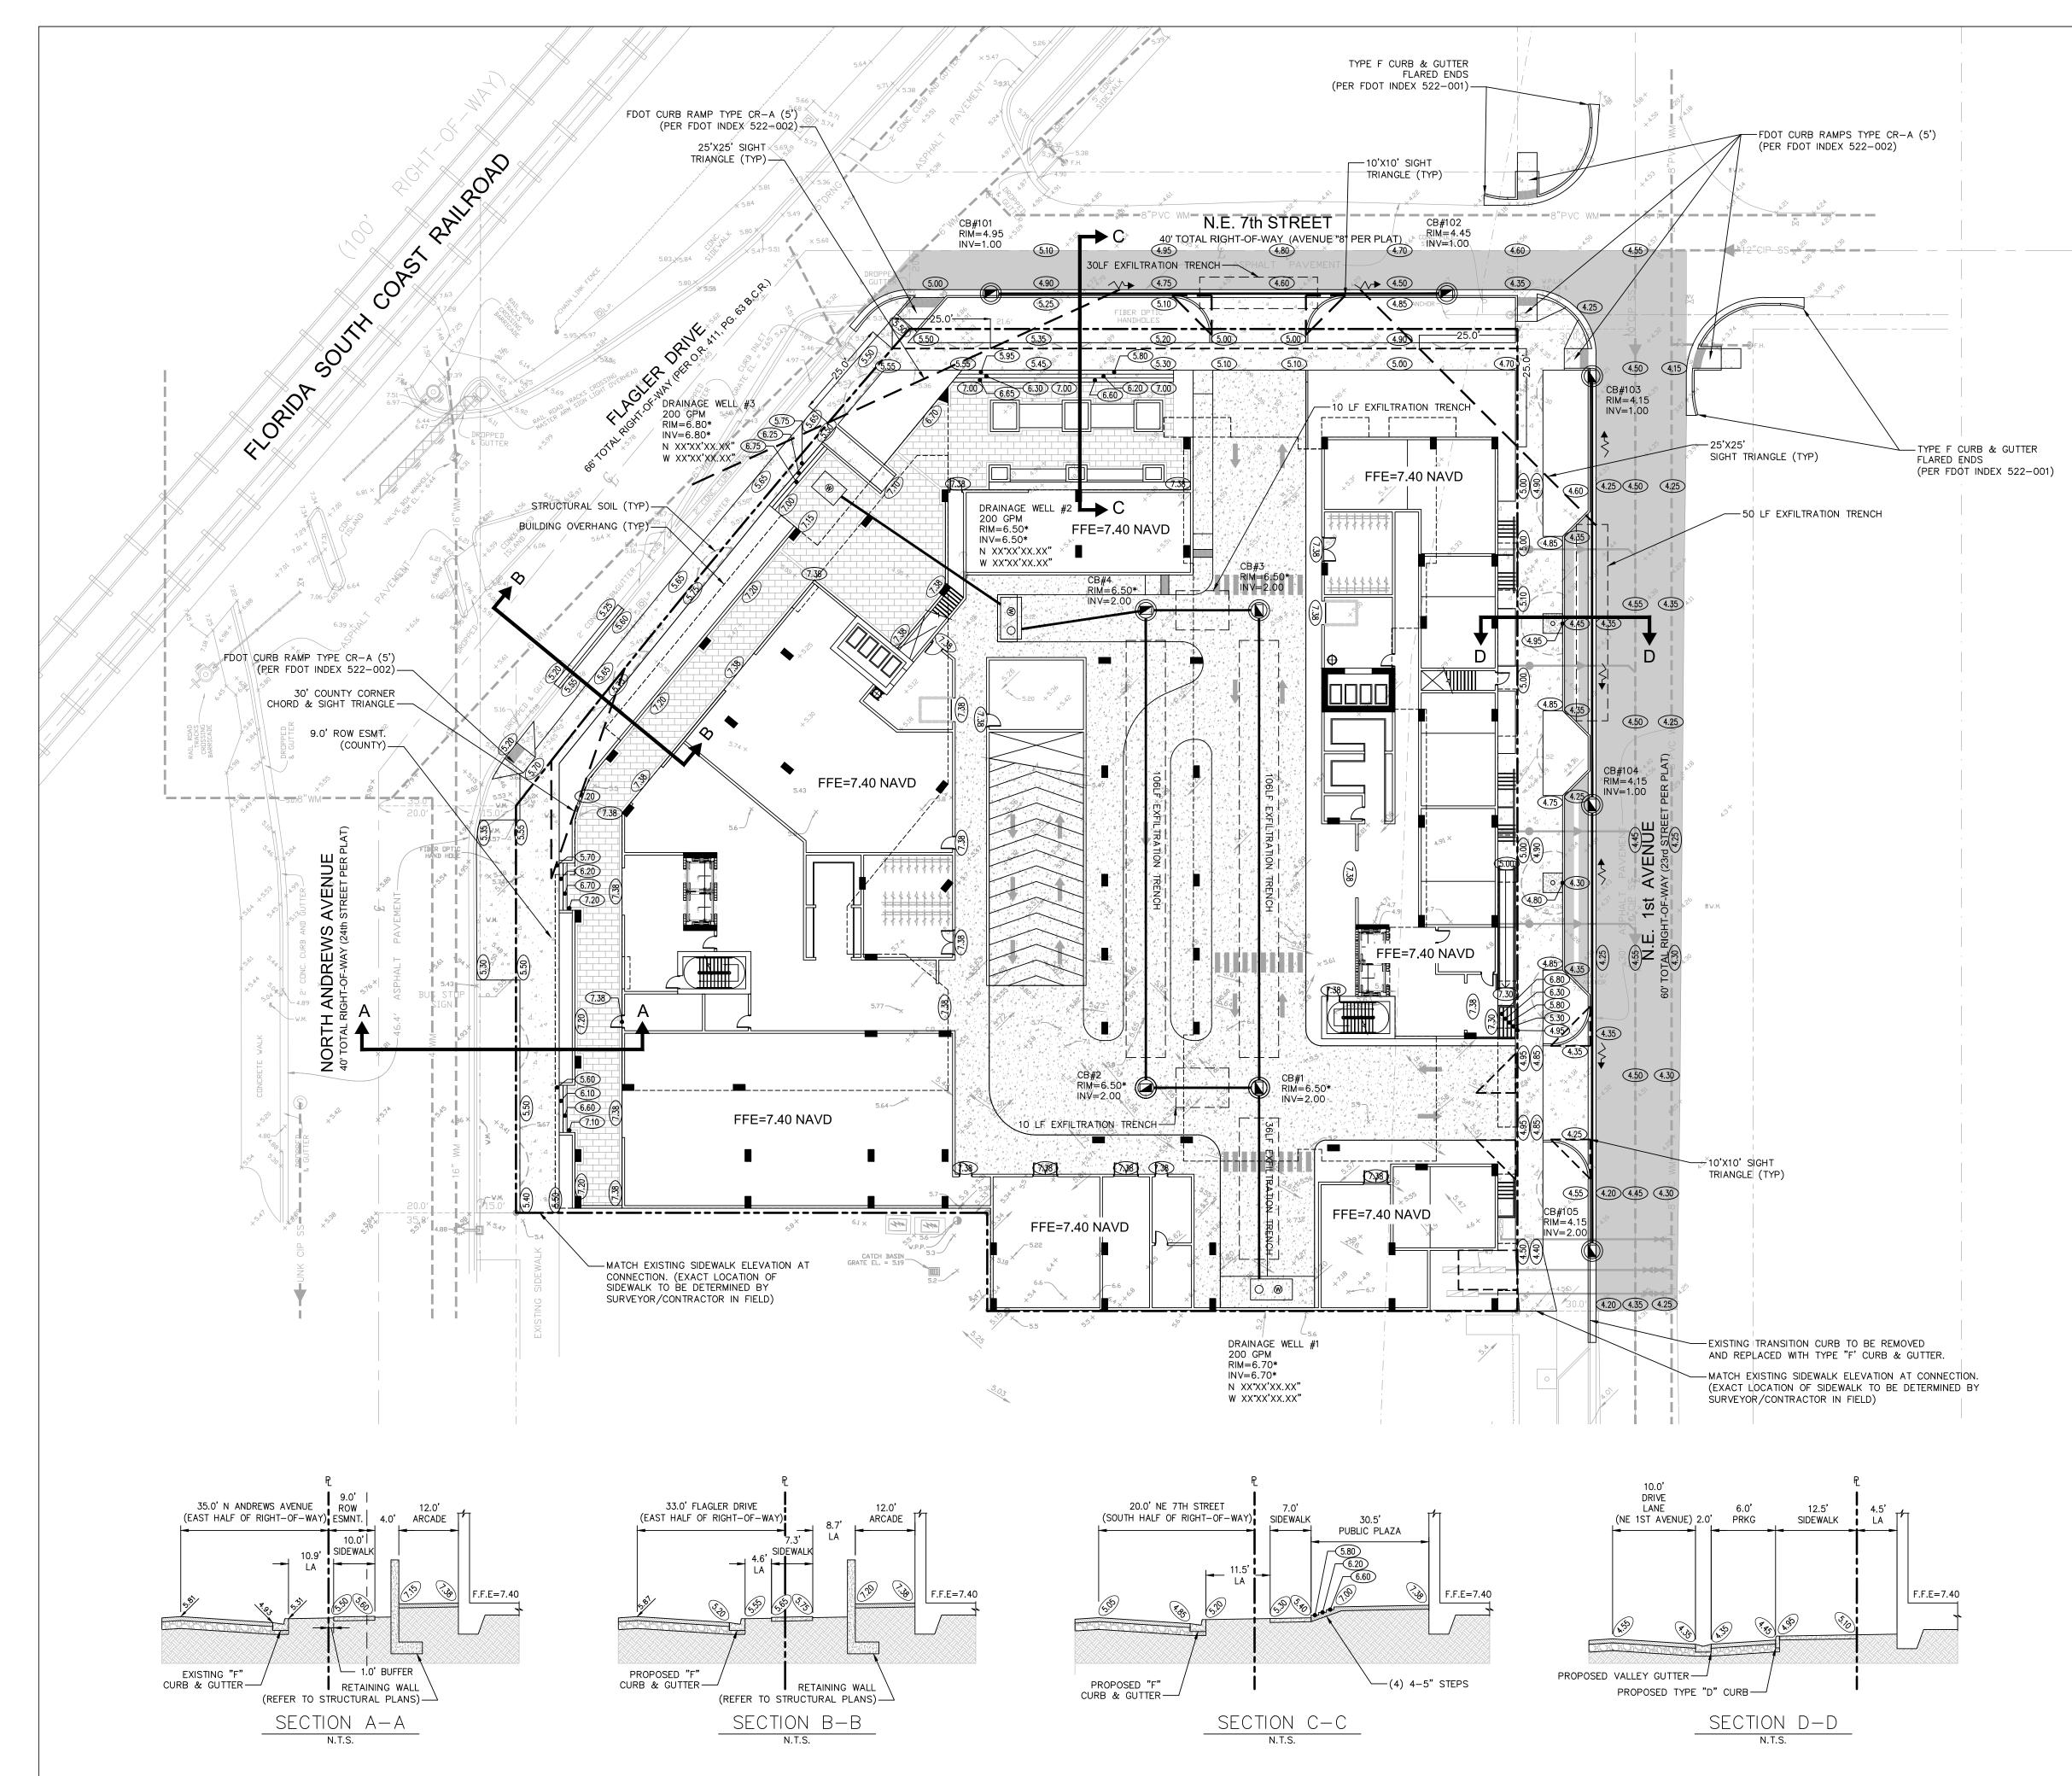M
WATER METER

DOUBLE DETECTOR CHECK W/ WAFER CHECK VALVE ON DOWNSTREAM SIDE NAME REDUCED PRESSURE BACKFLOW PREVENTOR

DIRECTIONAL FLOW ARROW AND GRAVITY SEWER

PROPOSED MANHOLE
- W - WATER MAIN

-FM - SANITARY FORCE MAIN

VALVE

FIRE HYDRANT

SIAMESE CONNECTION

CLEANOUT

EDGE OF PROPOSED PAVEMENT
(ASPHALT)

Ty
DIRECTION OF SURFACE DRAINAGE

SAMPLE POINT

RROW

EXIST. WATER MAIN

EXIST. UTILITY LINE TO BE ABANDONED IN PLACE

CURRENT: FLOOD ZONE "X" ELEV (N/A) NAVD
ON FIRM MAP #12011C0369 H, DATED AUGUST 18, 2014

PRELIM: FLOOD ZONE "AE "ELEV (6.0) NAVD
ON FIRM MAP #12011C0369 J, DATED DECEMBER 31, 2019

BROWARD COUNTY FUTURE 100 YEAR
3 DAY CONTOUR= ELEV. (6.5) NAVD

DESIGN FLOOD ELEVATION 100 YEAR 3 DAY STORM= ELEV. (7.0) NAVD

AVERAGE WET SEASON WATER LEVEL= ELEV. (2.0) NAVD

GRADING AND DRAINAGE NOTES:

ALL CONSTRUCTION SHALL CONFORM TO THE STANDARDS AND SPECIFICATIONS OF THE CITY OF FORT LAUDERDALE.
 PRIOR TO CONSTRUCTION, THE CONTRACTOR SHALL GIVE TIMELY NOTIFICATION TO ALL UTILITY COMPANIES WITH FACILITIES IN THE AREA.

3. THE CONTRACTOR SHALL TAKE ALL NECESSARY PRECAUTIONS TO SAFEGUARD ALL EXISTING STRUCTURES, UTILITIES, AND SURVEY MARKERS.

4. ALL STORM DRAINAGE LINE FROM THE BLDG SHALL BE LAID @ 1.0% MINIMUM SLOPE UNLESS NOTED OTHERWISE ON PLANS.

5. CLEANOUTS ON STORM DRAINAGE LINES ARE TO BE ADJUSTED TO BE FLUSH W/FINISHED

6. CONTRACTOR SHALL PROVIDE FITTINGS (WYES, TEE, REDUCERS, ETC.) AS REQUIRED TO FURNISH A COMPLETE WORKING SYSTEM BASED ON THE LAYOUT SHOWN ON THESE PLANS.

FURNISH A COMPLETE WORKING SYSTEM BASED ON THE LAYOUT SHOWN ON THESE PLANS.

7. LANDSCAPED AREAS SHALL BE GRADED TO DRAIN TO THE CATCH BASIN INLETS. FIELD ADJUST GRADING AS REQUIRED.

8. SITE UTILITY CONTRACTOR SHALL COORDINATE WITH THE BUILDING PLUMBING CONTRACTOR FOR EXACT LOCATION OF CONNECTION POINTS BETWEEN THE BUILDING AND SITE WATER, SEWER AND DRAINAGE LINES (VERTICALLY AND HORIZONTALLY).

9. RECTANGULAR CATCH BASIN AND YARD DRAIN GRATES SHALL BE INSTALLED SUCH THAT THE LONG AXIS OF GRATE PARALLELS THE CLOSEST ADJACENT WALK, BLDG., DRIVE WAY, PROPERTY LINE, OR ROADWAY.

10. COORDINATE LOCATION IN FIELD OF ALL CATCH BASINS & YARD DRAINS WITH LANDSCAPE CONTRACTOR TO AVOID CONFLICTS.

11. CENTERLINE OF YARD DRAINS @ BASE OF DOWN SPOUTS MUST ALIGN WITH CENTERLINE OF DOWN SPOUT PRIOR TO FINAL ACCEPTANCE BY OWNER. REFERENCE ARCH. PLANS FOR EXACT LOCATION OF DOWN SPOUTS.

12. SLOPE ON SIDEWALKS SHALL NOT EXCEED 5% SLOPE IN DIRECTION OF TRAVEL OR 2% CROSS SLOPE. NOTIFY ENGINEER PRIOR TO CONSTRUCTION OF ANY GRADING THAT DOES NOT COMPLY WITH THIS REQUIREMENT.

13. SLOPE IN HANDICAP PARKING AND ACCESS AISLES SHALL NOT EXCEED 2% CROSS SLOPE. NOTIFY ENGINEER PRIOR TO CONSTRUCTION OF ANY GRADING THAT DOES NOT COMPLY WITH

14. SLOPE IN CROSSWALKS SHALL NOT EXCEED 2% CROSS SLOPE. NOTIFY ENGINEER PRIOR TO CONSTRUCTION OF ANY GRADING THAT DOES NOT COMPLY WITH THIS REQUIREMENT.

15. SURVEY INFORMATION BASED ON SURVEY PROVIDED BY MCLAUGHLIN ENGINEERING COMPANY


DATED SEPTEMBER 23, 2022.


16. ELEVATIONS SHOWN ARE NAVD88.


*17. FINAL RIM ELEVATIONS FOR THE DRAINAGE STRUCTURES WITHIN THE GARAGE TO BE BASED ON ARCHITECT'S GRADING PLAN.

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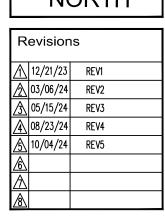


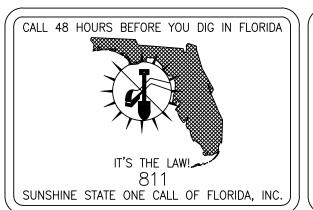


CONCEPTUAL PAVING, GRADING, & DRAINAGE PLAN

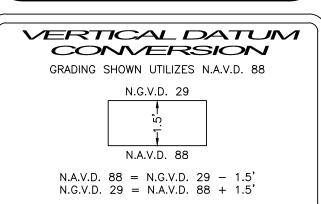N. ANDREWS AVE

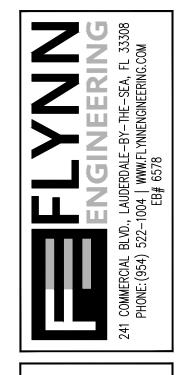
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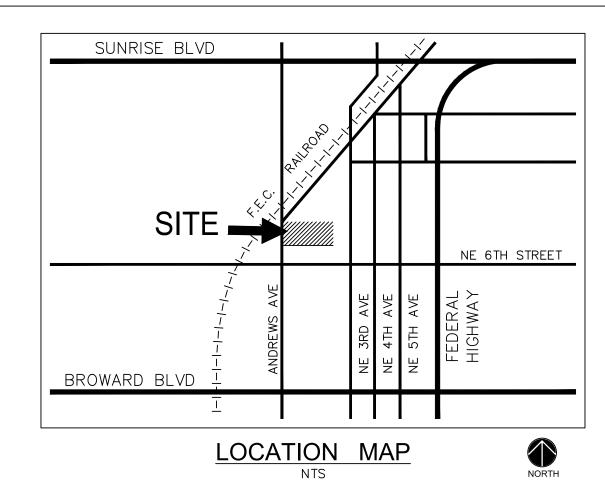


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LEGEND:

0.00 PROPOSED ELEVATION (NAVD)

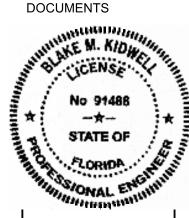\$\phi 5.32 EXISTING ELEVATION (NAVD) PROPOSED CATCH BASIN

PROPOSED PLUG

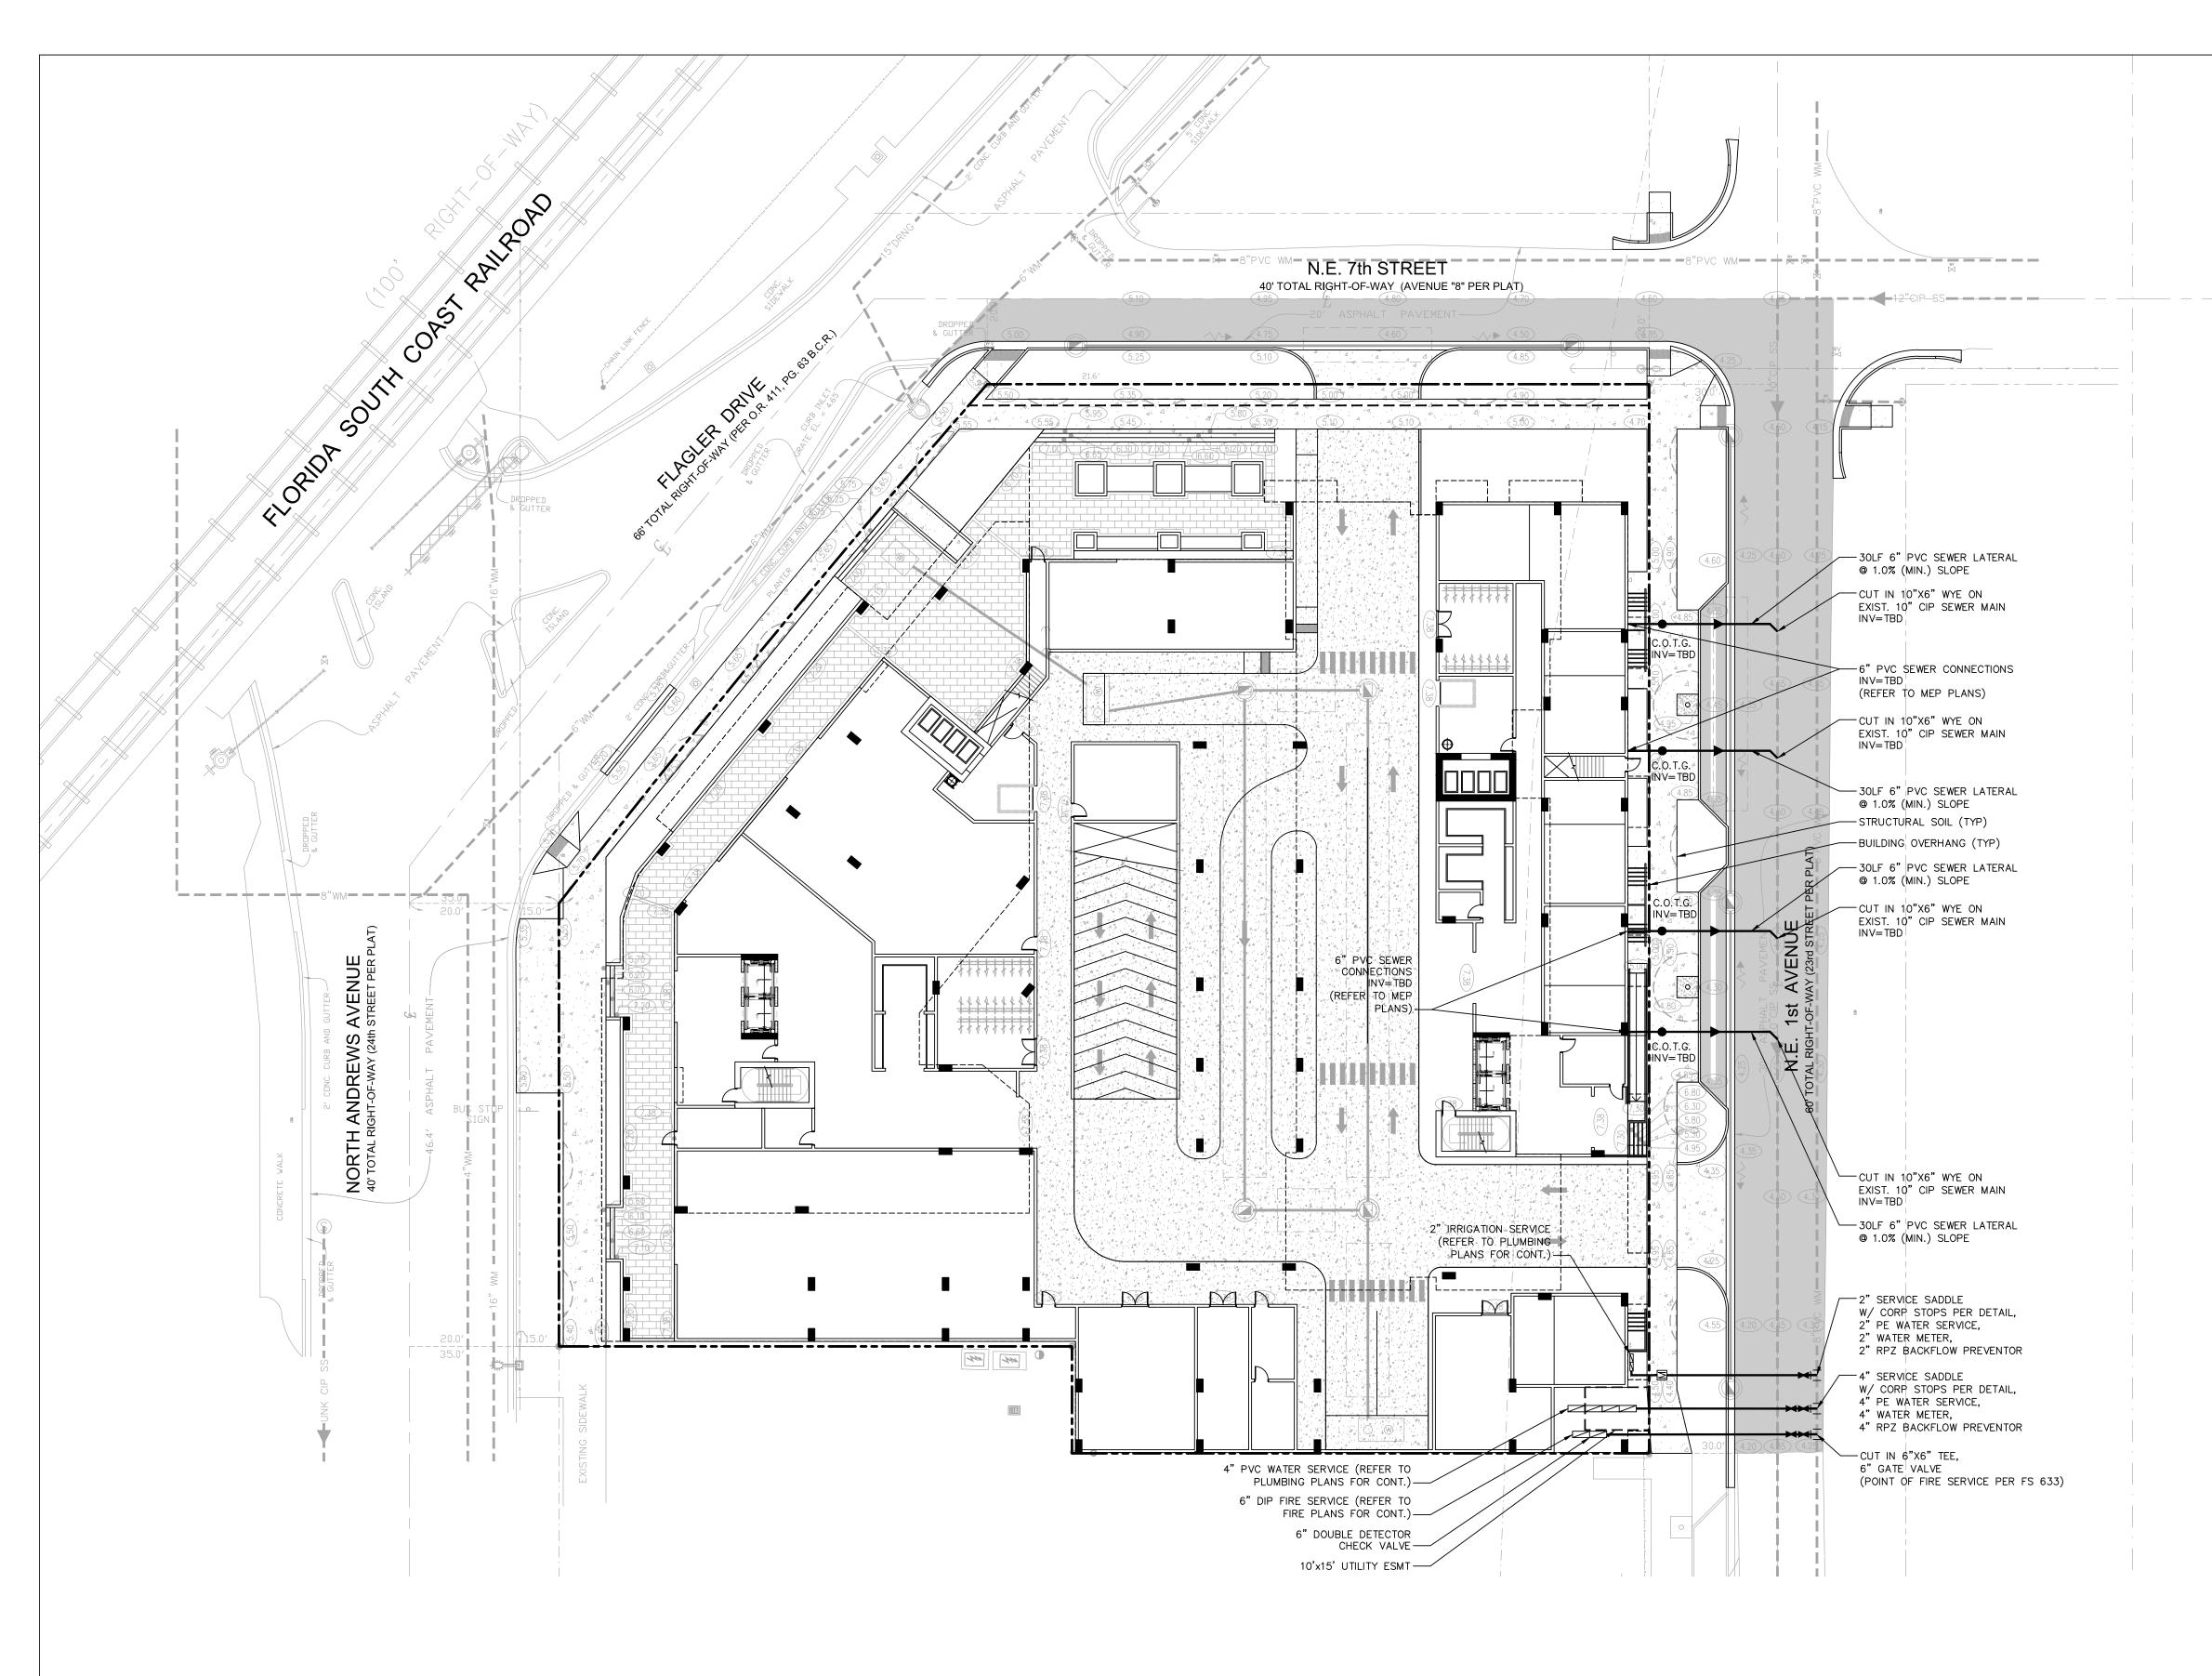WATER METER DOUBLE DETECTOR CHECK W/ WAFER CHECK VALVE ON DOWNSTREAM SIDE REDUCED PRESSURE

DIRECTIONAL FLOW ARROW AND GRAVITY SEWER

PROPOSED MANHOLE

— W — WATER MAIN -FM - SANITARY FORCE MAIN

VALVE FIRE HYDRANT SIAMESE CONNECTION CLEANOUT

EDGE OF PROPOSED PAVEMENT (ASPHALT) DIRECTION OF SURFACE DRAINAGE SAMPLE POINT BACKFLOW PREVENTOR --W-- EXIST. WATER MAIN

> EXIST. UTILITY LINE TO BE ABANDONED IN PLACE

WATER AND SEWER NOTES:

1. CONTRACTOR SHALL PROVIDE FITTINGS (WYES, TEE, REDUCERS, ETC.) AS REQUIRED TO FURNISH A COMPLETE WORKING SYSTEM BASED ON THE LAYOUT SHOWN ON THESE PLANS.

2. CONTRACTOR SHALL PROVIDE ANY EASEMENT DOCUMENTATION AROUND MH'S, BACKFLOW PREVENTORS, MAINLINES, METERS, ETC. AS REQUIRED BY THE CITY SO THAT THE OWNER MAY RECORD ANY EASEMENTS WITH THE CITY. CONTRACTOR'S SURVEYOR MUST COORDINATE WITH THE CITY AND PROVIDE ALL NECESSARY EASEMENT DOCUMENTATION TO THE OWNER. THE OWNER MUST THEN PROVIDE ALL RECORDED UTILITY EASEMENT DOCUMENTS TO THE CITY PRIOR TO FINAL ACCEPTANCE.

3. CONTRACTOR IS RESPONSIBLE TO COORDINATE WITH THE CITY UTILITY DEPT. ANY WATER MAIN CONNECTIONS. UTILITY CONNECTIONS AND SCHEDULE MUST BE APPROVED BY THE CITY PRIOR TO IMPLEMENTATION. THE CONTRACTOR IS REQUIRED TO PAY FOR ALL COSTS ASSOCIATED WITH THIS WORK REGARDLESS OF WHETHER OR NOT THE UTILITY OR THE CONTRACTOR PERFORMS THE WORK.

4. SITE UTILITY CONTRACTOR SHALL COORDINATE WITH THE BUILDING PLUMBING CONTRACTOR FOR EXACT LOCATION OF CONNECTION POINTS BETWEEN THE BUILDING AND SITE WATER, SEWER AND DRAINAGE LINES (VERTICALLY AND HORIZONTALLY). 5. W.M./S.S. MAINS TO BE LOCATED 5' CLEAR OF ALL OBSTRUCTIONS, POLES, BOXES, CULVERTS, ETC.

W.M./S.S. MAINS MUST BE LOCATED 5' FROM TREES. F.H.'S MUST HAVE A 7.5' CLEAR RADIUS FROM ALL OBSTRUCTIONS.

6. PRESSURE TESTING AND CERTIFICATION SHALL FOLLOW THE FDEP, CITY OF FORT LAUDERDALE PUBLIC WORKS DEPARTMENT, AND FLYNN ENGINEERING SERVICES STANDARDS.

7. 18" VERTICAL CLEARANCE PREFERRED FOR ALL UTILITY CROSSINGS. MINIMUM OF 12" REQUIRED FOR WM-WM CROSSING AND WM-FM CROSSING. CONTRACTOR SHALL CALL 811 AND LOCATE UTILITY CROSSINGS PRIOR TO CONSTRUCTION AND NOTIFY ENGINEER OF ANY DISCREPANCIES. ALL SANITARY SEWER LATERALS SHALL CROSS UNDER WATER MAINS WHERE ABLE. IF THE WATER MAIN MUST CROSS BELOW THE SEWER, A MINIMUM OF 12' SEPARATION SHALL BE PROVIDED. A 20 FOOT SECTION OF DUCTILE IRON PIPE WATER MAIN CENTERED CROSSING IS REQUIRED IF LESS THAN 18" VERTICAL SEPARATION OCCURS BETWEEN SEWER AND WATER MAIN.

8. ALL UNDERGROUND UTILITIES TO BE REMOVED SHALL BE CAPPED OFF AT THE POINT NEAREST TO THE UTILITIES OR DRAINAGE LINES THAT WILL REMAIN IN SERVICE. NOTIFY THE ENGINEER OF RECORD BEFORE REMOVING ANY UTILITIES THAT ARE CURRENTLY IN SERVICE. THE CONTRACTOR SHALL NOT REMOVE ANY UTILITY SERVICE TO ANY EXISTING BUILDING THAT WILL REMAIN AND SHALL DIG UP AND COMPLETELY REMOVE AND/OR ABANDON ANY UTILITY SERVICE THAT IS NO LONGER REQUIRED. THE CONTRACTOR SHALL INFORM AND CONSULT THE ENGINEER OF RECORD PRIOR TO REMOVING ANY LINES.

ENGINEER OF ANY DIFFERENCE FROM THE DESIGN PRIOR TO CONSTRUCTION AND/OR EXCAVATION. 10. CLEANOUTS AND MANHOLES ON SANITARY LINES ARE TO BE ADJUSTED TO BE FLUSH WITH FINISHED

9. CONTRACTOR SHALL VERIFY EXISTING WATER MAIN LOCATION AND ELEVATION AND NOTIFY THE

11. PROPOSED FIRE LINES (I.E. MAINS, SERVICES, SIAMESE CONNECTION LINES, ETC.) TO BE INSTALLED BY A STATE LICENSED FIRE LINE CONTRACTOR PER F.S. 633.

13. STATE LICENSED FIRE LINE CONTRACTOR, UPON COMPLETION OF REQUIRED TESTING, SHALL ISSUE A "LICENSED UNDERGROUND TEST CERTIFICATE" PRIOR TO ACCEPTANCE FOR PLACING FIRE LINE INTO

14. CORING INTO EXISTING MANHOLE MAY RESULT IN COMPLETE RECONSTRUCTION OF EXISTING MANHOLE AT CONTRACTOR'S EXPENSE IF MANHOLE IS IN A DETERIORATED CONDITION.

12. FIRE LINES TO BE INSPECTED BY A CERTIFIED FIRE LINE INSPECTOR.

*15. ON-SITE MANHOLES TO HAVE STANDARD SANITARY SEWER USF 420 COVER. 16. THE MINIMUM COVER DEPTHS FOR PVC AND DIP SEWER MAINS AR RESPECTIVELY 36 INCHES AND 30

17. EXFILTRATION TESTING AND LAMPING OF THE GRAVITY SEWER SHALL BE COORDINATED BY THE CONTRACTOR PRIOR TO THE COMPLETION OF THE PROJECT.

PUMP STATION START UP, EXFILTRATION TESTING, LAMPING, AND VIDEO SURVEY OF SANITARY SEWER TO BE PERFORMED AND WITNESSED BY CITY INSPECTOR. PRESSURE TESTING AND CANNON FLUSH OF WATER MAIN TO BE PERFORMED AND WITNESSED BY CITY INSPECTOR.




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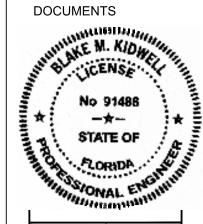
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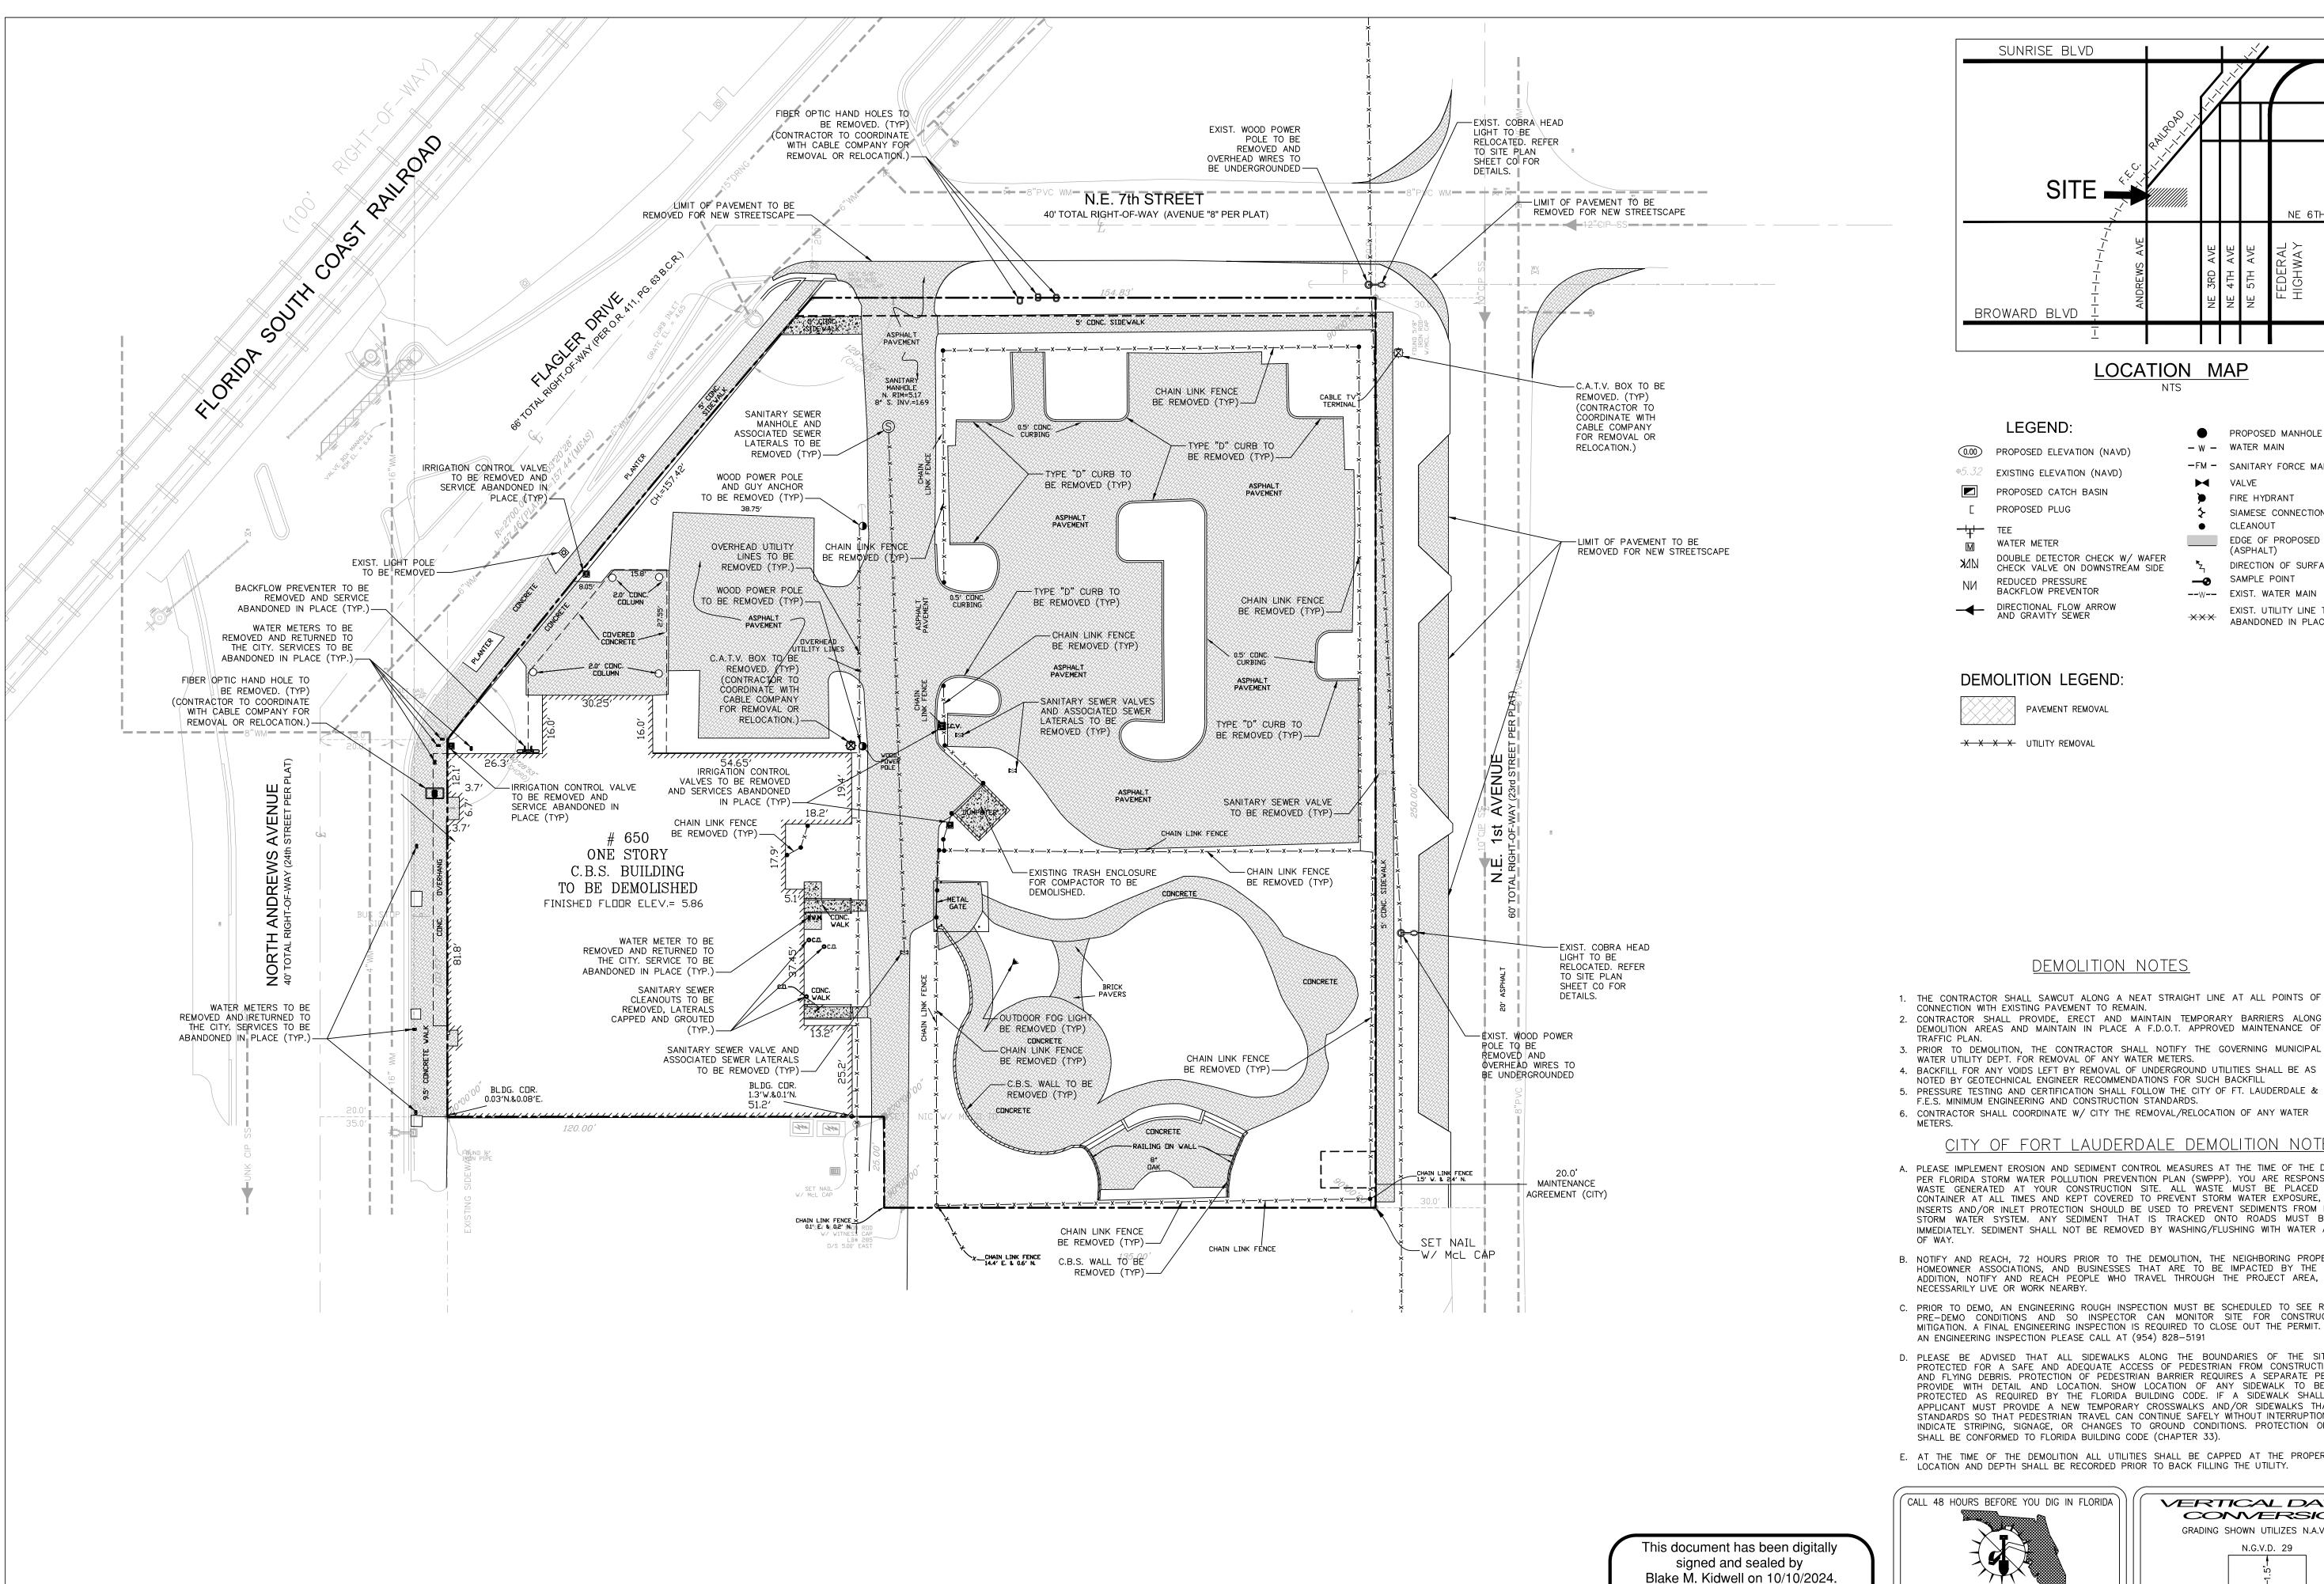



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LOCATION MAP

LEGEND:

0.00 PROPOSED ELEVATION (NAVD)

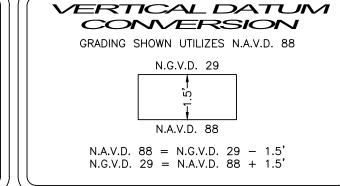\$\phi 5.32 EXISTING ELEVATION (NAVD) PROPOSED CATCH BASIN PROPOSED PLUG

WATER METER

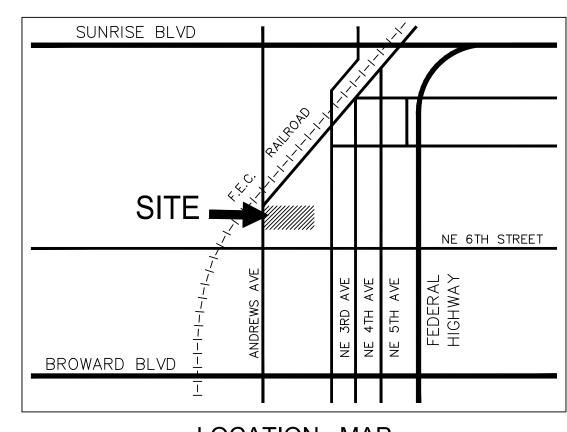DOUBLE DETECTOR CHECK W/ WAFER CHECK VALVE ON DOWNSTREAM SIDE REDUCED PRESSURE BACKFLOW PREVENTOR

DIRECTIONAL FLOW ARROW AND GRAVITY SEWER

PROPOSED MANHOLE

- W - WATER MAIN -FM - SANITARY FORCE MAIN

> **VALVE** FIRE HYDRANT SIAMESE CONNECTION CLEANOUT

EDGE OF PROPOSED PAVEMENT (ASPHALT) DIRECTION OF SURFACE DRAINAGE SAMPLE POINT

--W-- EXIST. WATER MAIN EXIST. UTILITY LINE TO BE ABANDONED IN PLACE

DEMOLITION LEGEND:

X X X UTILITY REMOVAL




DEMOLITION NOTES

- 1. THE CONTRACTOR SHALL SAWCUT ALONG A NEAT STRAIGHT LINE AT ALL POINTS OF
- CONNECTION WITH EXISTING PAVEMENT TO REMAIN. 2. CONTRACTOR SHALL PROVIDE, ERECT AND MAINTAIN TEMPORARY BARRIERS ALONG DEMOLITION AREAS AND MAINTAIN IN PLACE A F.D.O.T. APPROVED MAINTENANCE OF
- 3. PRIOR TO DEMOLITION, THE CONTRACTOR SHALL NOTIFY THE GOVERNING MUNICIPAL WATER UTILITY DEPT. FOR REMOVAL OF ANY WATER METERS.
- 4. BACKFILL FOR ANY VOIDS LEFT BY REMOVAL OF UNDERGROUND UTILITIES SHALL BE AS NOTED BY GEOTECHNICAL ENGINEER RECOMMENDATIONS FOR SUCH BACKFILL
- F.E.S. MINIMUM ENGINEERING AND CONSTRUCTION STANDARDS. 6. CONTRACTOR SHALL COORDINATE W/ CITY THE REMOVAL/RELOCATION OF ANY WATER


CITY OF FORT LAUDERDALE DEMOLITION NOTES


- A. PLEASE IMPLEMENT EROSION AND SEDIMENT CONTROL MEASURES AT THE TIME OF THE DEMOLITION AS PER FLORIDA STORM WATER POLLUTION PREVENTION PLAN (SWPPP). YOU ARE RESPONSIBLE FOR ALL WASTE GENERATED AT YOUR CONSTRUCTION SITE. ALL WASTE MUST BE PLACED IN A TRASH CONTAINER AT ALL TIMES AND KEPT COVERED TO PREVENT STORM WATER EXPOSURE, CATCH BASIN INSERTS AND/OR INLET PROTECTION SHOULD BE USED TO PREVENT SEDIMENTS FROM ENTERING THE STORM WATER SYSTEM. ANY SEDIMENT THAT IS TRACKED ONTO ROADS MUST BE SWEPT UP IMMEDIATELY. SEDIMENT SHALL NOT BE REMOVED BY WASHING/FLUSHING WITH WATER AT THE RIGHT
- B. NOTIFY AND REACH, 72 HOURS PRIOR TO THE DEMOLITION, THE NEIGHBORING PROPERTY OWNERS, HOMEOWNER ASSOCIATIONS, AND BUSINESSES THAT ARE TO BE IMPACTED BY THE ACTIVITIES. IN ADDITION, NOTIFY AND REACH PEOPLE WHO TRAVEL THROUGH THE PROJECT AREA, BUT DO NOT NECESSARILY LIVE OR WORK NEARBY.
- C. PRIOR TO DEMO, AN ENGINEERING ROUGH INSPECTION MUST BE SCHEDULED TO SEE RIGHT-OF-WAY PRE-DEMO CONDITIONS AND SO INSPECTOR CAN MONITOR SITE FOR CONSTRUCTION DEBRIS MITIGATION. A FINAL ENGINEERING INSPECTION IS REQUIRED TO CLOSE OUT THE PERMIT. TO SCHEDULE AN ENGINEERING INSPECTION PLEASE CALL AT (954) 828-5191
- D. PLEASE BE ADVISED THAT ALL SIDEWALKS ALONG THE BOUNDARIES OF THE SITE SHALL BE PROTECTED FOR A SAFE AND ADEQUATE ACCESS OF PEDESTRIAN FROM CONSTRUCTION ACTIVITIES AND FLYING DEBRIS. PROTECTION OF PEDESTRIAN BARRIER REQUIRES A SEPARATE PERMIT. PLEASE PROVIDE WITH DETAIL AND LOCATION. SHOW LOCATION OF ANY SIDEWALK TO BE CLOSED OR PROTECTED AS REQUIRED BY THE FLORIDA BUILDING CODE. IF A SIDEWALK SHALL BE CLOSED. APPLICANT MUST PROVIDE A NEW TEMPORARY CROSSWALKS AND/OR SIDEWALKS THAT MEET ADA STANDARDS SO THAT PEDESTRIAN TRAVEL CAN CONTINUE SAFELY WITHOUT INTERRUPTION. THIS SHALL INDICATE STRIPING, SIGNAGE, OR CHANGES TO GROUND CONDITIONS. PROTECTION OF PEDESTRIAN SHALL BE CONFORMED TO FLORIDA BUILDING CODE (CHAPTER 33).
- E. AT THE TIME OF THE DEMOLITION ALL UTILITIES SHALL BE CAPPED AT THE PROPERTY LINE, THE LOCATION AND DEPTH SHALL BE RECORDED PRIOR TO BACK FILLING THE UTILITY.

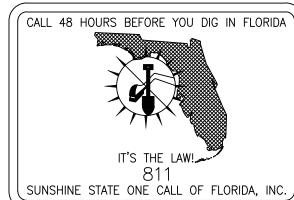

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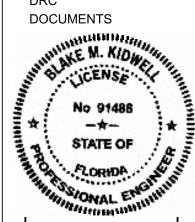
UTILITY DEMOLITION I AREA 1

EWS

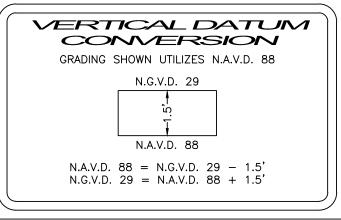
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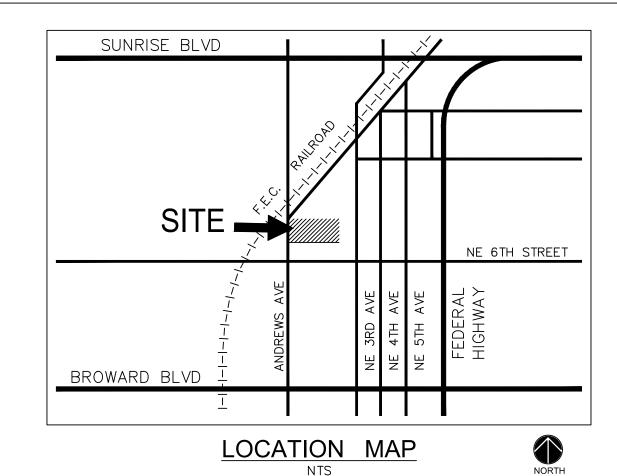


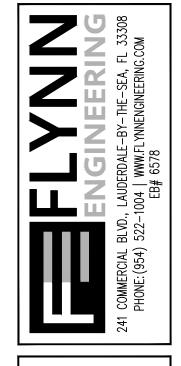ESC NOTES:

- CLOSED CIRCUIT TV INSPECTION (CCTV) NOTES: 1. CONTRACTOR SHALL PROVIDE CCTV VIDEOTAPES TO CITY STW OPS OF THE EXISTING STORMWATER SYSTEM TO THE LIMITS SHOWN WITH GREEN LINE WORK IN THE STORM MAP PROVIDED AT THE END OF THIS REPORT IN ORDER TO DOCUMENT THE PRE AND POST CONSTRUCTION CONDITIONS OF THE CITY'S STORM SYSTEM.
- 2. CONTRACTOR SHALL PROVIDE THE PRE CONSTRUCTION CCTV TO CITY STW OPS WHEN APPLYING FOR A DEMOLITION PERMIT AT THE CITY'S BUILDING DEPARTMENT. I. IF DEBRIS IS FOUND IN THE CITY'S STORMWATER SYSTEM PRIOR TO DEMOLITION OR CONSTRUCTION, THE APPLICANT, CONTRACTOR, DEVELOPER OR DESIGNER (AS APPLICABLE) SHALL INFORM THE CITY'S STORMWATER OPERATIONS DEPARTMENT FOR PROPER REMOVAL.
- 3. CONTRACTOR SHALL PROVIDE THE POST CONSTRUCTION VIDEOTAPE TO CITY STW OPS WHEN REQUESTING THE CERTIFICATE OF OCCUPANCY (CO) TO VERIFY THAT THE CITY'S STORMWATER SYSTEMS HAVE NOT BEEN NEGATIVELY IMPACTED BY THE DEMOLITION AND CONSTRUCTION ACTIVITIES. I. IF DEBRIS IS FOUND IN THE CITY'S STORM SYSTEMS AS A RESULT OF DEMOLITION
- OR CONSTRUCTION ACTIVITIES, IT WILL BE THE RESPONSIBILITY OF THE CONTRACTOR TO VACUUM CLEAN THE CITY'S STORMWATER SYSTEM (OR MAKE REPAIRS AS REQUESTED BY CITY'S STORMWATER OPERATIONS GROUP) PRIOR TO ISSUANCE OF FINAL CO. II. IF SURFACE WATER RUNOFF OR DEBRIS FROM DEMOLITION OR CONSTRUCTION ACTIVITIES IS FOUND TO HAVE NEGATIVELY IMPACTED THE CONDITION OF THE CITY'S STORMWATER ASSETS, IT WILL BE THE RESPONSIBILITY OF THE APPLICANT (CONTRACTOR, DEVELOPER, AND OWNER) TO RECTIFY THE INFRACTION(S) AS REQUESTED BY CITY.

1. THIS PLAN REFLECTS THE ENGINEER'S SUGGESTION FOR EROSION AND SEDIMENT CONTROL. SITE OPERATOR TO MODIFY PLAN AS NEEDED TO MAINTAIN "BEST MANAGEMENT PRACTICES" DURING CONSTRUCTION.

- 2. AT ALL TIMES DURING CONSTRUCTION, ALL STORMWATER MUST REMAIN ONSITE. NO DISCHARGE INTO THE PUBLIC RIGHT OF WAY OR ADJOINING PROPERTIES IS ALLOWED.
- 3. DRAINAGE STRUCTURES INSTALLED TO BE PROTECTED WITH FILTER FABRIC AND/OR PERIMETER SILT FENCE.
- 4. PROVIDE FILTER FABRIC OR OTHER METHOD OF SEDIMENT PROTECTION FOR ANY EXISTING CATCH BASIN/INLET WITHIN 100 FEET OF THE PROJECT AREA.
- 5. ANY SEDIMENT THAT IS TRACKED ONTO ROADS MUST BE SWEPT UP IMMEDIATELY.
- 6. SEDIMENT SHALL NOT BE REMOVED BY WASHING/FLUSHING WITH WATER AT THE RIGHT OF WAY.
- 7. PRIOR TO START OF CONSTRUCTION, AN ENGINEERING ROUGH INSPECTION MUST BE SCHEDULED TO VERIFY EROSION AND SEDIMENTATION CONTROL IS SETUP PROPERLY AND SO INSPECTOR CAN MONITOR SITE FOR CONSTRUCTION MITIGATION. TO REQUEST AN INSPECTION, PLEASE CALL (954) 828-5191.

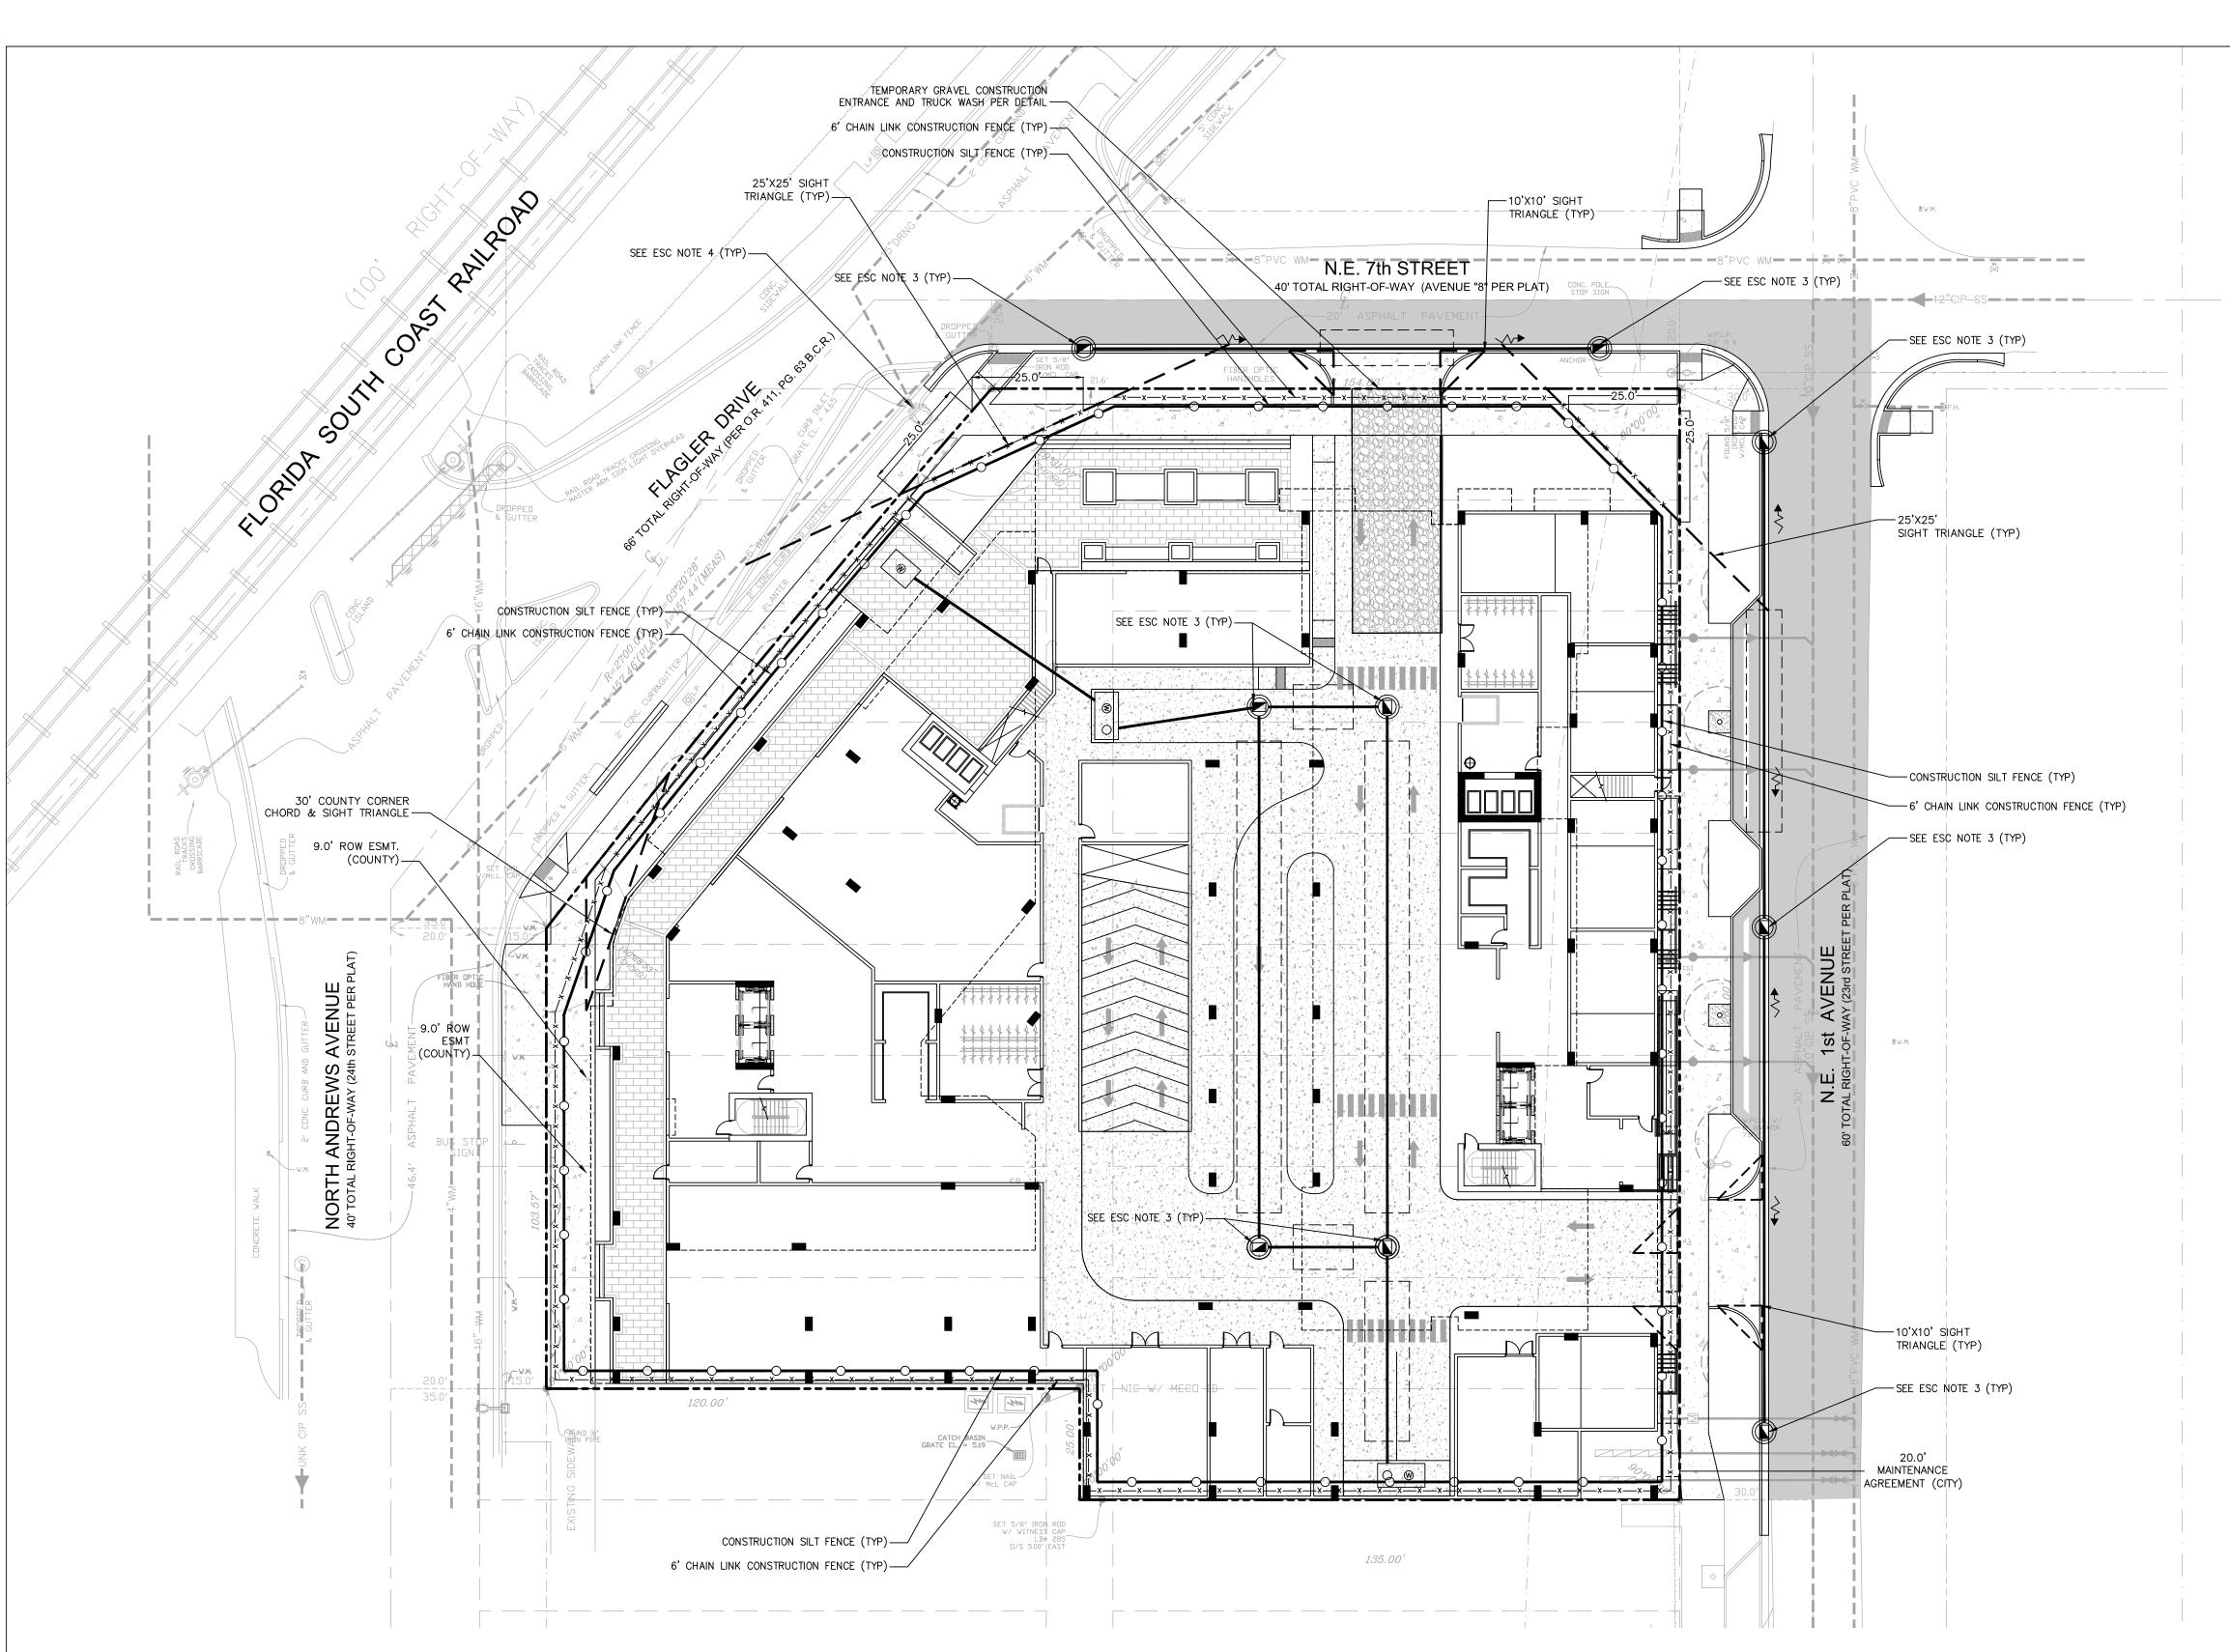

LEGEND:

0.00 PROPOSED ELEVATION (NAVD)

\$\phi 5.32 EXISTING ELEVATION (NAVD) PROPOSED CATCH BASIN

PROPOSED PLUG WATER METER

DOUBLE DETECTOR CHECK W/ WAFER CHECK VALVE ON DOWNSTREAM SIDE REDUCED PRESSURE BACKFLOW PREVENTOR

PROPOSED MANHOLE - W - WATER MAIN

VALVE FIRE HYDRANT SIAMESE CONNECTION CLEANOUT

-FM - SANITARY FORCE MAIN

EDGE OF PROPOSED PAVEMENT (ASPHALT) DIRECTION OF SURFACE DRAINAGE SAMPLE POINT

--W-- EXIST. WATER MAIN DIRECTIONAL FLOW ARROW AND GRAVITY SEWER EXIST. UTILITY LINE TO BE ABANDONED IN PLACE

POLLUTION PREVENTION NOTES:

- 1. CONTRACTOR SHALL ADHERE TO OF THE NATIONAL POLLUTION DISCHARGE ELIMINATION SYSTEM (NPDES) REQUIREMENTS. THE CONTRACTOR SHALL INSTITUTE BEST MANAGEMENT PRACTICES (BMPS) TO ENSURE COMPLIANCE WITH THE NPDES PROGRAM AND TO MINIMIZE THE IMPACT TO PUBLIC STORMWATER FACILITIES. A NOTICE OF INTENT (NOI) SHALL BE FILED PRIOR TO START CONSTRUCTION
- 2. PRIOR TO DEMOLITION ACTIVITIES, CONTRACTOR SHALL INSTALL POLLUTION PREVENTION CONTROL DEVICES (I.E., SILT BARRIERS, SEDIMENT BASINS, TURBIDITY BARRIERS AROUND STORMWATER OUTFALLS ON THE WATERSIDE OF LAKES, PONDS, CANALS, OR WATERWAYS, SILT SCREENS, ETC ACCORDING TO THE APPROVED SWPPP AND AS RECOMMENDED BY THE FLORIDA DEPARTMENT OF ENVIRONMENTAL PROTECTION (DEP) LATEST GUIDELINES AND PERMITTING REQUIREMENTS. PRIOR TO DEMOLITION ACTIVITIES, A SILT FENCE IN ACCORDANCE WITH THE APPROVED SWPPF
- DETAILS AND LATEST DEP STANDARDS SHALL BE ERECTED AROUND THE SITE PROPERTY LINES.
 ALL PUBLIC INLETS SURROUNDING THE SITE SHALL BE PROTECTED BY THE INSTALLATION OF FILTER
 FABRIC INTO THE FRAME AND GRATE OR OTHER APPROVED BMPS TO PROTECT AGAINST STORM
- 4. POLLUTION CONTROL INSTALLATIONS, AS APPROVED AND SHOWN IN THE SWPPP, SHALL BE MAINTAINED THROUGHOUT DEMOLITION AND CONSTRUCTION PERIODS UNTIL THE PROJECT HAS BEEN COMPLETED AND APPROVED BY CITY ENGINEERING INSPECTOR OR PROJECT ENGINEER.
- CONTRACTOR SHALL INSPECT THE POLLUTION CONTROL DEVICES DAILY FOR SIGNS OF MALFUNCTION, FAILURE, OR NEEDED REPAIRS, AND SHALL MAKE REMEDIAL ACTIONS IMMEDIATELY UPON DISCOVERY. 6. EXISTING STORMWATER INLETS, CATCH BASINS, OR MANHOLES, ONSITE AND OFFSITE, SHALL BE PROTECTED FROM SEDIMENT STORM RUNOFF FROM THE PROPOSED DEMOLITIONS AND CONSTRUCTION
- 7. CONTRACTOR SHALL IMMEDIATELY REMOVE ALL MUD, DIRT, OR OTHER MATERIALS TRACKED OR SPILLED ONTO EXISTING ROADS AND FACILITIES DUE TO DEMOLITION OR CONSTRUCTION ACTIVITIES FROM THE PROPOSED DEVELOPMENT.
- 8. IN ORDER TO MINIMIZE THE AMOUNT OF SEDIMENTS, MUD, AND DUST TRANSPORTED ONTO PUBLIC ROADWAYS BY THE CONSTRUCTION VEHICLES OR RUNOFF, THE CONTRACTOR SHALL INSTALL STABILIZED TEMPORARY CONSTRUCTION ENTRANCE(S) FROM THE CONSTRUCTION SITE AS RECOMMENDED BY FDEP. EACH TEMPORAL CONSTRUCTION ENTRANCE IS A STABILIZED 6 INCH THICK LAYER OF 2 TO 3 INCH COURSE AGGREGATE STONE, 12" MINIMUM WIDTH, AND LENGTH TO ACCOMMODATE A MINIMUM OF ONE TRUCKING VEHICLE.
- A. THE ENTRANCE SHALL BE MAINTAINED PERIODICALLY AS CONDITIONS DEMAND IN A CONDITION THAT WILL PREVENT TRACKING OR FLOWING OF SEDIMENTS ONTO PUBLIC RIGHTS-OF-WAY. SEDIMENT SHALL BE TRAPPED IN CLEANOUT AREAS AND PROPERLY HANDLED AS ONSITE DEBRIS PER APPLICABLE STATE REGULATIONS. II. WHEN NECESSARY, VEHICLE WHEELS SHALL BE CLEANED PRIOR TO ENTRANCE ONTO PUBLIC
- RIGHT-OF-WAY. III. ALL MATERIALS SPILLED, DROPPED, WASHED OR TRACKED FROM VEHICLES ONTO ROADWAYS OR INTO PUBLIC STORM DRAINS MUST BE REMOVED BY THE CONTRACTOR IMMEDIATELY. IV. TRUCKS SHALL NOT 'CUT CORNERS' WHERE THE CONSTRUCTION EXIT MEETS THE ROADWAYS.
- V. SWEEPING OF PUBLIC ROADWAYS SHALL BE DONE PERIODICALLY AS CONDITION DEMAND. 9. DUST GENERATED FROM CONSTRUCTION SHALL BE MINIMIZED BY DAILY WATERING OF THE SITE. 10. CONTRACTOR SHALL PROVIDE AN EROSION AND SEDIMENTATION CONTROL INSPECTOR TO INSPECT ALL POINTS OF DISCHARGE INTO NEARBY WATER BODIES TO RECORD THE CONDITION OF DISCHARGE POINTS, INTEGRITY OF SILT FENCE AND POLLUTION CONTROL DEVICES, DUST CONTROL MEASURES, VEHICULAR TRAFFIC AND CONSTRUCTION MATERIAL STORAGE AND DISPOSAL WRITTEN RECORD OF ALL INSPECTIONS SHALL BE STORED BY THE CONTRACTOR DURING DEMOLITION AND CONSTRUCTION PERIODS AND SHALL BE SUBMITTED TO CITY INSPECTORS UPON REQUEST.
- THE INSPECTION REPORT SHALL INCLUDE AT A MINIMUM THE FOLLOWING INFORMATION: NAME OF INSPECTOR AND HIS/HER QUALIFICATIONS IN EROSION AND SEDIMENTATION CONTROL DATE OF THE INSPECTION

NPDES

ALL PROJECTS THAT WILL RESULT IN THE

DISTURBANCE OF 1 OR MORE ACRES OF LAND

CONTRACTORS ARE REQUIRED TO SUBMIT A STORM

WATER NOTICE OF INTENT (DEP FORM

62-621.300(4)(b)) 48 HOURS PRIOR TO THE

COMMENCEMENT OF CONSTRUCTION TO THE FLORIDA

DEPARTMENT OF ENVIRONMENTAL PROTECTION, NPDES

STORMWATER PROGRAM, 2600 BLAIR STONE ROAD

MAIL STATION 2510, TALLAHASSEE, FL 32399-2400.

WWW.DEP.STATE.FL.US/WATER/STORMWATER/NPDES

ADDITIONAL DETAILS ARE AVAILABLE AT


- III. RAINFALL RATE IV. OBSERVATIONS ABOUT THE SWPP
- V. ACTIONS TAKEN BY CONTRACTOR FOR ALL INCIDENTS OF NONCOMPLIANCE WITH PERMIT(S) VI. CERTIFICATION THAT THE FACILITY IS IN COMPLIANCE WITH THE SWPP AND PERMIT(S)


This document has been digitally signed and sealed by

Blake M. Kidwell on 10/10/2024.

Printed copies of this document are not considered signed and sealed.

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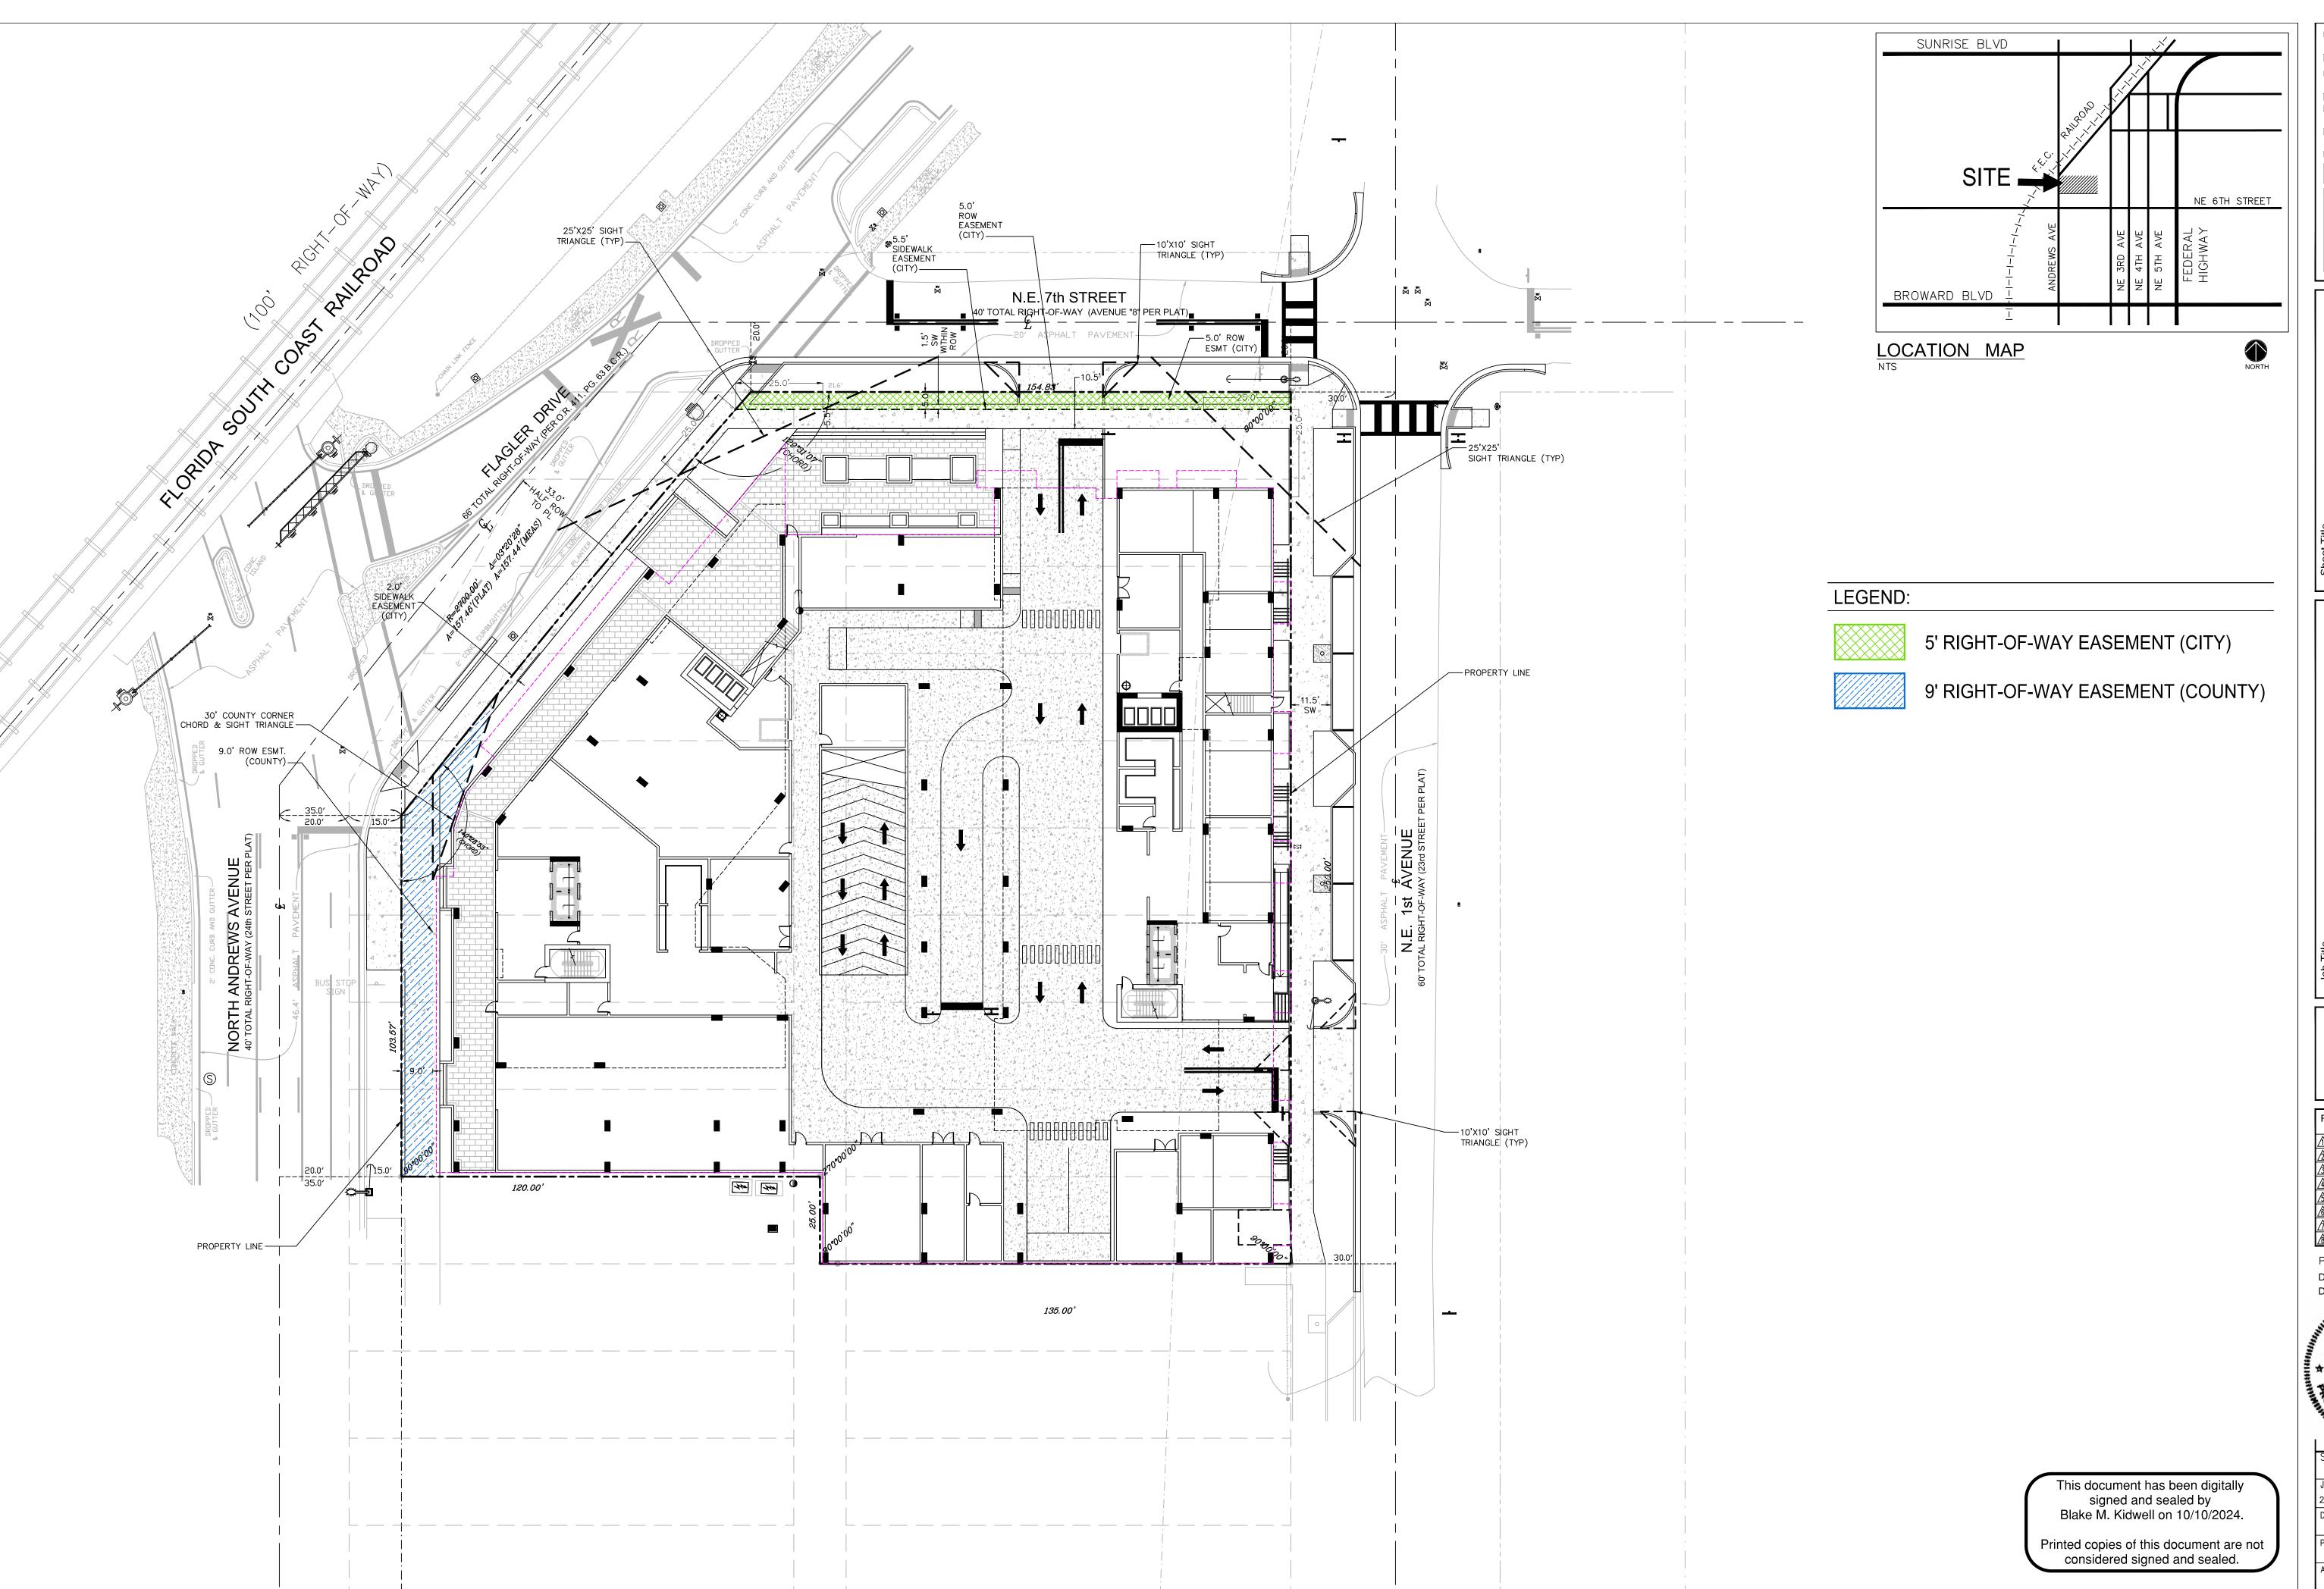

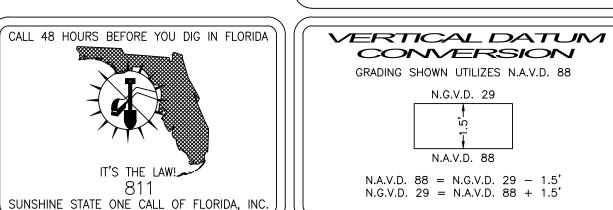
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NORTH Revisions 12/21/23 REV1 ∕<u>∱</u> 03/06/24 REV2 /3\ 05/15/24 REV3 ∕**4** 08/23/24 REV4 ∱\|10/04/24| REV5

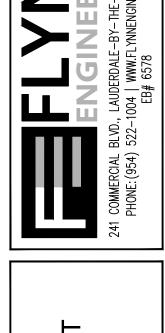

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RIGHT-OF-WAY EASEMENT EXHIBIT

650 N ANDREWS AVE

NORTH


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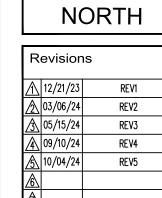
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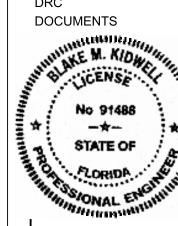


SIDEWALK EASEMENT EXHIBIT


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COMMERCIAL BLVD., LAUDERDALE—BY—THE—SEA, FL 33308
PHONE: (954) 522—1004 | WWW.FLYNNENGINEERING.COM
EB# 6578

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EXHIBIT

650 N ANDREWS AVE

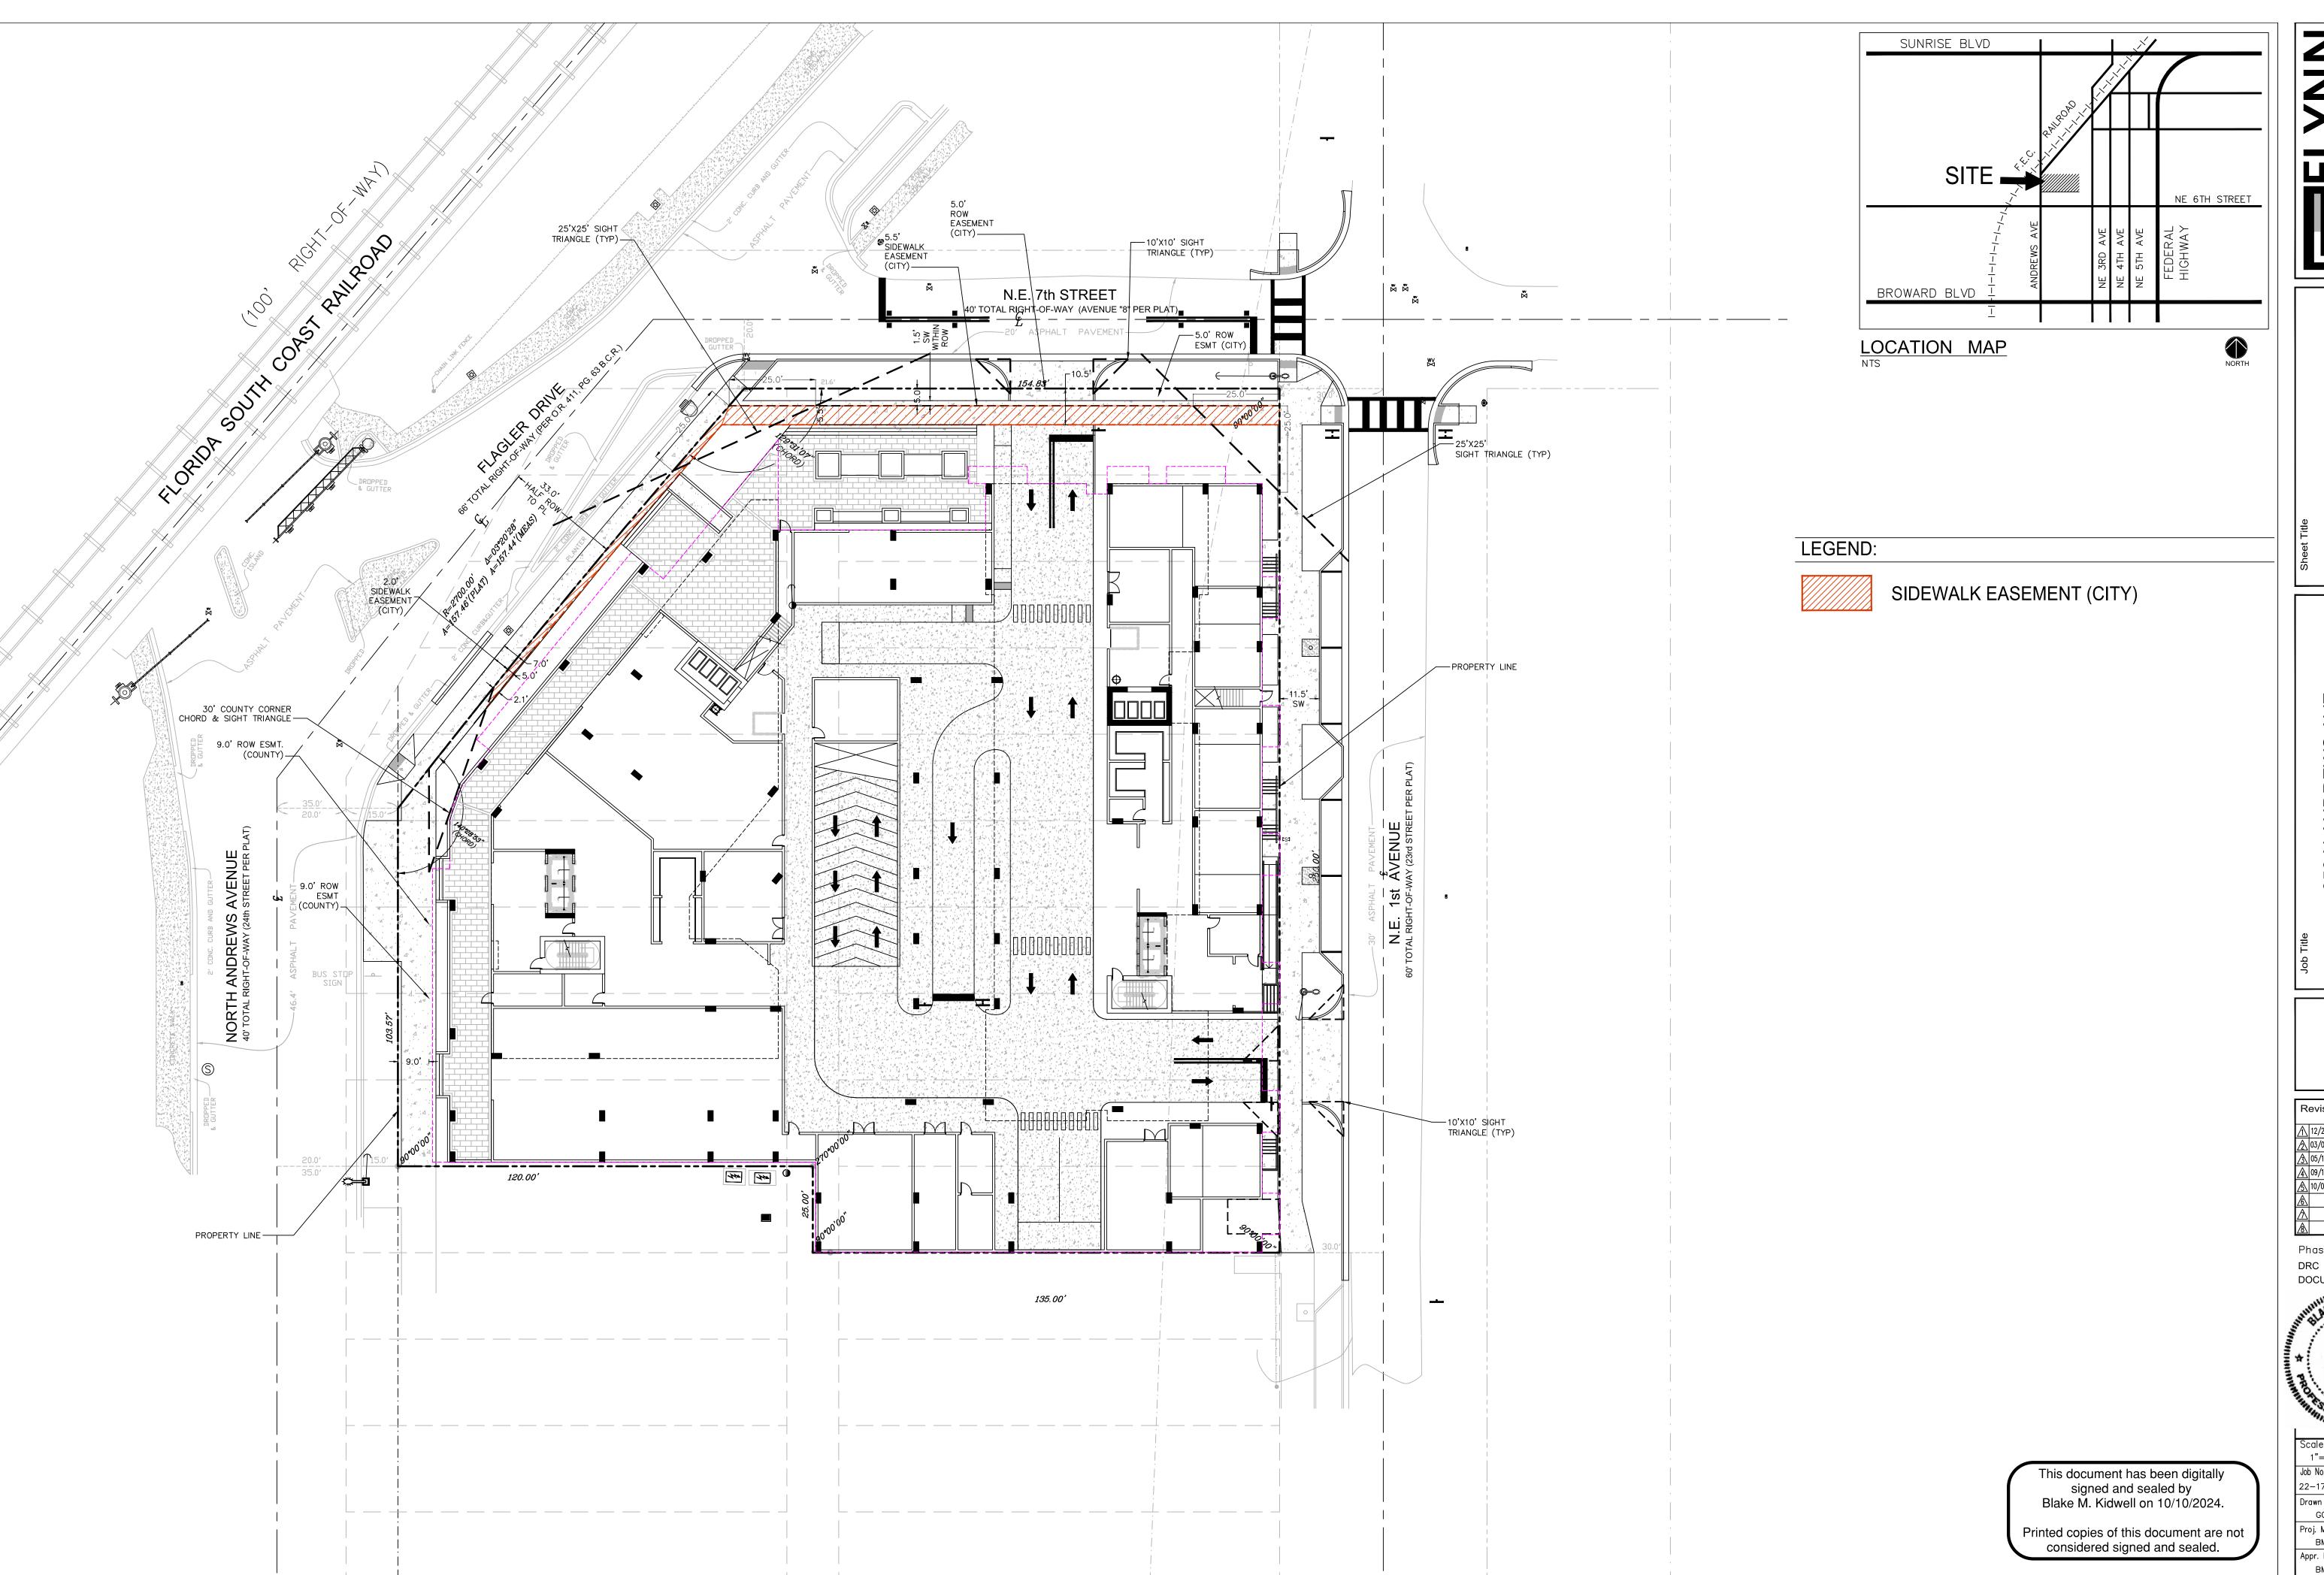NORTH

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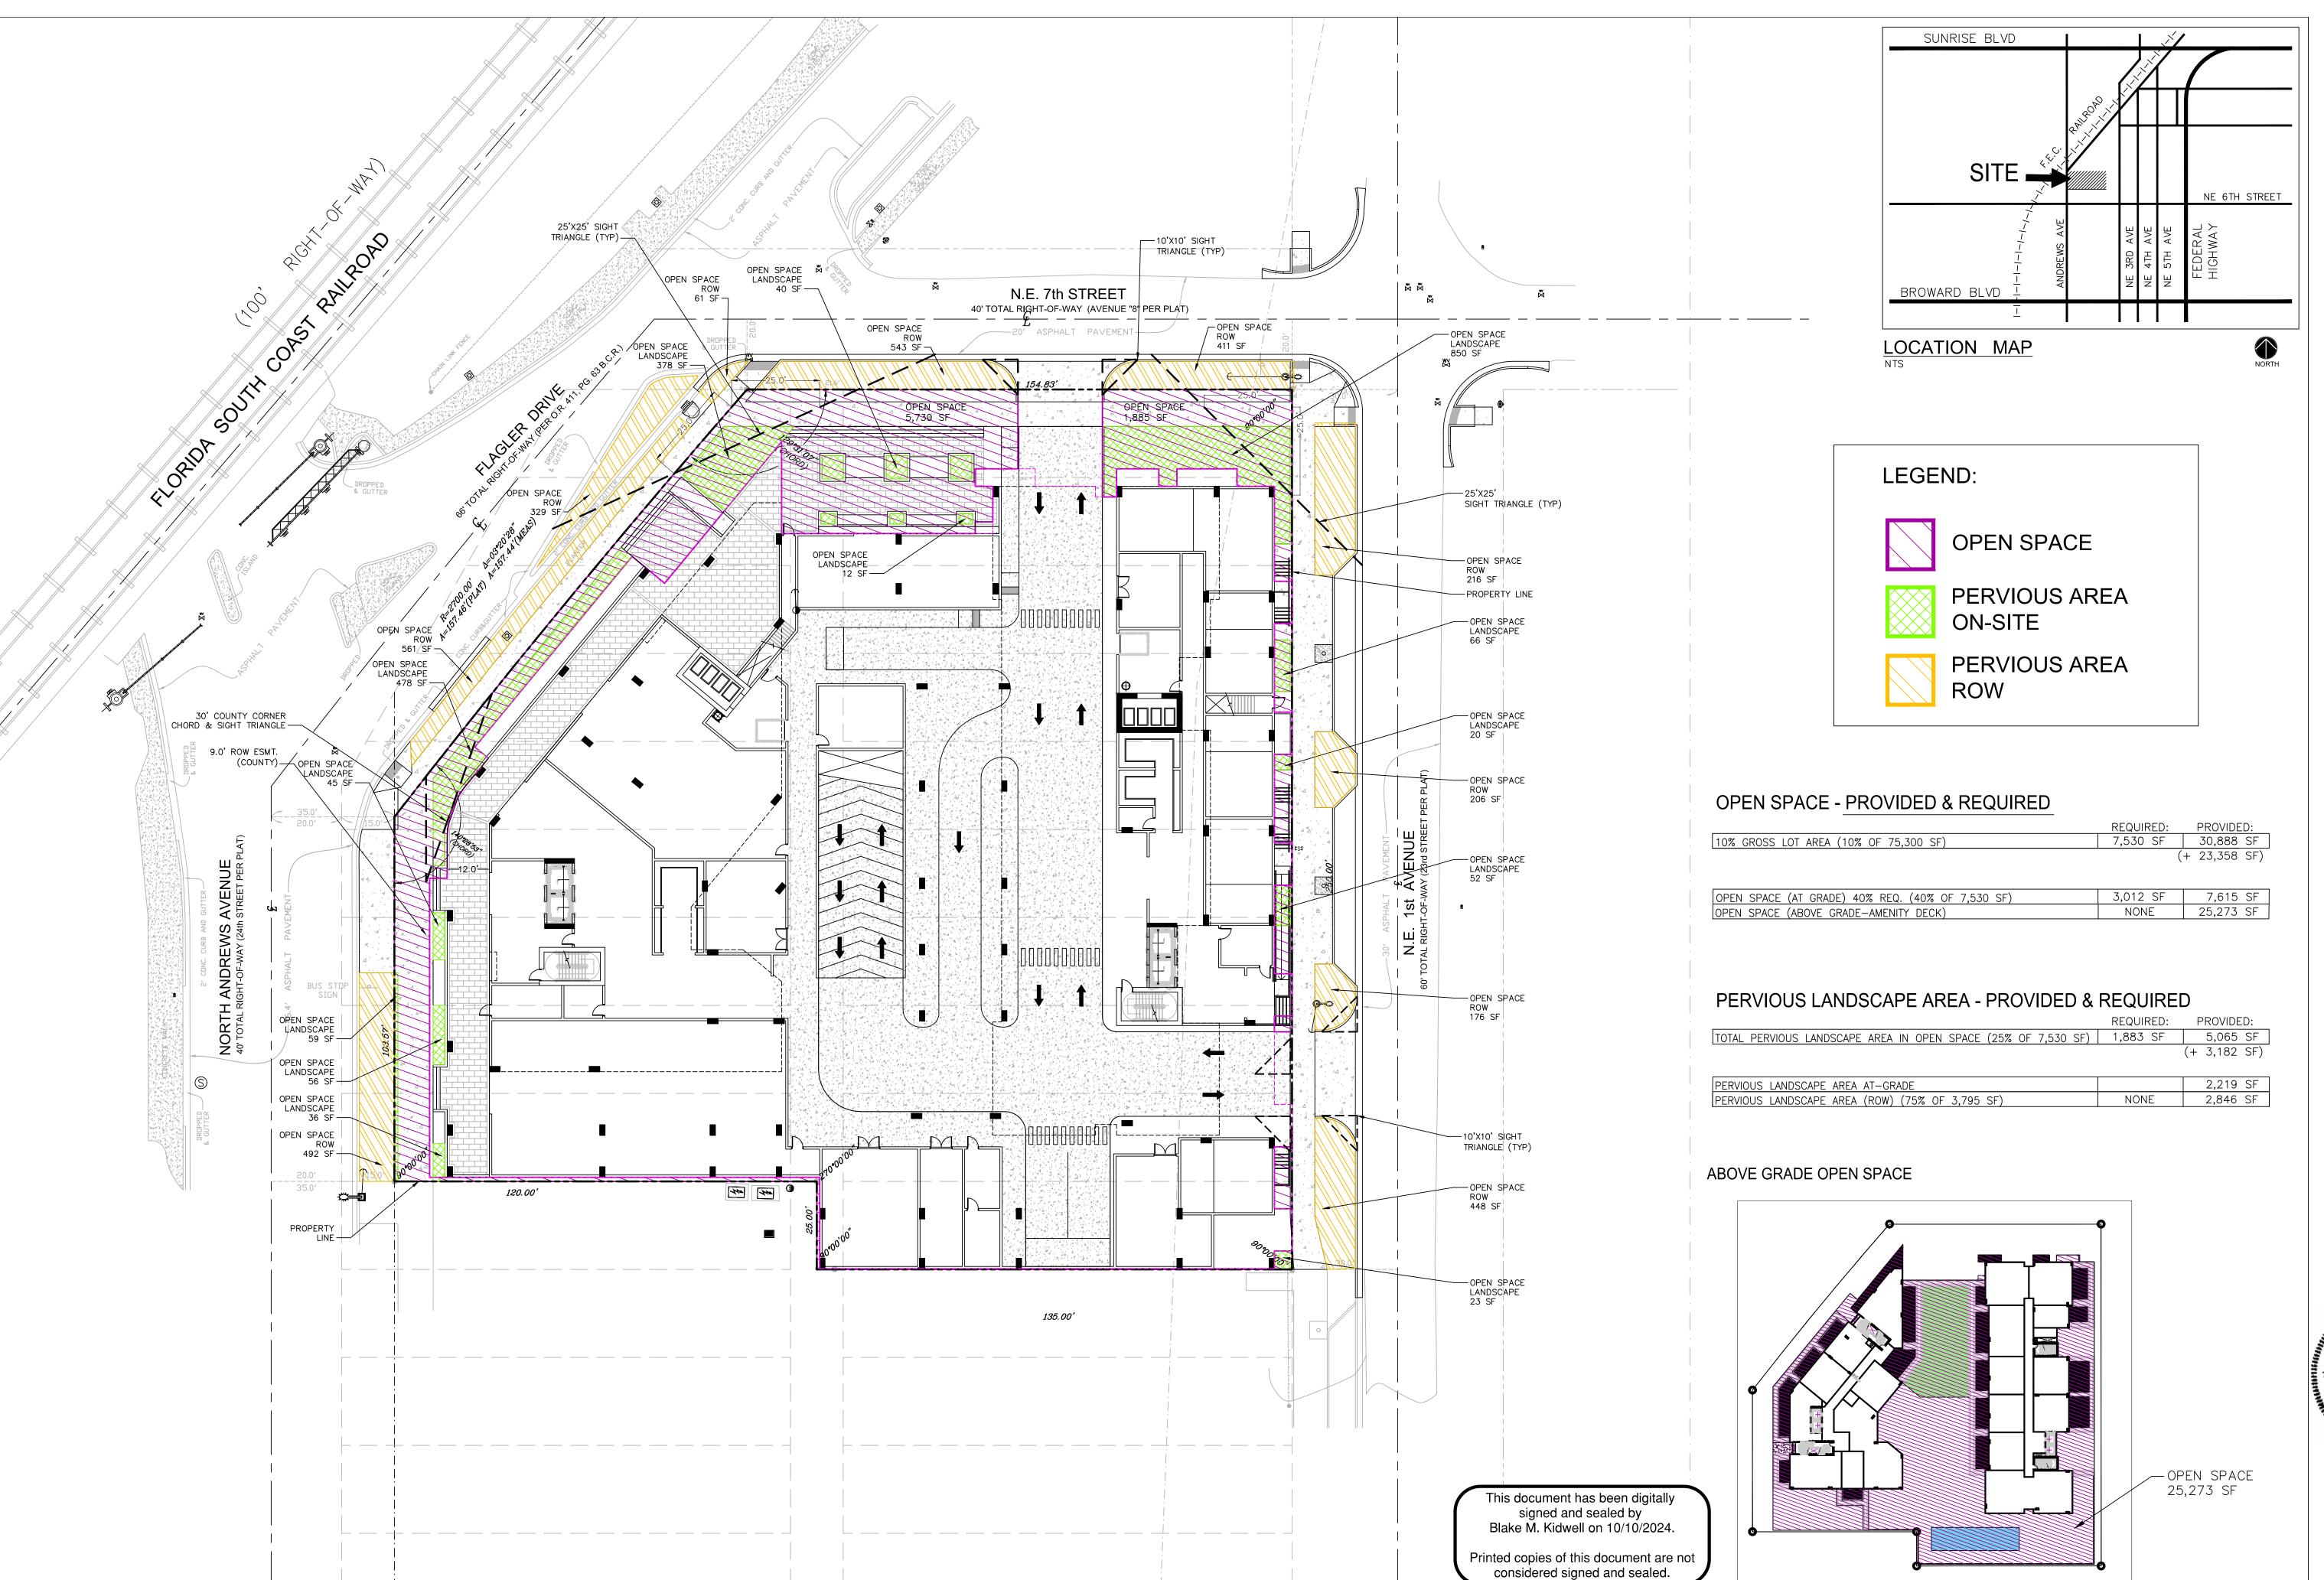
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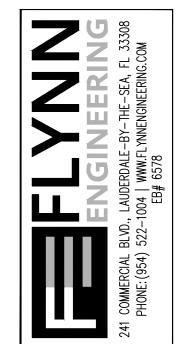
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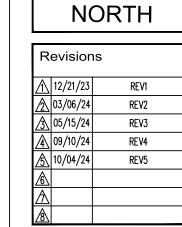
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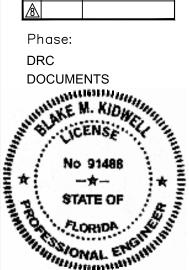


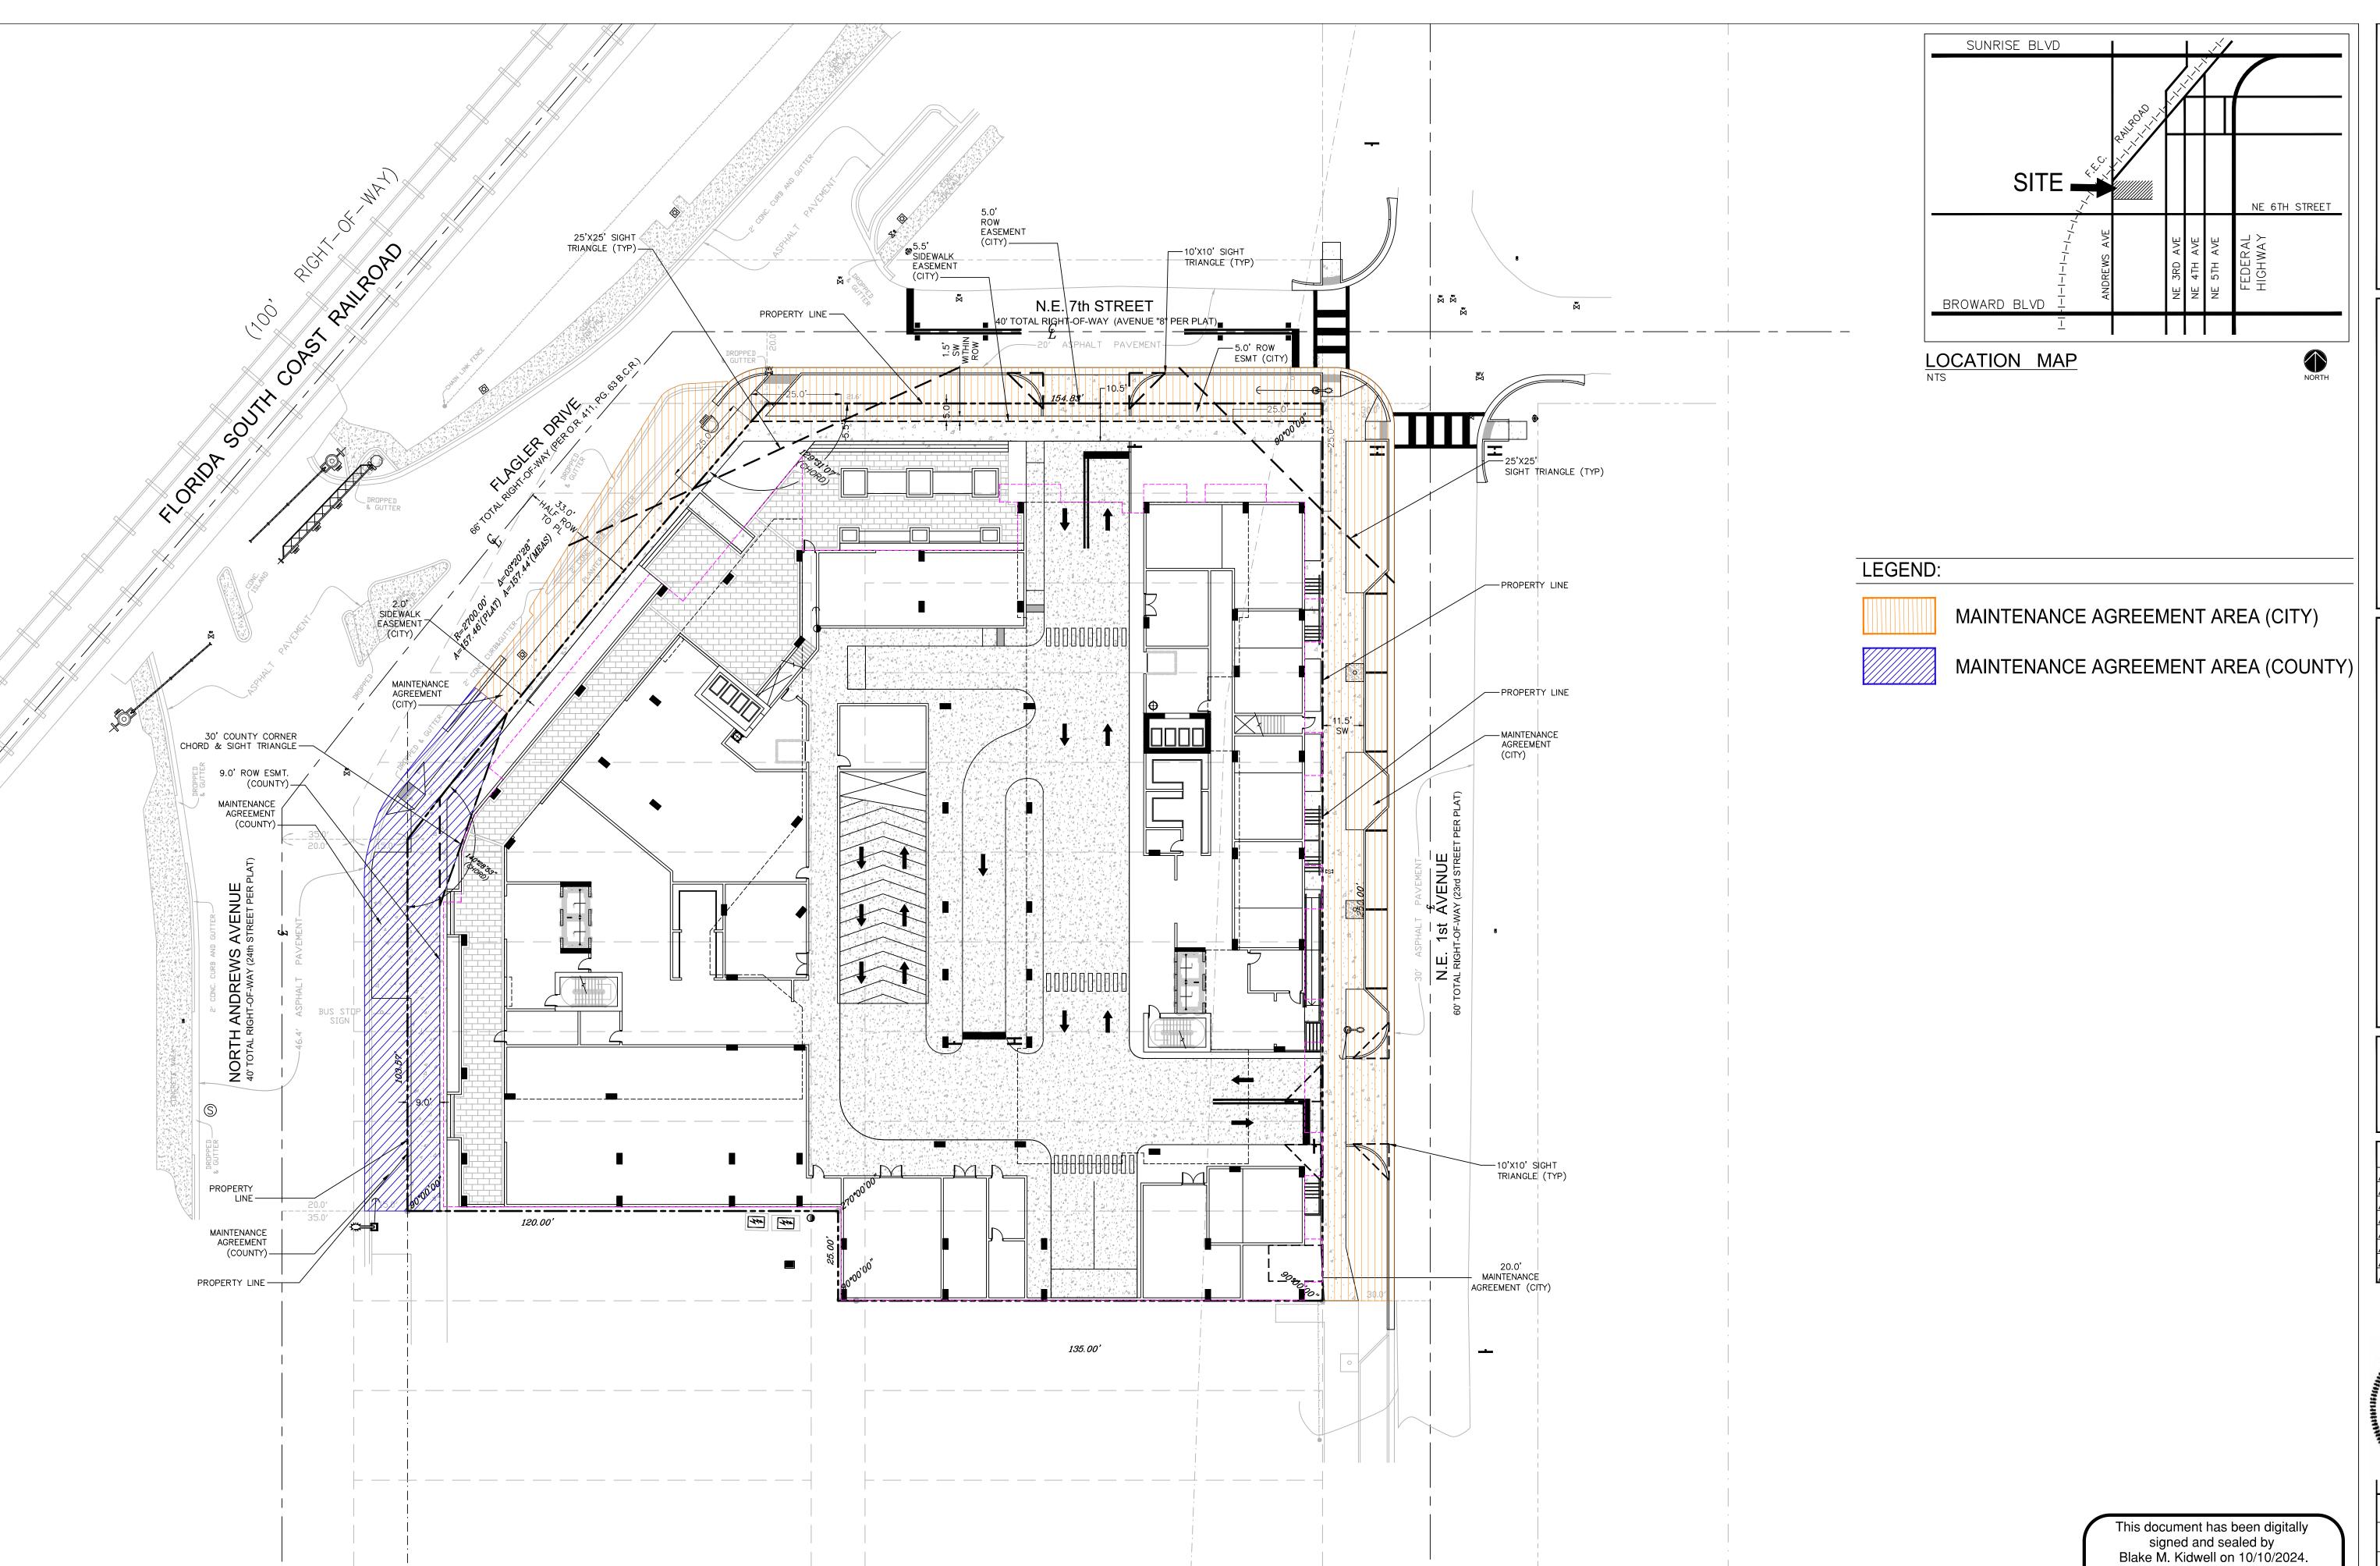


OPEN SPACE EXHIBIT

650 N ANDREWS AVE
1619 NW 6TH STREET
FORT LAUDERDALE, FLORIDA






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PASSENGER CAR CIRCULATION EXHIBIT

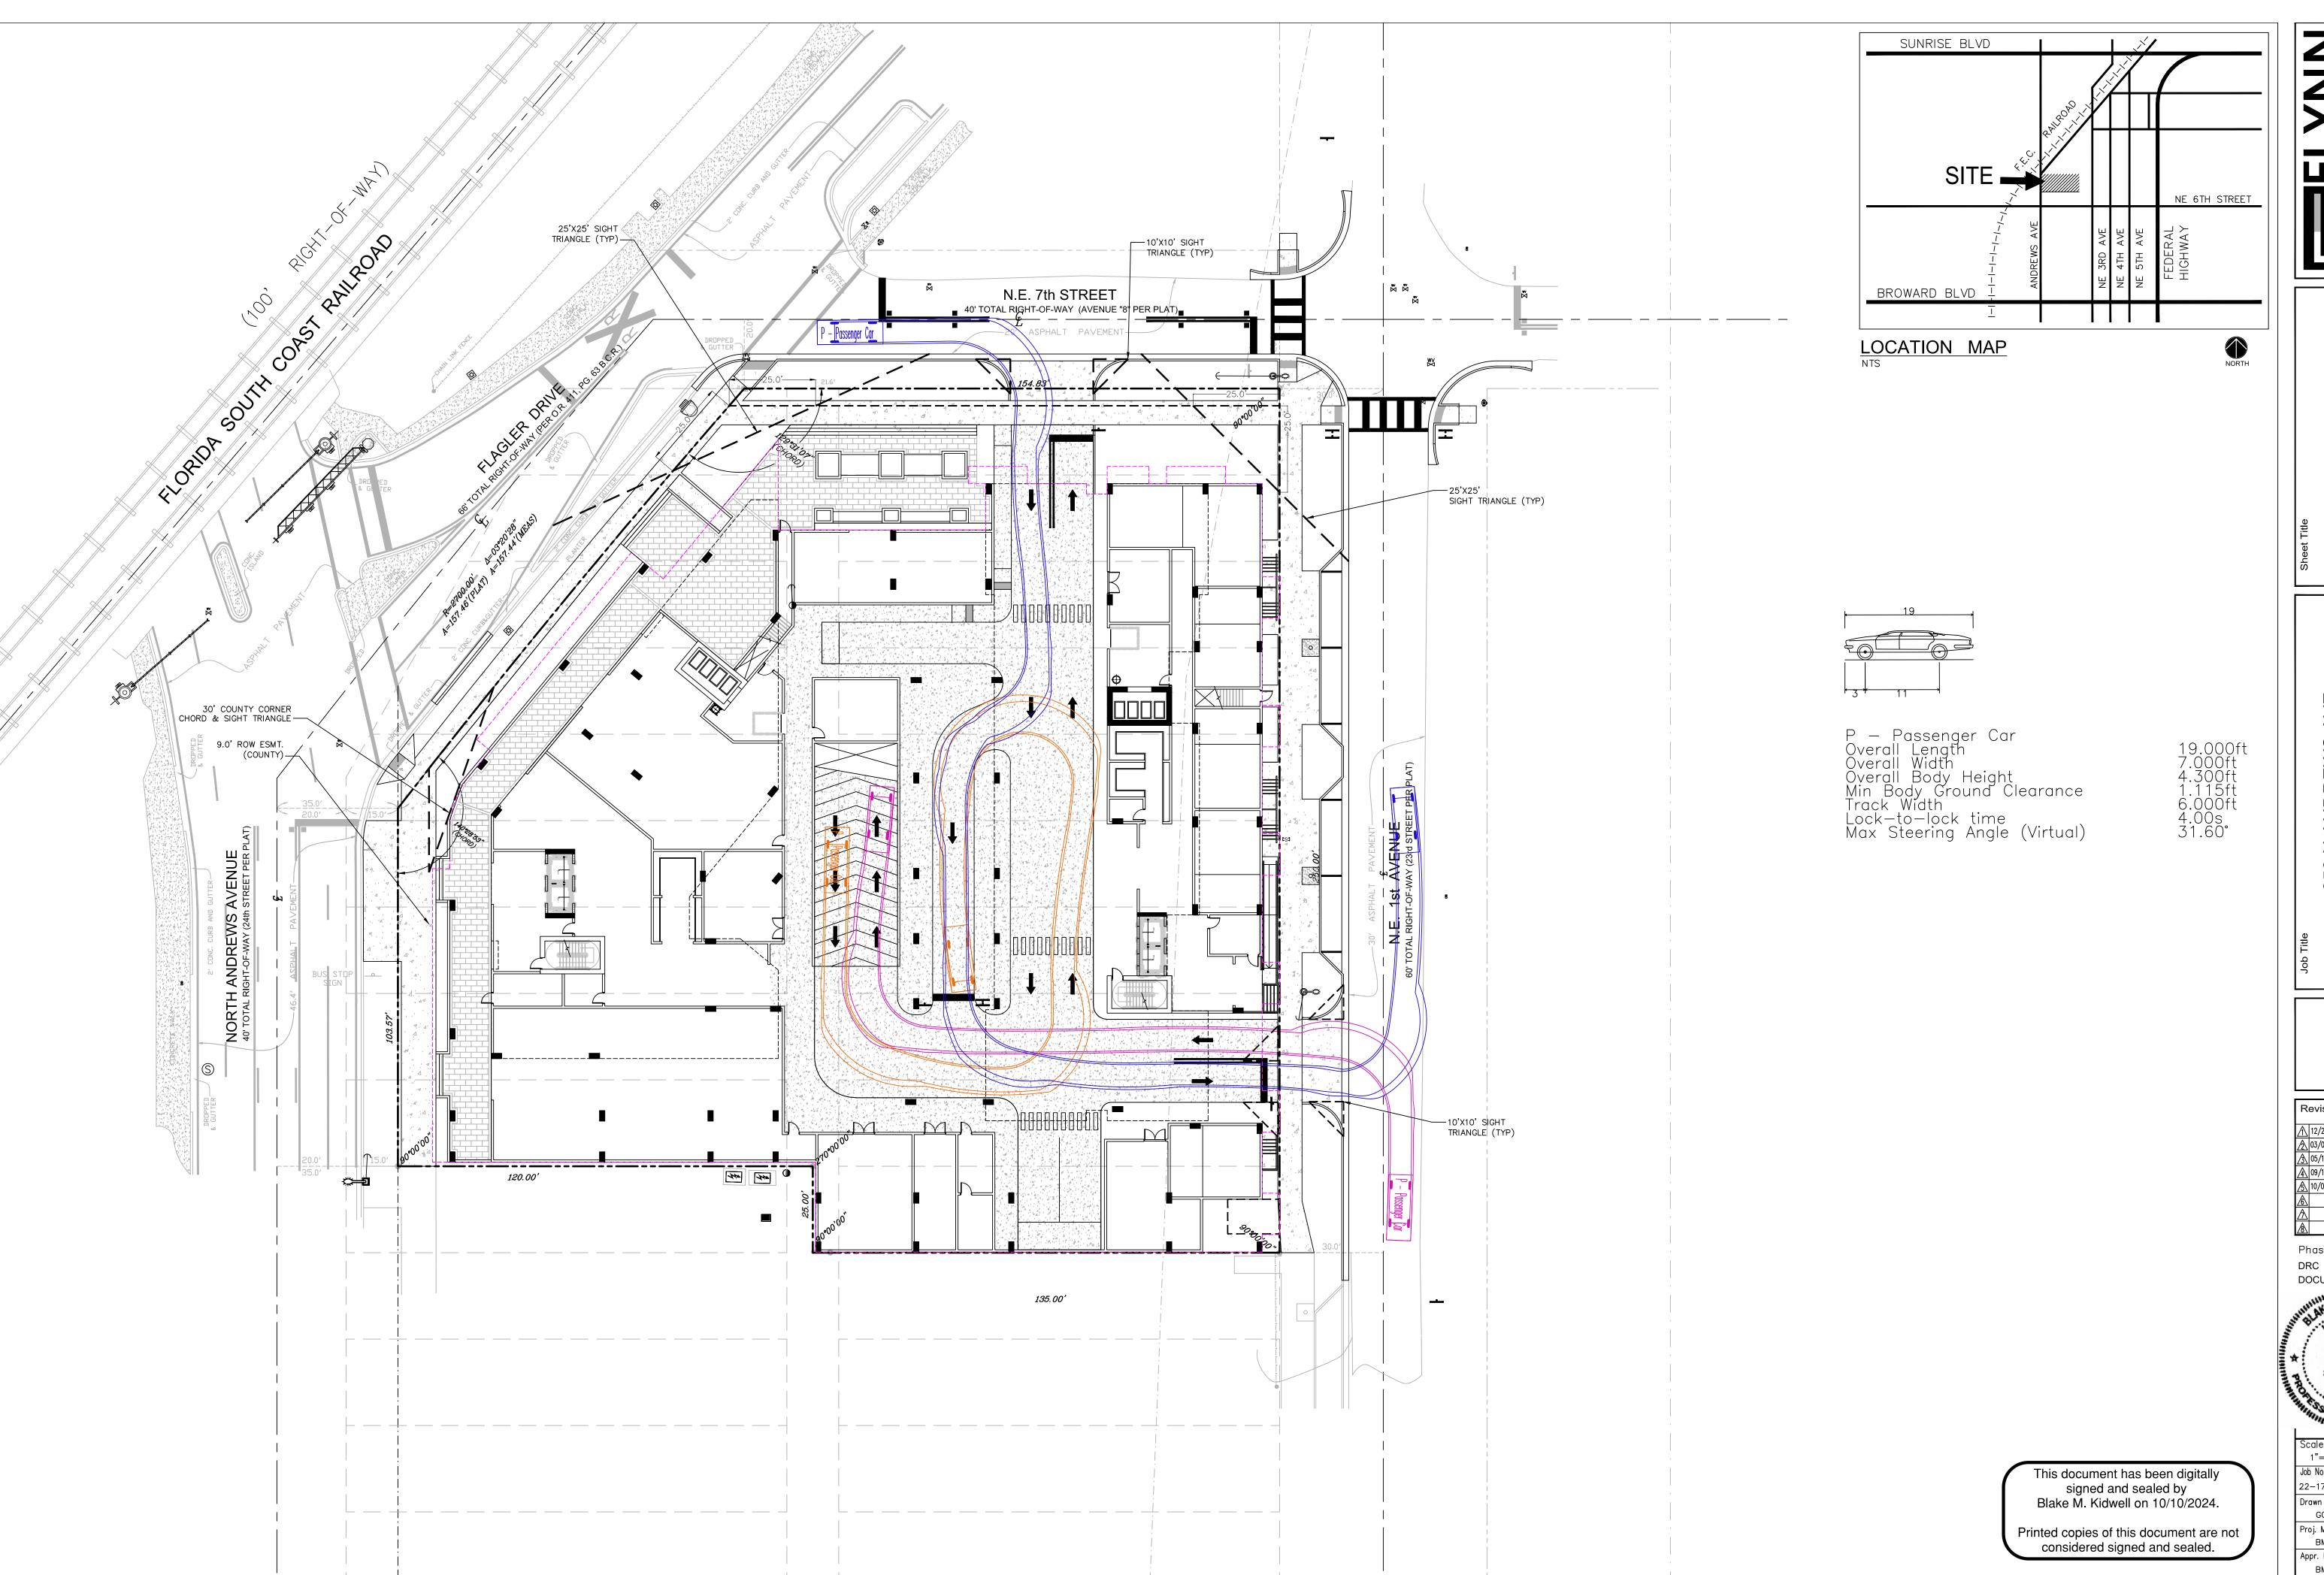650 N ANDREWS AVE





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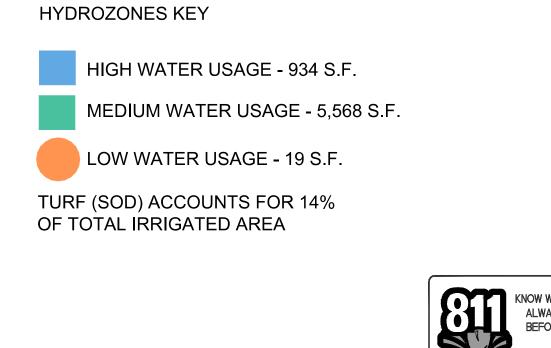



OR LANDSCAPE INSPECTOR AND THE LANDSCAPE CONTRACTOR PRIOR TO

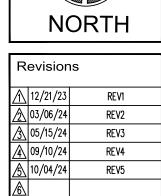ANY INSTALLATION ON THE SITE.

PLAN	NT SCH	HEDULE 650 N ANDREWS -	APTS						
CODE	QTY	BOTANICAL NAME	COMMON NAME	CONT	CALIPER	SIZE	NATIVE	DROUGHT	
TREES	•	•	•	•	•	-	•	•	•
LJ	3	LIGUSTRUM JAPONICUM	TREE LIGUSTRUM	FG/B&B	MULTI STEM	8`-10` OA	NO	MEDIUM	
QV	7	QUERCUS VIRGINIANA	LIVE OAK "HIGH RISE"	FG/B&B	4"CAL	20' OA., 8-10' SPRD., 8' CT., MATCHED	YES	HIGH	
FI OWFI	RING TRE	FS	•	•	•		•	•	•
PP	4	PELTOPHORUM PTEROCARPUM	YELLOW POINCIANA	-	3" CAL.	16` HT. X 7` SPR., 7` CT	NO	MED.	
TT	3	TABEBUIA HETEROPHYLLA	PINK TRUMPET TREE	FG/B&B	3" CAL.	16` HT. X 7` SPR., 7` CT.	NO	HIGH	
PALM T	REES		•	•	'		•	•	•
PD	4	PHOENIX DACTYLIFERA `MEDJOOL`	MEDJOOL DATE PALM	FG/B&B		14` CT, NUT INCLUDED, MATCHED	NO	HIGH	
PE	9	PTYCHOSPERMA ELEGANS	SOLITAIRE PALM	FG/B&B		10-12` OA, SINGLE, STRAIGHT LEADER	NO	HIGH	
TR2	6	THRINAX RADIATA	FLORIDA THATCH PALM	-		6` OA, SINGLE TRUNK	YES	HIGH	
TR1	6	THRINAX RADIATA	FLORIDA THATCH PALM	EXISTING TO REMAIN		EXISTING TO REMAIN	YES	HIGH	
VM	15	VEITCHIA MCDANIELSII	SUNSHINE PALM	FG/B&B	SPECIMENS	12` GW, MATCHED	NO	HIGH	
ACCEN	T PLANT				•	•			•
APN	29	AECHMEA X 'PINOT NOIR'	PINOT NOIR BROMELIAD	-		20"X20" OA.	NO	HIGH	
CSI	6	CUPRESSUS SEMPERVIRENS	ITALIAN CYPRESS	-	SPECIMEN	7-8` OA, FULL TO BASE	NO	HIGH	
PLA	5	POLYALTHIA LONGIFOLIA PENDULA	ASHOKA TREE	-	1" CAL.	7-8` OA, FULL TO BASE	NO	HIGH	
PALMS	& CYCAD	S			•	•	•		•
PR	12	PHOENIX ROEBELENII	PYGMY DATE PALM	-	SPECIMEN	8` OA	NO	HIGH	
REL	3	RHAPIS EXCELSA	LADY PALM	-	SPECIMEN	5`-6` OA	NO	MEDIUM	
CODE	QTY	BOTANICAL NAME	COMMON NAME	CONT	CALIPER	SIZE	NATIVE	DROUGHT	SPACING
SHRUB	ARFAS				•		•		
CIR	213	CHRYSOBALANUS ICACO 'REDTIP'	RED TIP COCOPLUM	-		30" HT. X 24" SPR.	YES	HIGH	24" o.c.
IVD	394	ILEX VOMITORIA 'STOKES DWARF'	DWARF YAUPON HOLLY	-		14" HT X 14" SPR	YES	HIGH	18" o.c.
PNW	17	PSYCHOTRIA NERVOSA	WILD COFFEE	-		20" HT. X 20" SPR.	YES	HIGH	24" o.c.
SAT	155	SCHEFFLERA ARBORICOLA 'TRINETTE'	SCHEFFLERA	-		24"HT X 24"SPR	NO	HIGH	24" o.c.
GROUN	D COVER	RS			•	•		•	•
AGR	576	ARACHIS GLABRATA	PERENNIAL PEANUT	-		4" HT. X 12" SPR.	NO	HIGH	18" o.c.
ADM	30	ASPARAGUS DENSIFLORUS 'MYERS'	MYERS ASPARAGUS	-		18" HT. X 18" SPD.	NO	MEDIUM	20" o.c.
CIH	409	CHRYSOBALANUS ICACO 'HORIZONTALIS'	HORIZONTAL COCOPLUM	-		14" HT X 16" SPR	YES	HIGH	24" o.c.
JVW	41	JASMINUM VOLUBILE	WAX JASMINE	-		18" HT. X 18" SPD.	NO	MEDIUM	24" o.c.
NES	96	NEPHROLEPIS EXALTATA	BOSTON FERN	-		12" HT. X 12" SPR.	YES	HIGH	18" o.c.
SOD/SE	ED	·		<u> </u>					
SOD	934 SF	STENOTAPHRUM SECUNDATUM `FLORITAM`	`FLORITAM` ST. AUGUSTINE SOD	SOD					

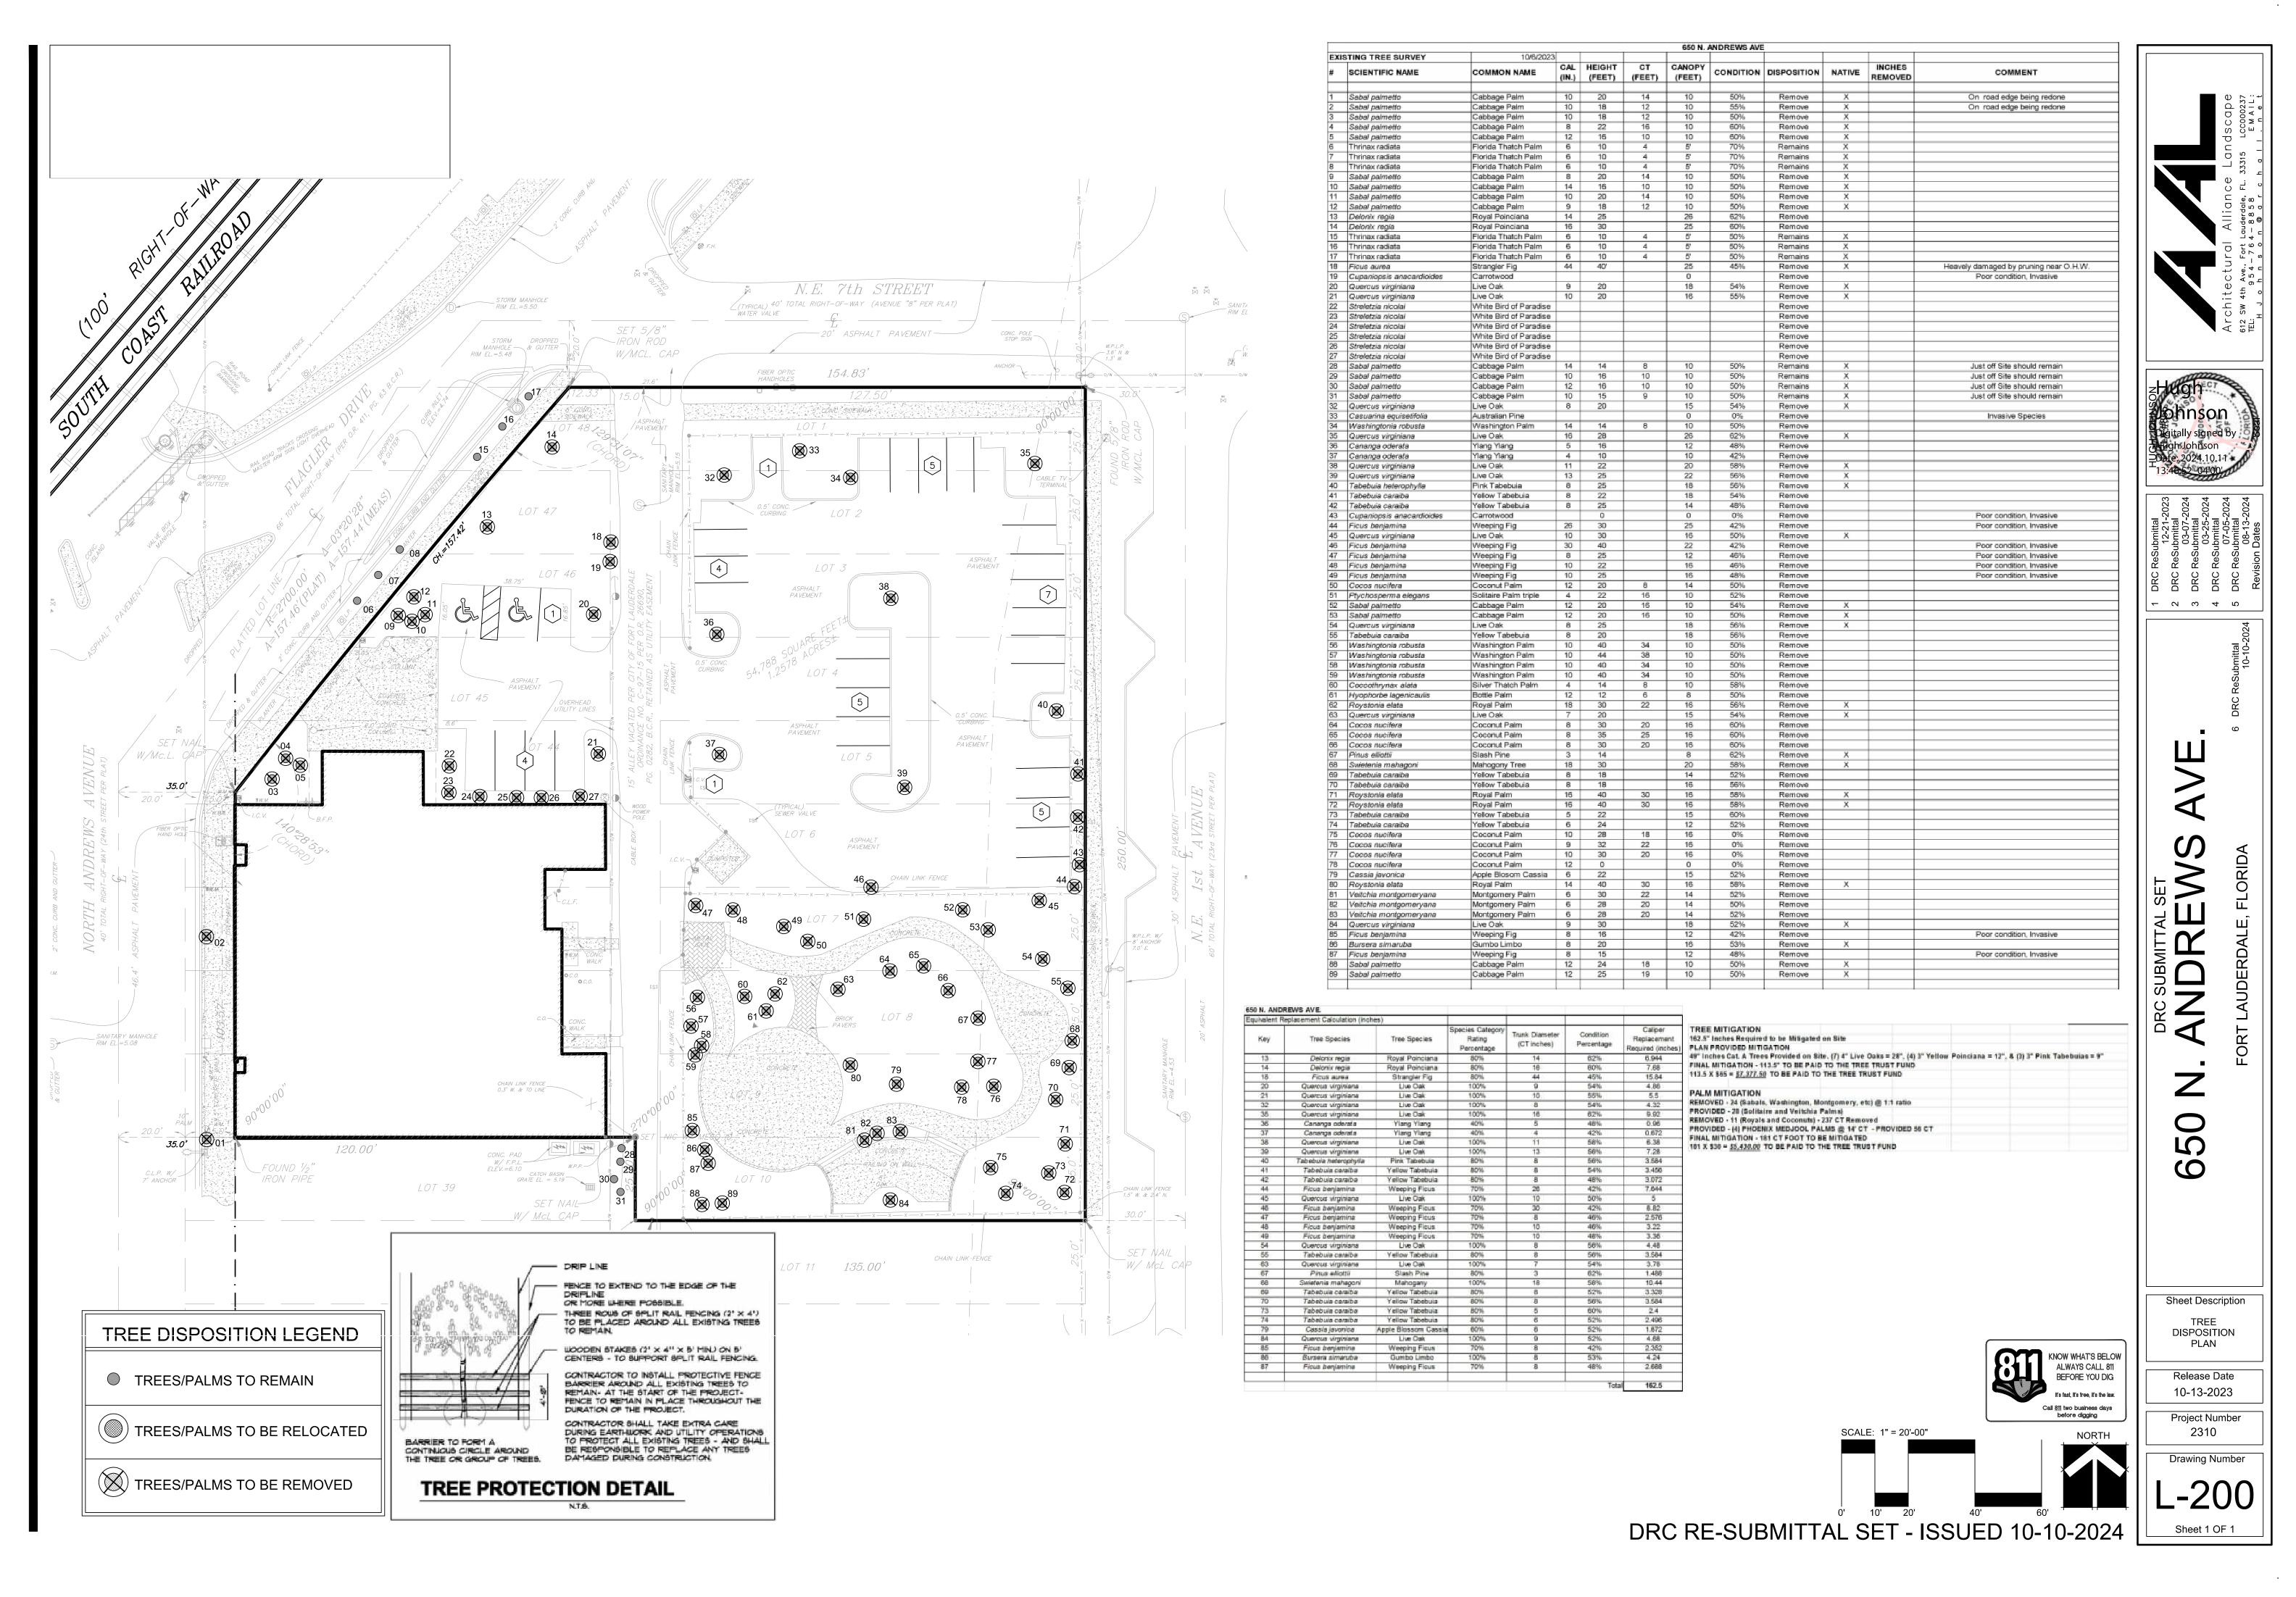N. ANDREWS AVE.		
ND USE: D-RAC		
NING: RAC-UV		
E AREA	1.25 AC.	58,788 SF
TAL PERVIOUS AREA PROPOSED		3,054 SF
TAL LANDSCAPE AREA PROVIDED		3,054 SF
TAL VUA	0	0
NDSCAPE VUA AREA (20% OF VUA)	0	0
PERIMETER VUA	0	0
INTERIOR VUA (30 SF EACH SPACE) - NO SPACES	0	0
	REQUIRED	PROVIDED
HICULAR USE AREA (1 TREE PER 1,000 SF)		
EES (1 TREE PER 1,000 SF OF VUA)	N/A	N/A
RUBS (12 SHRUBS PER 1,000 SF OF VUA)	N/A	N/A
T LOT AREA (1 TREE PER 1,000 SF)		
54 SF / 1,000 SF = 3 TREES	3 Trees	3 Trees & 16 Palms
RUBS (12 SHRUBS PER 1,000 SF) 12 x 3 = 36 Shrubs	36 Shrubs	1,928 Shrubs
NLY COUNTING PERVIOUS AREA WITHIN SITE, NOT		
VITHIN STREET ROW'S		
REET TREES		П
REE PER 30 LF WITH RAC-UV		
7TH STREET (NORTH): 150 LF / 30 LF = 5 Trees	5 Trees	3 Trees & 2 Palms
1ST AVE. (EAST): 250 LF / 30 LF = 8 Trees	8 Trees	6 Trees & 4 Palms
AGLER DRIVE (NORTH/WEST): 155 LF / 30 = 5 Trees	5 Trees	3 Trees and 6 Palm
ANDREWS AVE (WEST): 63 LF / 30 LF = 2 Trees*	2 Trees	2 Trees*
SUB-TOTAL	20 Trees	14 Trees & 12 Paim
6 of Street Trees shall be trees		70% Trees
TAL TREES	23 Trees	17 Trees & 28 Palm
TIVE TREES		
4 TREES MUST BE NATIVE (23 TREES X 40% = 9)	9 Trees	9 Trees
6 NATIVE PLANT MATERIAL		
al Provided - 2,077 x 50% = 1,039 Req. Native)	1,039	1,146 (55%)
D		
6 MAX. SOD FOR PERVIOUS AREA - ON SITE		
54 SF Total Pervious / 50% = 1,527 SF Max.	50% - 1,527 SF	0% - 0 SF
y providing sod within Street ROW's nothing On-Site		
SOD AND LANDSCAPE TO RECEIVE 100% COVERA RIGATION SYSTEM USING AN APPROVED WATER SO RIGATION SYSTEM SHALL ALSO BE EQUIPT WITH A R	URCE.	'n

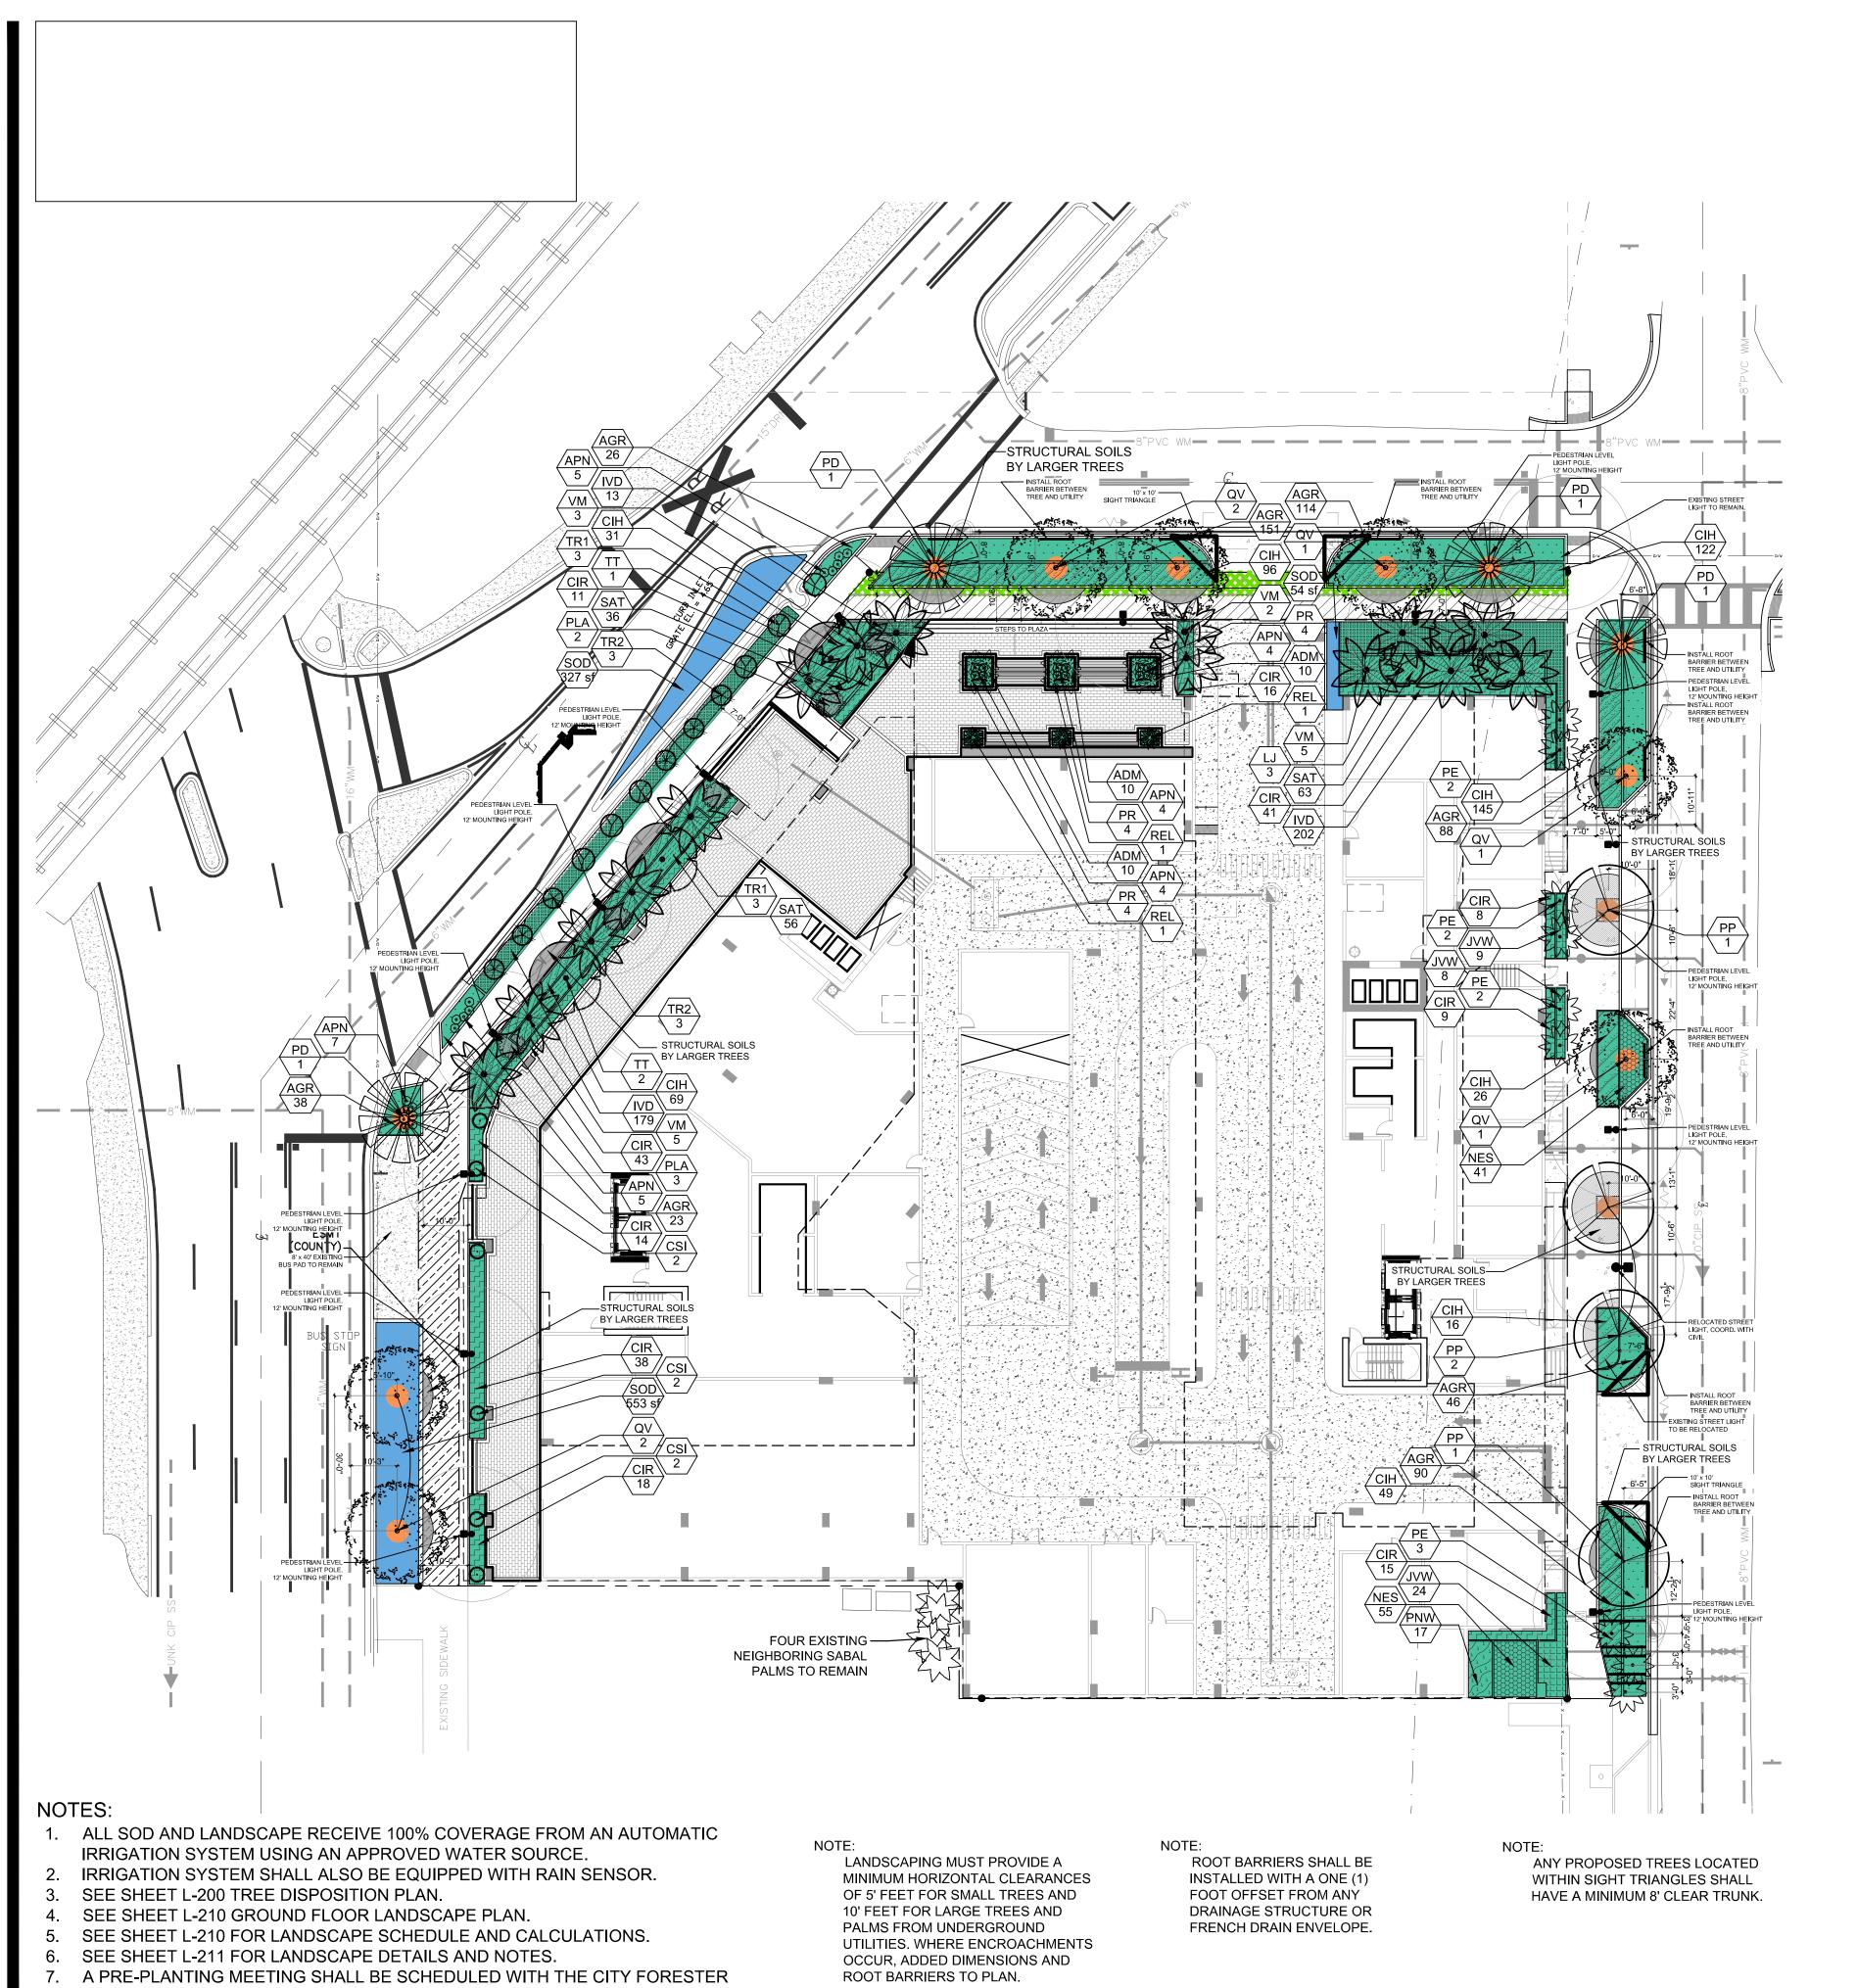

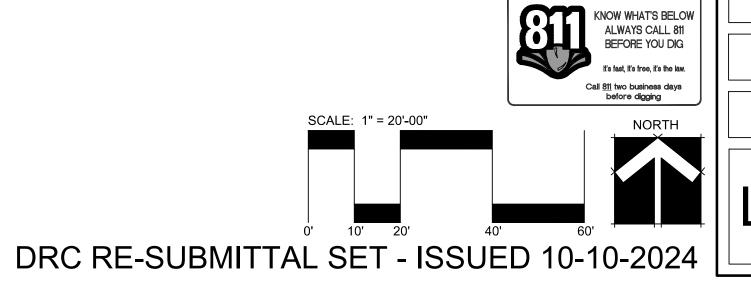

650 N. ANDREWS AVE.

Sheet Description

GROUND FLOOR LANDSCAPE PLAN

Release Date

Project Number

Drawing Number

10-13-2023

ROOT BARRIER IF REQUIRED, 24" DEPTH TYPICAL, — TYPICAL PAVING OR LOCATE AT BACK OF CURB CONC. WALK - 4" COMPACTED LIMEROCK BY CIVIL ENGINEER BASE FOR PAVERS TYPICAL ASPHALT ROADWAY -ROAD ROCK, DEPTH AND SIZE TO-BE DETERMINED BY CIVIL ENG. Do Not Nail Wood Battens to Tree 5 Layers Burlap (Min.) 2x4" Wood Braces Nailed Into the Wood Battens Banding Wire 3" Mulch Layer 5-6" Water Ring - Remove Burlap, String, Nails, etc., Completely From Plant Ball Fertilizer Tabs or Eq. CU-STRUCTURAL SOIL, REFER TO SPECIFICATION— ON THIS SHEET, EXTEND TO A DEPTH OF 36". INSTALL PER Backfill with 6" Planting Soil MANUFACTURER'S INSTRUCTIONS. 50/50 Topsoil / sand mix PREPARED COMPACTED SUBGRADE, — REFER TO CIVIL ENGINEER'S DRAWINGS Undisturbed Earth **CU-STRUCTURAL SOIL DETAIL** Large Tree Planting Detail

CU-STRUCTURAL SOIL* SPECIFICATIONS

PART 2- MATERIALS

2.1 CLAY LOAM

A. Soil shall be a "loam" with a minimum clay content of 20% or a "clay loam" based on the "USDA classification system" as determined by mechanical analysis (ASTM D-422) and it shall be of uniform composition, without admixture of subsoil. It shall be free of stones, lumps, plants and their roots, debris and other extraneous matter. It shall not contain toxic substances harmful to plant growth. Clay loam shall contain not less than 2% or more than 5% organic matter as determined by the loss on ignition of oven-dried samples. Test samples shall be oven-dried to a constant weight at a temperature of 230 degrees F., plus or minus 9

B. Mechanical analysis for the loam or elay foam shall be as follows:

ment of end announted as no a
% of Total Weight
less than 5%
20-45%
20-50%
20-40%

- C. Chemical analysis: Meet, or be amended to meet the following criteria:
- pH between 5.5 to 6.5
- 2. Percent organic matter 2% 5% by dry weight
- Adequate nutrient levels

Carbon/Nitrogen ratio less than 33:1

- 4. Soluble salt less than 1.0 mmho/cm.
- Cation Exchange Capacity (CEC) greater than 10
- D. Loam or clay loam shall not come from USDA classified prime farmland.

2.2 FERTILIZER (if needed)

2.3 SULFUR (if needed)

A. Should nutrient analysis suggest that the loam or clay loam need additional nutrients, it shall be amended by Amereq's licensed producer.

- A. Sulfur shall be a commercial granular, 96% pure sulfur, with material and analysis appearing
- B. Sulfur used to lower pH shall be a ferrous sulfate formulation.
- C. Application rates shall be dependent on soil test results.

2.4 LIME (if needed)

Agricultural lime containing a minimum of 85% carbonates.

B. Application rates shall be dependent on soil test results.

2.5 CRUSHED STONE

- A. The size of the crushed stone shall be 0.75 inches to 1.5 inches allowing for up to 10% being greater than 1.5 inches, and up to 10% less than 0.75 inches.
- B. Acceptable aggregate dimensions will not exceed 2.5:1.0 for any two dimensions.
- C. Minimum 90% with two or more fractured faces.
- D. Results of Aggregate Soundness Loss test shall not exceed 18%.
- E. Losses from LA Abrasion tests shall not exceed 40%.

2.6 HYDROGEL

A. Hydrogel shall be a coated potassium propenoate-propenamide copolymer (Gelscape® Hydrogel Tackifier) as manufactured by Amereq, Inc. 800-832-8788.

2.7 WATER

A. The installing contractor shall be responsible to furnish his own supply of water (if needed) free of impurities, to the site.

2.8 CU-STRUCTURAL SOIL*

A. A uniformly blended urban tree mixture of crushed stone, clay loam and Gelscape* Hydrogel fackifier, as produced by an Amereq-licensed company, mixed in the following proportion:

> specified crushed Stone specified clay loam Gelseape* Hydrogel Tackifier

Unit of Weight 100 units dry weight 20 - 25 units (to achieve minimum CBR of 50) 0.035 units dry weight ASTM D698/AASHTO T-99 optimum moisture

CU-STRUCTURAL SOIL SPECIFICATIONS

SPECIAL INSTRUCTIONS:

- 1. GENERAL SITE AND BERM GRADING TO +/- 1 INCH (1") SHALL BE PROVIDED BY THE GENERAL CONTRACTOR. ALL FINISHED SITE GRADING AND FINAL DECORATIVE BERM SHAPING SHALL BE PROVIDED BY THE LANDSCAPE CONTRACTOR.
- 2. ALL SOD AREAS AS INDICATED ON THE PLANTING PLAN SHALL RECEIVE STENOTAPHRUM SECUNDATUM, ST. AUGUSTINE 'PALMETTO' SOLID SOD. IT SHALL BE THE RESPONSIBILITY OF THE LANDSCAPE CONTRACTOR TO INCLUDE IN THE BID, THE REPAIR OF ANY SOD WHICH MAY BE DAMAGED FROM THE LANDSCAPE INSTALLATION OPERATIONS.

Wellington Tape — 2x2" Wood Stakes _ 3" Mulch Layer Remove Burlap, String, Nails, etc. Completely From Plant Ball 5-6" Water Ring Fertilizer Tabs or Eq. Backfill with 6" Planting Soil 50/50 Topsoil/sand mix Undisturbed Earth

Small Tree Planting Detail

NOTES:

- 1. ALL SOD AND LANDSCAPE RECEIVE 100% COVERAGE FROM AN AUTOMATIC IRRIGATION SYSTEM USING AN APPROVED WATER SOURCE.
- IRRIGATION SYSTEM SHALL ALSO BE EQUIPPED WITH RAIN SENSOR.
- SEE SHEET L-200 TREE DISPOSITION PLAN.
- SEE SHEET L-210 GROUND FLOOR LANDSCAPE PLAN.
- SEE SHEET L-210 FOR LANDSCAPE SCHEDULE AND CALCULATIONS.
- SEE SHEET L-211 FOR LANDSCAPE DETAILS AND NOTES.
- 7. A PRE-PLANTING MEETING SHALL BE SCHEDULED WITH THE CITY FORESTER OR LANDSCAPE INSPECTOR AND THE LANDSCAPE CONTRACTOR PRIOR TO ANY INSTALLATION ON THE SITE.

DRC RE-SUBMITTAL SET - ISSUED 10-10-2024

GENERAL PLANTING REQUIREMENTS

All sizes shown for plant material on the plans are to be considered Minimum. All plant material must meet or exceed these minimum requirements for both height and spread. Any other requirements for specific shape or effect as noted on the plan(s) will also be required for final acceptance.

All plant material furnished by the landscape contractor shall be Florida #1 or better as established by "Grades and Standards for Florida Nursery Plants" and "Grades and Standards for Florida Nursery Trees". All material shall be installed as per CSI specifications.

All plant material as included herein shall be warrantied by the landscape contractor for a minimum period as follows: All trees and palms for 12 months, all shrubs, vines, groundcovers and miscellaneous planting materials for 90 days, and all lawn areas for 60 days after final acceptance by the owner or owner's representative.

All plant material shall be planted in planting soil that is delivered to the site in a clean loose and friable condition. All soil shall have a well drained characteristic. Soil must be free of all rocks, sticks, and objectionable material including weeds and weed seeds as per CSI specifications.

Twelve inches (12") of planting soil 50/50 sand/topsoil mix is required around and beneath the root ball of all trees and palms, and 1 cubic yard per 50 bedding or groundcover plants.

All landscape areas shall be covered with Eucalyptus or sterilized seed free Melaleuca mulch to a minimum depth of three inches (3") of cover when settled. A four-inch clear space must be left for air between plant bases and the mulch. Cypress bark mulch shall not be used.

All plant material shall be thoroughly watered in at the time of planting; no dry planting permitted. All plant materials shall be planted such that the top of the plant ball is flush with the surrounding grade.

- All landscape and lawn areas shall be irrigated by a fully automatic sprinkler system adjusted to provide 100% coverage of all landscape areas. All heads shall be adjusted to 100% overlap as per manufacturers specifications and performance standards utilizing a rust free water source. Each system shall be installed with a rain sensor.
- It is the sole responsibility of the landscape contractor to insure that all new plantings receive adequate water during the installation and during all plant warranty periods. Deep watering of all new trees and palms and any supplemental watering that may be required to augment natural rainfall and site irrigation is mandatory to insure proper plant development and shall be provided as a part of this contract.

All plant material shall be installed with fertilizer which shall be State approved as a complete fertilizer containing the required minimum of trace elements in addition to N-P-K, of which 50% of the nitrogen shall be derived from an organic source as per CSI specifications.

Contractors are responsible for coordinating with the owners and appropriate public agencies to assist in locating and verifying all underground utilities prior to excavation.

All ideas, designs and plans indicated or represented by this drawing are owned by and are the exclusive property of AAL.

The plan takes precedence over the plant list.


LANDSCAPE **DETAILS AND** NOTES

10-13-2023

Project Number 2310

Drawing Number

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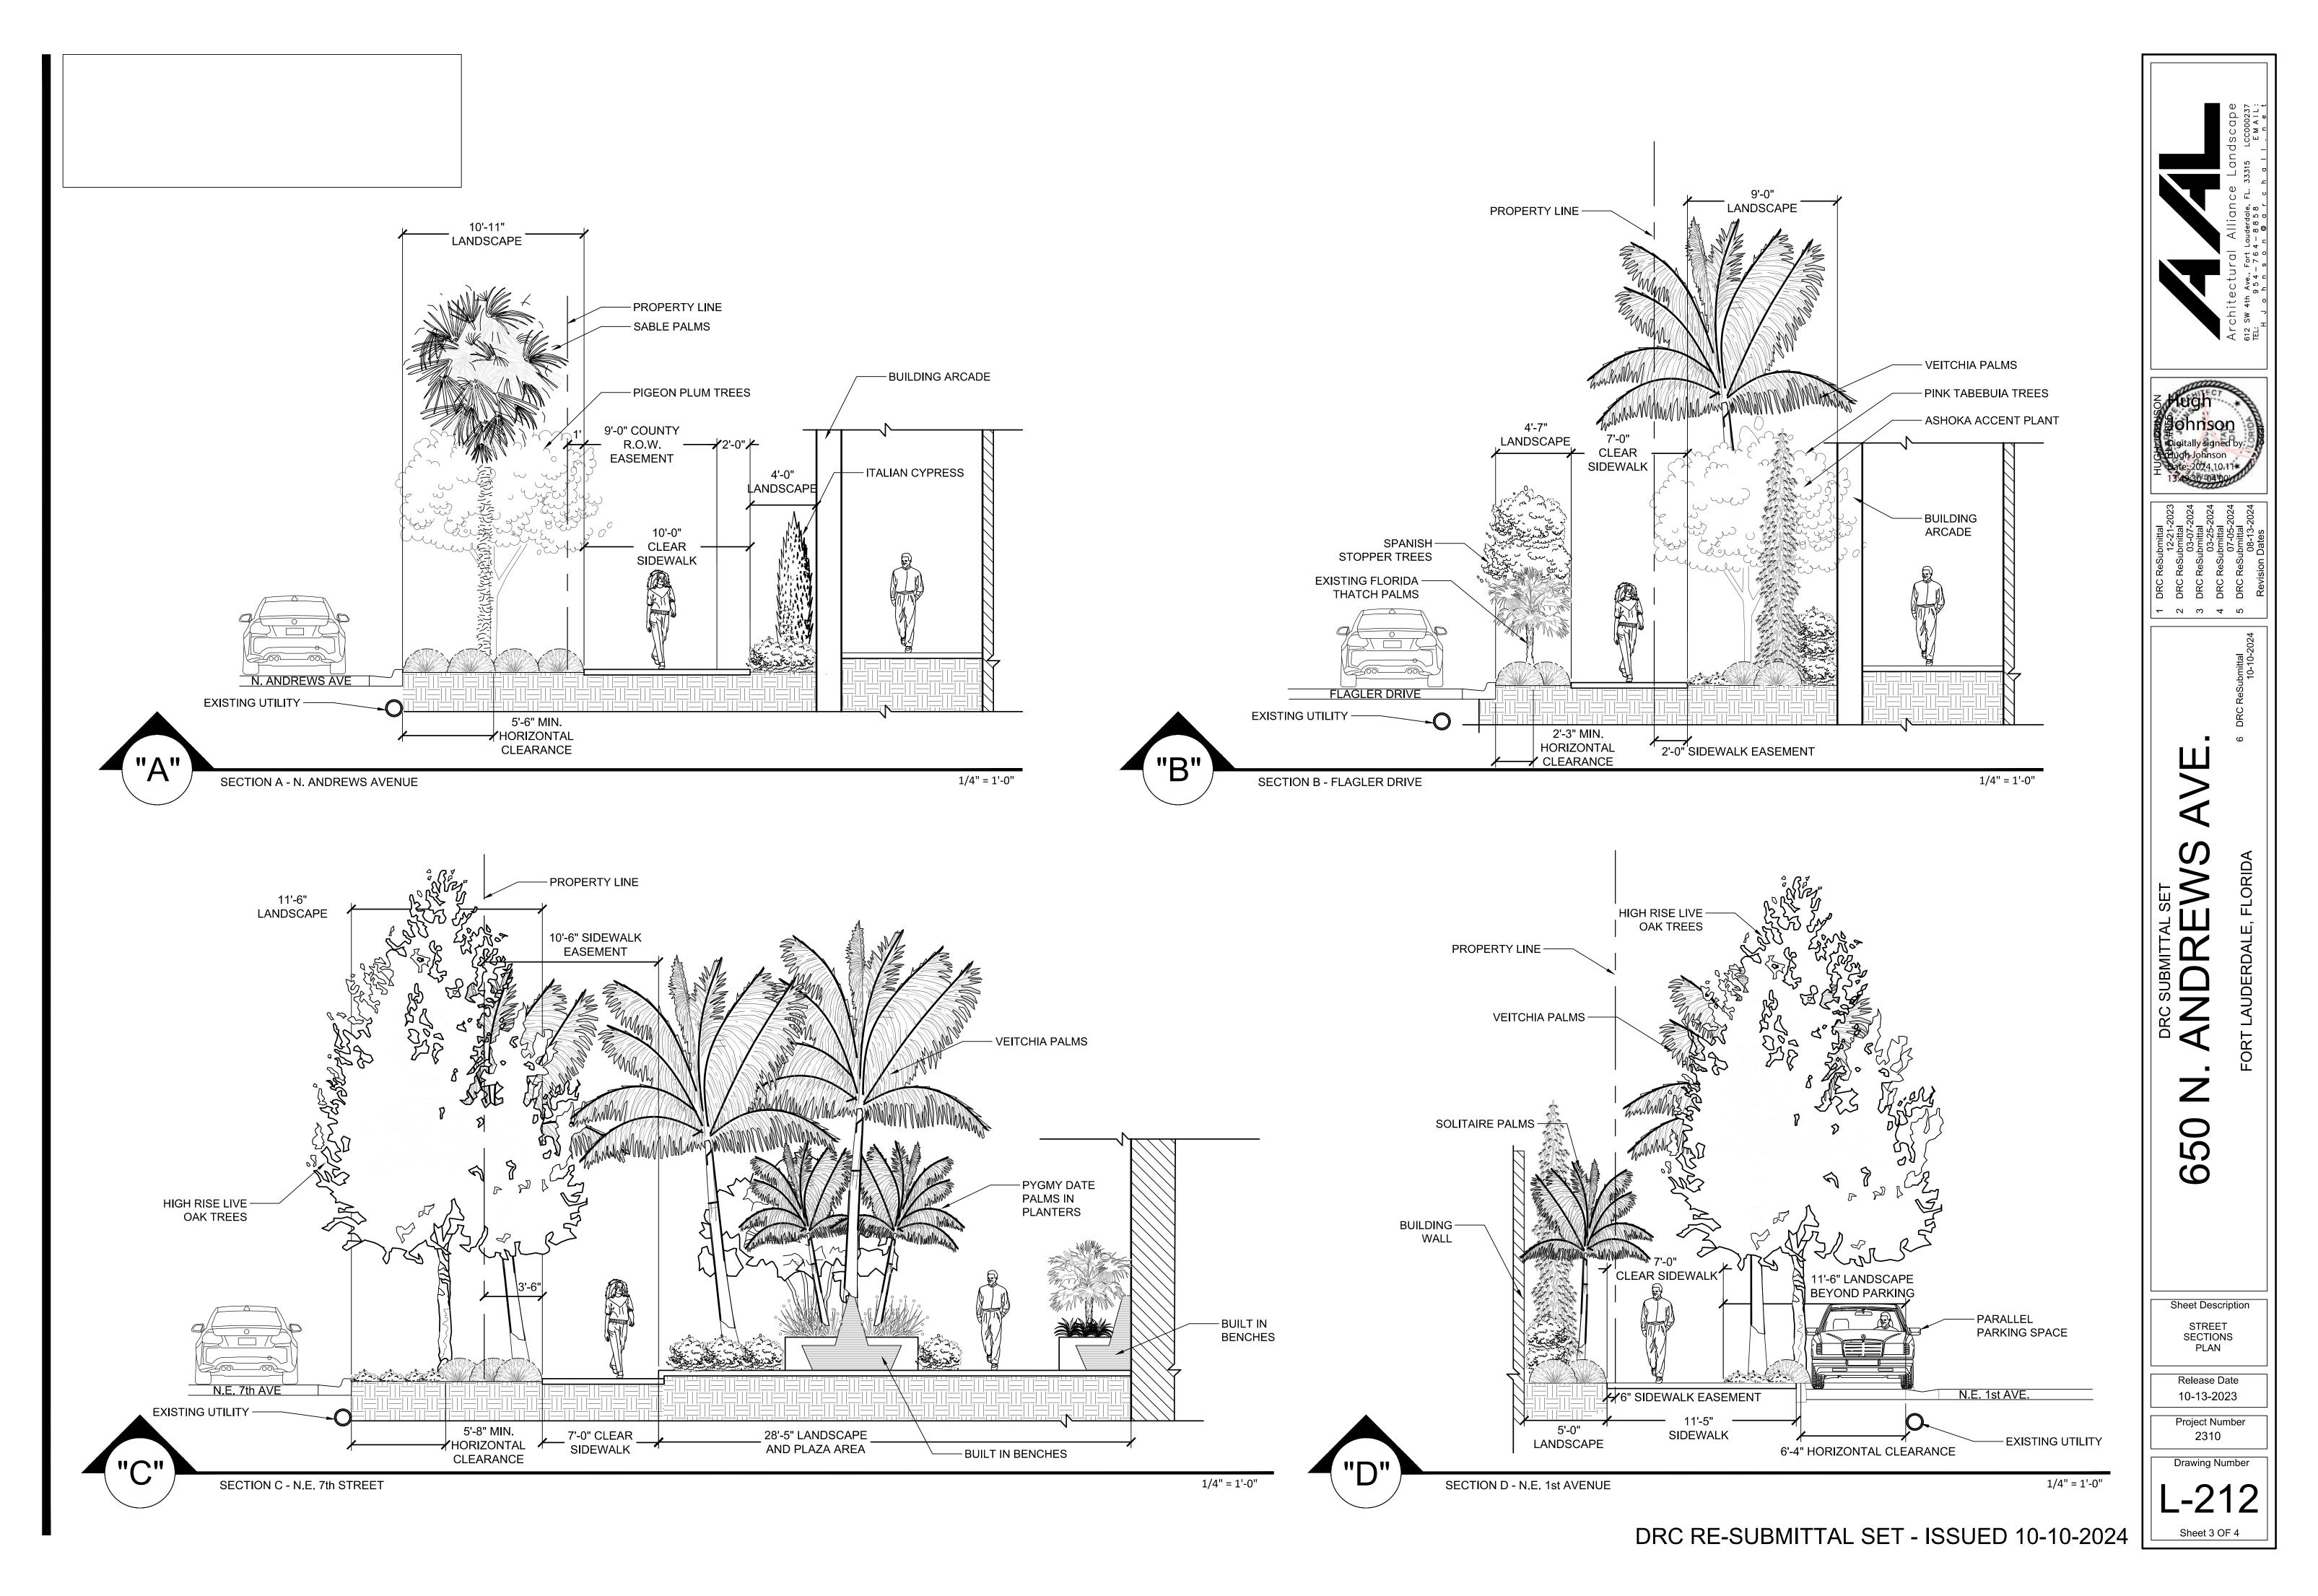
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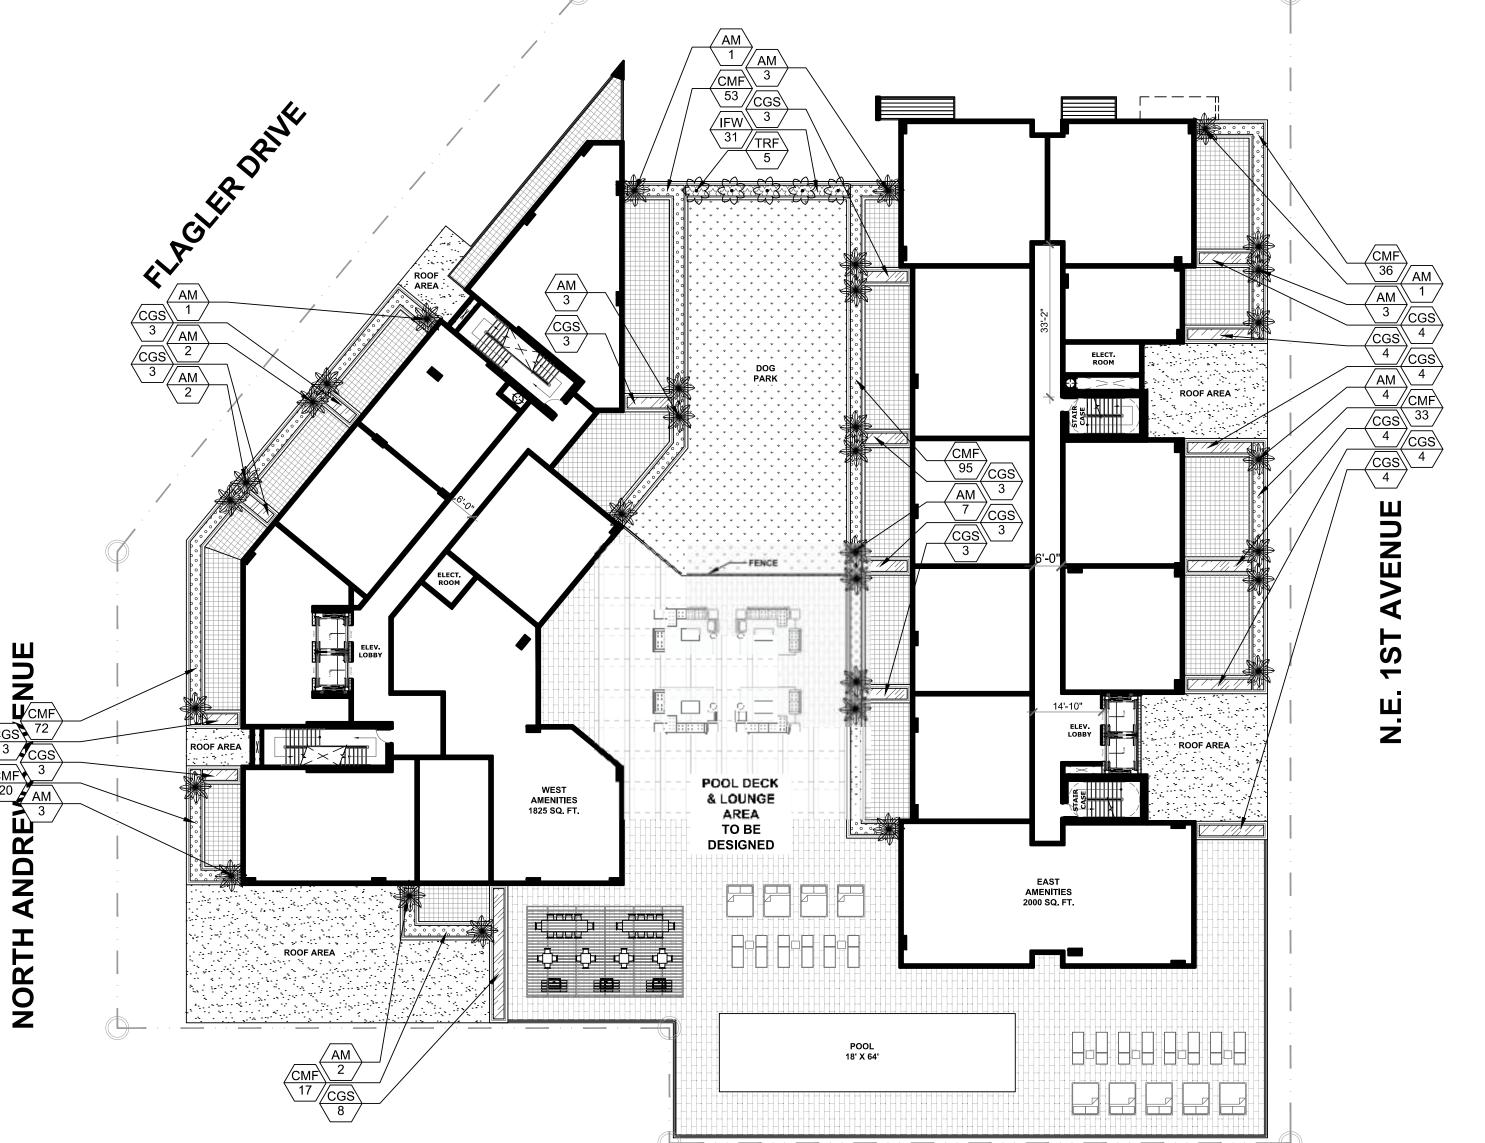
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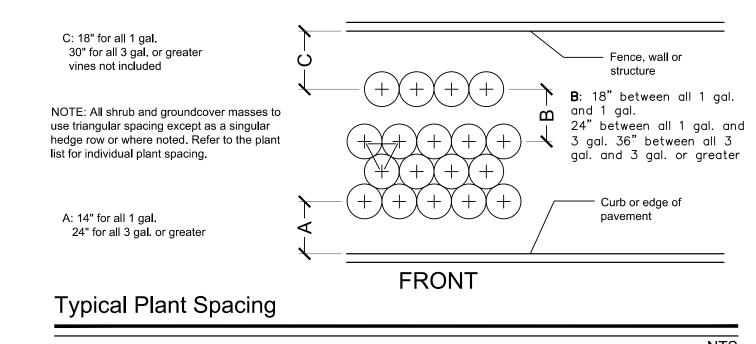
Sheet 2 OF 4

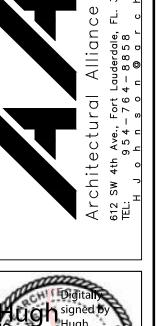





N.E. 7TH STREET







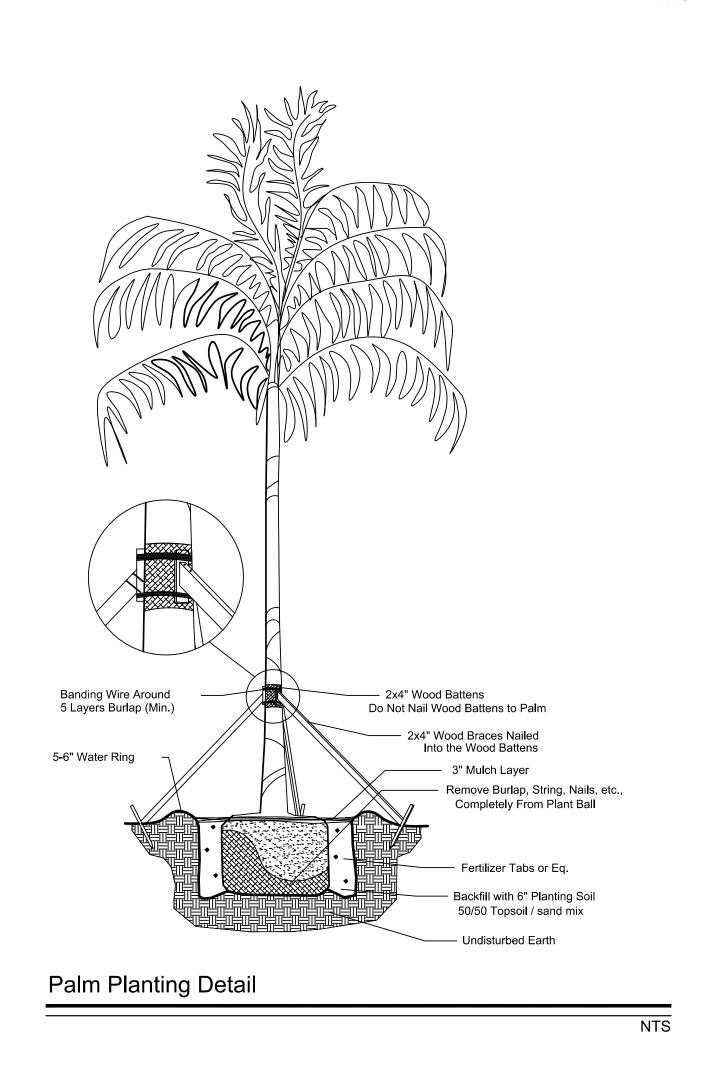


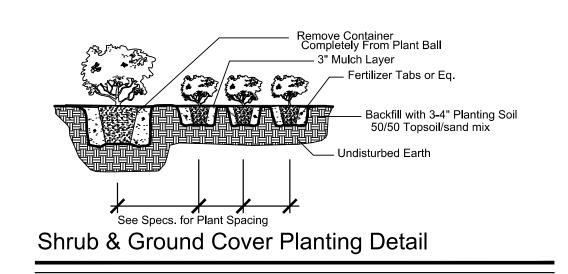

PLANT SCH	HEDU	JLE 2310 POOL DECK								
PALMS & CYCADS	QTY	BOTANICAL NAME	COMMON NAME	CONT	CALIPER	SIZE	NATIVE	DROUGHT		REMARKS
AM	32	ADONIDIA MERRILLII	MANILA PALM	-		5` O.A	NO	HIGH		
TRF	5	THRINAX RADIATA	FLORIDA THATCH PALM	-	SPECIMEN	6" O.A.	YES	HIGH		
SHRUB AREAS	QTY	BOTANICAL NAME	COMMON NAME	CONT	CALIPER	SIZE	NATIVE	DROUGHT	SPACING	REMARKS
CMF	326	CARMONA MICROPHYLLA	FUKIEN TEA	-		14" HT X 16" SPR	NO	HIGH	24" o.c.	
CGS	59	CLUSIA GUTTIFERA	SMALL-LEAF CLUSIA	-		48" HT. X 36" SPR.	YES	HIGH	36" o.c.	
IFW	31	IXORA COCCINEA 'FRANKIE HIPP'	WHITE NORA GRANT IXORA	-		20" HT. X 20" SPR.	NO	MEDIUM	20" o.c.	

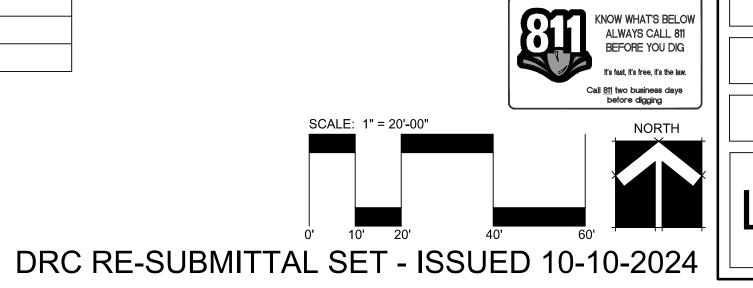

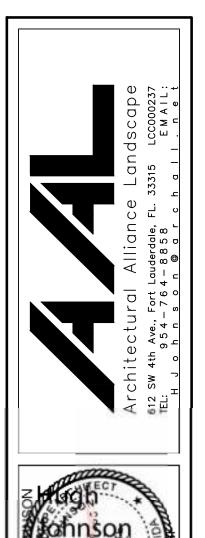

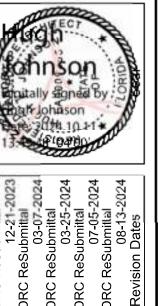

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BRC SUBMITTAL SET

650 N. ANDREWS AVE.

FORT LAUDERDALE, FLORIDA

6 DRC Resubmittal
10-10-1

Sheet Description

POOL DECK
LANDSCAPE
PLAN

Release Date


Project Number 2310


Drawing Number

Drawing Number

L-213

Sheet 4 OF 4

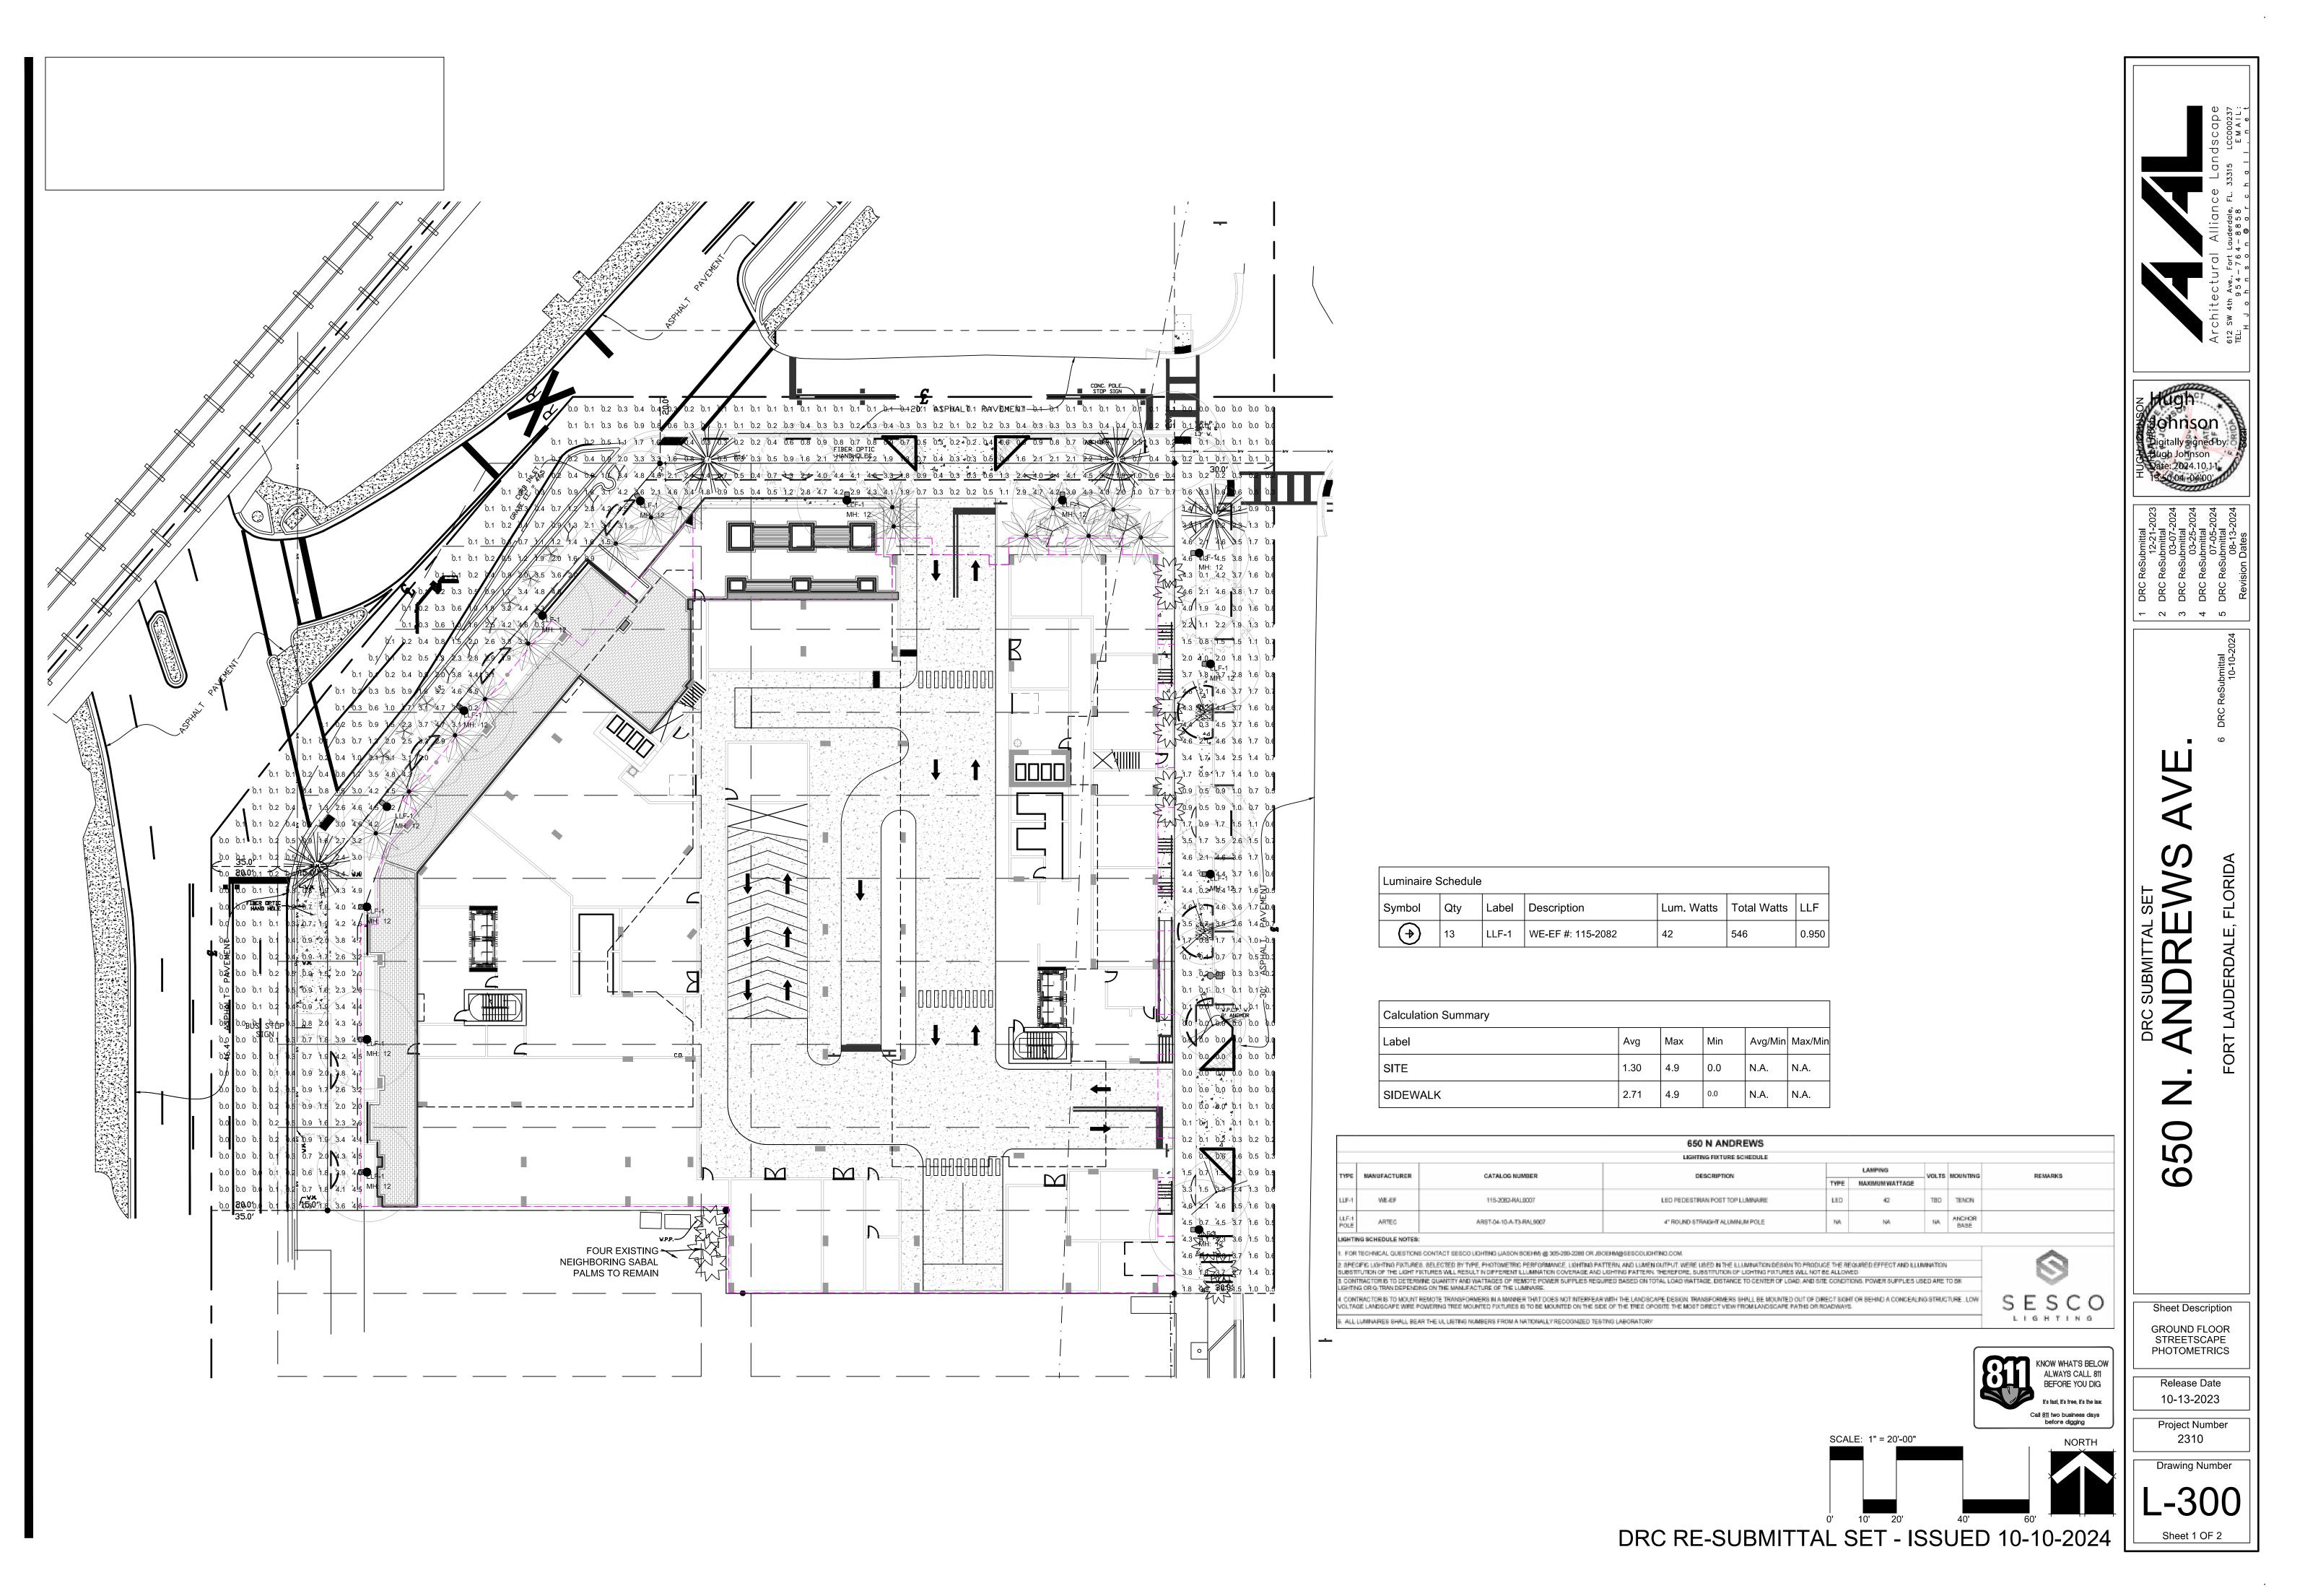

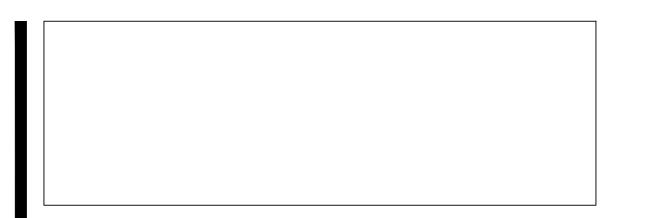

	650 N ANDREWS									
	LIGHTING FIXTURE SCHEDULE									
TYPE MANUFACTURER CATALOG NUMBER DESCRIPTION							MOUNTING	REMARKS		
	MANOPAGIONEN	OATAEOG HOMBEN	ON INCOMPEN		MAXIMUM WATTAGE	VOLIG	mooning	Nemanna		
LLF-1	WE-EF	115-2082-RAL9007	LED PEDESTIRAN POST TOP LUMINAIRE	LED	42	TBD	TENON			
LLF-1 POLE	ARTEC	ARST-04-10-A-T3-RAL9007	4" ROUND STRAIGHT ALUMINUM POLE	NA	NA	NA	ANCHOR BASE			

LIGHTING SCHEDULE NOTES:


. FOR TECHNICAL QUESTIONS CONTACT SESCO LIGHTING (JASON BOEHM) @ 305-299-2288 OR JBOEHM@SESCOLIGHTING.COM.

2. SPECIFIC LIGHTING FIXTURES, SELECTED BY TYPE, PHOTOMETRIC PERFORMANCE, LIGHTING PATTERN, AND LUMEN OUTPUT, WERE USED IN THE ILLUMINATION DESIGN TO PRODUCE THE REQUIRED EFFECT AND ILLUMINATION. SUBSTITUTION OF THE LIGHT FIXTURES WILL RESULT IN DIFFERENT ILLUMINATION COVERAGE AND LIGHTING PATTERN. THEREFORE, SUBSTITUTION OF LIGHTING FIXTURES WILL NOT BE ALLOWED. 3. CONTRACTOR IS TO DETERMINE QUANTITY AND WATTAGES OF REMOTE POWER SUPPLIES REQUIRED BASED ON TOTAL LOAD WATTAGE, DISTANCE TO CENTER OF LOAD, AND SITE CONDITIONS. POWER SUPPLIES USED ARE TO BK LIGHTING OR Q-TRAN DEPENDING ON THE MANUFACTURE OF THE LUMINAIRE.

4. CONTRACTOR IS TO MOUNT REMOTE TRANSFORMERS IN A MANNER THAT DOES NOT INTERFEAR WITH THE LANDSCAPE DESIGN, TRANSFORMERS SHALL BE MOUNTED OUT OF DIRECT SIGHT OR BEHIND A CONCEALING STRUCTURE. LOW VOLTAGE LANDSCAPE WIRE POWERING TREE MOUNTED FIXTURES IS TO BE MOUNTED ON THE SIDE OF THE TREE OPOSITE THE MOST DIRECT VIEW FROM LANDSCAPE PATHS OR ROADWAYS.

5. ALL LUMINAIRES SHALL BEAR THE UL LISTING NUMBERS FROM A NATIONALLY RECOGNIZED TESTING LABORATORY



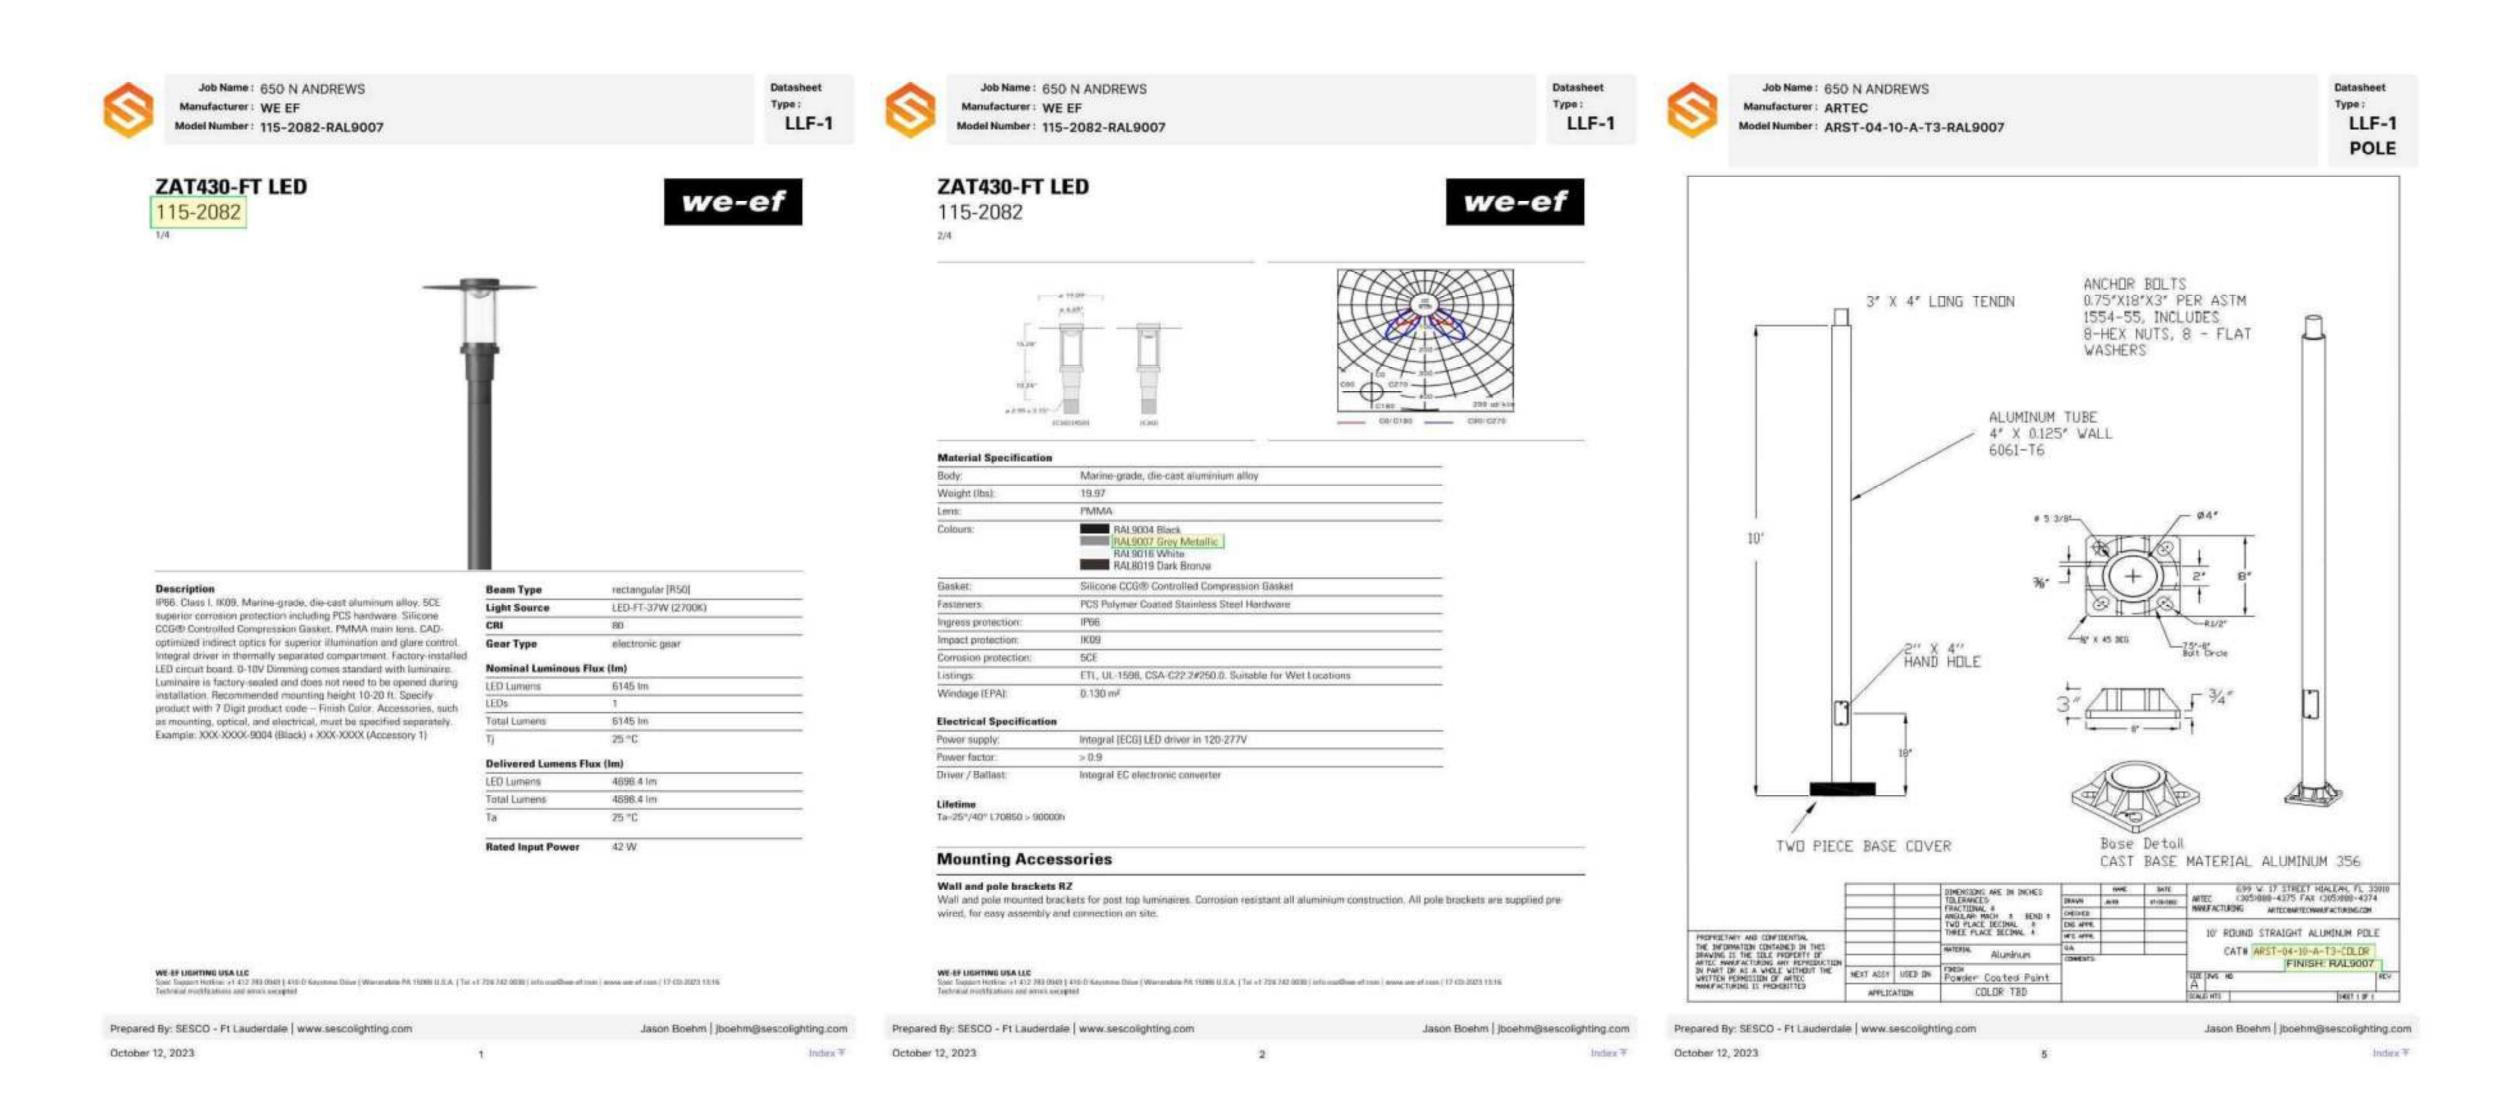

KNOW WHAT'S BELOW ALWAYS CALL 811 BEFORE YOU DIG It's fast, It's free, it's the law Call 811 two business days

DRC RE-SUBMITTAL SET - ISSUED 10-10-2024



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Sheet Description STREETSCAPE LIGHTING

SPECIFICATION Release Date

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10-13-2023 Project Number

2310 Drawing Number