

FORT LAUDERDALE POLICE HEADQUARTERS PZB SUBMITTAL

1300 W BROWARD BLVD, FT. LAUDERDALE, FL 33312

LAND DESCRIPTION:

LEGAL DESCRIPTI

LL OF BLOCKS 117, 118, 125; AND THE 10 FOOT ALLEYS WITHIN SAID BLOCKS; AND THAT PORTION OF FLORIDA STREET (S.W. t STREET) AND NORTH 3rd STREET (S.W. 2nd STREET) LYING BETWEEN SAID BLOCKS, PER WAVERLY PLACE, ACCORDING TO HE PLAT THEREOF, AS RECORDED IN PLAT BOOK 2, PAGE 19 OF THE PUBLIC RECORDS OF DADE COUNTY, FLORIDA; AND SESS THEREOF THE RIGHT-OF-WAY FOR WEST BROWARD BOULEVARD AS SHOWN ON STATE OF FLORIDA STATE ROAD SEPARTMENT RIGHT OF WAY MAP OF STATE ROAD NO. 842, SECTION 86006-2501, DATED 7-15-1971.

TOGETHER WIT

THE NORTH 855.00 FEET OF LOT 7, THE NORTH 900.00 FEET OF LOT 8, AND THE NORTH 850.00 FEET OF LOT 9, W.C. VALENTINES SUBDIVISION, ACCORDING TO THE PLAT THEREOF, AS RECORDED IN PLAT BOOK B, PAGE 29 OF THE PUBLIC RECORDS OF DADE COUNTY, FLORIDA; AND LESS THEREOF THE RIGHT-OF-WAY FOR WEST BROWARD BOULEVARD AS SHOWN ON STATE OF FLORIDA STATE ROAD DEPARTMENT RIGHT OF WAY MAP OF STATE ROAD NO. 842, SECTION 86006-250 DATED 7-15-1971.

ALL OF THE ABOVE BEING MORE PARTICULARLY DESCRIBED AS FOLLOWS:

BEGINNING AT THE SOUTHEAST CORNER OF SAID BLOCK 117, WAVERLY PLACE; THENCE SOUTH 88°00'53" WEST ALONG THE SOUTH LINE OF SAID BLOCK 117, A DISTANCE OF 350.79 FEET TO A POINT ON THE WEST LINE OF SAID BLOCK 117 AND A POINT ON THE EAST LINE OF SAID LOT 9, W.C. VALENTINES SUBDIVISION: THENCE NORTH 01°57'46" WEST ALONG SAID EAST LINE OF LOT 9, A DISTANCE OF 10.00 FEET; THENCE SOUTH 88°00'53" WEST ALONG THE SOUTH LINE OF THE NORTH 850.00 FEET OF SAID LOT 9, A DISTANCE OF 209.00 FEET TO A POINT ON THE EAST LINE OF SAID LOT 8, W.C. VALENTINES SUBDIVISION; THENCE SOUTH 01°57'46" EAST ALONG SAID EAST LINE, A DISTANCE OF 50.00 FEET TO A POINT ON THE SOUTH LINE OF THE NORTH 900.00 FEET OF SAID LOT 8; THENCE SOUTH 88°00'53" WEST ALONG SAID SOUTH LINE, A DISTANCE OF 209.00 FEET TO A POINT ON THE EAST LINE OF SAID LOT 7, W.C. VALENTINES SUBDIVISION; THENCE NORTH 01°57'46" WEST ALONG SAID EAST LINE, A DISTANCE OF 45.00 FEET TO A POINT ON THE SOUTH LINE OF THE NORTH 855.00 FEET OF SAID LOT 7; THENCE SOUTH 88°00'53" WEST ALONG SAID SOUTH LINE, A DISTANCE OF 188.26 FEET TO A POINT ON A LINE 20.00 FEET EAST OF AND PARALLEL WITH THE WEST LINE OF SAID LOT 7; THENCE NORTH 02°05'07" WEST ALONG SAID PARALLEL LINE, A DISTANCE OF 795.91 FEET; THENCE NORTH 88°01'11" EAST, A DISTANCE 5.00 FEET; THENCE NORTH 42°57'35" EAST, A DISTANCE OF 34.68 FEET TO A POINT ON THE SOUTH RIGHT-OF-WAY LINE OF WEST BROWARD BOULEVARD, AS SHOWN ON SAID RIGHT OF WAY MAP SECTION 86006-2501; THENCE EASTERLY ALONG SAID SOUTH RIGHT-OF-WAY LINE THE FOLLOWING NINE (9) COURSES AND DISTANCES; THENCE NORTH 88°01'11" EAST, A DISTANCE OF 150.97 FEET TO A POINT OF CURVATURE CONCAVE TO THE SOUTHWEST, HAVING A RADIUS OF 9.50 FEET; THENCE SOUTHEASTERLY ALONG SAID CURVE THROUGH A CENTRAL ANGLE OF 90°00'00", FOR A DISTANCE OF 14.92 FEET TO A POINT OF TANGENCY AND A POINT ON THE EAST LINE OF SAID LOT 7, W.C. VALENTINES SUBDIVISION; THENCE SOUTH 01°58'49" EAST, A DISTANCE OF 4.50 FEET; THENCE NORTH 88°01'11" EAST, A DISTANCE OF 44.50 FEET; THENCE NORTH 01°58'49" WEST, A DISTANCE OF 3.00 FEET; THENCE NORTH 88°01'11" EAST, A DISTANCE OF 60.00 FEET TO A POINT OF CURVATURE CONCAVE TO THE NORTHWEST, HAVING A RADIUS OF 107.00 FEET; THENCE EASTERLY AND NORTHEASTERLY ALONG SAID CURVE THROUGH A CENTRAL ANGLE OF 19°05'28", FOR A DISTANCE OF 35.65 FEET TO A POINT OF REVERSE CURVATURE OF A CURVE HAVING A RADIUS OF 93.00 FEET; THENCE NORTHEASTERLY AND EASTERLY ALONG SAID CURVE THROUGH A CENTRAL ANGLE OF 19°05'28", FOR A DISTANCE OF 30.99 FEET TO A POINT OF TANGENCY; THENCE NORTH 88°01;11" EAST, FOR A DISTANCE OF 597.64 FEET TO THE TERMINATION OF SAID NINE (9) COURSES AND DISTANCES AND A POINT ON THE EAST LINE OF SAID BLOCK 125, WAVERLY PLACE; THENCE SOUTH 02°02'58" EAST ALONG SAID EAST LINE AND THE EXTENTION THEREOF, FOR A DISTANCE OF 825.37 FEET TO THE POINT OF BEGINNING.

SAID LANDS SITUATE, LYING AND BEING IN THE CITY OF FORT LAUDERDALE, BROWARD COUNTY, FLORIDA, AND CONTAINING 793,409 SQUARE FEET OR 18.21 ACRES, MORE OR LESS.

FEMA FLOOD ZONE:

THE PROPERTY IS LOCATED WITHIN FLOOD ZONE X WITH A BASE FLOOD ELEVATION OF N/A FEET, AS SHOWN ON F.I.R.M. NUM. 12011C0556J, BEARING A MAP EFFECTIVE DATE OF 12/31/2019.

THESE PLANS MAY HAVE BEEN
REDUCED IN SIZE BY REPRODUCTION
THIS MUST BE CONSIDERED WHEN
OBTAINING SCALED DATA.





SECTION 09, TOWNSHIP 50 S, RANGE 42 E FOLIO #504209010070

PREPARED FOR:
AECOM
2 ALHAMBRA PLAZA, SUITE 900
CORAL GABLES, FL 33134

INDEX OF SHEETS			
SHEET No.	SHEET TITLE		
	COVER SHEET		
S1-S9	SURVEY		
EX-101	SITE IMAGES		
SP-100-SP-105	SITE PLANS		
SP-501	VEHICLE CIRCULATION PLAN		
	ARCHITECTURAL PLANS		
HQ-A1-1-01	ARCHITECTURAL SITE PLAN - OVERALL		
HQ-A1-4-20	HEADQUARTER BLDG - LIFE SAFETY PLAN LEVEL 2		
HQ-A2-2-01 -2-03	HEADQUARTERS BLDG - FLOOR PLAN LEVEL 1 - 3 OVERALL		
HQ-A2-2-04	HEADQUARTERS BLDG - ROOF PLAN - OVERALL		
HQ-A3-2-00	HEADQUARTERS BLDG - BUILDING ELEVATIONS - OVERALL		
HQ-A3-2-01 - 2-11	HQ BLDG - BUILDING ELEVATIONS - ENLARGED		
HQ-A5-4-04	HQ BLDG - DETAILS - MISCELLANEOUS		
HQ-A8-1-01 - 1-03	HQ BLDG - RENDERINGS		
HQ-A8-1-04-1-05	HQ BLDG - GREEN SCREEN AND MATERIALS BOARD		
PG-A2-2-01	PARKING GARAGE - FLOOR PLAN LEVEL 1 - OVERALL		
PG-A2-2-01	PARKING GARAGE - FLOOR PLAN LEVEL 2 - OVERALL		
PG-A2-2-03	PARKING GARAGE - FLOOR PLAN LEVEL 3 - OVERALL		
PG-A3-1-01 - 1-02	OVERALL BUILDING ELEVATIONS		
PG-A3-1-01 - 1-02	WALL SECTIONS		
r G-A0-4-01 - 4-02	WALL SECTIONS		
	CIVIL PLANS		
GI-001	LEGEND AND ABBREVIATIONS		
GI-001 GI-002	GENERAL CONSTRUCTION NOTES		
GI-002 GI-003	CONSTRUCTION NOTES CONSTRUCTION SPECIFICATIONS		
CD-000-CD-105			
CG-000-CG-105	EROSION CONTROL PLANS		
CG-501	EROSION CONTROL DETAILS BAVING CRADING AND DRAINAGE BLANS		
CP-000-CP-105	PAVING, GRADING, AND DRAINAGE PLANS		
CP-301-CP-303	PAVING, GRADING, AND DRAINAGE SECTIONS		
CP-501-CP-506	PAVING, GRADING, AND DRAINAGE DETAILS		
CU-000-CU-105	WATER AND SEWER PLANS		
CU-501-CU-505	WATER AND SEWER DETAILS		
CM-000-CM-105	PAVEMENT MARKING AND SIGNAGE PLAN		
	LANDSCAPE PLANS		
LC-100	OVERALL REFERENCE PLAN		
LC-101	ILLUSTRATIVE SITE PLAN		
LD-001	TREE DISPOSITION LIST		
LD-101	TREE DISPOSITION PLANS		
LH 100-105	HARDSCAPE PLANS		
	HARDSCAPE DETAILS		
I H 501-504			
LH 501-504	PLANTING NOTES AND SCHEDULE		
LP 001-002	PLANTING NOTES AND SCHEDULE LANDSCAPE PLANS (CANOPY)		
LP 001-002 LP 101-105	LANDSCAPE PLANS (CANOPY)		
LP 001-002 LP 101-105 LP 201-205	LANDSCAPE PLANS (CANOPY) LANDSCAPE PLAN (UNDERSTORY)		
LP 001-002 LP 101-105 LP 201-205 LP-501	LANDSCAPE PLANS (CANOPY) LANDSCAPE PLAN (UNDERSTORY) PLANTING DETAILS		
LP 001-002 LP 101-105 LP 201-205 LP-501 LI 101-105	LANDSCAPE PLANS (CANOPY) LANDSCAPE PLAN (UNDERSTORY) PLANTING DETAILS IRRIGATION PLAN		
LP 001-002 LP 101-105 LP 201-205 LP-501	LANDSCAPE PLANS (CANOPY) LANDSCAPE PLAN (UNDERSTORY) PLANTING DETAILS		

NDEY OF SHEETS

PERMITTING AGENCIES	PERMIT NO.	EXPIRES
CITY OF XXXXX	XXXXXXXXX	XX/XX/XX
BROWARD COUNTY XXXXX		



THOMAS F. DONAHUE, P.E. FLORIDA REG. NO. 60529 (FOR THE FIRM)

PROJECT No. 11112.00 04/11/2022

METAL POST METAL SIGN POST MONITORING WELL NATURAL GAS WITNESS POST PALM TREE (SEE TREE TABLE) PEDESTRIAN CROSSING SIGNAL SANITARY CLEAN OUT SANITARY SEWER MAINTENANCE ACCESS STRUCTURE SANITARY VALVE COVER STREET LIGHT HANDHOLE STORAGE TANK TELEPHONE CABINET TELEPHONE HANDHOLE TELEPHONE MAINTENANCE ACCESS STRUCTURE TRAFFIC CONTROL ARM TRAFFIC HANDHOLE TRANSFORMER TRASH CAN TREE (SEE TREE TABLE) TREE (SEE TREE TABLE) **UNKNOWN BOX** UNKNOWN CABINET UNKNOWN HANDHOLE UNKNOWN MAINTENANCE ACCESS STRUCTURE UNKNOWN TREE UNKNOWN VALVE COVER UNKNOWN VAULT WATER FOUNTAIN WATER METER WATER VALVE COVER WHEEL CHAIR ACCESS PAINT MARK WOOD LIGHT POLE WOOD SIGN POST

WOOD UTILITY POLE


VACUUM


YARD DRAIN

ABBREVIATIONS B.C.R. BROWARD COUNTY RECORDS BLDG. BUILDING CATCH BASIN CI CURB INLET C&G CURB AND GUTTER CONC. CONCRETE CONCRETE BLOCK STRUCTURE CBS CB CATCH BASIN CHAIN LINK FENCE CORRUGATED METAL PIPE D.C.R. DADE COUNTY RECORDS DUCTILE IRON PIPE DETWARN DETECTABLE WARNING SURFACE ELEC. ELECTRIC ELEV. ELEVATION F.D.O.T. FLORIDA DEPARTMENT OF TRANSPORTATION F.S.R.D. FLORIDA STATE ROAD DEPARTMENT IDENTIFICATION INCHES ARC LENGTH (CURVE DATA) FLORIDA LICENSED BUSINESS NUMBER MAG MAGNETIC STORM DRAINAGE MAINTENANCE ACCESS STRUCTURE SANITARY SEWER MAINTENANCE ACCESS STRUCTURE MIAMI-DADE COUNTY RECORDS METAL FENCE NORTH AMERICAN VERTICAL DATUM OF 1988 OFFICIAL RECORDS BOOK PG. **PAGE** P.B. PLAT BOOK PARKER KALON P.O.B. POINT OF BEGINNING POLYVINYL CHLORIDE PIPE RADIUS (CURVE DATA) REINFORCED CONCRETE PIPE RIGHT-OF-WAY TOP OF PIPE TYPICAL UNABLE TO DETERMINE WOOD FENCE

DELTA/CENTRAL ANGLE (CURVE DATA)

LINE TYPES

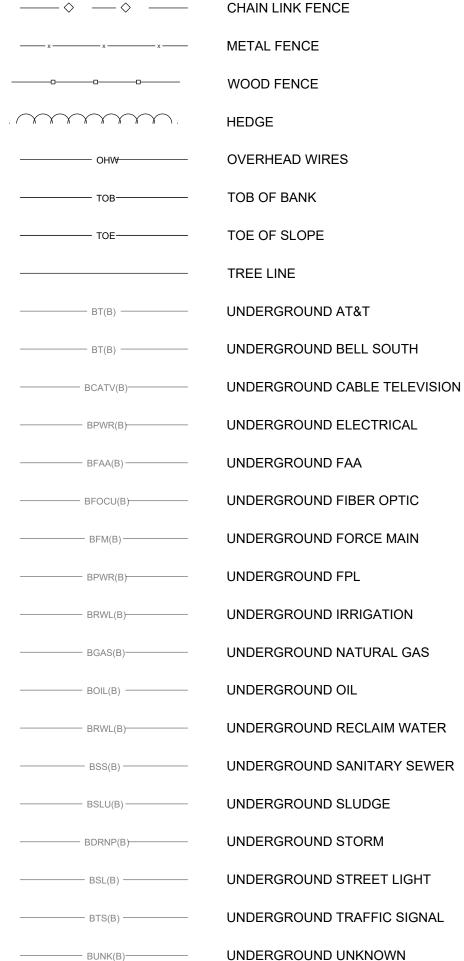

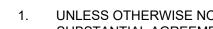

SURVEY NOTES:

1. UNLESS OTHERWISE NOTED, RECORD VALUES AND FIELD MEASURED VALUES ARE IN SUBSTANTIAL AGREEMENT.

LOCATION SKETCH (NOT TO SCALE)

BROWARD BLVD.

NOT VALID WITHOUT THE ORIGINAL SIGNATURE AND SEAL OR AN ENCRYPTED DIGITAL SIGNATURE OF A FLORIDA PROFESSIONAL SURVEYOR AND MAPPER.

Elementary School

DORSEY RIVERBEND

- 3. IT IS A VIOLATION OF THE STANDARDS OF PRACTICE RULE 5J-17 OF THE FLORIDA ADMINISTRATIVE CODE TO ALTER THIS SURVEY WITHOUT THE EXPRESS PRIOR WRITTEN CONSENT OF THE SURVEYOR. ADDITIONS AND/OR DELETIONS MADE TO THE FACE OF
- 4. LANDS SHOWN HEREON WERE NOT ABSTRACTED FOR RIGHTS OF WAY, EASEMENTS, OWNERSHIP, OR OTHER INSTRUMENTS OF RECORD.
- 5. OTHER THAN AS SHOWN, THERE IS NO EVIDENCE THAT UNDERGROUND ENCROACHMENTS EXIST. HOWEVER, A SUBSURFACE INVESTIGATION WAS NOT PERFORMED TO DETERMINE IF UNDERGROUND ENCROACHMENTS DO EXIST.
- THIS SURVEY DOES NOT IDENTIFY THE LIMITS OR EXTENTS OF POTENTIAL JURISDICTIONAL BOUNDARIES.

THIS SURVEY WILL MAKE THIS SURVEY INVALID.


- 7. THE OWNERSHIP OF FENCES, PERIMETER WALLS AND/OR HEDGES SHOWN HEREON ARE NOT KNOWN AND THUS ARE NOT LISTED AS ENCROACHMENTS. FENCES, HEDGES AND/OR PERIMETER WALLS ARE SHOWN IN THEIR RELATIVE POSITION TO THE BOUNDARY.
- 8. FEATURES AND LINE WORK SHOWN HEREON ARE REFERENCED TO THE NORTH AMERICAN HORIZONTAL DATUM OF 1983 WITH THE 2011 ADJUSTMENT APPLIED (NAD 83/11), TRANSVERSE MERCATOR, FLORIDA EAST ZONE.
- ELEVATIONS SHOWN HEREON ARE BASED ON THE NORTH AMERICAN VERTICAL DATUM OF 1988 (NAVD88). SAID ELEVATIONS ARE BASED THE CITY OF FORT LAUDERDALE BENCHMARKS "45 NW" AND "153 NW". "45 NW" IS A PARKER KALON NAIL AND BRASS DISC STAMPED "CITY OF FT LAUD BM NW 45". IN THE TOP OF CURB 12 FEET WEST OF THE CENTERLINE OF NW 15 AVENUE, & 36 FEET NORTH OF THE CENTERLINE OF NW 3 STREET. ELEVATION=5.662' (NGVD 1929). "153 NW" IS A PARKER KALON NAIL AND BRASS DISC STAMPED "CITY OF FT LAUD BM NW 153" IN A CONCRETE APRON AT END OF PAVER SIDEWALK, 23 FEET WEST OF THE CENTERLINE OF NW 15 AVENUE AND 35 FEET NORTH OF THE CENTERLINE OF NW 1 STREET. ELEVATION=5.399'(NGVD 1929) . THE ELEVATION OF "45 NW" WAS CONVERTED TO 4.085 FEET(NAVD88) AND THE ELEVATION OF "153 NW" WAS CONVERTED TO 3.822 FEET (NAVD88) USING A NATIONAL GEODETIC SURVEY (NGS) COORDINATE AND TRANSFORMATION TOOL (NCAT) RESULTING IN A VERTCON FACTOR OF (-)1.577 FEET.
- 10. THE HORIZONTAL FEATURES SHOWN HEREON ARE PLOTTED TO WITHIN 1/20 OF THE MAP SCALE. HORIZONTAL FEATURE LOCATION IS TO THE CENTER OF THE SYMBOL AND MAY BE ALTERED FOR CLARITY. DISTANCES AND ELEVATIONS SHOWN HEREON ARE U.S. SURVEY FEET UNLESS OTHERWISE NOTED. THE EXPECTED HORIZONTAL ACCURACY OF THE INFORMATION SHOWN HEREON IS ±0.10'.
- 11. THE INTENDED DISPLAY SCALE FOR THIS SURVEY IS 1"= 20' OR SMALLER.
- 12. ALL MAPPED FEATURES AND ELEVATIONS SHOWN HEREON WERE OBTAINED BY KEITH AND ASSOCIATES FOR THE PURPOSE OF THIS SURVEY.
- 13. BEARINGS SHOWN HEREON ARE BASED ON AN ASSUMED BEARING ALONG THE MOST EASTERLY SOUTH RIGHT OF WAY LINE OF STATE ROAD 842 (BROWARD BOULEVARD), BEARING BEING NORTH 88°01'11" EAST.
- 14. ACCORDING TO THE NATIONAL FLOOD INSURANCE PROGRAM, FLOOD INSURANCE RATE MAP (FIRM) COMMUNITY PANEL NO. 12011C0556H EFFECTIVE DATE 8-18-2014, THIS PROPERTY LIES IN ZONE AH. BASE FLOOD ELEVATION 4' (NAVD88) AND ZONE X, NO BASE FLOOD ELEVATION. FLOOD ZONE LINES SHOWN HEREON WERE ESTABLISHED WITH GIS FILES SUPPLIED BY FEDERAL EMERGENCY MANAGEMENT AGENCY (FEMA).


I HEREBY CERTIFY THAT THE ATTACHED BOUNDARY AND TOPOGRAPHIC SURVEY OF THE HEREON DESCRIBED PROPERTY IS DEPICTED TO THE BEST OF MY KNOWLEDGE AND BELIEF AND THE INFORMATION AS SURVEYED UNDER MY DIRECTION ON JANUARY 12, 2021 MEETS THE STANDARDS OF PRACTICE RULE 5J-17 OF THE FLORIDA ADMINISTRATIVE CODE, PURSUANT TO SECTION 472.027, FLORIDA STATUTES, SUBJECT

KEITH & ASSOCIATES, INC.

DONALD A. SPICER PROFESSIONAL SURVEYOR AND MAPPER REGISTRATION No. 4677 STATE OF FLORIDA

TO THE QUALIFICATIONS NOTED HEREON.

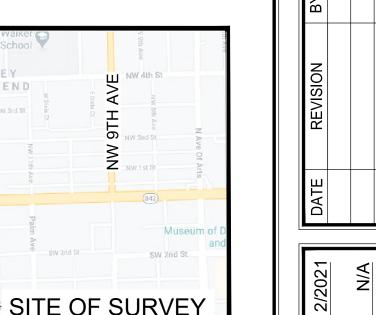

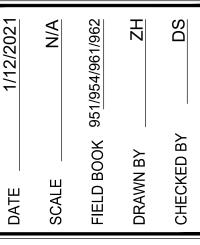



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SHEET 1 OF 9 PROJECT NUMBER 11112.00

[SHEET 1] Jan 19, 2021 2:41pm

LEGAL DESCRIPTION:

ALL OF BLOCKS 117, 118, 125; AND THE 10 FOOT ALLEYS WITHIN SAID BLOCKS; AND THAT PORTION OF FLORIDA STREET (S.W. 1st STREET) AND NORTH 3rd STREET (S.W. 2nd STREET) LYING BETWEEN SAID BLOCKS, PER WAVERLY PLACE, ACCORDING TO THE PLAT THEREOF, AS RECORDED IN PLAT BOOK 2, PAGE 19 OF THE PUBLIC RECORDS OF DADE COUNTY, FLORIDA; AND LESS THEREOF THE RIGHT-OF-WAY FOR WEST BROWARD BOULEVARD AS SHOWN ON STATE OF FLORIDA STATE ROAD DEPARTMENT RIGHT OF WAY MAP OF STATE ROAD NO. 842, SECTION 86006-2501, DATED 7-15-1971.

UNDERGROUND WATER

TOGETHER WITH:


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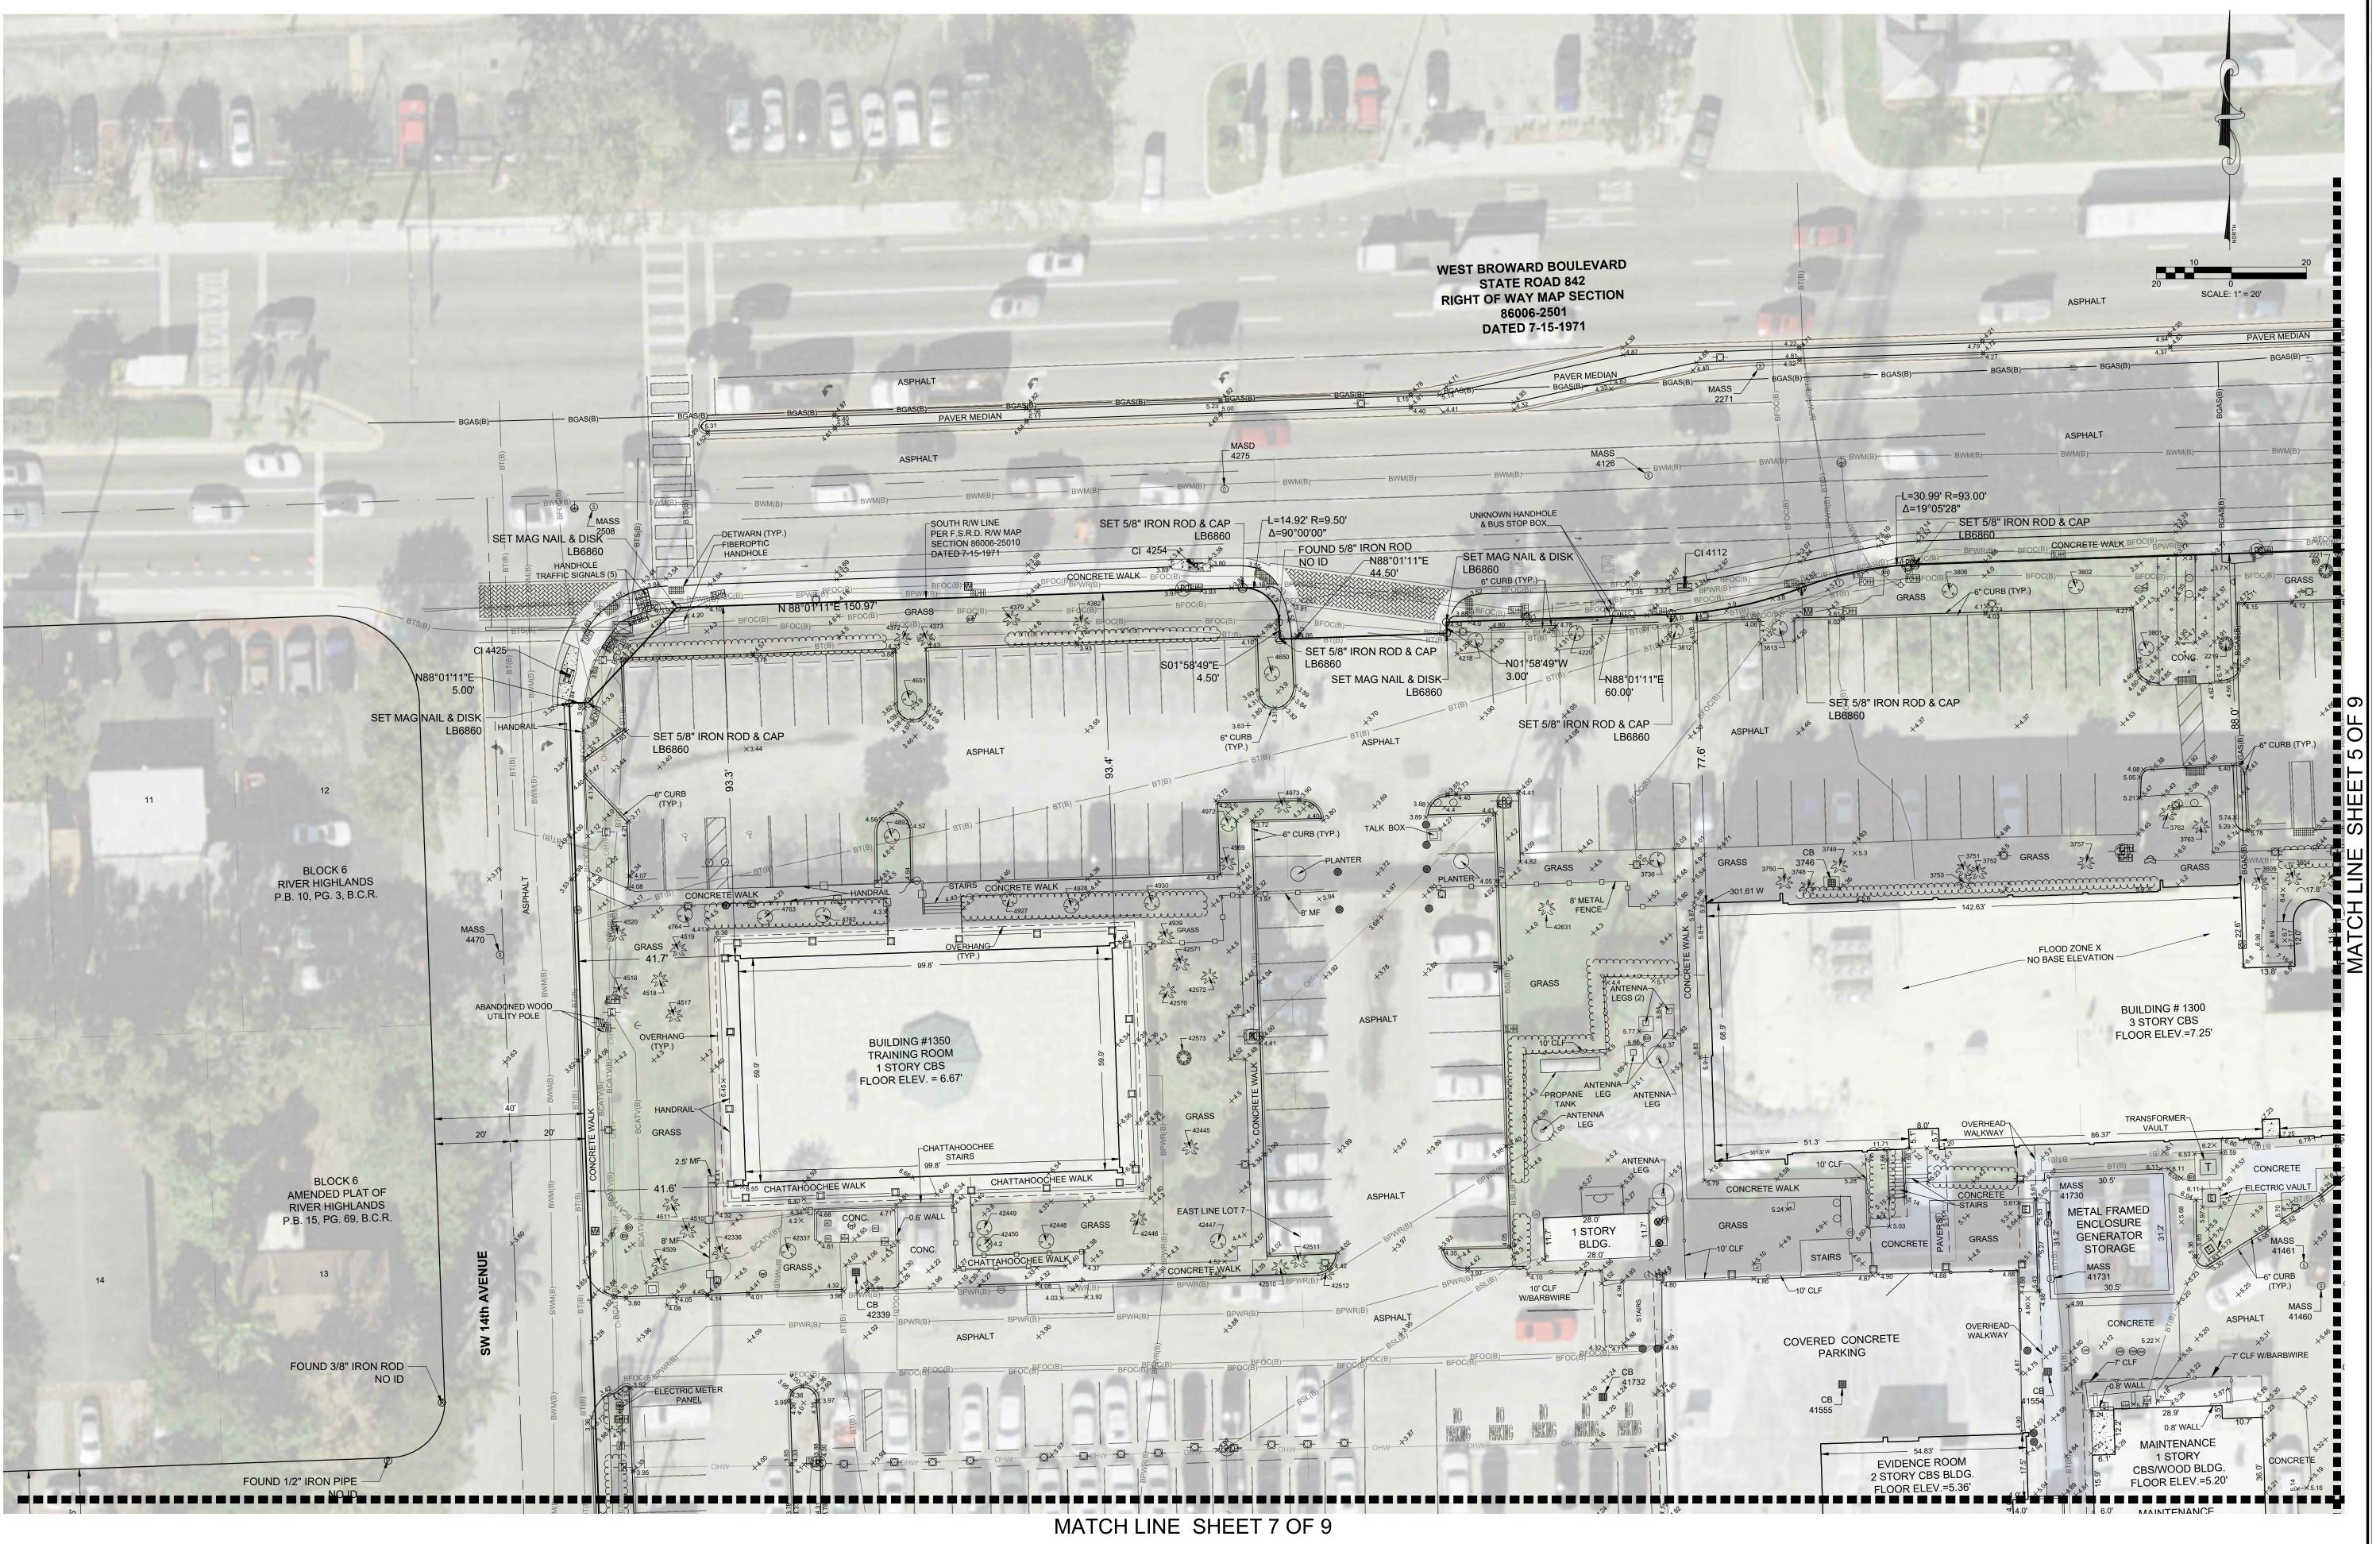
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Page 2 of 65






SHEET <u>3</u> OF <u>9</u> PROJECT NUMBER

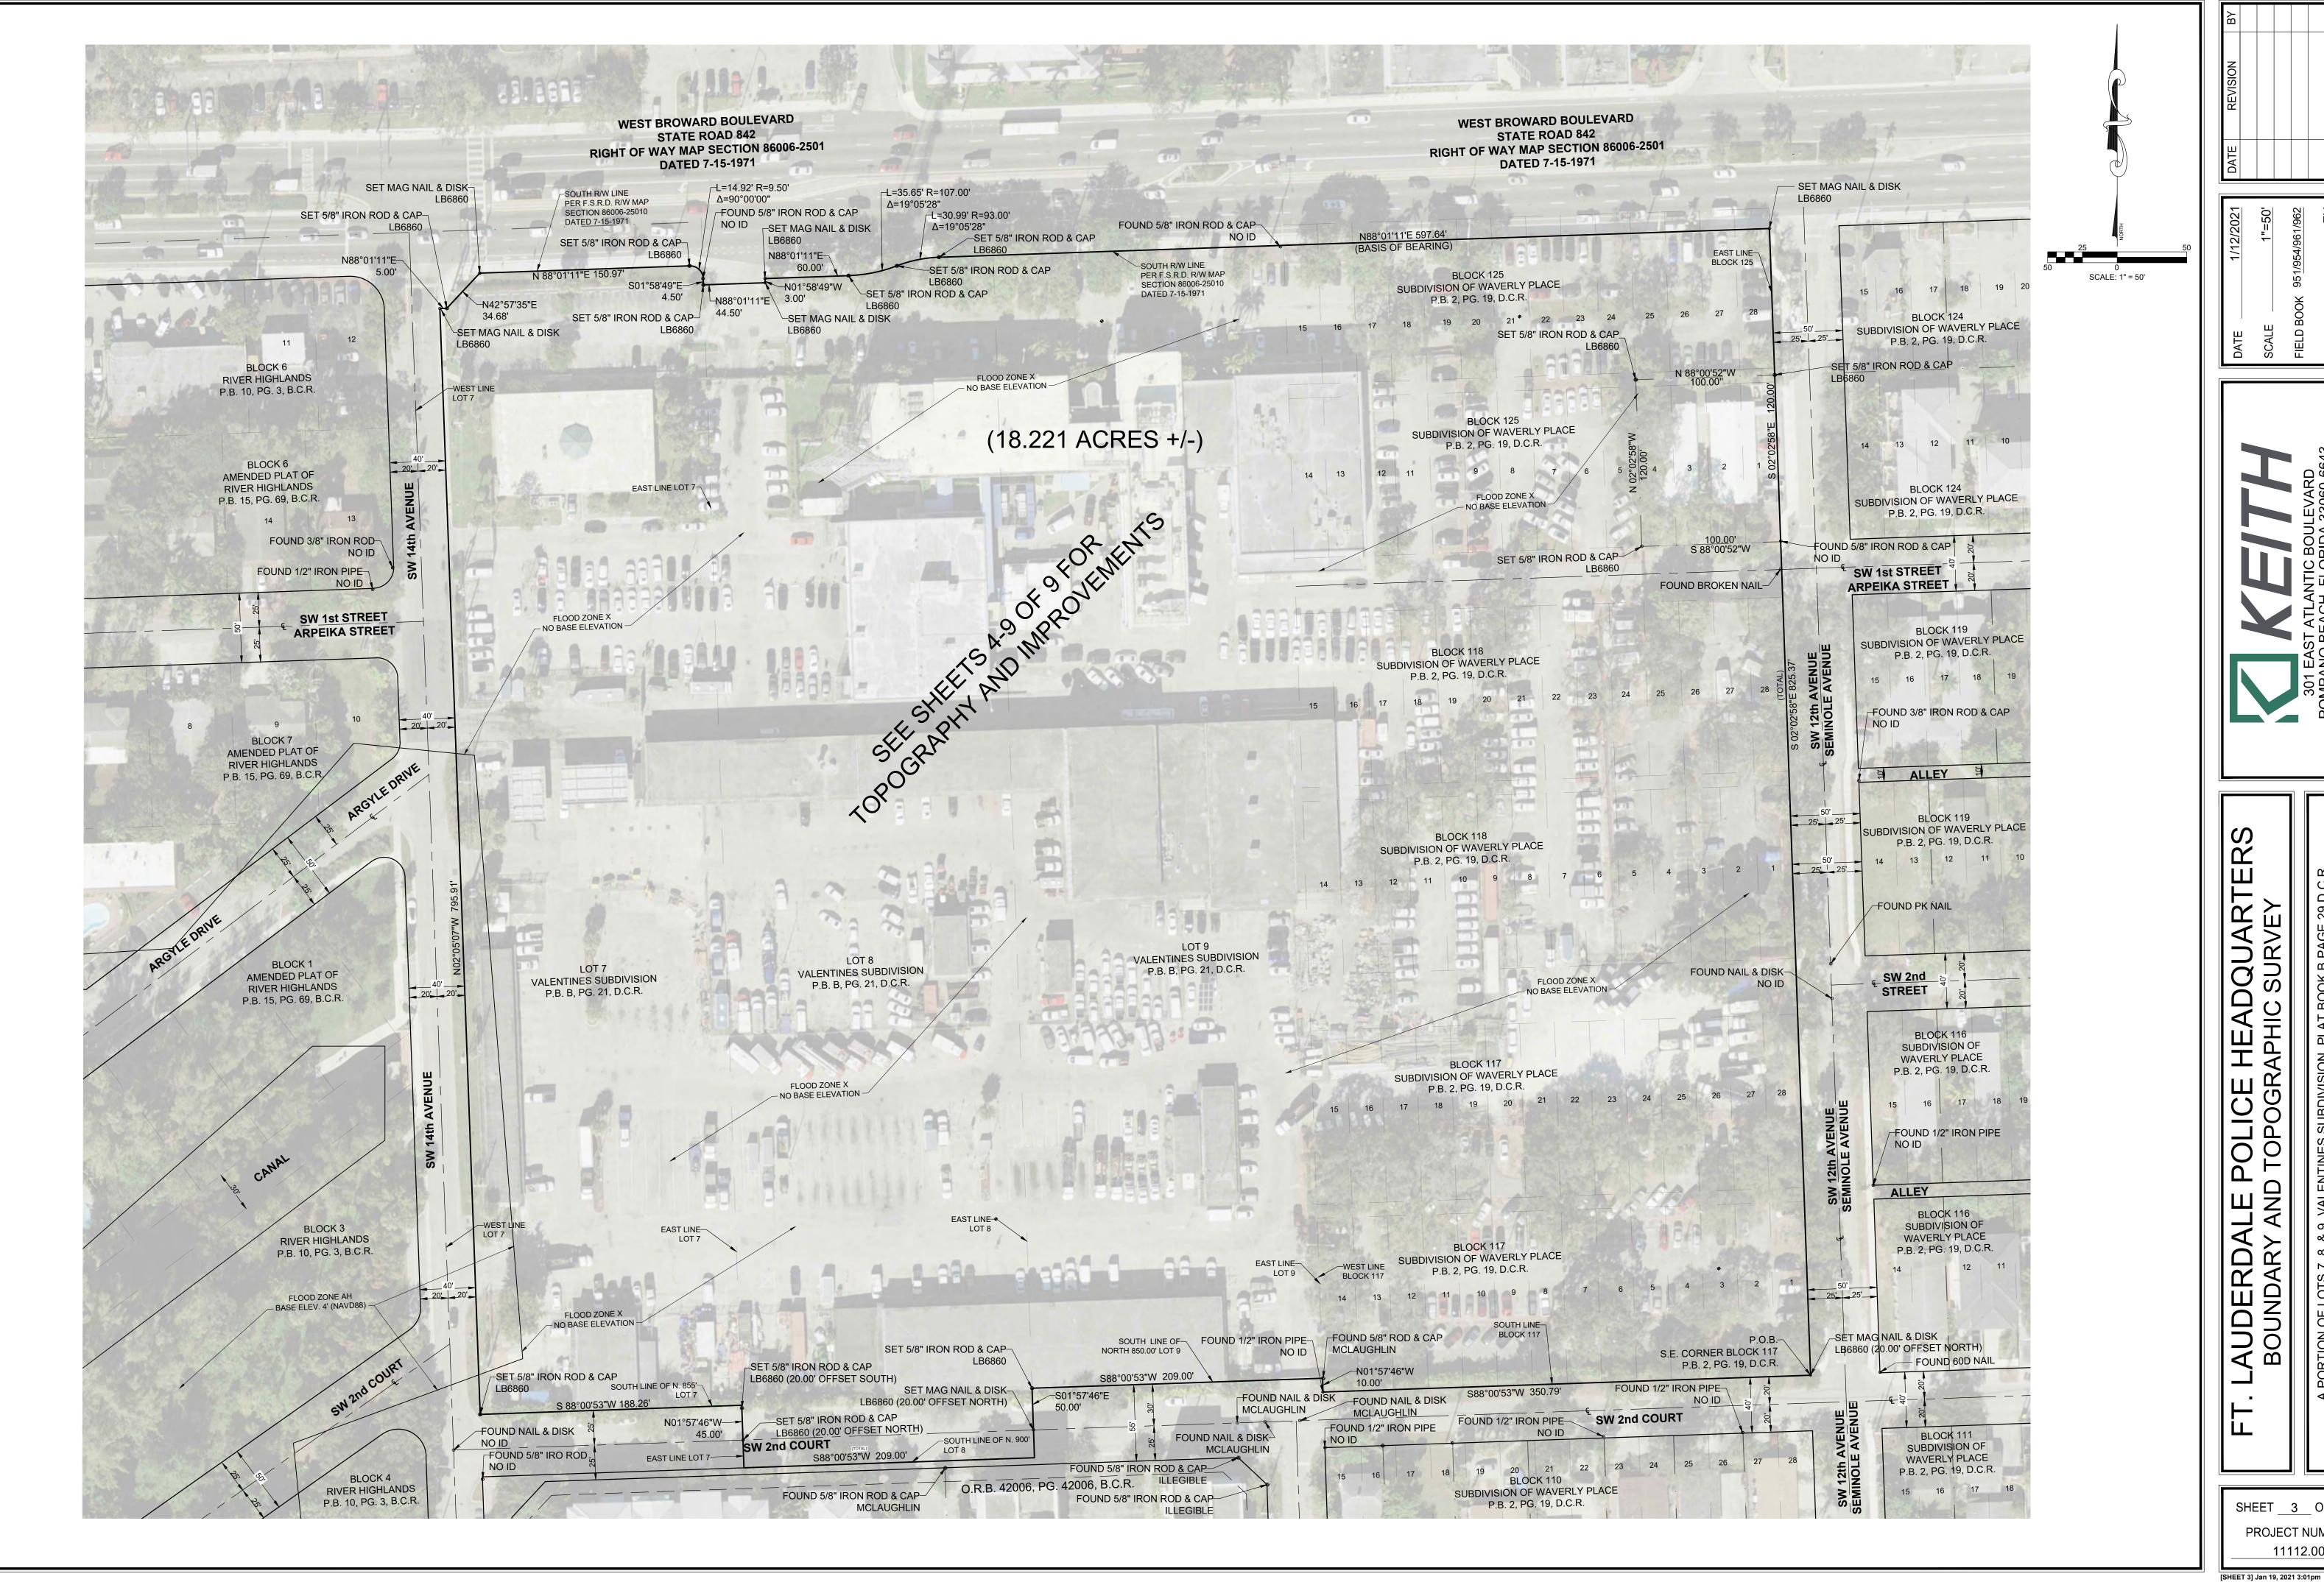

SHEET <u>4</u> OF <u>9</u> PROJECT NUMBER 11112.00

[SHEET 4] Jan 19, 2021 2:45pm

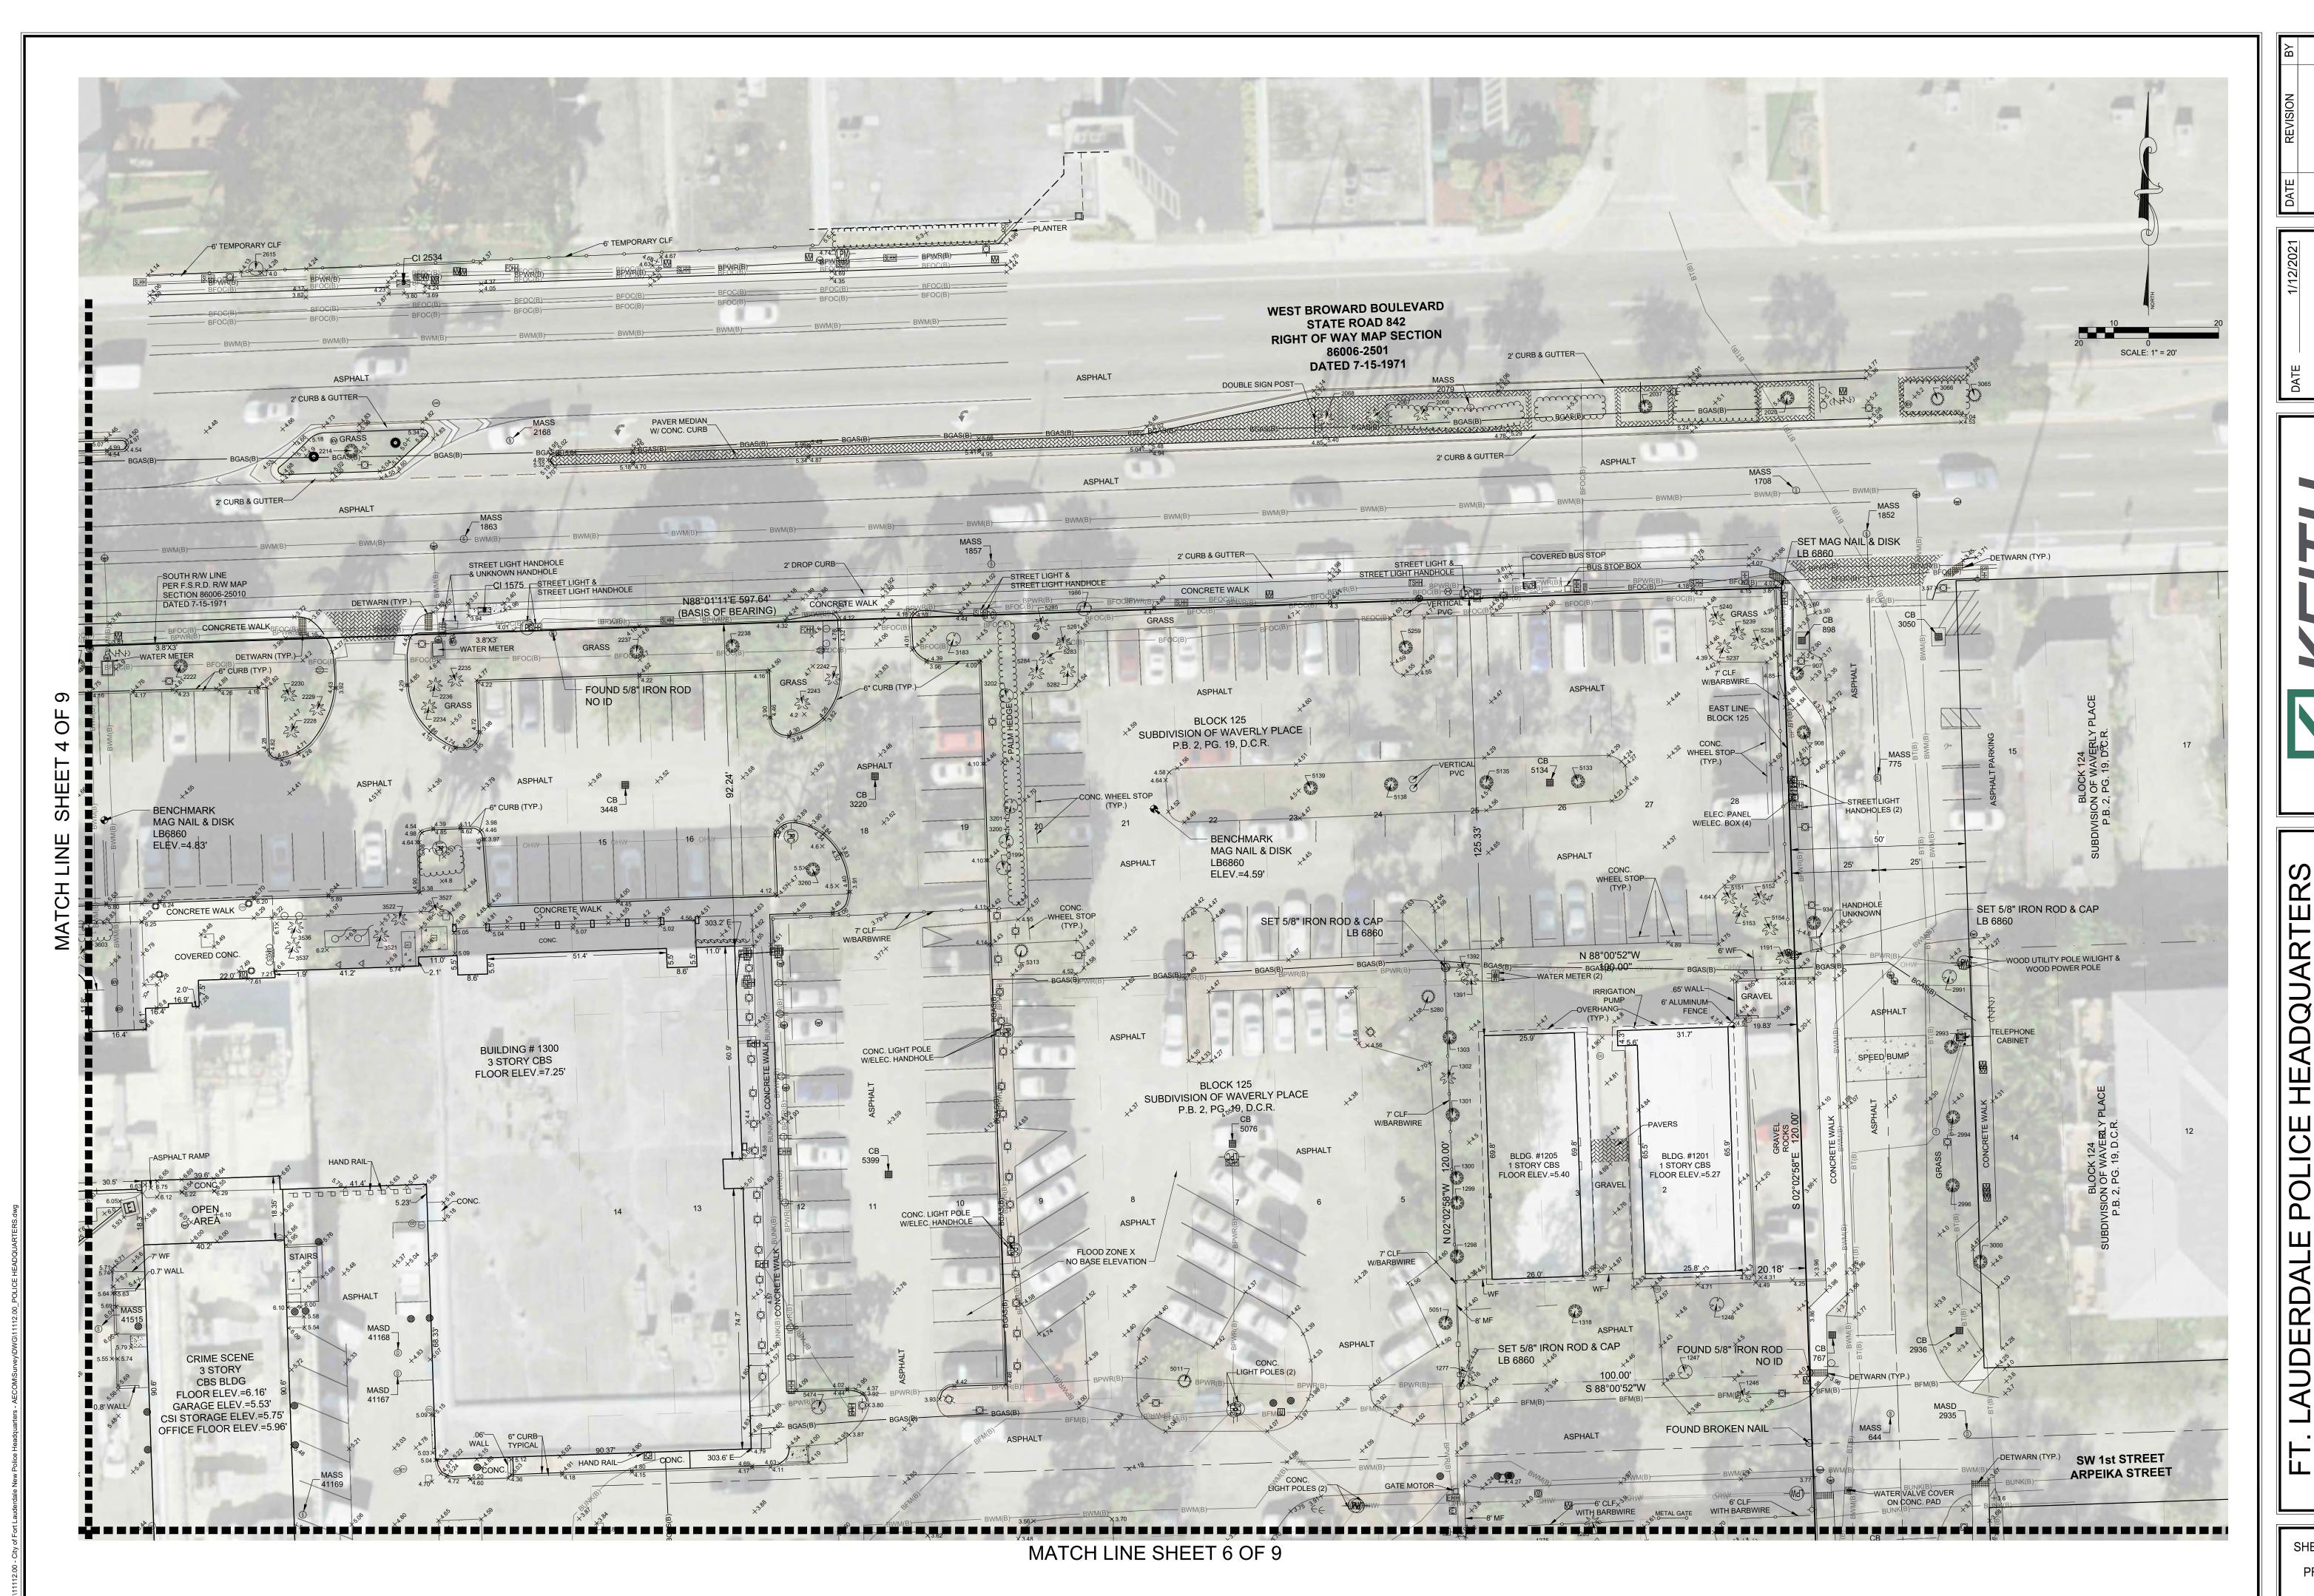


SHEET <u>5</u> OF <u>9</u>

PROJECT NUMBER

11112.00

[SHEET 5] Jan 19, 2021 2:46pm

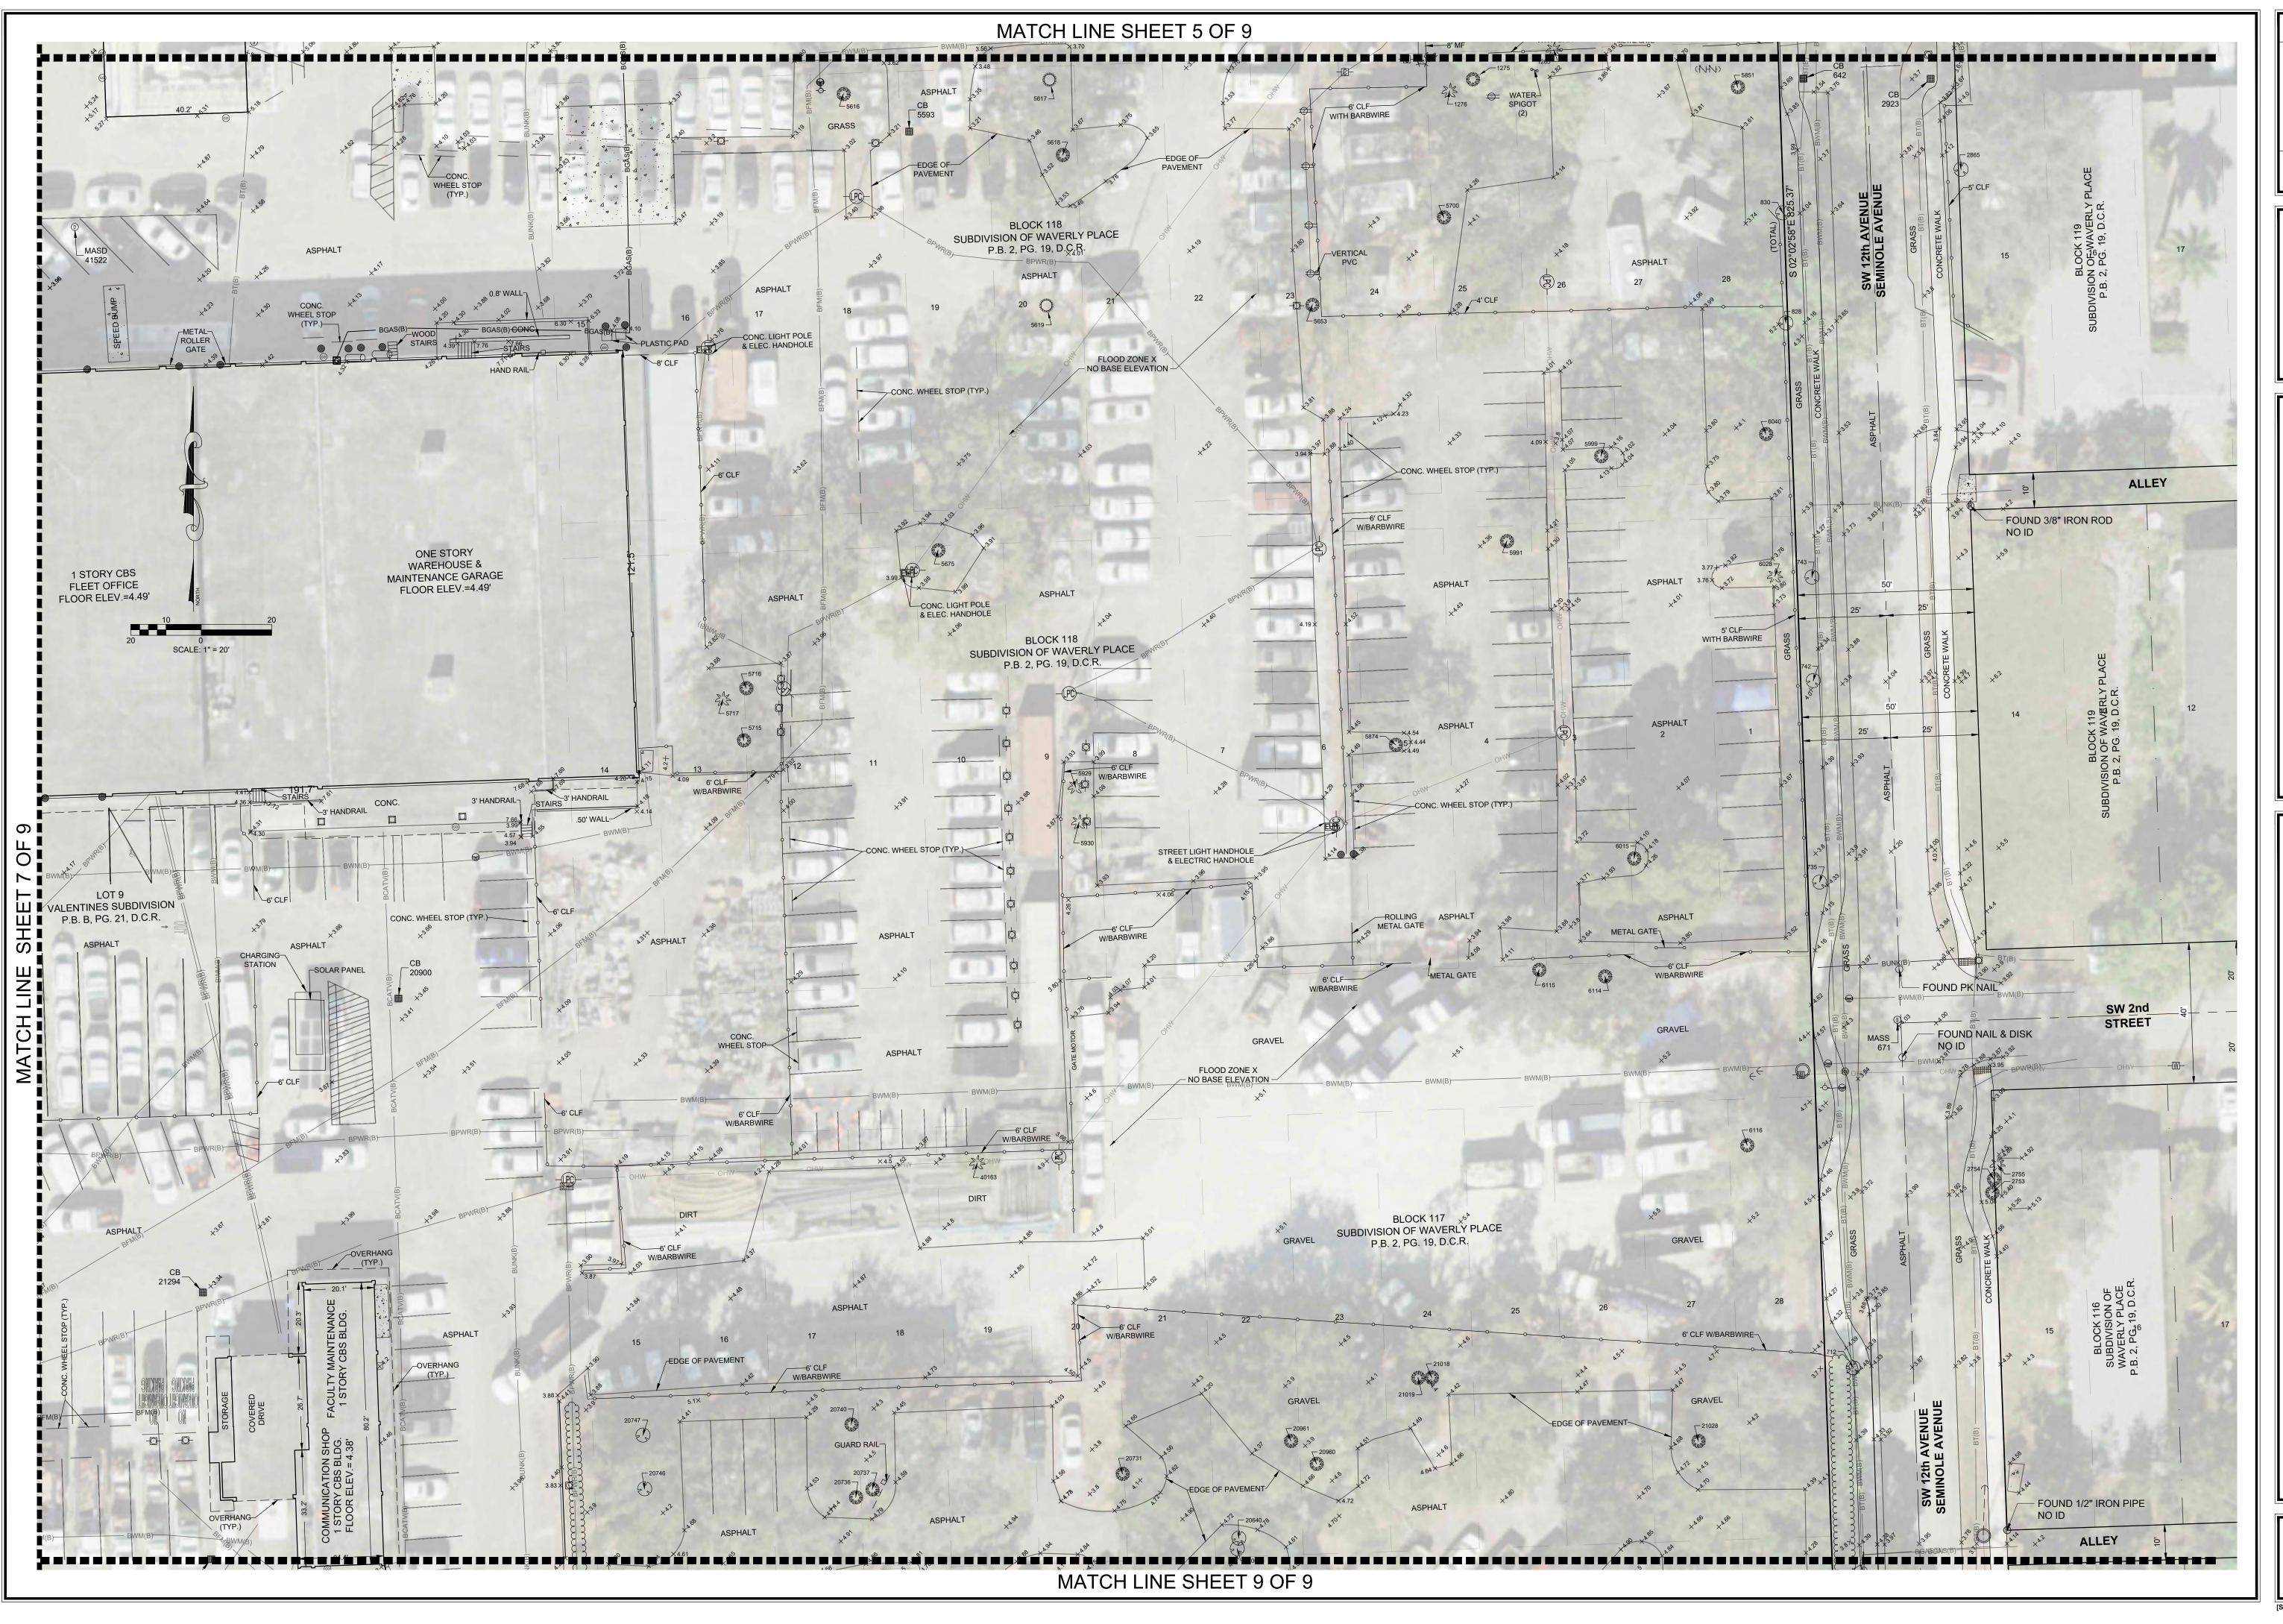





A PORTION OF LOTS 7, 8, & 9, VALENTINES SUBDIVISION, PLAT BOOK B
A PORTION OF BLOCKS 117, 118, & 125, WAVERLY PLACE, PLAT BOOK 2
CITY OF OF FT. LAUDERDALE, BROWARD COUNTY, FLORI

SHEET 6 OF 9
PROJECT NUMBER
11112.00
[SHEET 6] Jan 19, 2021 2:48pm



CAM #22-0702 Exhibit 2 Page 7 of 65

SHEET 8 OF 9 PROJECT NUMBER 11112.00

[SHEET 8] Jan 19, 2021 2:50pm

EADQUARTERS HIC SURVEY



CAM #22-0702 Exhibit 2 Page 9 of 65


SHEET <u>9</u> OF <u>9</u>

PROJECT NUMBER 11112.00


[SHEET 9] Jan 19, 2021 2:52pm




VIEW FROM NORTHWEST CORNER

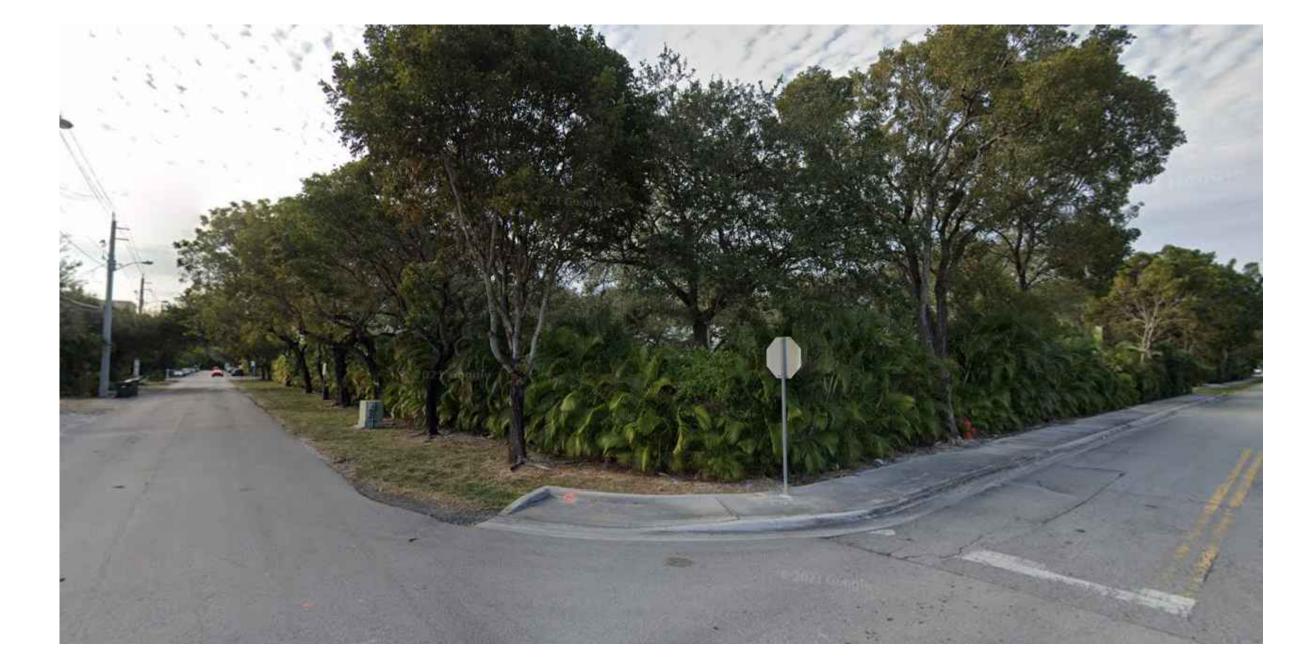

VIEW FROM SOUTHWEST CORNER

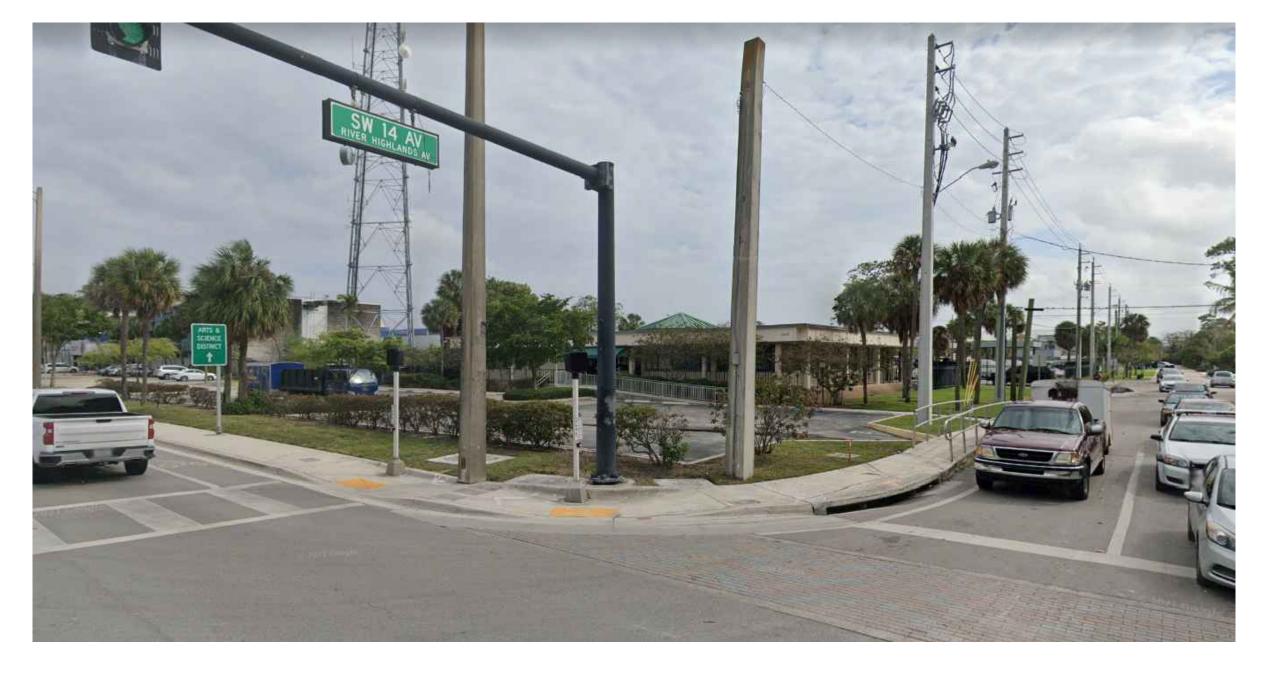

VIEW FROM NORTHEAST CORNER

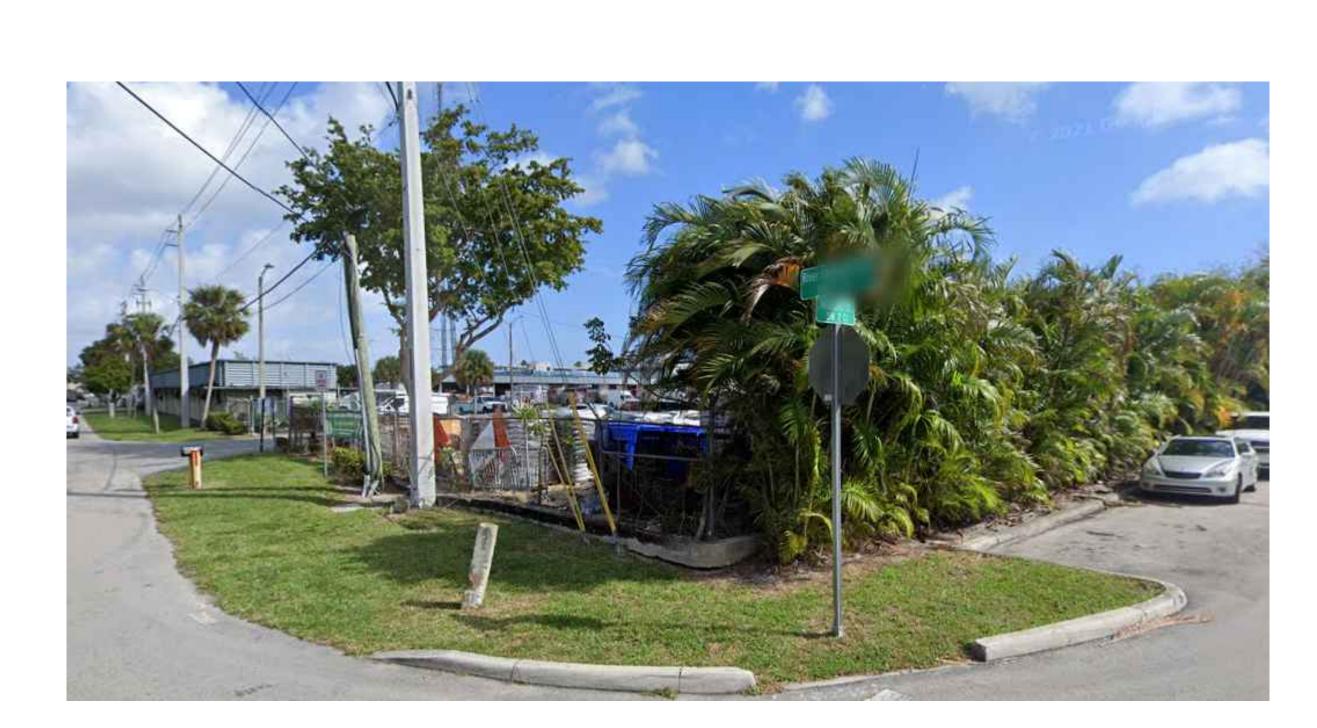

VIEW FROM SOUTHEAST CORNER

KEITH

301 East Atlantic Blvd. Pompano Beach, FL 33060 PH: (954) 788-3400

Florida Certificate of Authorization: 7928
Licensed Business Number: 6860

REVISIONS		
NO.	DESCRIPTION	DATE

PRELIMINARY PLAN

NOT FOR CONSTRUCTION

THESE PLANS ARE NOT FULLY PERMITTED
AND ARE SUBJECT TO REVISIONS MADE
DURING THE PERMITTING PROCESS.

RESPONSIBILITY FOR THE USE OF THESE
PLANS PRIOR TO OBTAINING PERMITS FROM
ALL AGENCIES HAVING JURISDICTION OVER
THE PROJECT WILL FALL SOLELY UPON THE
USER.

ISSUE DATE:	06/25/21
DESIGNED BY:	JW
DRAWN BY:	AM/NW/FA
CHECKED BY:	TD
BID-CONTRACT:	

THOMAS F. DONAHUE, P.E. FLORIDA REG. NO. 60529 (FOR THE FIRM)

CLIENT

CITY OF FORT LAUDERDALE


PROJECT


NEW POLICE HEADQUARTERS 1300-1350 WEST BROWARD BLVD

SHEET TITLE


SITE IMAGES


SHEET EX-101
PROJECT 11112.00

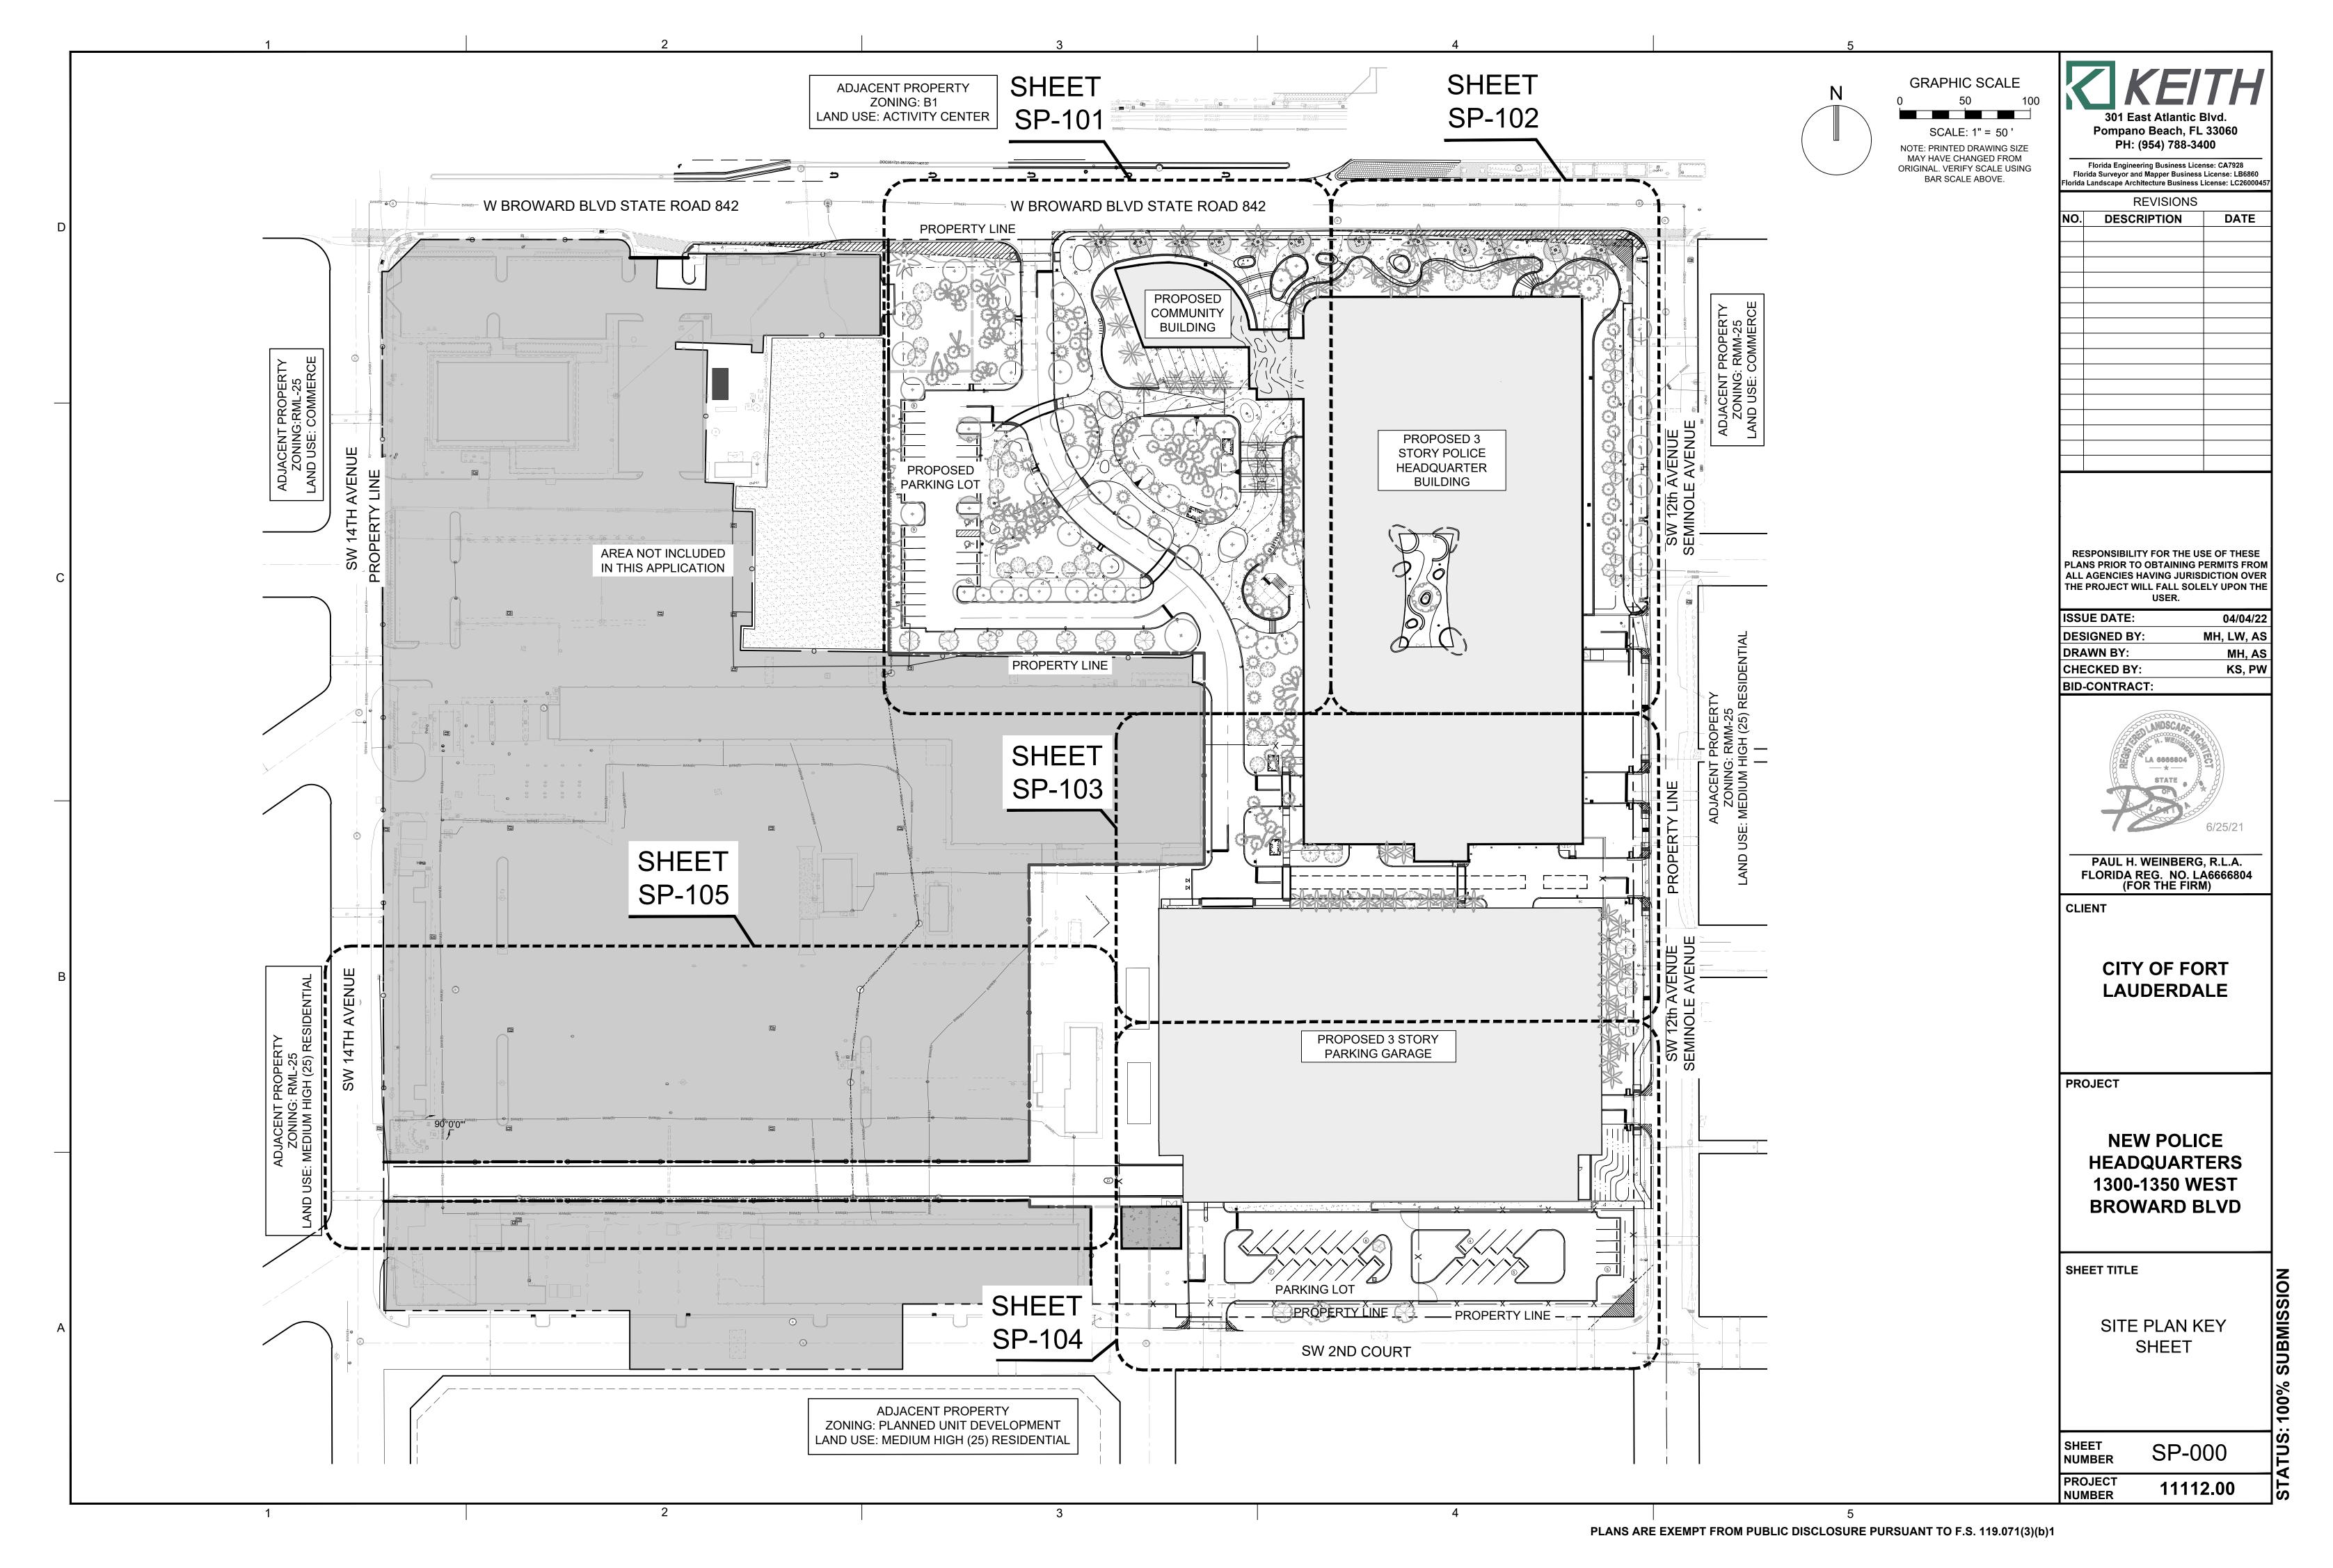

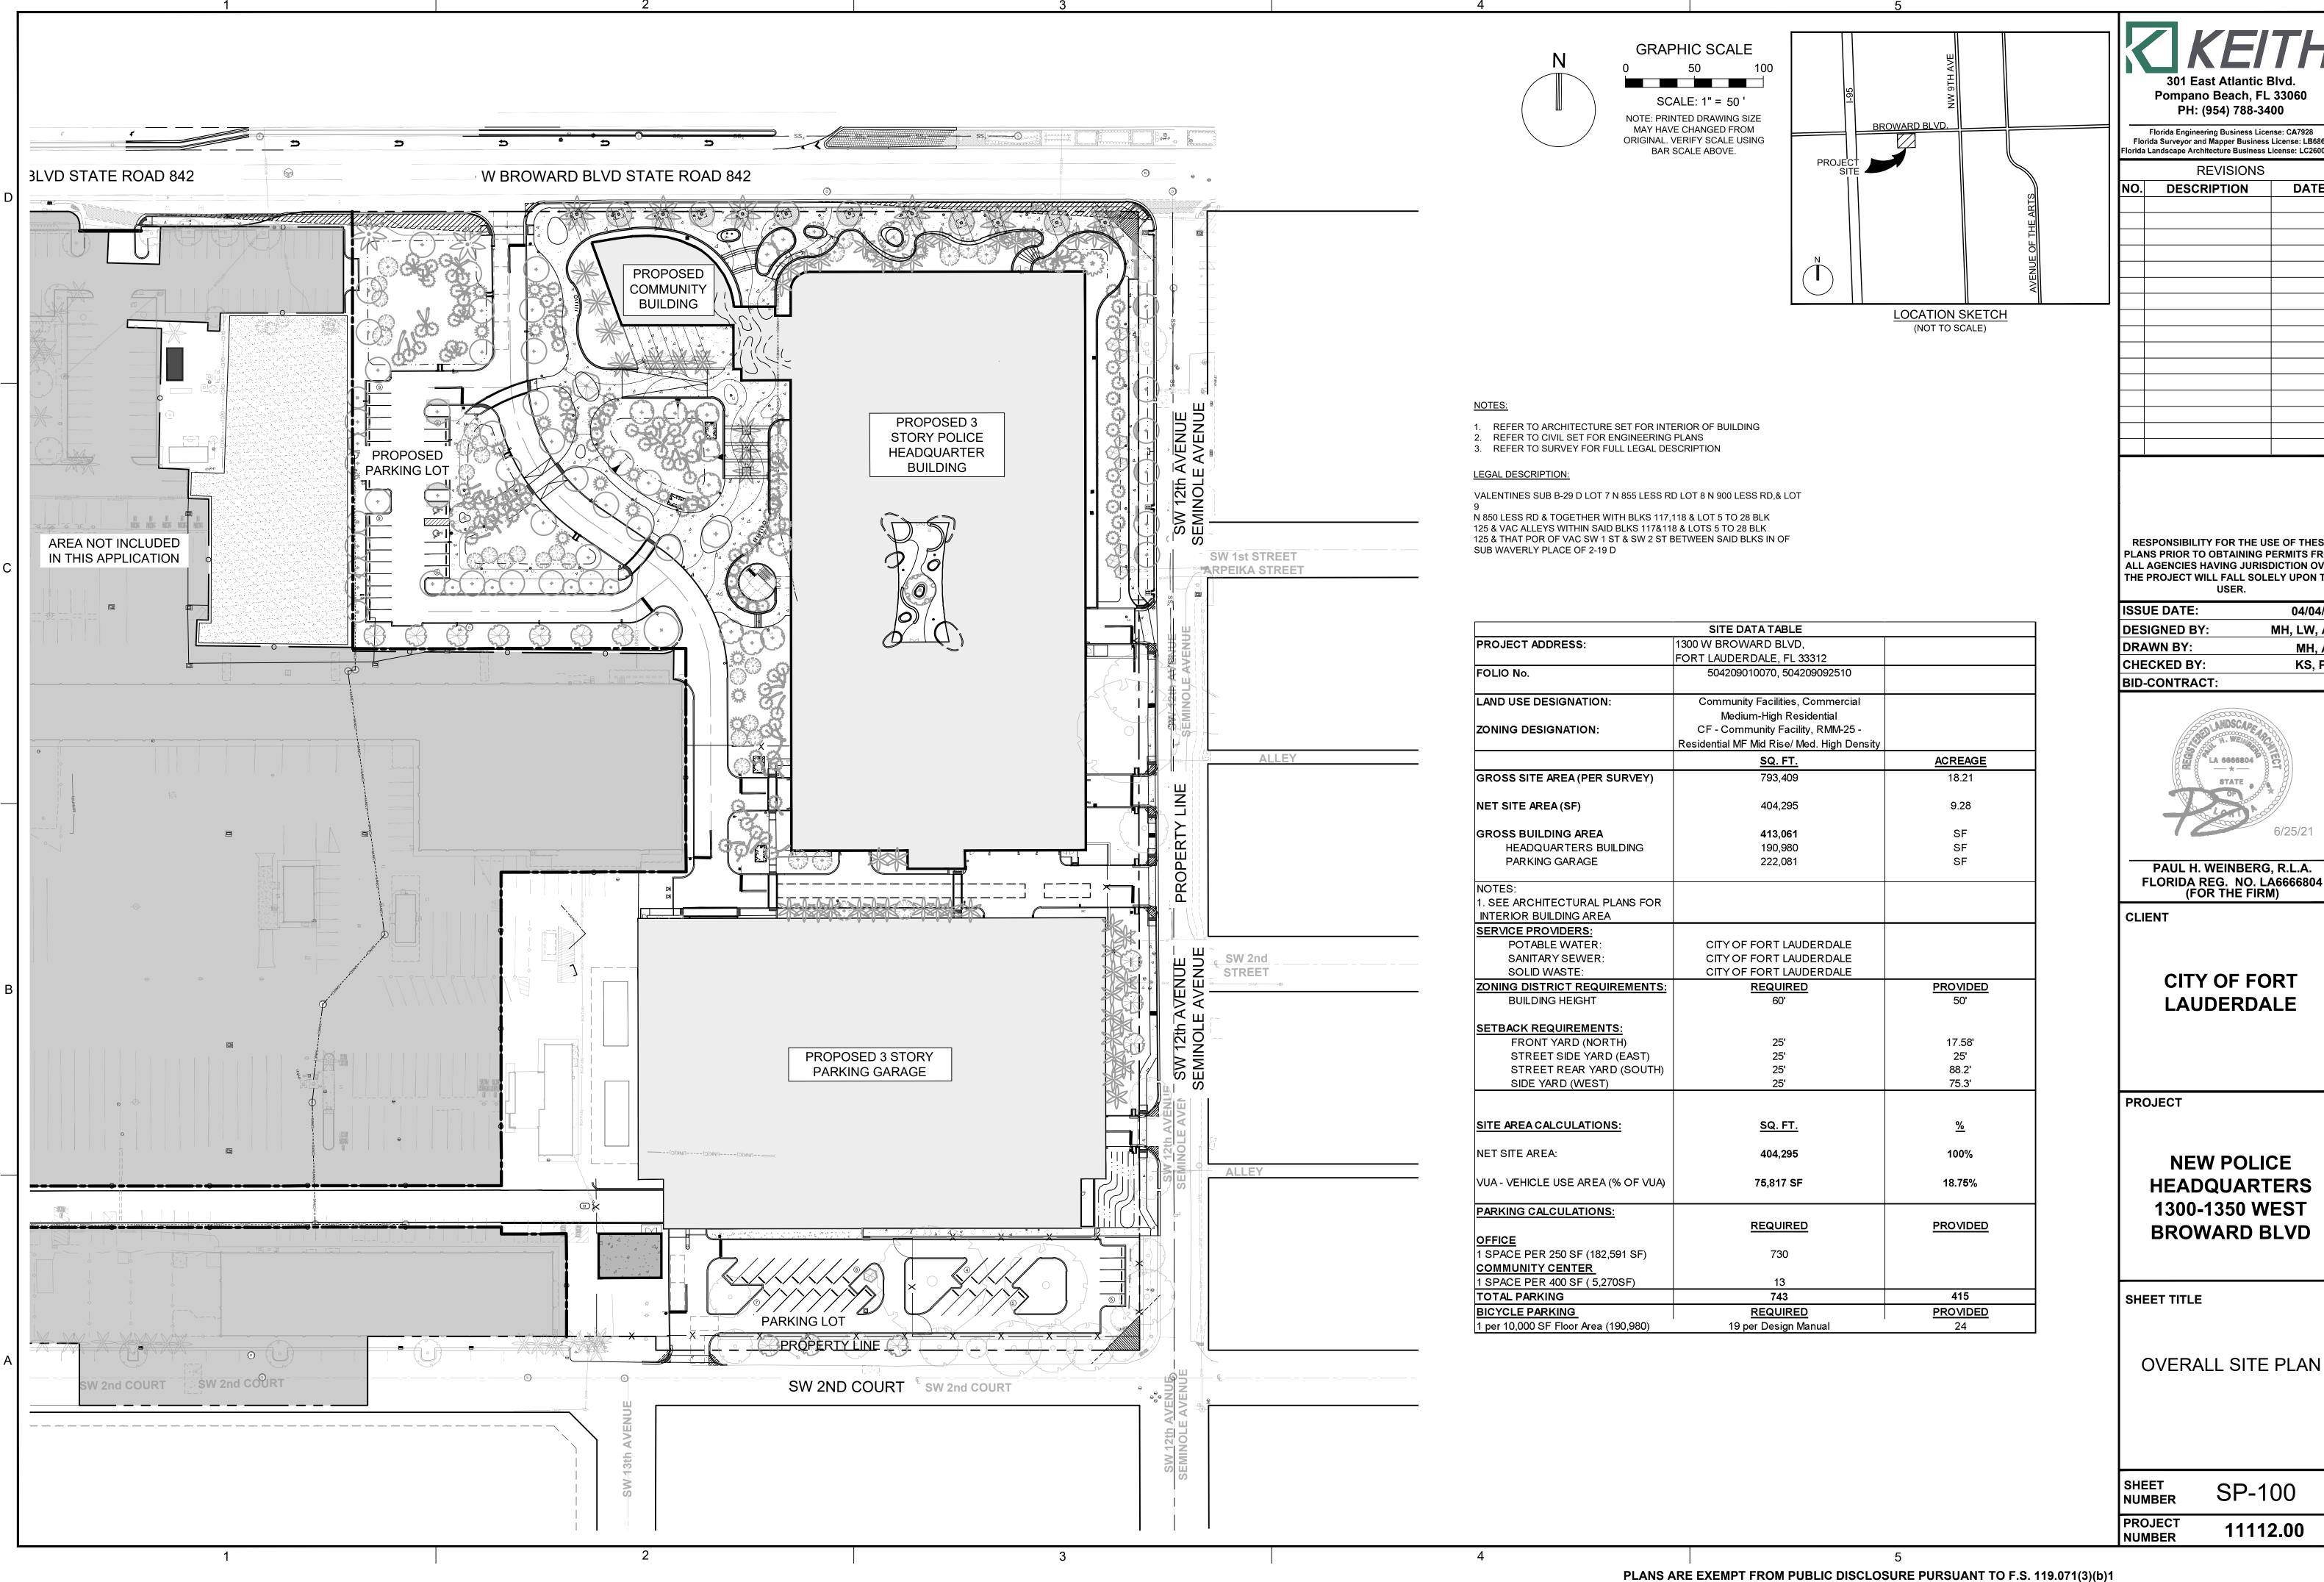


301 East Atlantic Blvd. Pompano Beach, FL 33060 Florida Engineering Business License: CA7928 Florida Surveyor and Mapper Business License: LB6860 Florida Landscape Architecture Business License: LC2600045 DATE RESPONSIBILITY FOR THE USE OF THESE PLANS PRIOR TO OBTAINING PERMITS FROM **ALL AGENCIES HAVING JURISDICTION OVER** THE PROJECT WILL FALL SOLELY UPON THE 04/04/22 MH, LW, AS MH, AS KS, PW PAUL H. WEINBERG, R.L.A. FLORIDA REG. NO. LA6666804 (FOR THE FIRM) **CITY OF FORT** LAUDERDALE **NEW POLICE HEADQUARTERS** 1300-1350 WEST **BROWARD BLVD**

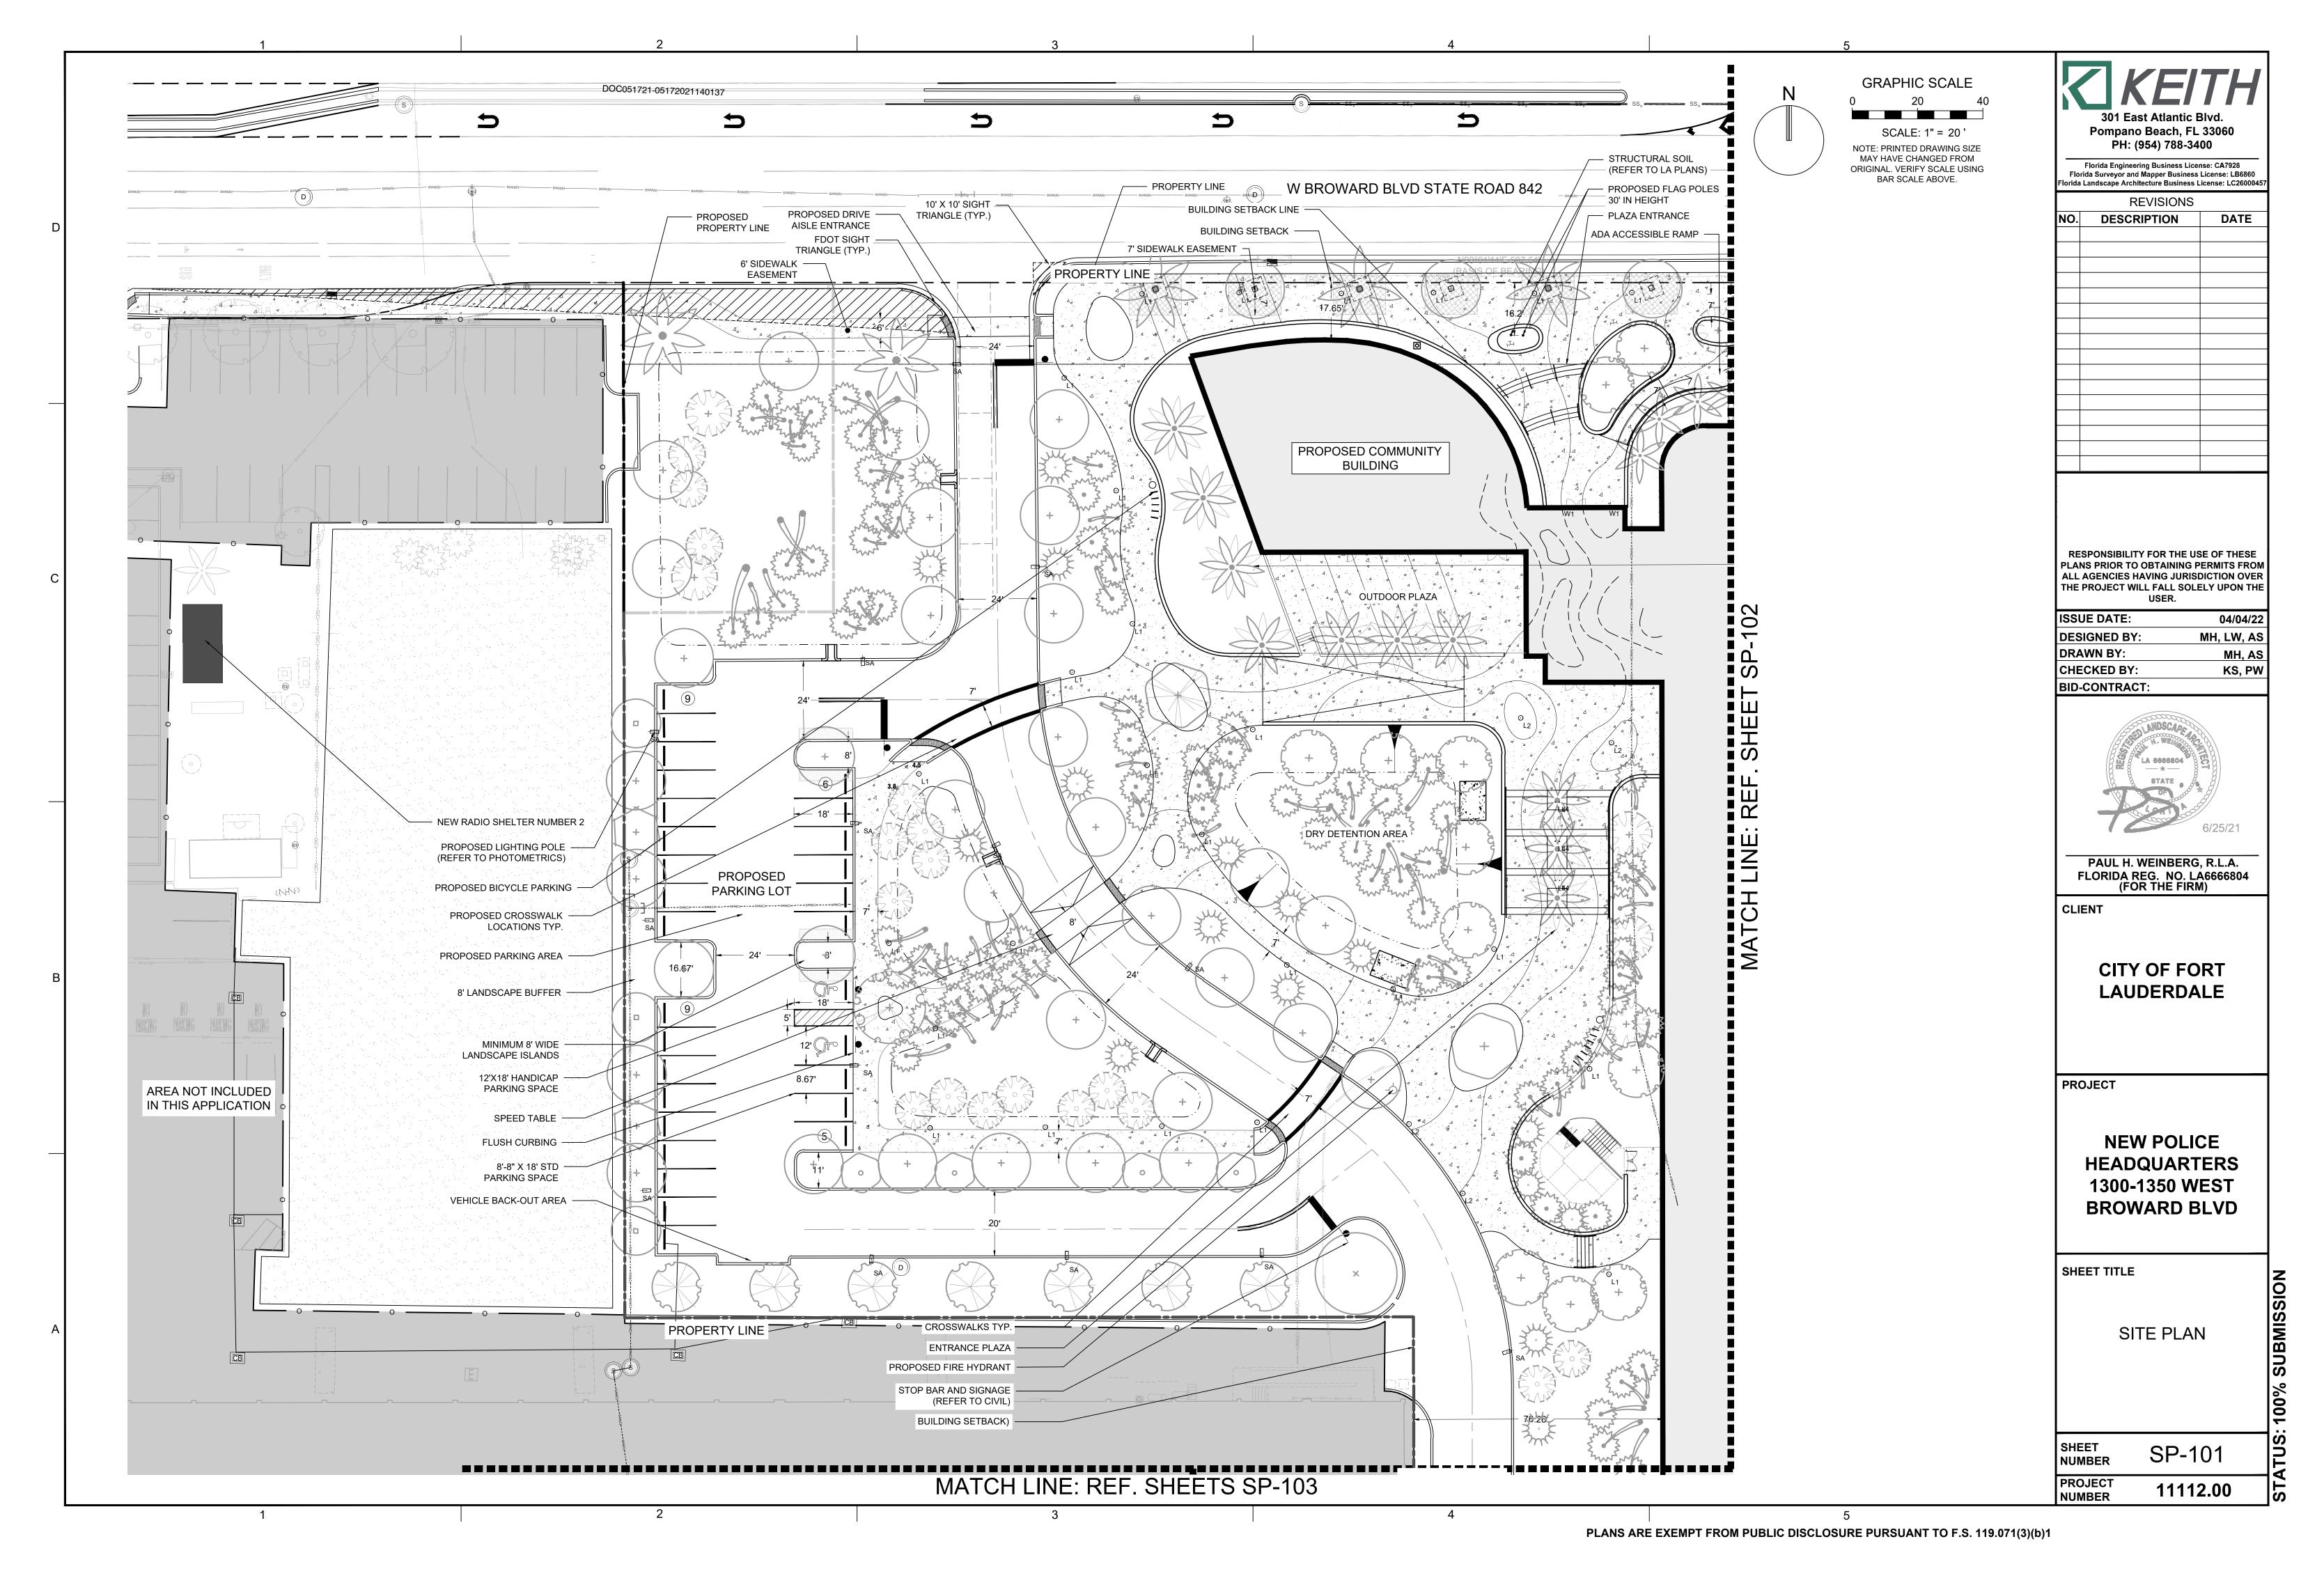


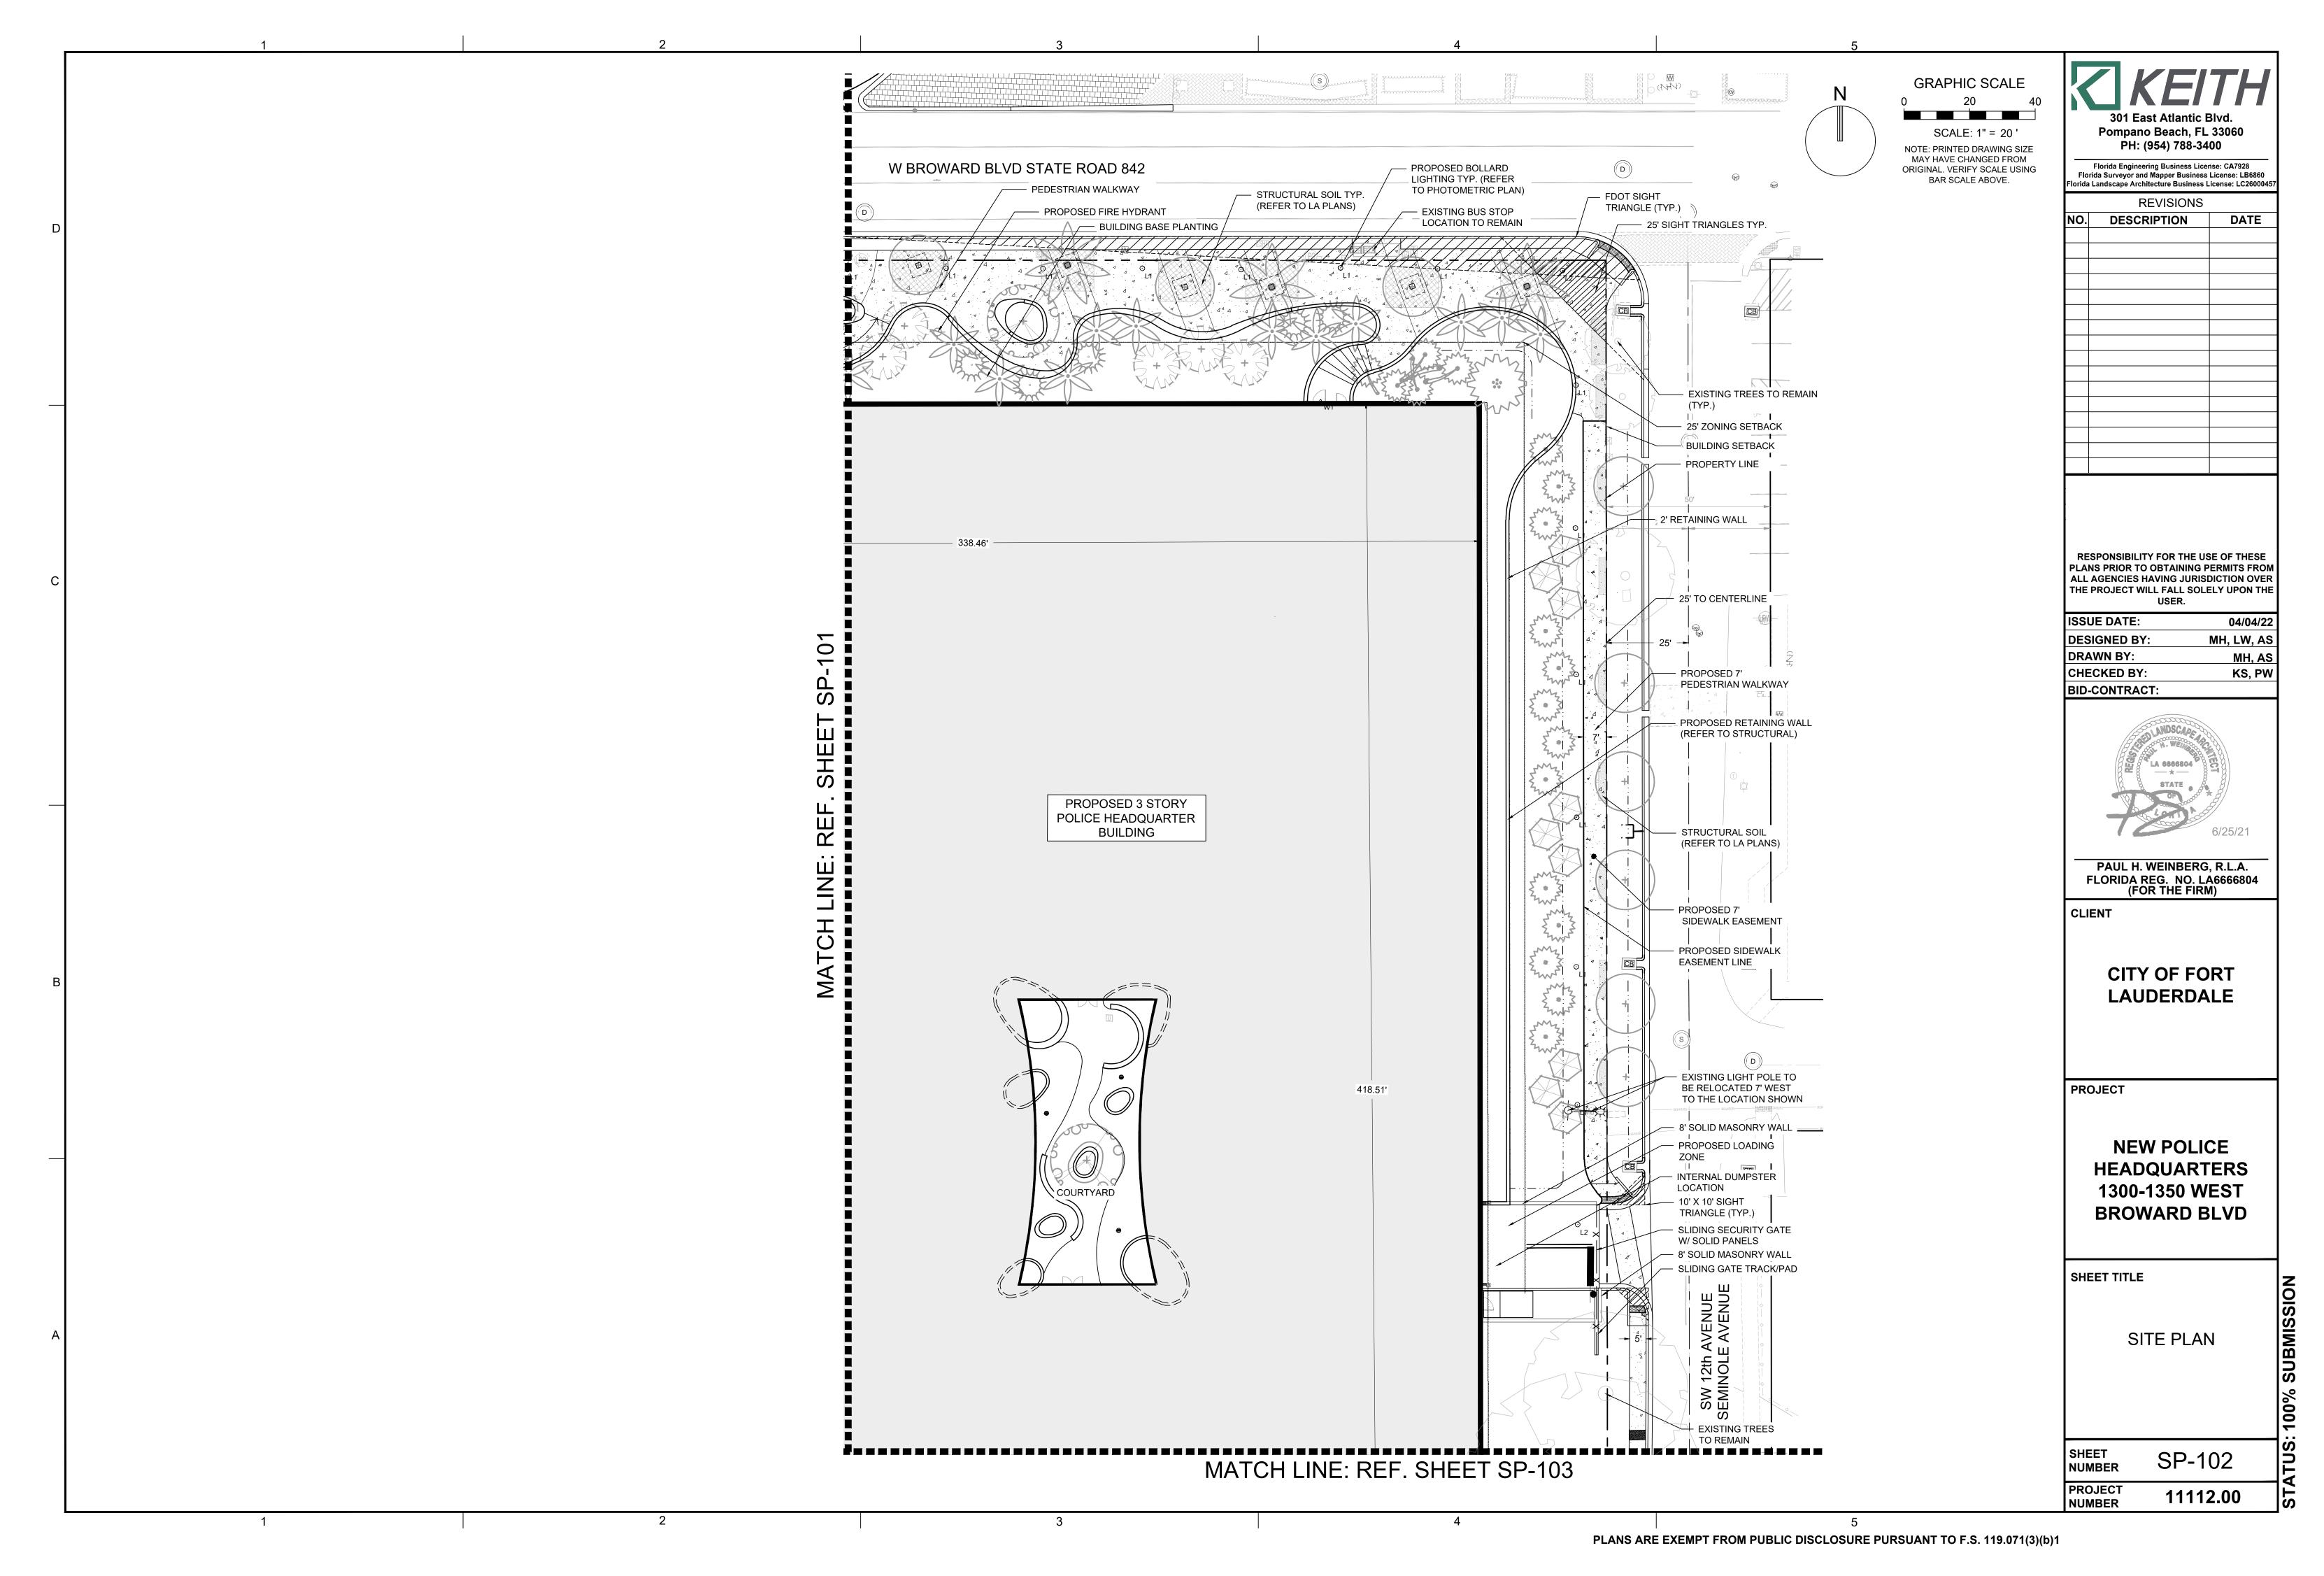


GRAPHIC SCALE 301 East Atlantic Blvd. Pompano Beach, FL 33060 PH: (954) 788-3400 SCALE: 1" = 20 ' Florida Engineering Business License: CA7928 Florida Surveyor and Mapper Business License: LB6860 Florida Landscape Architecture Business License: LC2600045 NOTE: PRINTED DRAWING SIZE MAY HAVE CHANGED FROM ORIGINAL. VERIFY SCALE USING BAR SCALE ABOVE. REVISIONS DESCRIPTION DATE RESPONSIBILITY FOR THE USE OF THESE PLANS PRIOR TO OBTAINING PERMITS FROM ALL AGENCIES HAVING JURISDICTION OVER THE PROJECT WILL FALL SOLELY UPON THE MATCH LINE: REF. SHEET SP-102 **ISSUE DATE:** 04/04/22 **DESIGNED BY:** MH, LW, AS DRAWN BY: MH, AS CHECKED BY: KS, PW BID-CONTRACT: 76.26 10' ECHELON II INVINCIBLE FENCE @ 4 RAIL & NON-RATED HIGH SPEED SLIDING GATE W/ K8 CRASH-RATED ARM PROPOSED 3 STORY POLICE STOP SIGN AND PAVEMENT MARKING PROPOSED EXTERIOR PIPE HEADQUARTER BUILDING BOLLARDS TYP. FFE 8.00 NAVD LOADING ZONE AREA PROPOSED FIRE HYDRANT LOCATION (REFER TO CIVIL) + 10' X 10' SIGHT TRIANGLE (TYP.) PAUL H. WEINBERG, R.L.A. FLORIDA REG. NO. LA6666804 (FOR THE FIRM) 8' SOLID MASONRY WALL BUILDING SETBACK CLIENT PROPERTY LINE BI-PARTING SLIDING **CITY OF FORT** GATE W/ SOLID PANELS PROPOSED EXTERIOR PIPE BOLLARDS TYP. **LAUDERDALE** 10' X 10' SIGHT TRIANGLE (TYP.) DEAD END - PROPOSED EXTERIOR PIPE BOLLARDS TYP. **ROAD SIGN** ROAD SIGN

10' ECHELON II INVINCIBLE
FENCE @ 4 RAIL (CB) PROPOSED CROSSWALK -NEW SERVICE DRIVE PROJECT MATCH I **NEW POLICE** CENTER LINE
OF ROAD **HEADQUARTERS** - 8' SOLID 1300-1350 WEST MASONRY WALL **BROWARD BLVD** - PROPOSED PARKING GARAGE **EXISTING LIGHT POLE** TO BE RELOCATED 10' SHEET TITLE NORTHEAST TO THE LOCATION SHOWN _ PROPOSED 5' SIDEWALK PROPOSED GARAGE SITE PLAN FFE 8.00 NAVD MATCH LINE: REF. SHEET SP-104 SHEET NUMBER SP-103 PROJECT NUMBER 11112.00

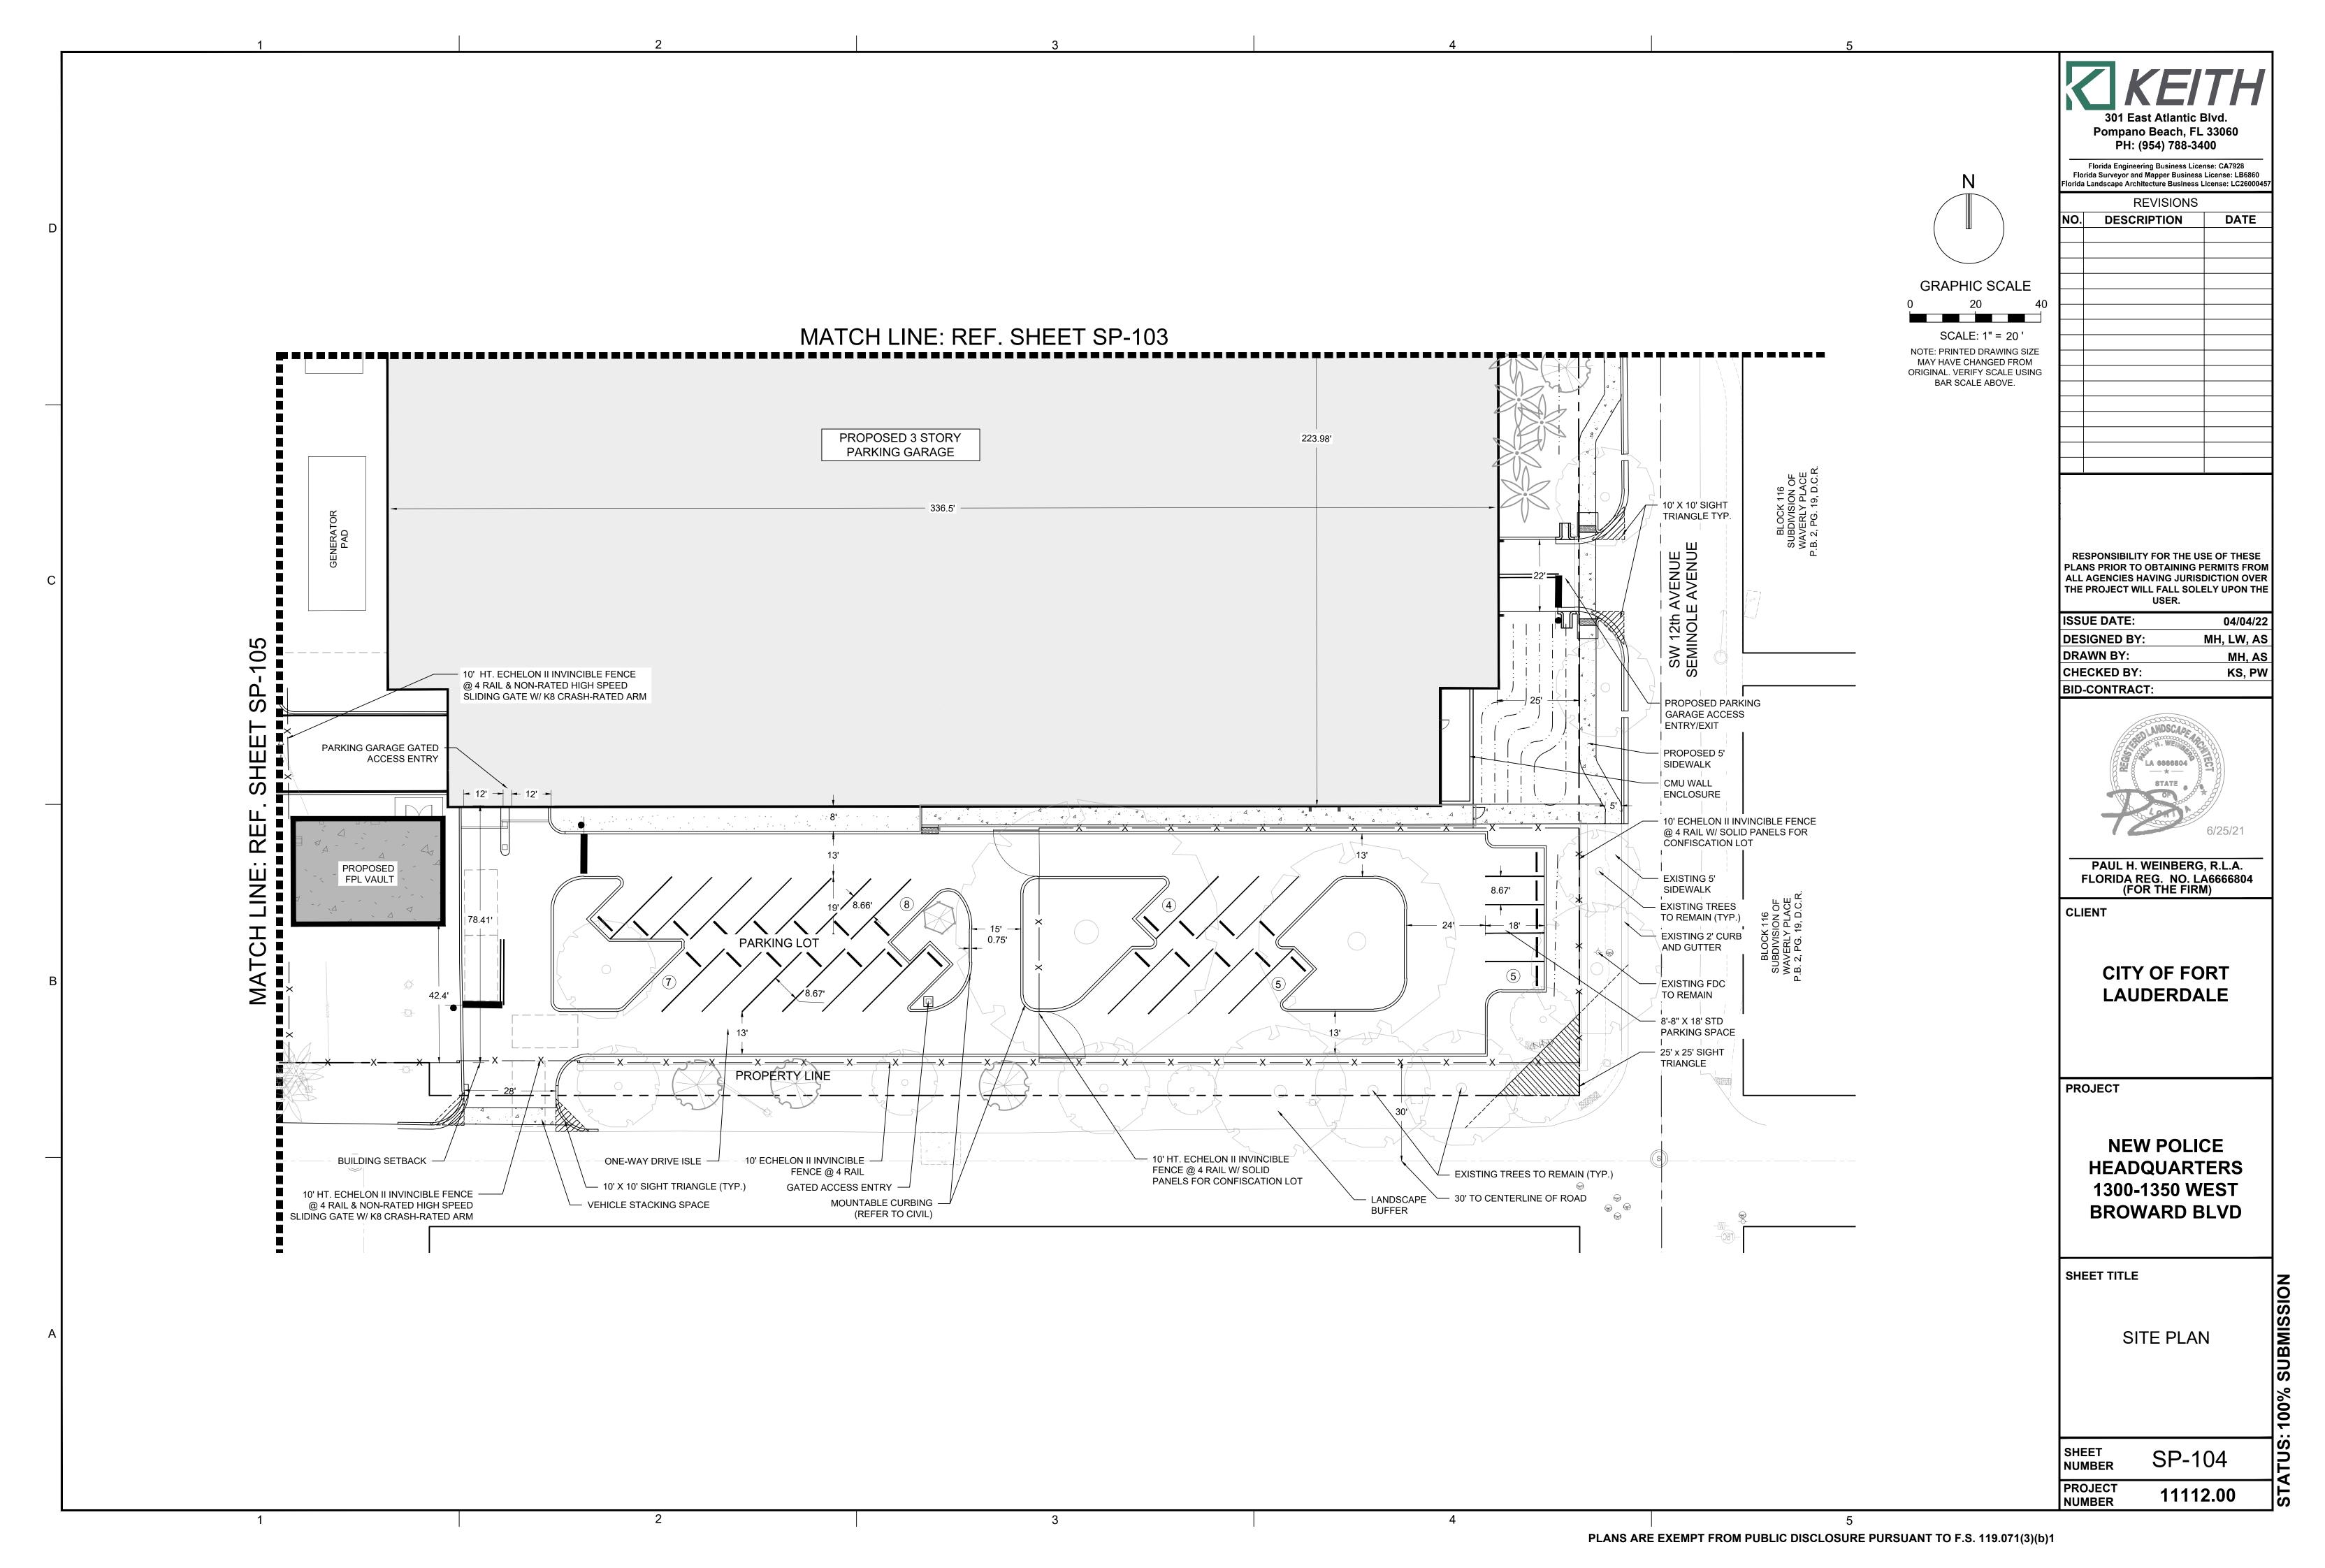

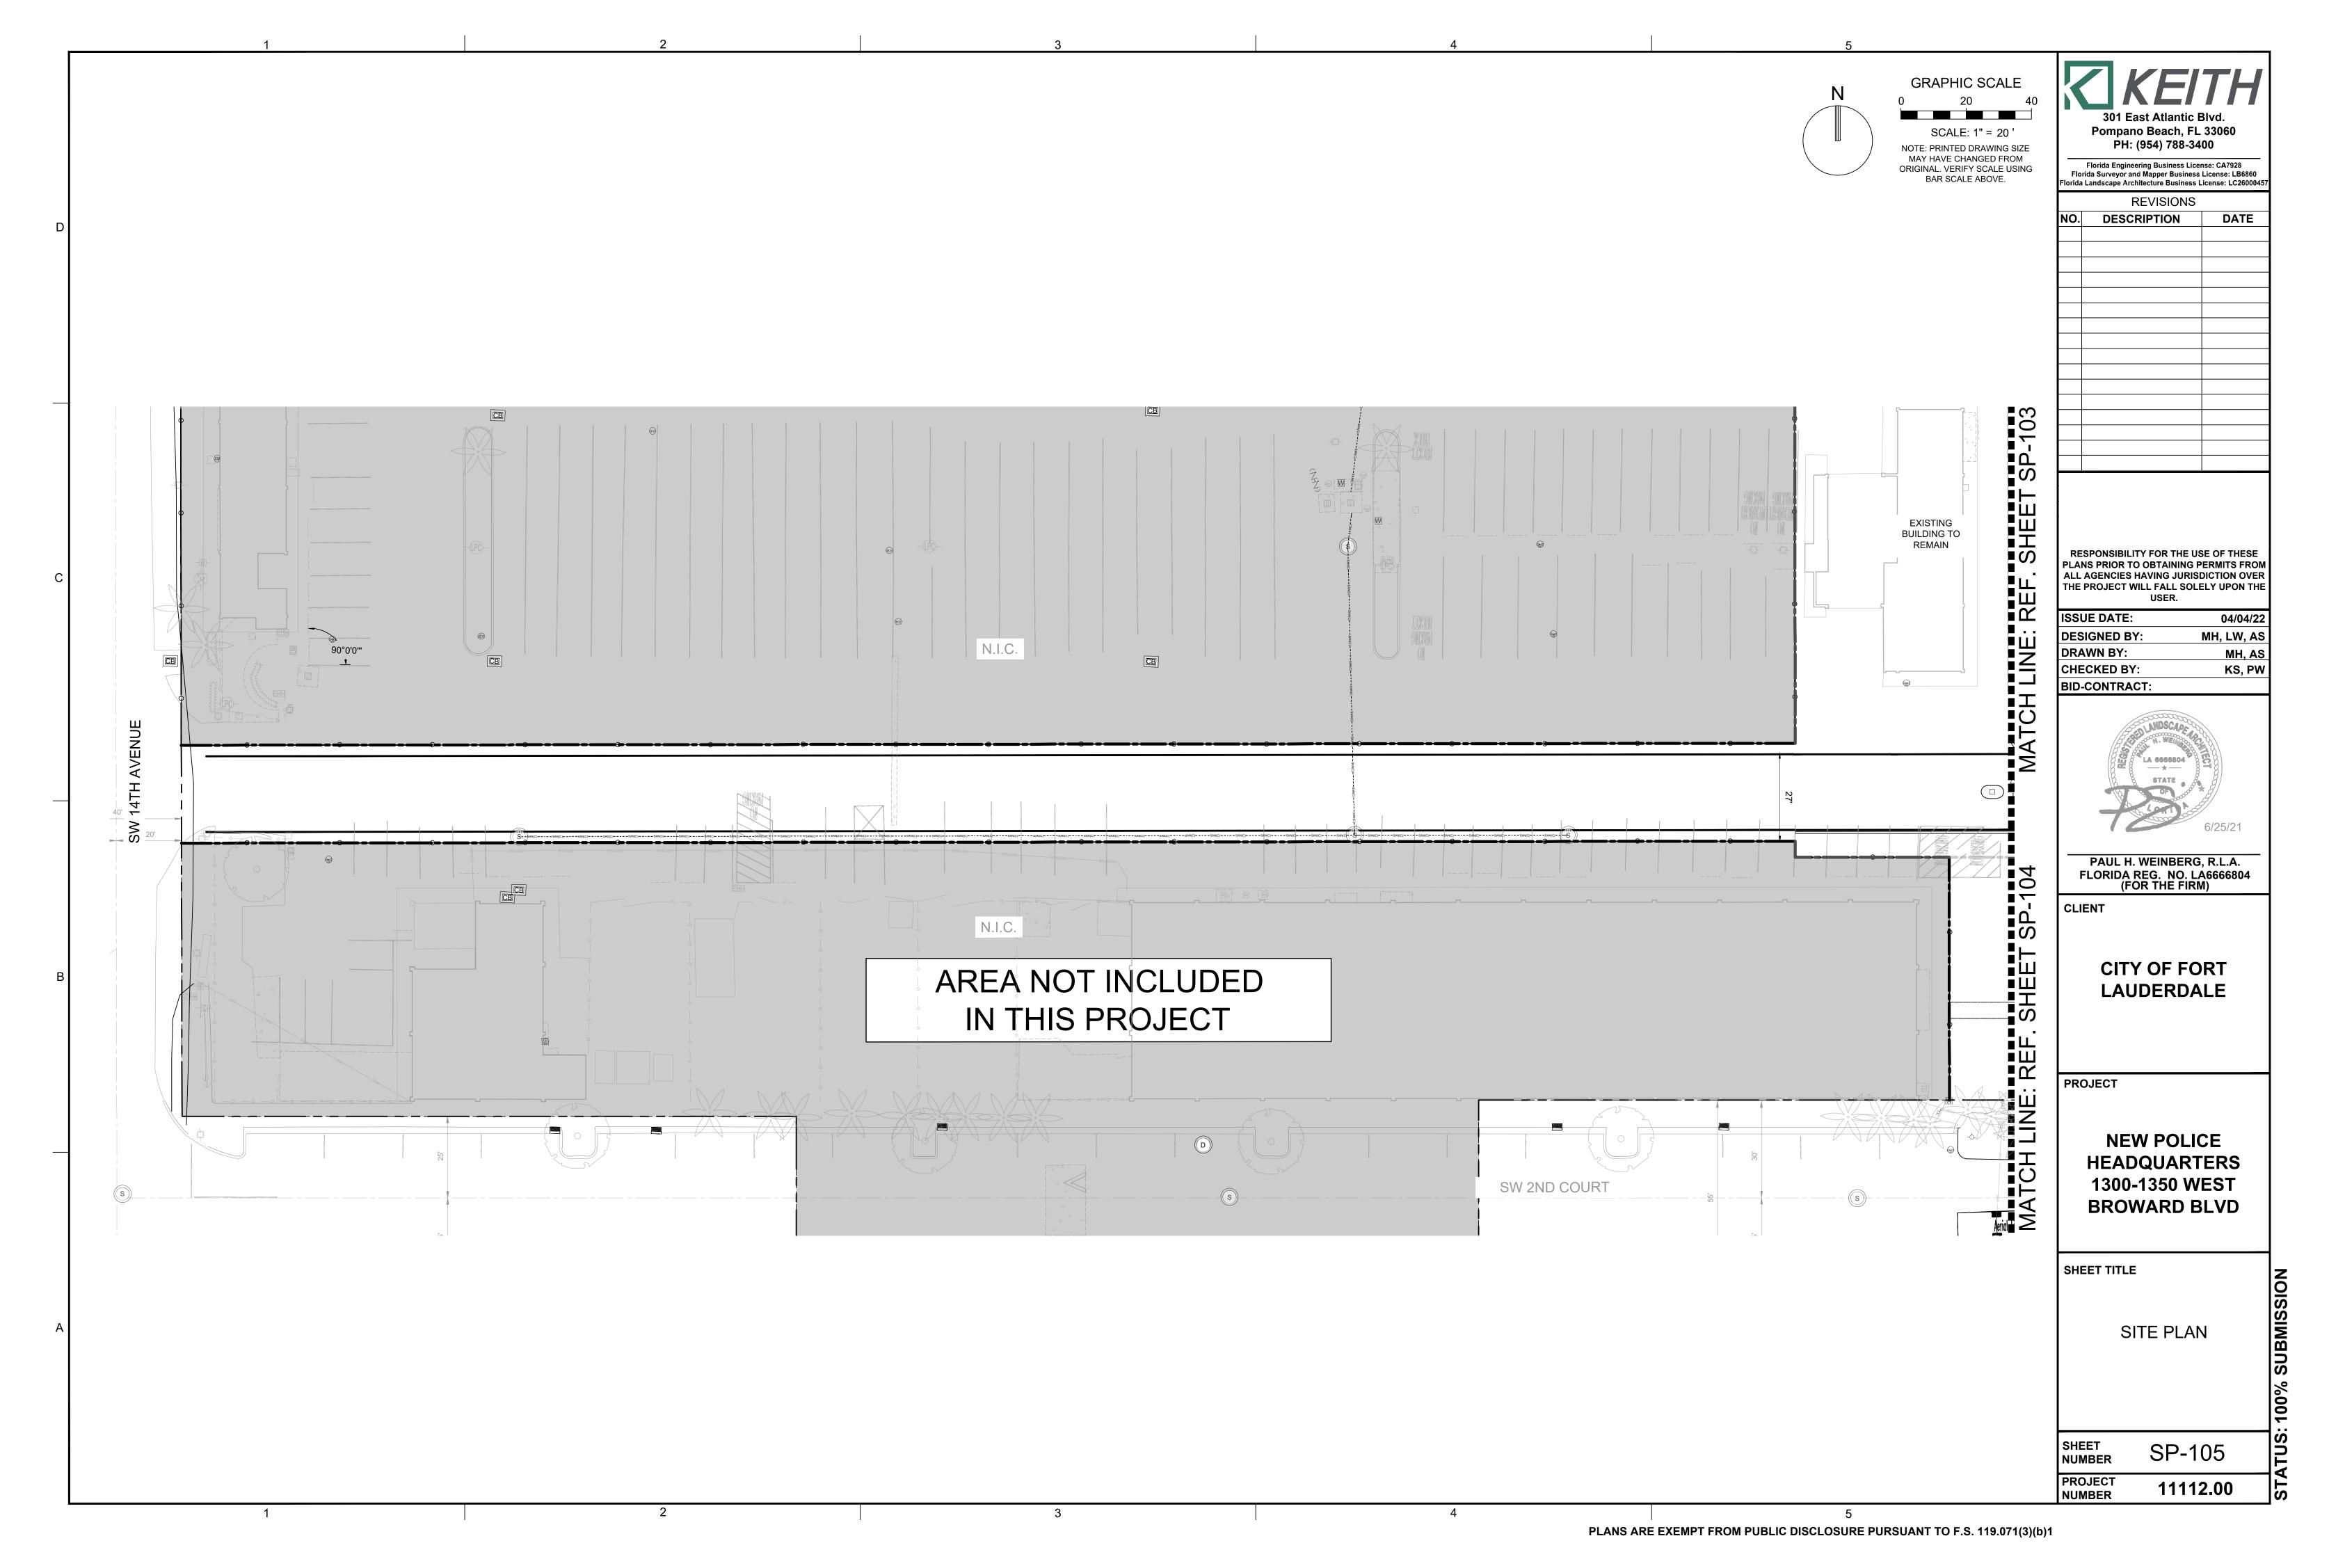

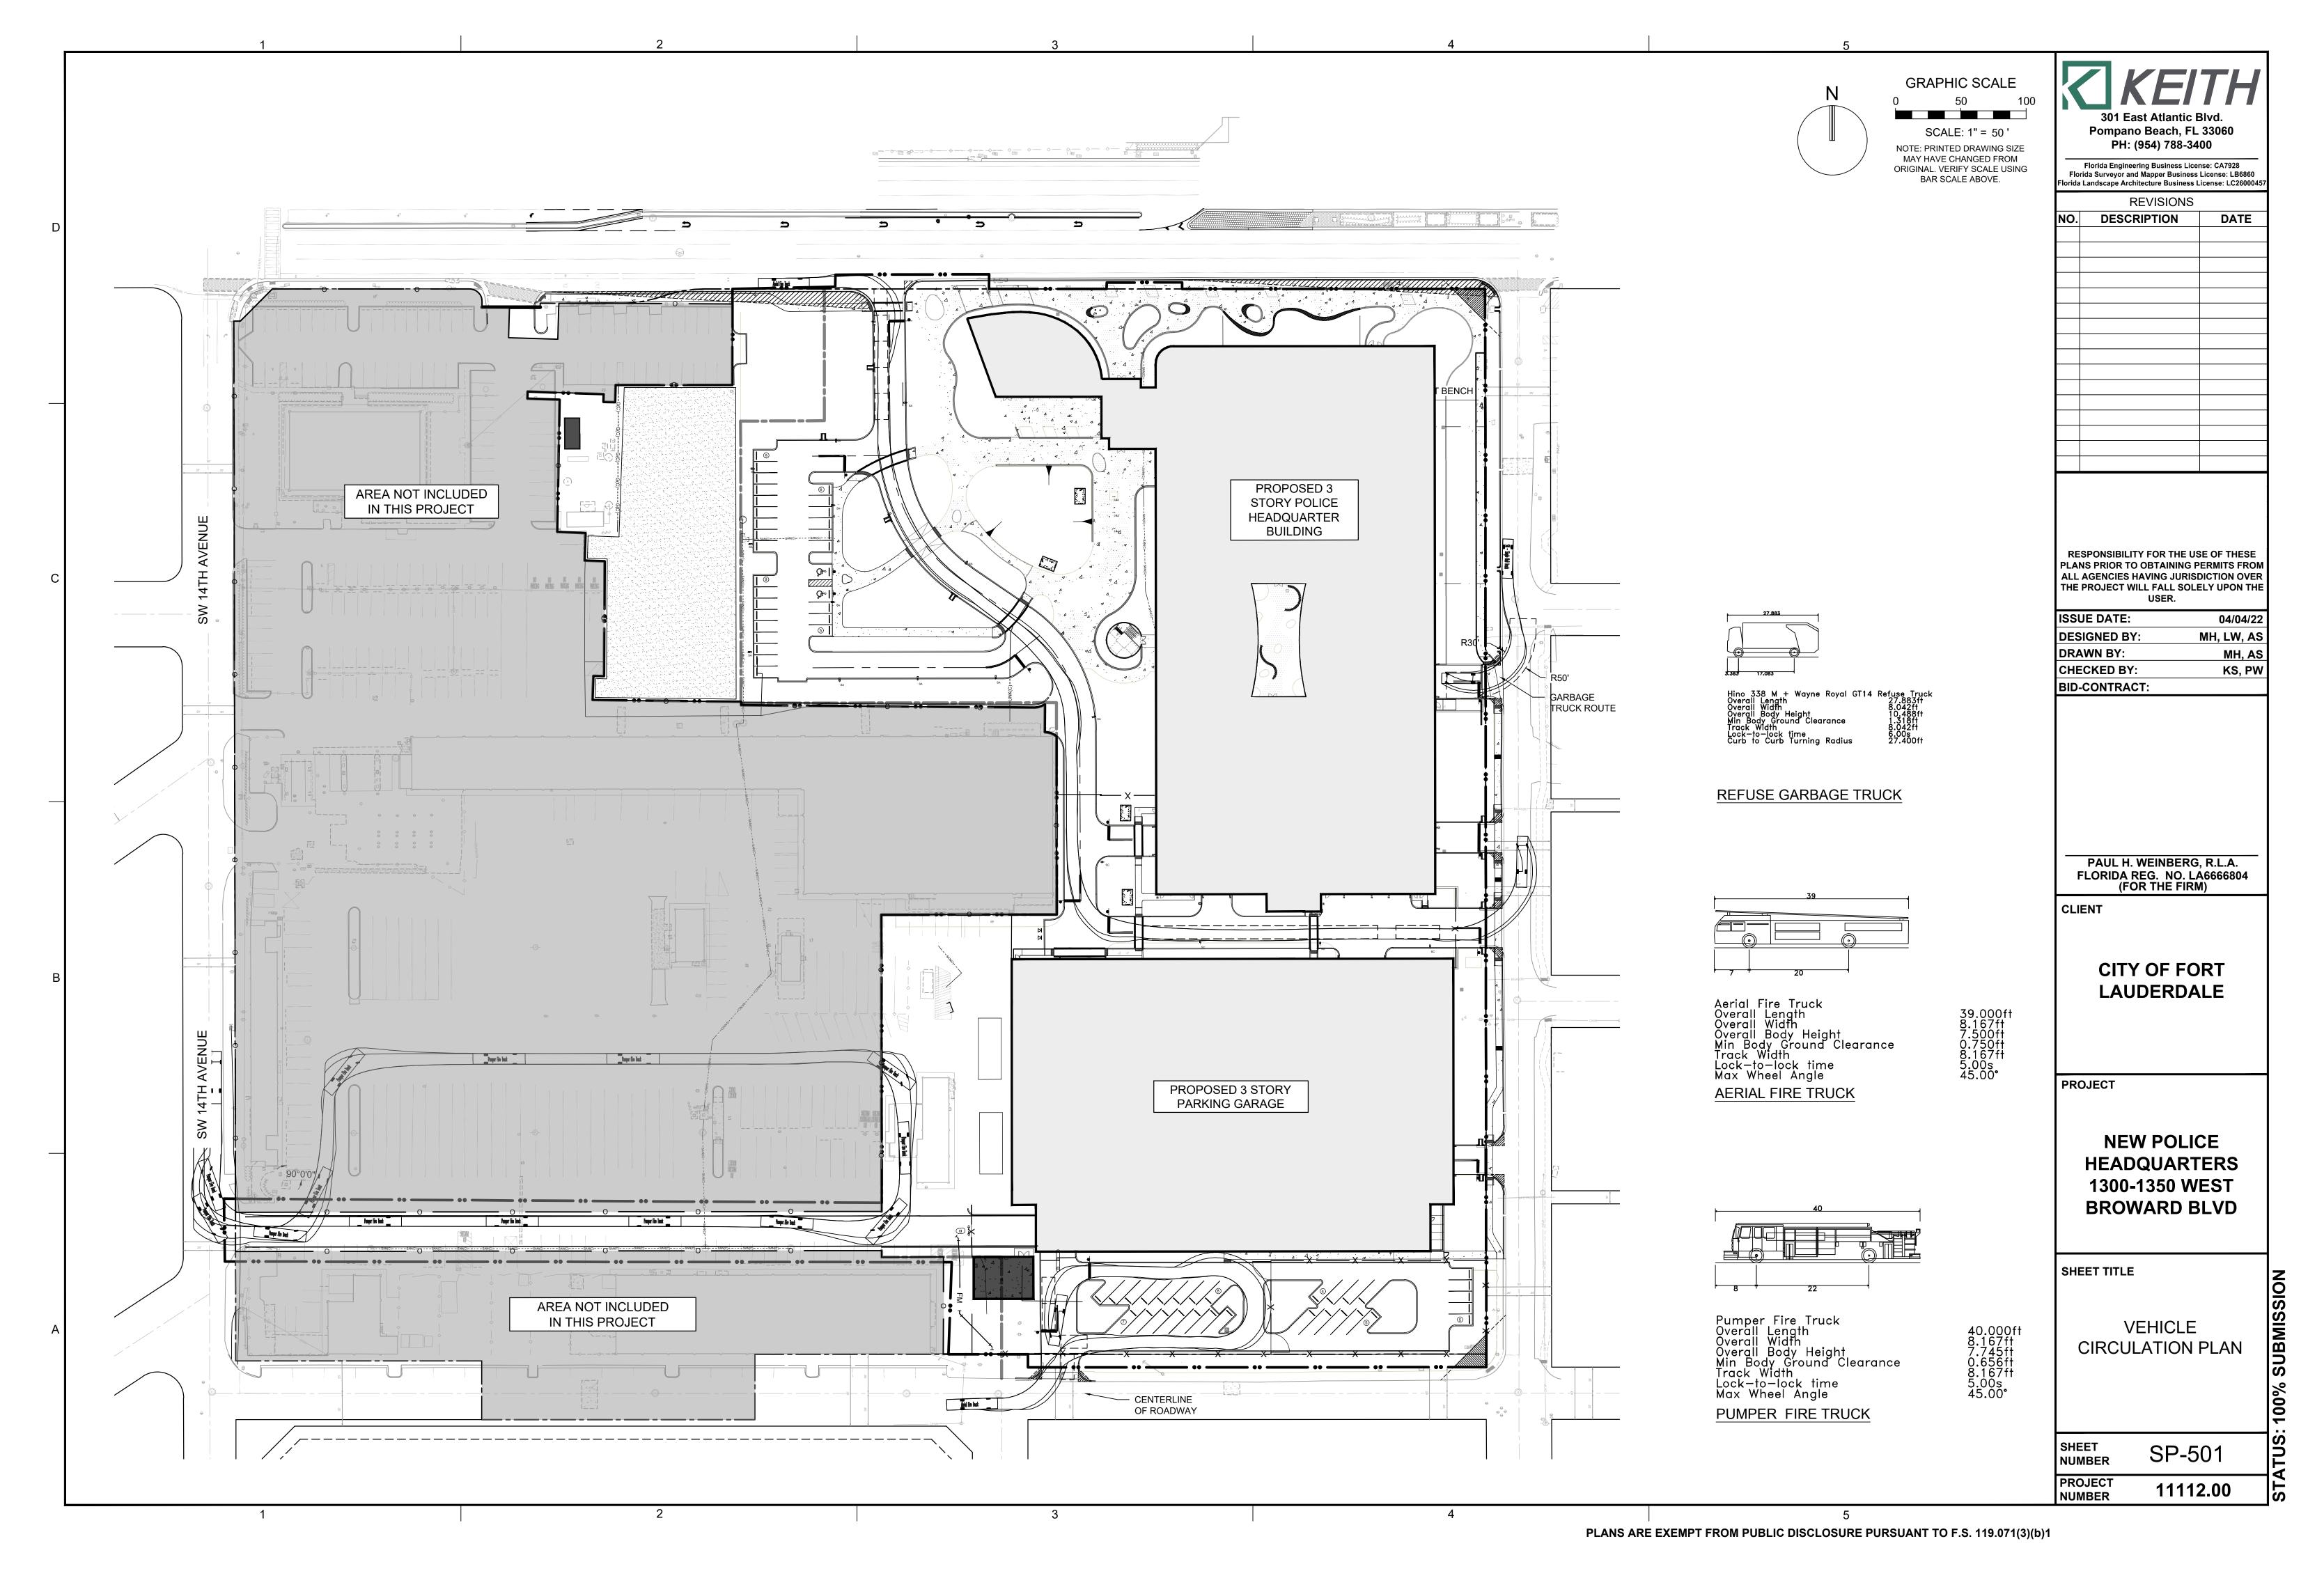

ARM ACCESS CONTROL

ASPHALT DRIVEWAY, SEE CIVIL DWGS

1-43 50 FOOT SECURITY SETBACK (FROM FACE OF CURB)

PROJECT DATA

FORT LAUDERDALE POLICE HEADQUARTERS 1300 W BROWARD BLVD FORT LAUDERDALE, FL 33321

OWNERS: CITY OF FORT LAUDERDALE DEPARTMENT OF PUBLIC WORKS

EXISTING CONDITIONS ZONING CF - COMMUNITY FACILITY, B-1 - BUSINESS ZONE AH & ZONE X FLOOD ZONE 793,409 SF (18.21 ACRES) LOT SIZE LOT A - 389,486 SF (8.94 ÁCRES)

LEGAL DESCRIPTION

ALL OF BLOCKS 117, 118, 125; AND THE 10 FOOT ALLEYS WITHIN SAID BLOCKS; AND THAT PORTION OF FLORIDA STREET (S.W. 1st STREET) AND NORTH 3rd STREET (S.W. 2nd STREET) LYING BETWEEN SAID BLOCKS, PER WAVERLY PLACE, ACCORDING TO THE PLAT THEREOF, AS RECORDED IN PLAT BOOK 2, PAGE 19 OF THE PUBLIC RECORDS OF DADE COUNTY, FLORIDA; AND LESS THEREOF THE RIGHT-OF-WAY FOR WEST BROWARD BOULEVARD AS SHOWN ON STATE OF FLORIDA STATE ROAD DEPARTMENT RIGHT OF WAY MAP OF STATE ROAD NO. 842, SECTION 86006-2501, DATED 7-15-1971.

THE NORTH 855.00 FEET OF LOT 7, THE NORTH 900.00 FEET OF LOT 8, AND THE NORTH 850.00 FEET OF LOT 9, W.C. VALENTINES SUBDIVISION, ACCORDING TO THE PLAT THEREOF, AS RECORDED IN PLAT BOOK B, PAGE 29 OF THE PUBLIC RECORDS OF DADE COUNTY, FLORIDA; AND LESS THEREOF THE RIGHT-OF-WAY FOR WEST BROWARD BOULEVARD AS SHOWN ON STATE OF FLORIDA STATE ROAD DEPARTMENT RIGHT OF WAY MAP OF STATE ROAD NO. 842, SECTION 86006-2501, DATED 7-15-1971.

E	BUIL	.DIN	G H	IEIC	Ж

	ALLOWED	PROVIDED
NEW BUILDING	60 FT	50 FT
	BUILDING SETBACKS	
	REQUIRED	PROVIDED
FRONT	25 FT	17'-7" COND. SPACE 11'-10" ROOF OVERHANG
SIDE	25 FT	38'-7"
REAR	25 FT	88'-6"
	FLOOD LEGEND	
HIGHEST CROWN OF ROAD (EXISTING)	PROPOSED GROUND FLOOR	ADJACENT GRADE (SIDEWALK)
4.95' (NAVD88)	8.00' (NAVD88)	4.49' (NAVD88)
PROPO	OSED SITE IMPROVEME	ENTS
	EXISTING	NEW

FLOOR AREA RATIO - FAR

0 SF

MAXIMUM FAR	NEW PROPOSED	
1.0 X 389,486 = 389,486 SF	HEADQUARTERS BUILDING 190,980 SF (NOT INCLUDING PARKING GARAGE)	

190,980 SF

222,081 SF

413,061 SF

LOT COVERAGE

ALLOWED	NEW PROPOSED	
NOT APPLICABLE	HEADQUARTERS = PARKING GARAGE = FPL VAULT =	98,480 SF 78,044 SF 2,060 SF
TOTAL NEW BU	JILDING FOOT PRINT:	178,605 SF

NEW 3 STORY BUILDING & 3 STORY PARKING GARAGE

COST OF CONSTRUCTION: SCOPE OF WORK

ITEMIZED LIST:

NEW CONSTRUCTION

COST OF CONSTRUCTION : SCOPE OF WORK

NEW (A/C) NEW (GARAGE)

NEW BUILDING - USABLE (A/C) GARAGE

TOTAL

190,980 SQ. FT. OF CONSTRUCTION 222,081 SQ. FT. OF CONSTRUCTION

TOTAL COST OF WORK: \$83,390,250

AECOM

FORT LAUDERDALE POLICE HEADQUARTERS 1300 W BROWARD BLVD, FT LAUDERDALE, FL 33312



CLIENT

CITY OF FORT LAUDERDALE **DEPARTMENT OF PUBLIC WORKS**

PRIME CONSULTANT

2 ALHAMBRA PLAZA, SUITE 900 CORAL GABLES, FL 33134 305.444.4691 tel 305.675.3843 fax http://www.aecom.com

CONSULTANTS

REGISTRATION



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4	NOV 24, 2021	75% CONSTRUCTION DOCS
3	AUG 16, 2021	DRC RESUBMIT
2	JUNE 21, 2021	DESIGN DEVELOPMENT
1	MAR 15, 2021	SCHEMATIC DESIGN

I/R DATE DESCRIPTION

KEY PLAN

PROJECT NUMBER

60639620

SHEET TITLE

ARCHITECTURAL SITE PLAN -OVERALL

SHEET NUMBER

HQ-A1-1-01

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WIDTH REQ=44" WIDTH PROV=68" * 220 WILL EXIT THROUGH STAIR 2 AND 120 THROUGH EXIT 7

CAPACITY: 220* LOAD: 120

WIDTH REQ=24" WIDTH PROV=44" * ACTUAL IS 340 - 220 IS MAX ALOWED

> SEE PARKING GARAGE DRAWINGS VOLUME 2 OF 3

LOCKERS Area: 2,099 SF

BUSINESS

Area: 5,161 SF Occupant Load: 35

MEP / STORAGE Area: 1,318 SF

Occupant Load: 5

EXERCISE AREA

Occupant Load: 63

Occupant Load: 46

Area: 3,106 SF

CLASSROOM

Area: 907 SF

KITCHEN

Area: 817 SF

CAFETERIA

Area: 1,065 SF

Area: 4,197 SF Occupancy: 280

BUSINESS Area: 933 SF Occupant Load: 7

BUSINESS

Area: 9,932 SF

CLASSROOM

Area: 2,014 SF Occupant Load: 101

ASSEMBLY Area: 284 SF Occupant Load: 19

CONCENTRATED BUSINESS

Area: 3,482 SF Occupant Load: 70

Area: 1,843 SF

Occupant Load: 7

Occupant Load: 67

NON-

ACCESSIBLE

ROOF

MAGNETIC HELD-OPEN FIRE DOORS Occupant Load: 71

Occupant Load: 5

Occupant Load: 42

HQ BLDG - LIFE SAFETY PLAN - LEVEL 2

SCALE: 1" = 30'-0" Scale: 1" = 30'-0"

LIFE SAFETY LEGEND

1 HOUR FIRE RATING • • 2-HOUR FIRE RATING 3-HOUR FIRE RATING SMOKE BARRIER (1-HOUR RATED) SMOKE PARTITION (NON-RATED) ASSUMED PROPERTY LINE EXIT ACCESS TRAVEL DISTANCE # FT. COMMON PATH COMMON PATH DISTANCE #FT. DEAD END DEAD END DISTANCE CAPACITY
LOAD
WIDTH REQUIRED=X'

EXIT WIDTH EGRESS CAPA
(NUMBER OF PERSONS) EXIT WIDTH EGRESS CAPACITY

MULTIPURPOSE FIRE EXTINGUISHER ON HOOK

SEMI RECESSED FIRE EXTINGUISHER CABINET WITH MULTIPURPOSE FIRE EXTINGUISHER. PROVIDE ONE TYPE 4A-60BC FE FOR EVERY 3000 SF. TRAVEL DISTANCE NOT TO EXCEED 75 FEET

AECOM

FORT LAUDERDALE POLICE HEADQUARTERS 1300 W BROWARD BLVD, FT LAUDERDALE, FL 33312



CLIENT

CITY OF FORT LAUDERDALE **DEPARTMENT OF PUBLIC WORKS**

PRIME CONSULTANT

2 ALHAMBRA PLAZA, SUITE 900 CORAL GABLES, FL 33134 305.444.4691 tel 305.675.3843 fax

CONSULTANTS


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REGISTRATION



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1		
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1	MAR 15, 2021	SCHEMATIC DESIGN
I/R	DATE	DESCRIPTION



PROJECT NUMBER

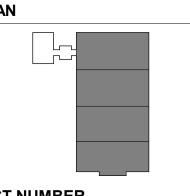
SHEET TITLE

HEADQUARTERS BLDG - LIFE SAFETY PLAN LEVEL 2

SHEET NUMBER

HQ-A1-4-20


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Page 21 of 65

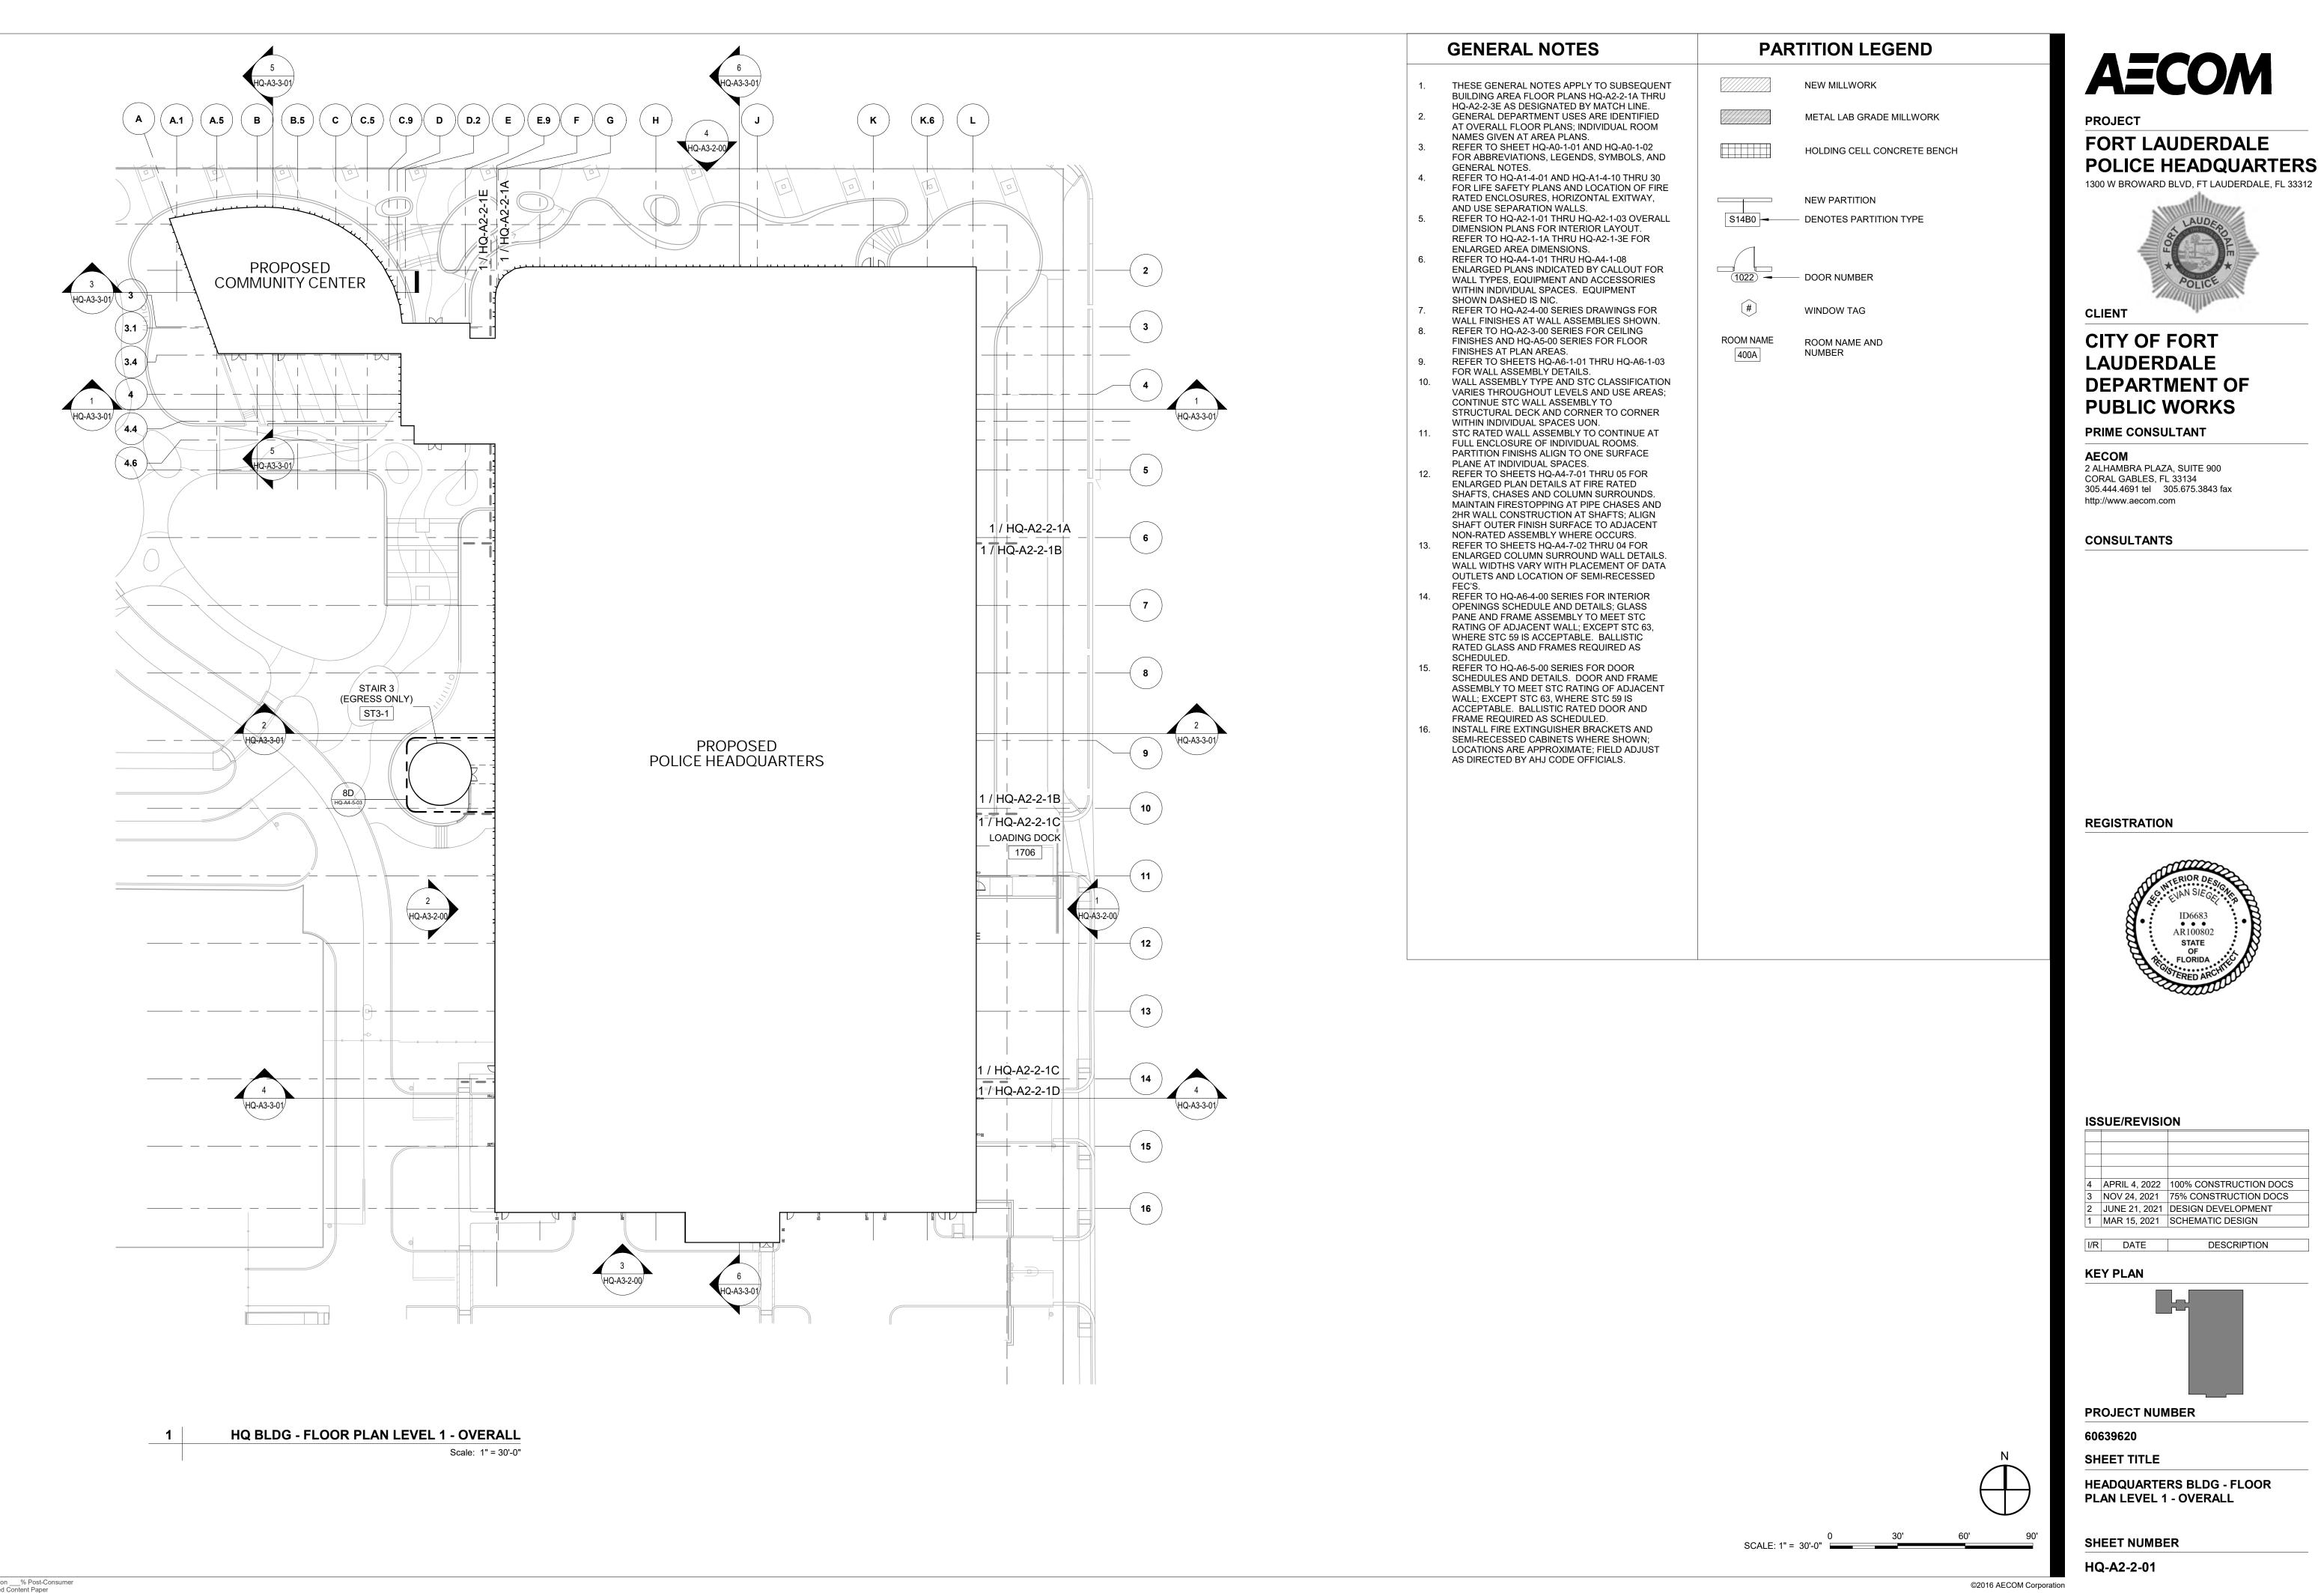DESCRIPTION

CAM #22-0702 Exhibit 2



GENERAL NOTES PARTITION LEGEND NEW MILLWORK THESE GENERAL NOTES APPLY TO SUBSEQUENT BUILDING AREA FLOOR PLANS HQ-A2-2-1A THRU HQ-A2-2-3E AS DESIGNATED BY MATCH LINE. GENERAL DEPARTMENT USES ARE IDENTIFIED METAL LAB GRADE MILLWORK AT OVERALL FLOOR PLANS; INDIVIDUAL ROOM NAMES GIVEN AT AREA PLANS. REFER TO SHEET HQ-A0-1-01 AND HQ-A0-1-02 HOLDING CELL CONCRETE BENCH FOR ABBREVIATIONS, LEGENDS, SYMBOLS, AND GENERAL NOTES. REFER TO HQ-A1-4-01 AND HQ-A1-4-10 THRU 30 FOR LIFE SAFETY PLANS AND LOCATION OF FIRE RATED ENCLOSURES, HORIZONTAL EXITWAY, **NEW PARTITION** AND USE SEPARATION WALLS. S14B0 REFER TO HQ-A2-1-01 THRU HQ-A2-1-03 OVERALL DENOTES PARTITION TYPE DIMENSION PLANS FOR INTERIOR LAYOUT. REFER TO HQ-A2-1-1A THRU HQ-A2-1-3E FOR ENLARGED AREA DIMENSIONS. REFER TO HQ-A4-1-01 THRU HQ-A4-1-08 ENLARGED PLANS INDICATED BY CALLOUT FOR — DOOR NUMBER WALL TYPES, EQUIPMENT AND ACCESSORIES WITHIN INDIVIDUAL SPACES. EQUIPMENT SHOWN DASHED IS NIC. REFER TO HQ-A2-4-00 SERIES DRAWINGS FOR WINDOW TAG WALL FINISHES AT WALL ASSEMBLIES SHOWN. REFER TO HQ-A2-3-00 SERIES FOR CEILING **ROOM NAME** ROOM NAME AND FINISHES AND HQ-A5-00 SERIES FOR FLOOR FINISHES AT PLAN AREAS. 400A NUMBER REFER TO SHEETS HQ-A6-1-01 THRU HQ-A6-1-03 FOR WALL ASSEMBLY DETAILS. WALL ASSEMBLY TYPE AND STC CLASSIFICATION VARIES THROUGHOUT LEVELS AND USE AREAS; CONTINUE STC WALL ASSEMBLY TO STRUCTURAL DECK AND CORNER TO CORNER WITHIN INDIVIDUAL SPACES UON.
STC RATED WALL ASSEMBLY TO CONTINUE AT FULL ENCLOSURE OF INDIVIDUAL ROOMS. PARTITION FINISHS ALIGN TO ONE SURFACE PLANE AT INDIVIDUAL SPACES. REFER TO SHEETS HQ-A4-7-01 THRU 05 FOR ENLARGED PLAN DETAILS AT FIRE RATED SHAFTS, CHASES AND COLUMN SURROUNDS. MAINTAIN FIRESTOPPING AT PIPE CHASES AND 2HR WALL CONSTRUCTION AT SHAFTS; ALIGN SHAFT OUTER FINISH SURFACE TO ADJACENT NON-RATED ASSEMBLY WHERE OCCURS. REFER TO SHEETS HQ-A4-7-02 THRU 04 FOR ENLARGED COLUMN SURROUND WALL DETAILS. WALL WIDTHS VARY WITH PLACEMENT OF DATA OUTLETS AND LOCATION OF SEMI-RECESSED REFER TO HQ-A6-4-00 SERIES FOR INTERIOR OPENINGS SCHEDULE AND DETAILS; GLASS PANE AND FRAME ASSEMBLY TO MEET STC RATING OF ADJACENT WALL; EXCEPT STC 63, WHERE STC 59 IS ACCEPTABLE. BALLISTIC RATED GLASS AND FRAMES REQUIRED AS SCHEDULED. REFER TO HQ-A6-5-00 SERIES FOR DOOR SCHEDULES AND DETAILS. DOOR AND FRAME ASSEMBLY TO MEET STC RATING OF ADJACENT WALL; EXCEPT STC 63, WHERE STC 59 IS ACCEPTABLE. BALLISTIC RATED DOOR AND FRAME REQUIRED AS SCHEDULED. INSTALL FIRE EXTINGUISHER BRACKETS AND SEMI-RECESSED CABINETS WHERE SHOWN; LOCATIONS ARE APPROXIMATE; FIELD ADJUST AS DIRECTED BY AHJ CODE OFFICIALS.

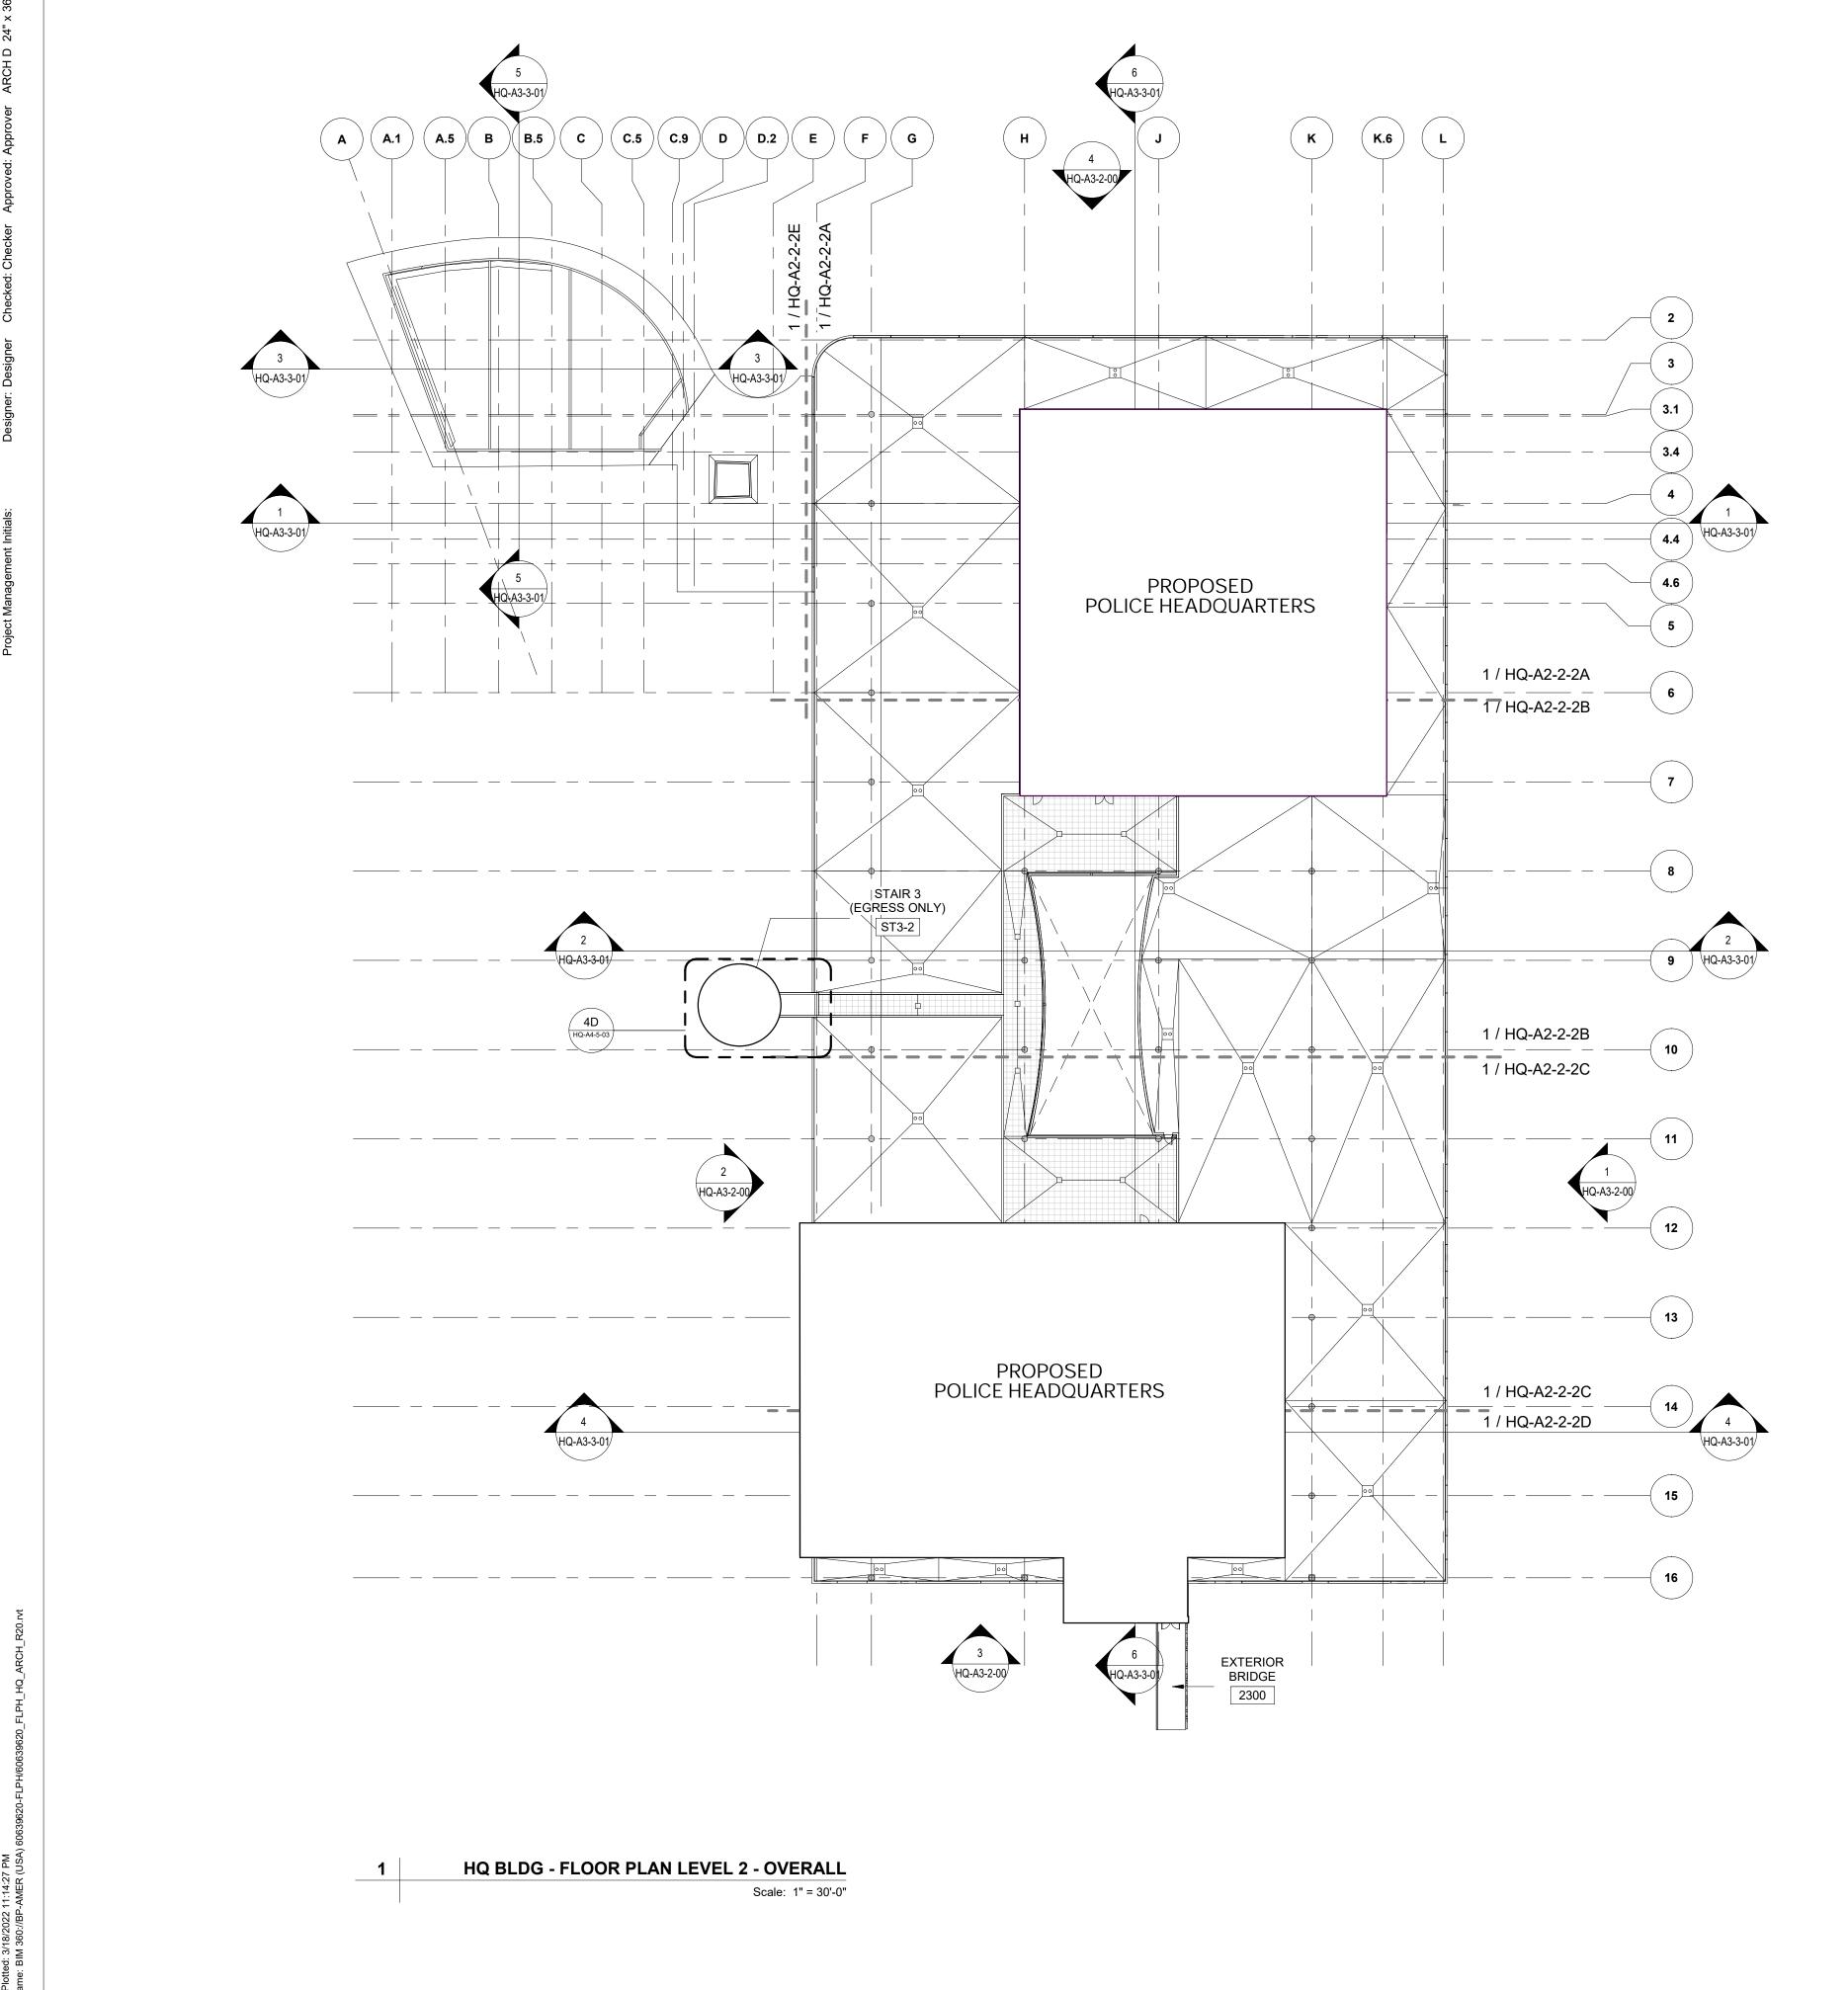AECOM

PROJECT

FORT LAUDERDALE POLICE HEADQUARTERS



1300 W BROWARD BLVD, FT LAUDERDALE, FL 33312

CLIENT

CITY OF FORT LAUDERDALE **DEPARTMENT OF PUBLIC WORKS**

PRIME CONSULTANT


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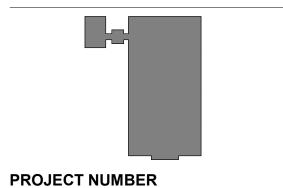
REGISTRATION



ISSUE/REVISION



DESCRIPTION I/R DATE

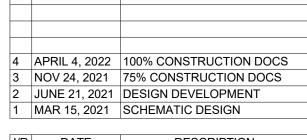

60639620

SHEET TITLE

HEADQUARTERS BLDG - FLOOR PLAN LEVEL 2 - OVERALL

SHEET NUMBER

HQ-A2-2-02

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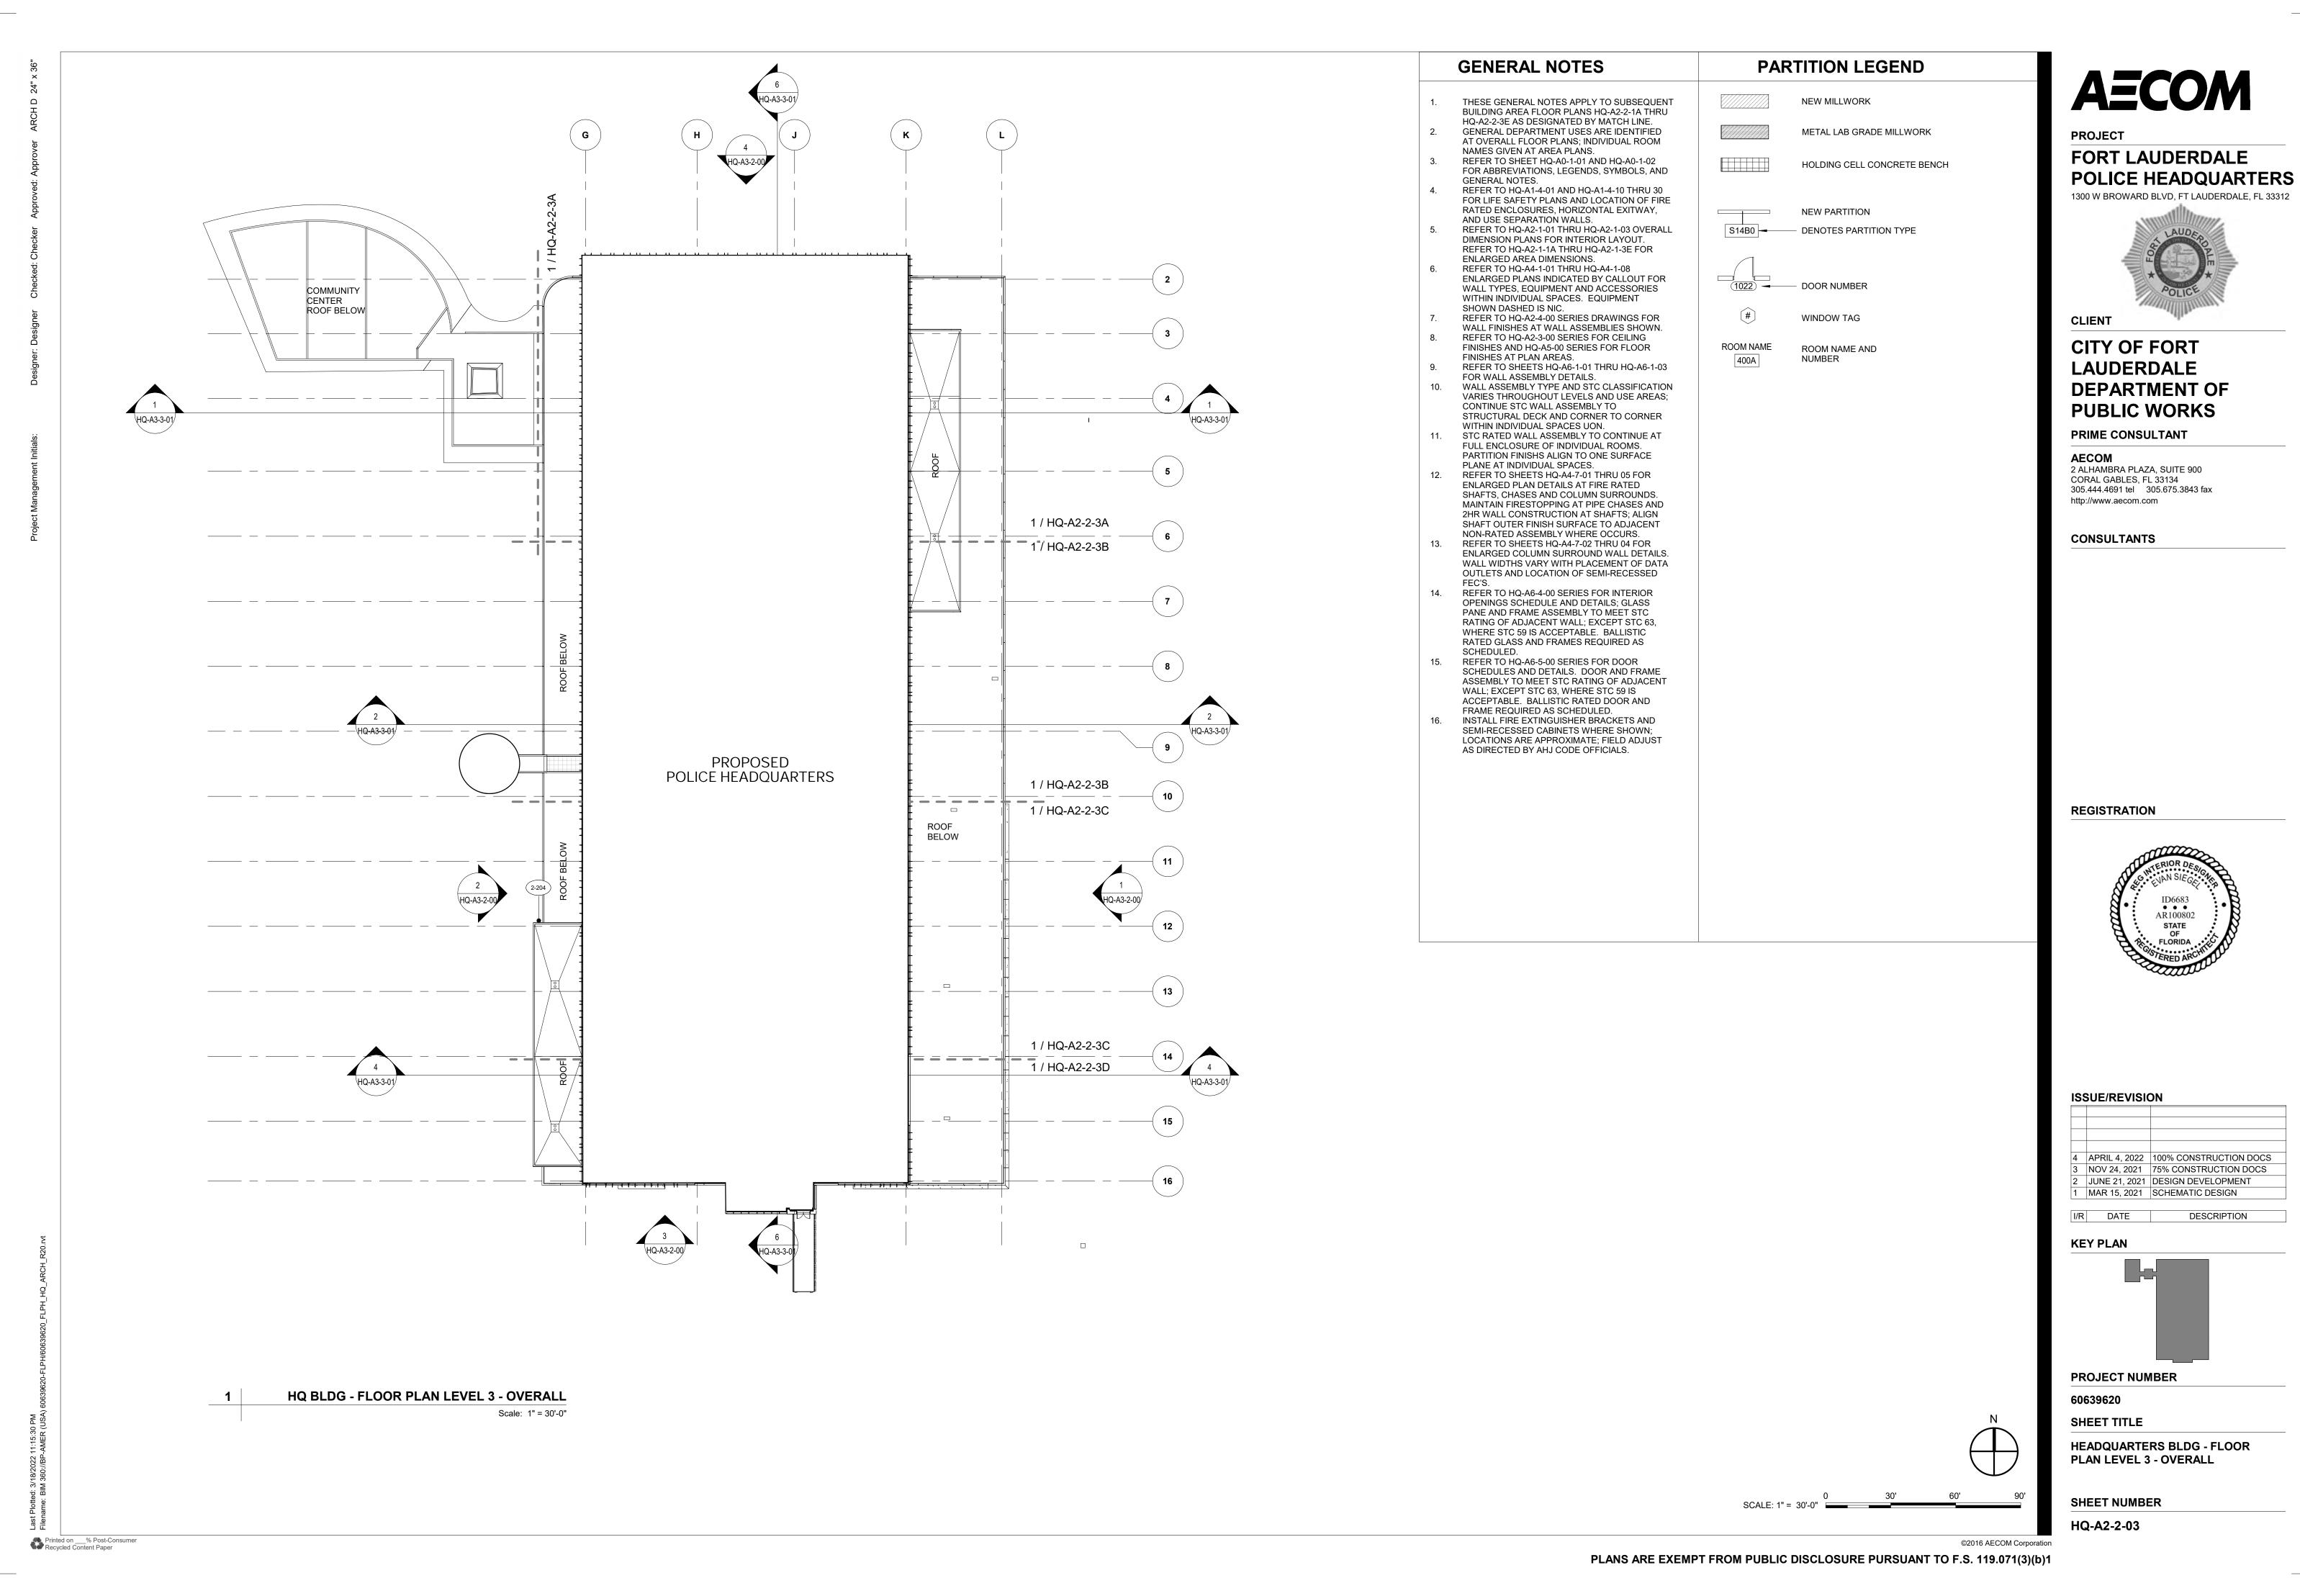
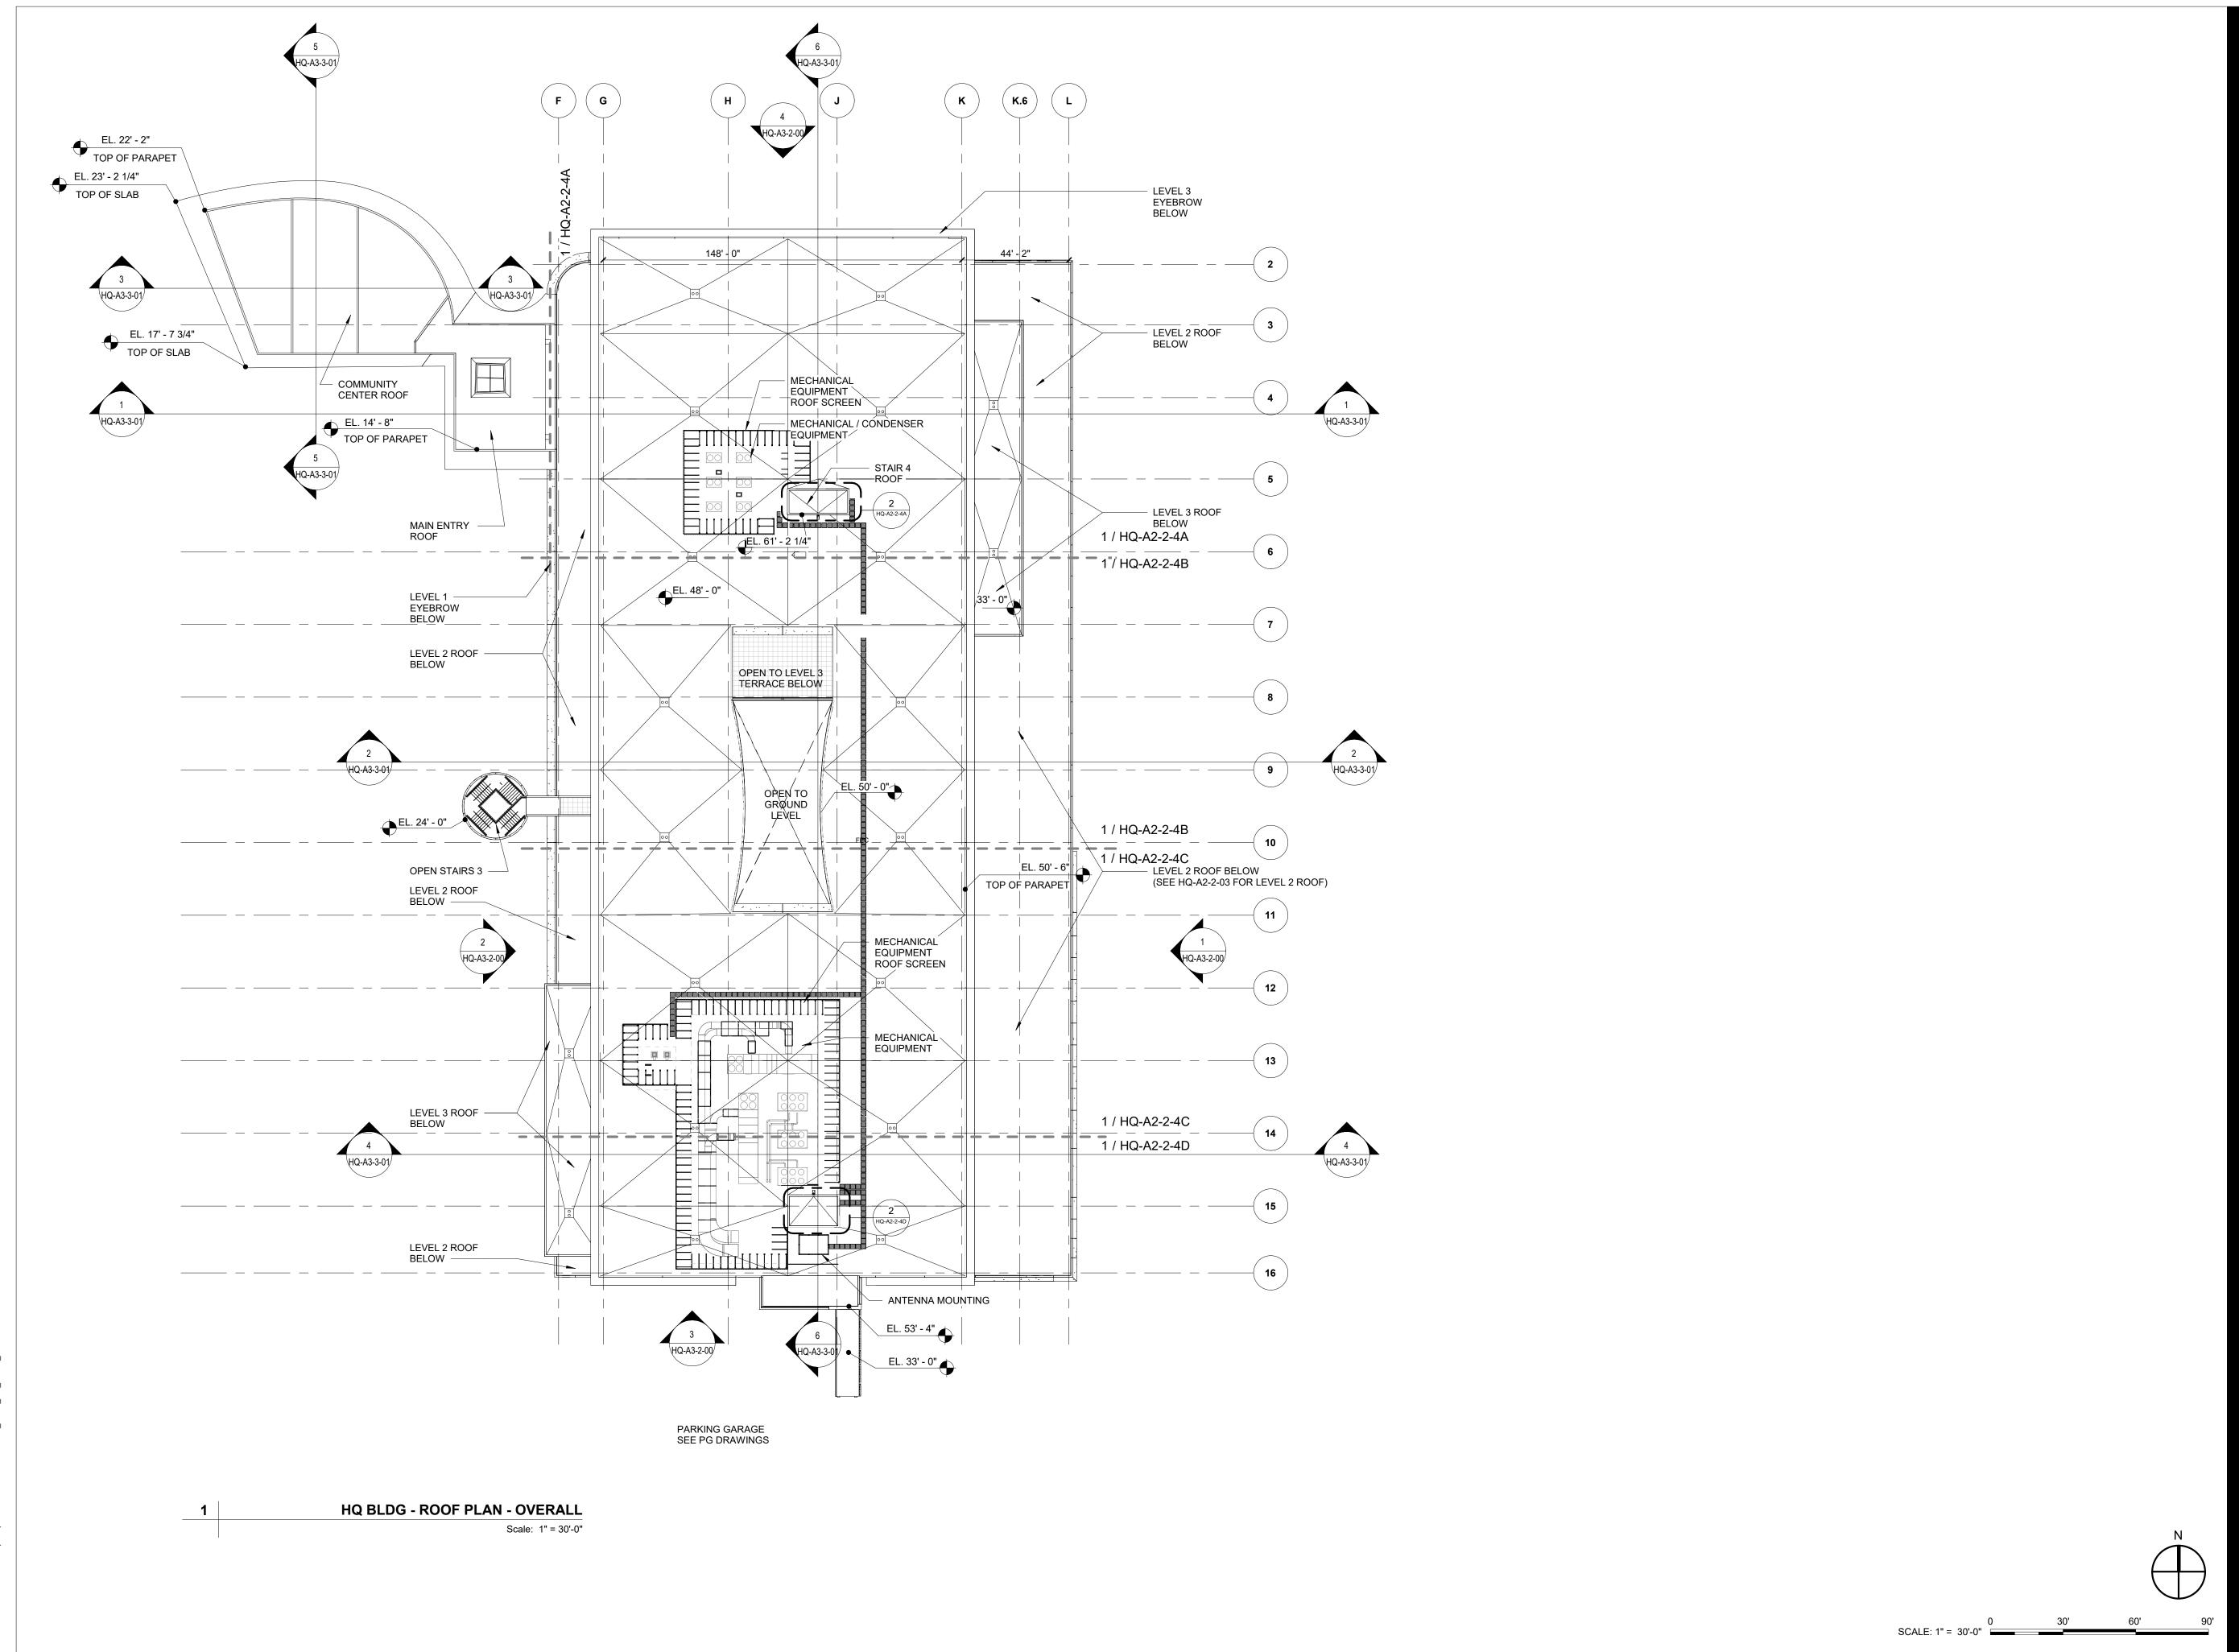


Exhibit 2



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PROJECT

FORT LAUDERDALE POLICE HEADQUARTERS



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CITY OF FORT LAUDERDALE **DEPARTMENT OF PUBLIC WORKS**

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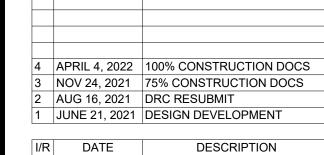
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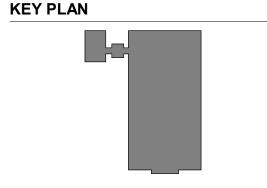
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PROJECT NUMBER

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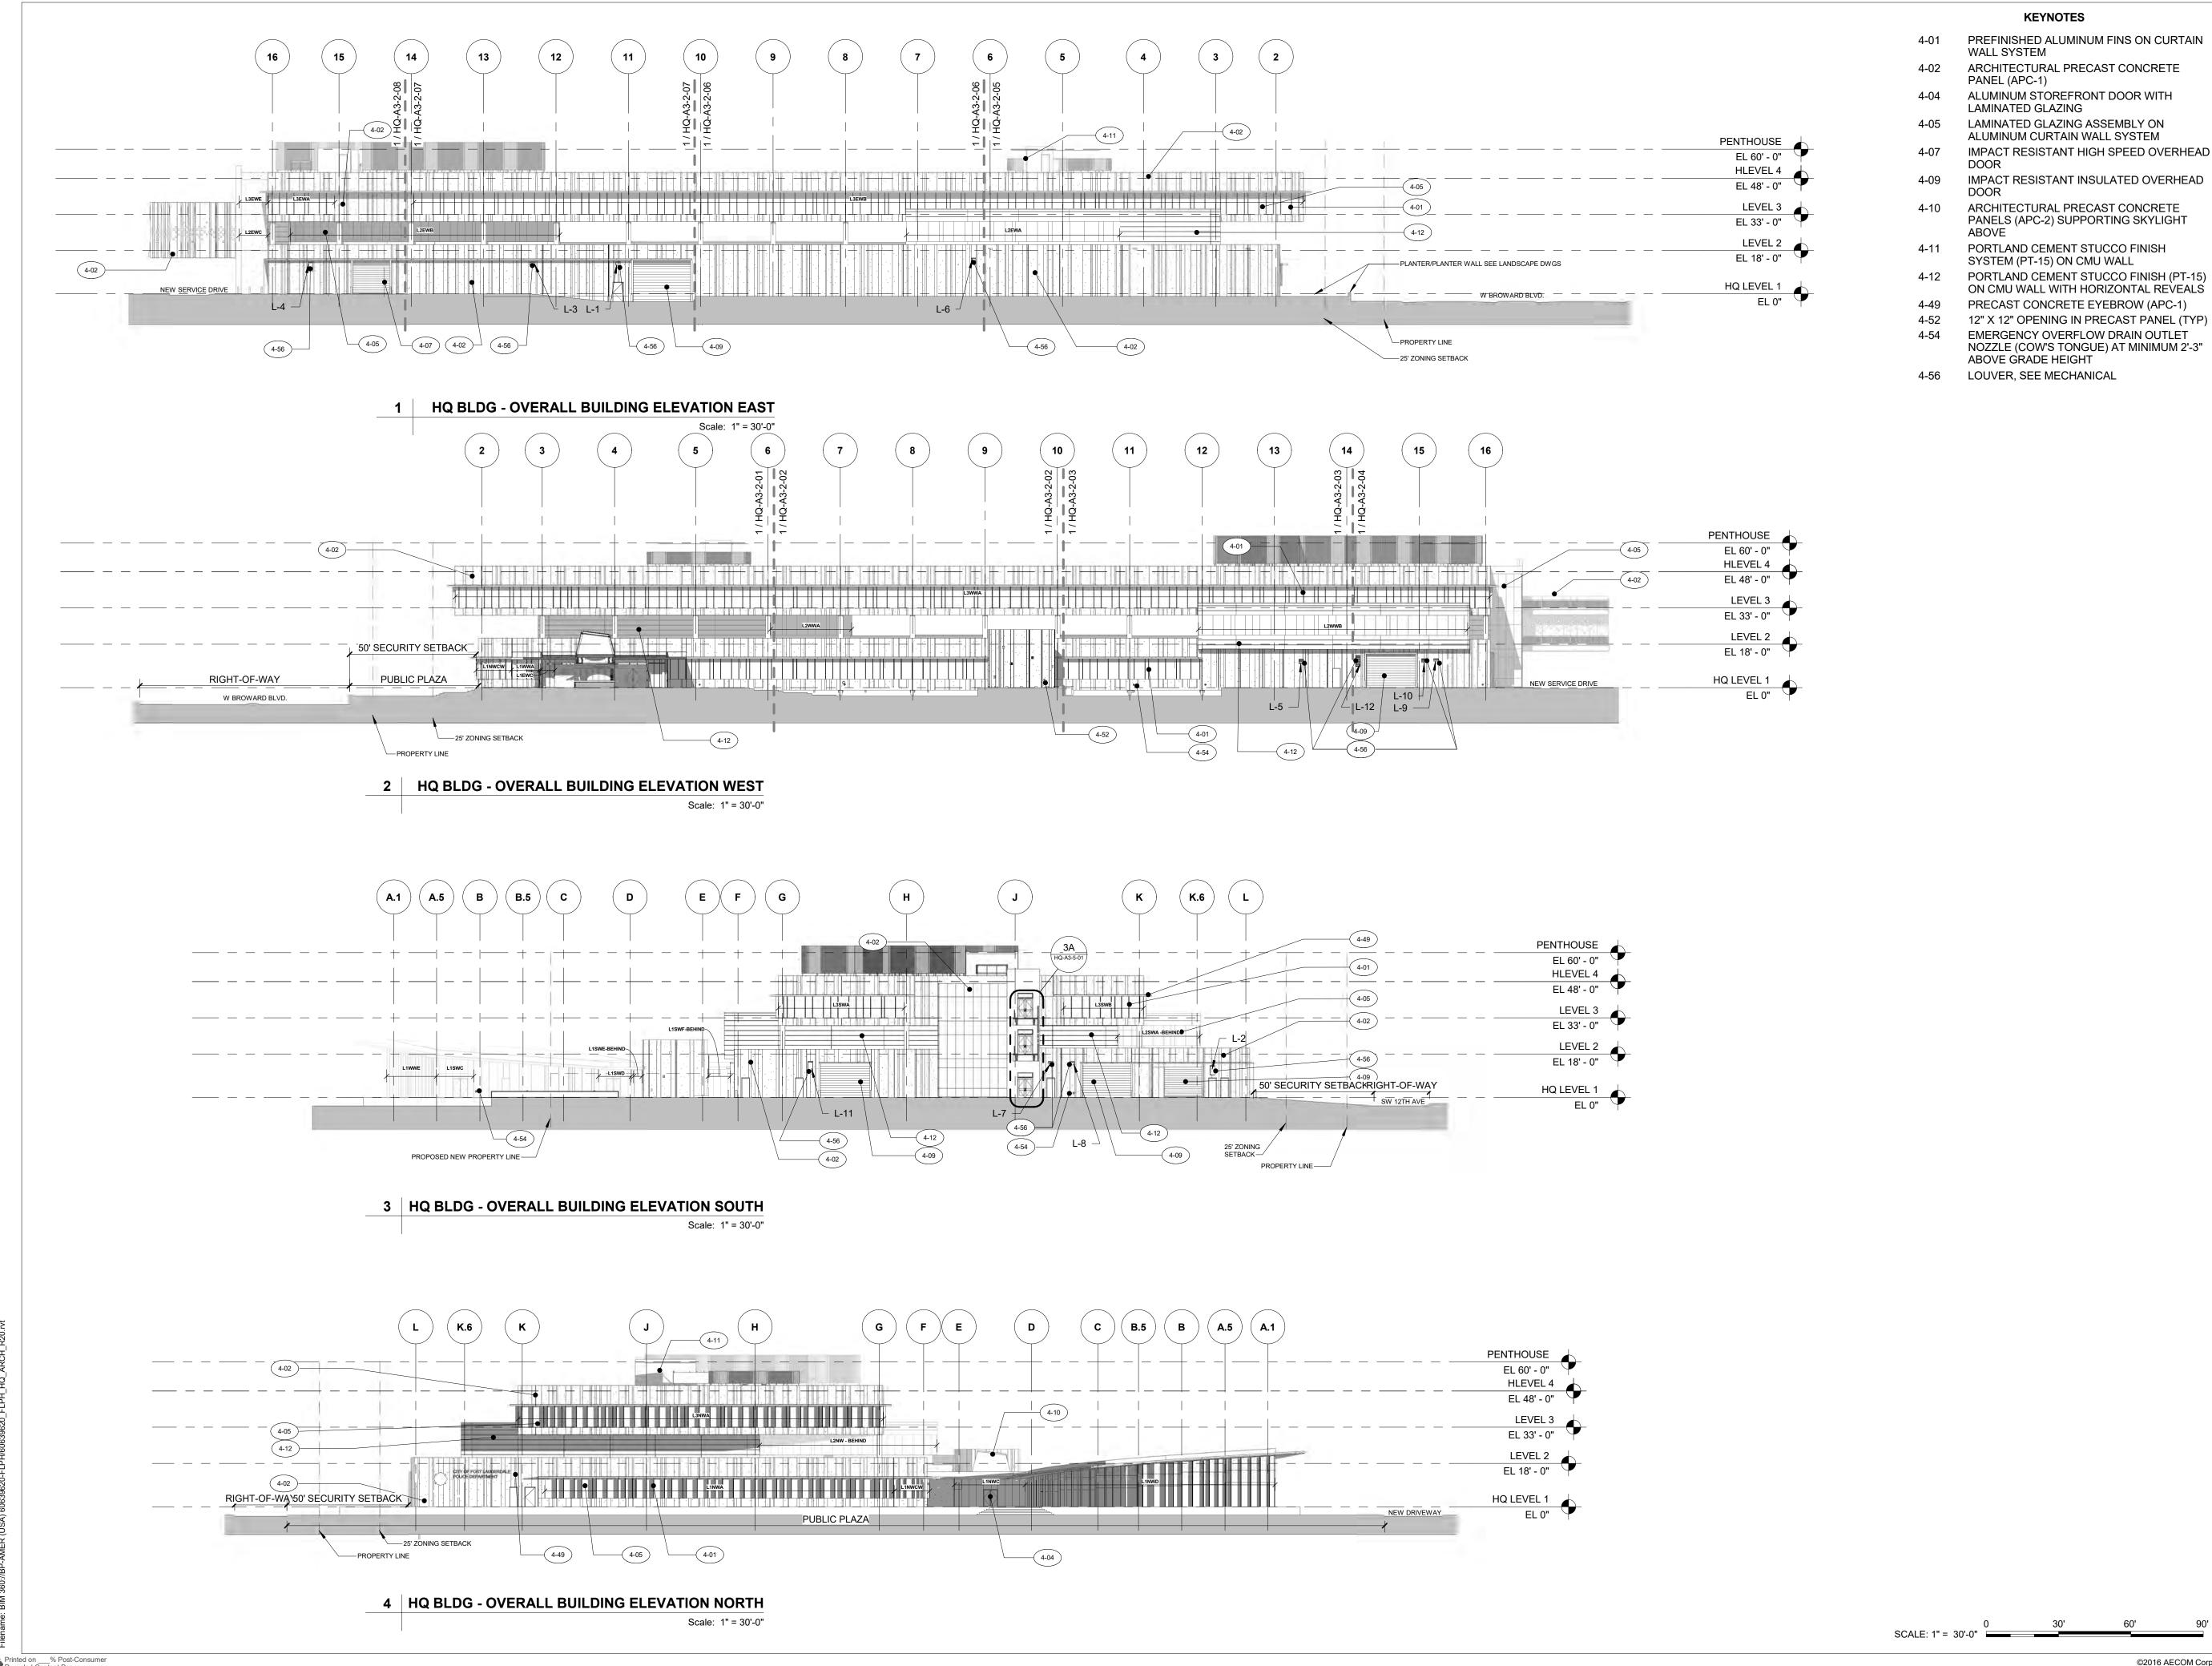
SHEET TITLE

HEADQUARTERS BLDG - ROOF PLAN - OVERALL

SHEET NUMBER

HQ-A2-2-04

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ALUMINUM STOREFRONT DOOR WITH

LAMINATED GLAZING

LAMINATED GLAZING ASSEMBLY ON ALUMINUM CURTAIN WALL SYSTEM

IMPACT RESISTANT INSULATED OVERHEAD

ARCHITECTURAL PRECAST CONCRETE PANELS (APC-2) SUPPORTING SKYLIGHT

SYSTEM (PT-15) ON CMU WALL PORTLAND CEMENT STUCCO FINISH (PT-15) ON CMU WALL WITH HORIZONTAL REVEALS

PRECAST CONCRETE EYEBROW (APC-1) 12" X 12" OPENING IN PRECAST PANEL (TYP) EMERGENCY OVERFLOW DRAIN OUTLET NOZZLE (COW'S TONGUE) AT MINIMUM 2'-3"

4-56 LOUVER, SEE MECHANICAL

PROJECT

FORT LAUDERDALE POLICE HEADQUARTERS 1300 W BROWARD BLVD, FT LAUDERDALE, FL 33312



CLIENT

CITY OF FORT LAUDERDALE **DEPARTMENT OF PUBLIC WORKS**

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DESCRIPTION I/R DATE

KEY PLAN

PROJECT NUMBER

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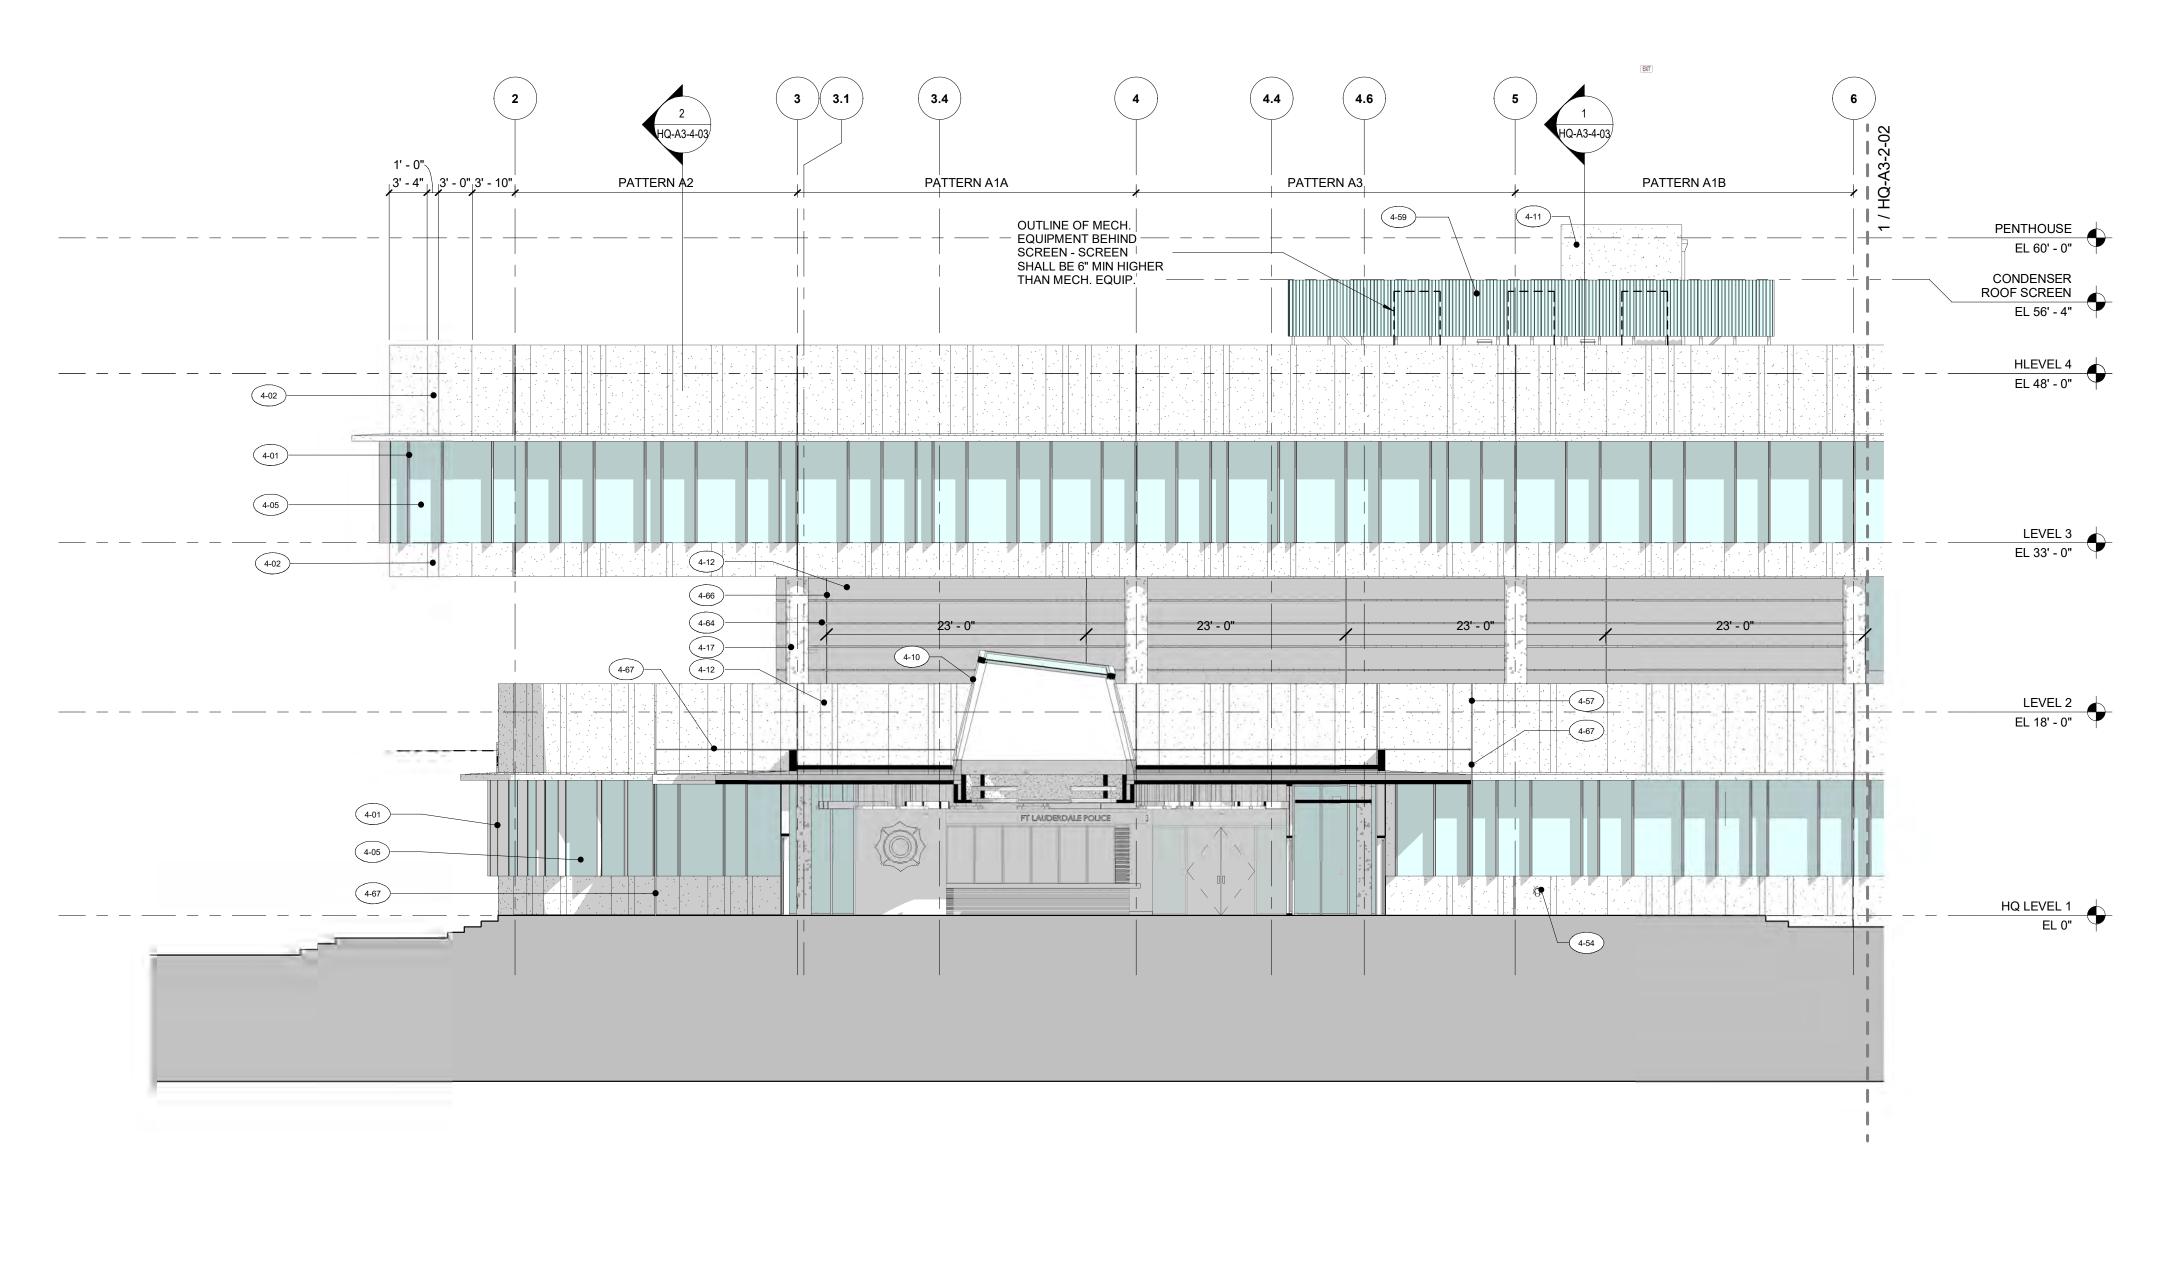
SHEET TITLE

HEADQUARTERS BLDG - BUILDING ELEVATIONS - OVERALL

SHEET NUMBER

1 ENLARGED BUILDING ELEVATION - WEST AREA A

Scale: 1/8" = 1'-0"



KEYNOTES

- 4-01 PREFINISHED ALUMINUM FINS ON CURTAIN WALL SYSTEM
- ARCHITECTURAL PRECAST CONCRETE
- PANEL (APC-1) LAMINATED GLAZING ASSEMBLY ON
- ALUMINUM CURTAIN WALL SYSTEM 4-10 ARCHITECTURAL PRECAST CONCRETE PANELS (APC-2) SUPPORTING SKYLIGHT
- 4-11 PORTLAND CEMENT STUCCO FINISH SYSTEM (PT-15) ON CMU WALL
- 4-12 PORTLAND CEMENT STUCCO FINISH (PT-15)
 - ON CMU WALL WITH HORIZONTAL REVEALS SKIM COAT PORTLAND CEMENT STUCCO (PT-14) OVER CONCRETE COLUMN
- EMERGENCY OVERFLOW DRAIN OUTLET NOZZLE (COW'S TONGUE) AT MINIMUM 2'-3" ABOVE GRADE HEIGHT
- ARCHITECTURAL PRECAST CONCRETE PANEL JOINT, TYP
- MECHANICAL EQUIPMENT ROOF SCREEN (DELEGATED DESIGN – SEE SPEC)
- 1-1/2" HORIZONTAL STUCCO REVEAL, TYP
- 3/8" CONTROL JOINT THRU STUCCO AND CMU WALL
- 1" PRECOMPRESSED FOAM SEAL EXPANSION JOINT WITH COLOR CAP

PROJECT

FORT LAUDERDALE POLICE HEADQUARTERS 1300 W BROWARD BLVD, FT LAUDERDALE, FL 33312



CLIENT

CITY OF FORT LAUDERDALE **DEPARTMENT OF PUBLIC WORKS**

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l/R	DATE	DESCRIPTION

KEY PLAN


PROJECT NUMBER

60639620

SHEET TITLE

HEADQUARTERS BLDG - BUILDING **ELEVATION WEST - ENLARGED**

SHEET NUMBER

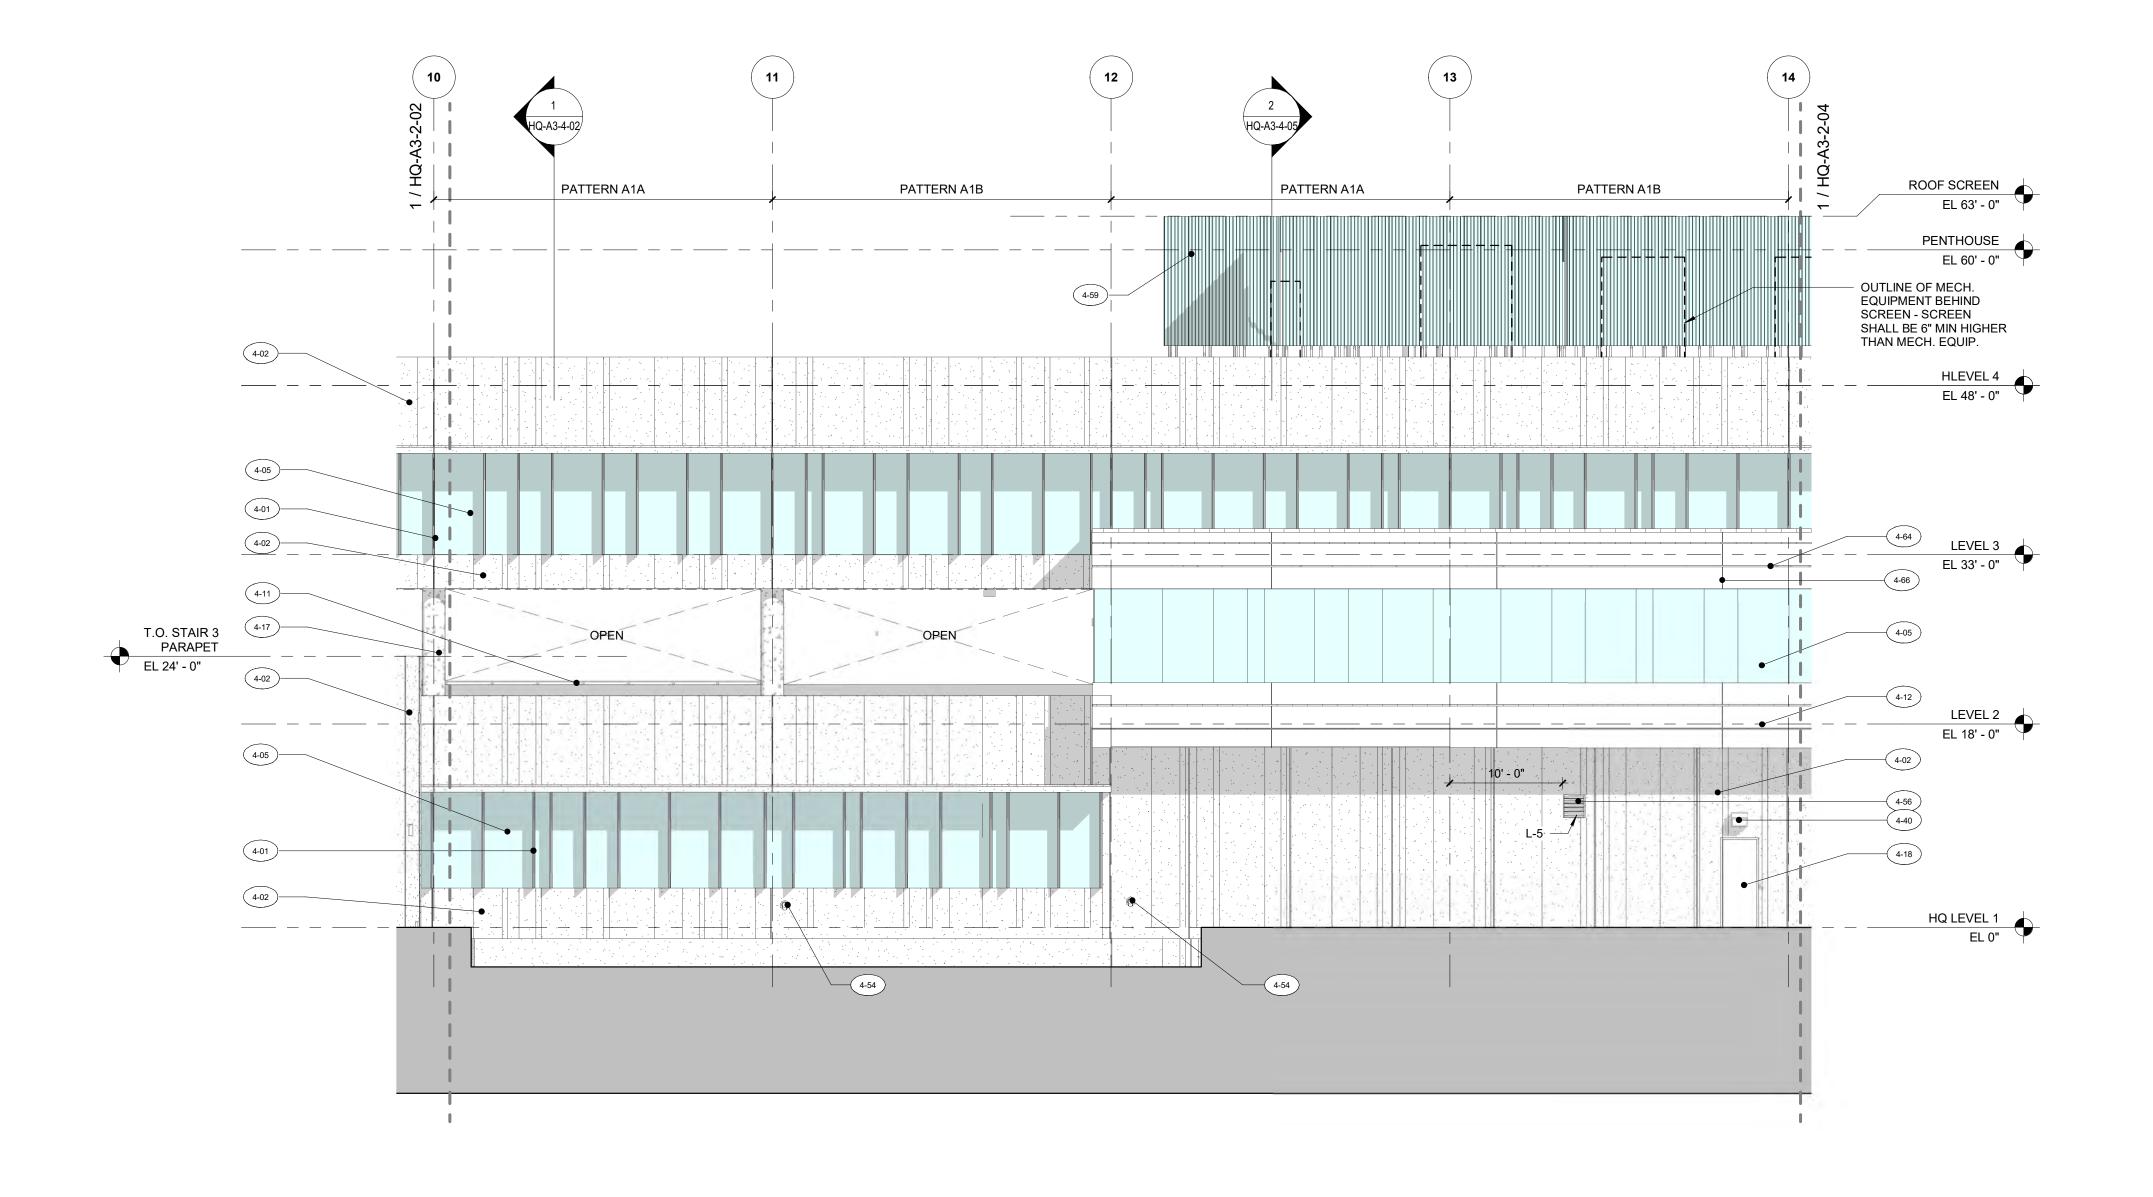

1 ENLARGED BUILDING ELEVATION - WEST AREA C

Scale: 1/8" = 1'-0"

KEYNOTES

- 4-01 PREFINISHED ALUMINUM FINS ON CURTAIN WALL SYSTEM
- ARCHITECTURAL PRECAST CONCRETE
- PANEL (APC-1) LAMINATED GLAZING ASSEMBLY ON
- ALUMINUM CURTAIN WALL SYSTEM PORTLAND CEMENT STUCCO FINISH
- SYSTEM (PT-15) ON CMU WALL PORTLAND CEMENT STUCCO FINISH (PT-15) ON CMU WALL WITH HORIZONTAL REVEALS
- SKIM COAT PORTLAND CEMENT STUCCO (PT-14) OVER CONCRETE COLUMN
- IMPACT RESISTANT HOLLOW METAL DOOR
- LIGHT FIXTURE, SEE ELECTRICAL DRAWINGS EMERGENCY OVERFLOW DRAIN OUTLET
- NOZZLE (COW'S TONGUE) AT MINIMUM 2'-3" ABOVE GRADE HEIGHT 4-56 LOUVER, SEE MECHANICAL
- MECHANICAL EQUIPMENT ROOF SCREEN (DELEGATED DESIGN – SEE SPEC)
- 1-1/2" HORIZONTAL STUCCO REVEAL, TYP
- 3/8" CONTROL JOINT THRU STUCCO AND CMU WALL

CLIENT

PROJECT

CITY OF FORT LAUDERDALE **DEPARTMENT OF PUBLIC WORKS**

FORT LAUDERDALE

POLICE HEADQUARTERS

1300 W BROWARD BLVD, FT LAUDERDALE, FL 33312

PRIME CONSULTANT

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DESCRIPTION

KEY PLAN

PROJECT NUMBER

60639620

SHEET TITLE

HEADQUARTERS BLDG - BUILDING ELEVATION WEST - ENLARGED

SHEET NUMBER

1 ENLARGED BUILDING ELEVATION - WEST AREA D

Scale: 1/8" = 1'-0"

KEYNOTES

- 4-01 PREFINISHED ALUMINUM FINS ON CURTAIN WALL SYSTEM
- ARCHITECTURAL PRECAST CONCRETE
- PANEL (APC-1) LAMINATED GLAZING ASSEMBLY ON
- ALUMINUM CURTAIN WALL SYSTEM IMPACT RESISTANT INSULATED OVERHEAD
- PORTLAND CEMENT STUCCO FINISH
- SYSTEM (PT-15) ON CMU WALL 4-12 PORTLAND CEMENT STUCCO FINISH (PT-15) ON CMU WALL WITH HORIZONTAL REVEALS
- 4-34 BOLLARD
- LIGHT FIXTURE, SEE ELECTRICAL DRAWINGS
- EMERGENCY OVERFLOW DRAIN OUTLET NOZZLE (COW'S TONGUE) AT MINIMUM 2'-3" ABOVE GRADE HEIGHT
- 4-56 LOUVER, SEE MECHANICAL
- ARCHITECTURAL PRECAST CONCRETE PANEL JOINT, TYP
- ARCHITECTURAL PRECAST CONCRETE PANEL REVEAL, TYP ALIGN VERTICALLY ENTIRE HEIGHT OF BUILDING
- 4-59 MECHANICAL EQUIPMENT ROOF SCREEN (DELEGATED DESIGN – SEE SPEC)
- HD GALV. STEEL GUARDRAIL W/METAL MESH INFILL PANEL
- 1-1/2" HORIZONTAL STUCCO REVEAL, TYP 3/8" CONTROL JOINT THRU STUCCO AND
- CMU WALL

PROJECT

FORT LAUDERDALE POLICE HEADQUARTERS 1300 W BROWARD BLVD, FT LAUDERDALE, FL 33312



CLIENT

CITY OF FORT LAUDERDALE **DEPARTMENT OF PUBLIC WORKS**

PRIME CONSULTANT

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2	NOV 24, 2021	75% CONSTRUCTION DOCS
1	JUNE 21, 2021	DESIGN DEVELOPMENT

I/R DATE DESCRIPTION

KEY PLAN

PROJECT NUMBER

60639620

SHEET TITLE

HEADQUARTERS BLDG - BUILDING ELEVATION WEST - ENLARGED

SHEET NUMBER

KEYNOTES

- 4-01 PREFINISHED ALUMINUM FINS ON CURTAIN WALL SYSTEM
- ARCHITECTURAL PRECAST CONCRETE
- PANEL (APC-1) LAMINATED GLAZING ASSEMBLY ON
- ALUMINUM CURTAIN WALL SYSTEM IMPACT RESISTANT INSULATED OVERHEAD
- SKIM COAT PORTLAND CEMENT STUCCO (PT-14) OVER CONCRETE COLUMN IMPACT RESISTANT HOLLOW METAL DOOR
- 4-34 BOLLARD
- LIGHT FIXTURE, SEE ELECTRICAL DRAWINGS
- PRECAST CONCRETE EYEBROW (APC-1)
- LOUVER, SEE MECHANICAL
- MECHANICAL EQUIPMENT ROOF SCREEN (DELEGATED DESIGN SEE SPEC)

PROJECT

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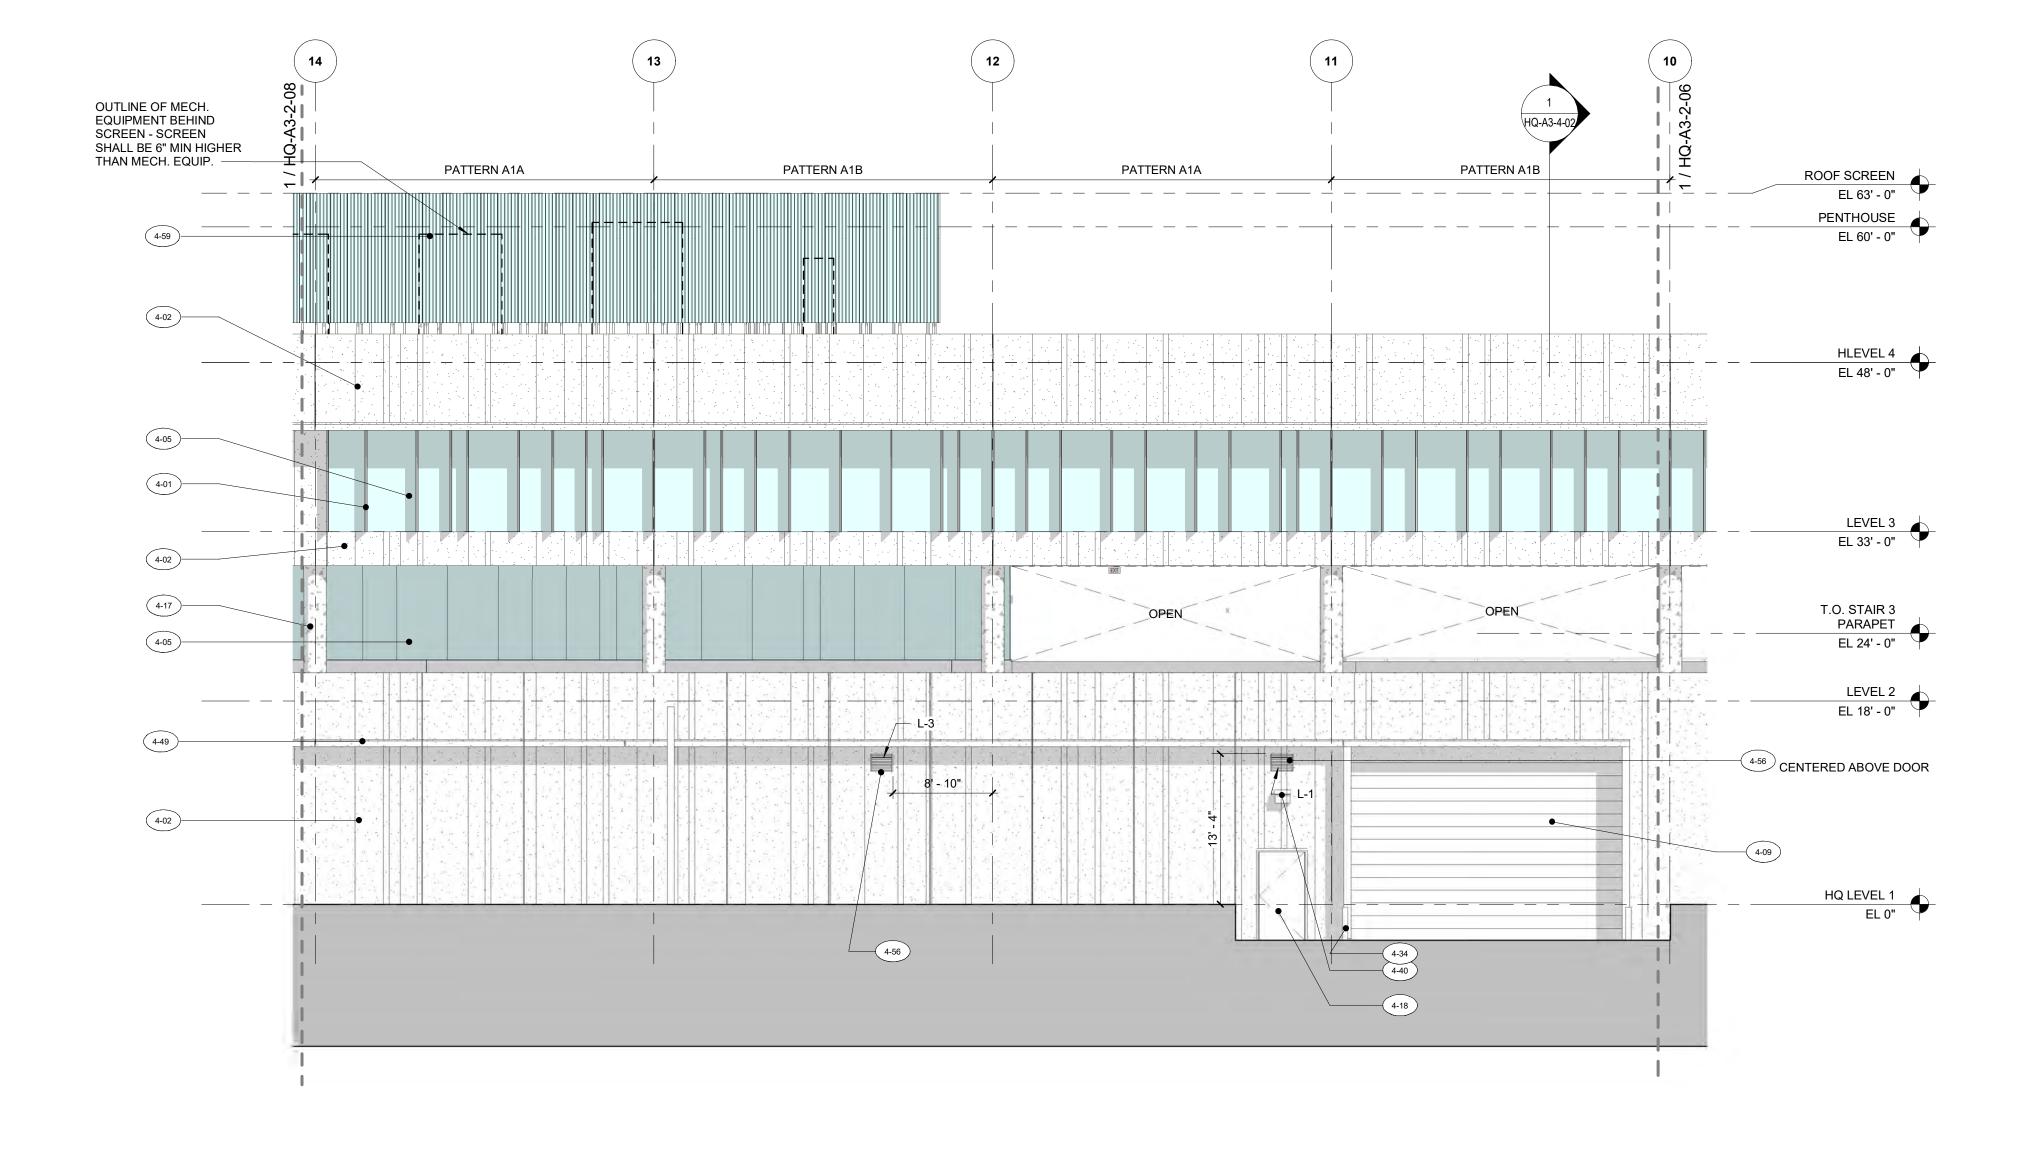
PROJECT NUMBER

60639620

SHEET TITLE

HEADQUARTERS BLDG - BUILDING **ELEVATION EAST - ENLARGED**

SHEET NUMBER



1 ENLARGED BUILDING ELEVATION - EAST AREA C

SHALL BE 6" MIN HIGHER THAN MECH. EQUIP. HQ-A3-4-01 PATTERN A4 PATTERN A1B ROOF SCREEN EL 63' - 0" PENTHOUSE EL 60' - 0" 4-51 4-02 HLEVEL 4 EL 48' - 0" 4-02 4-02 LEVEL 3
EL 33' - 0" LEVEL 2 EL 18' - 0" HQ LEVEL 1

1 ENLARGED BUILDING ELEVATION - EAST AREA D Scale: 1/8" = 1'-0"

PLANS ARE EXEMPT FROM PUBLIC DISCLOSURE PURSUANT TO F.S. 119.071(3)(b)1

KEYNOTES

- 4-01 PREFINISHED ALUMINUM FINS ON CURTAIN WALL SYSTEM
- ARCHITECTURAL PRECAST CONCRETE PANEL (APC-1)
- LAMINATED GLAZING ASSEMBLY ON ALUMINUM CURTAIN WALL SYSTEM
- PORTLAND CEMENT STUCCO FINISH SYSTEM (PT-15) ON CMU WALL
- PORTLAND CEMENT STUCCO FINISH (PT-15) ON CMU WALL WITH HORIZONTAL REVEALS SKIM COAT PORTLAND CEMENT STUCCO
- (PT-14) OVER CONCRETE COLUMN 4-34 BOLLARD
- PRECAST CONCRETE EYEBROW (APC-1) ARCHITECTURAL FINISHED CAST-IN-PLACE
- CONCRETE (PT-14) 4-56 LOUVER, SEE MECHANICAL
- ARCHITECTURAL PRECAST CONCRETE PANEL JOINT, TYP
- ARCHITECTURAL PRECAST CONCRETE PANEL REVEAL, TYP ALIGN VERTICALLY ENTIRE HEIGHT OF BUILDING 4-59 MECHANICAL EQUIPMENT ROOF SCREEN
- (DELEGATED DESIGN SEE SPEC) 1-1/2" HORIZONTAL STUCCO REVEAL, TYP
- 3/8" CONTROL JOINT THRU STUCCO AND
- CMU WALL
- 4-68 HOSE BIB, SEE PLUMBING

OUTLINE OF MECH.

EQUIPMENT BEHIND SCREEN - SCREEN

PROJECT

FORT LAUDERDALE POLICE HEADQUARTERS 1300 W BROWARD BLVD, FT LAUDERDALE, FL 33312



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I/R DATE DESCRIPTION

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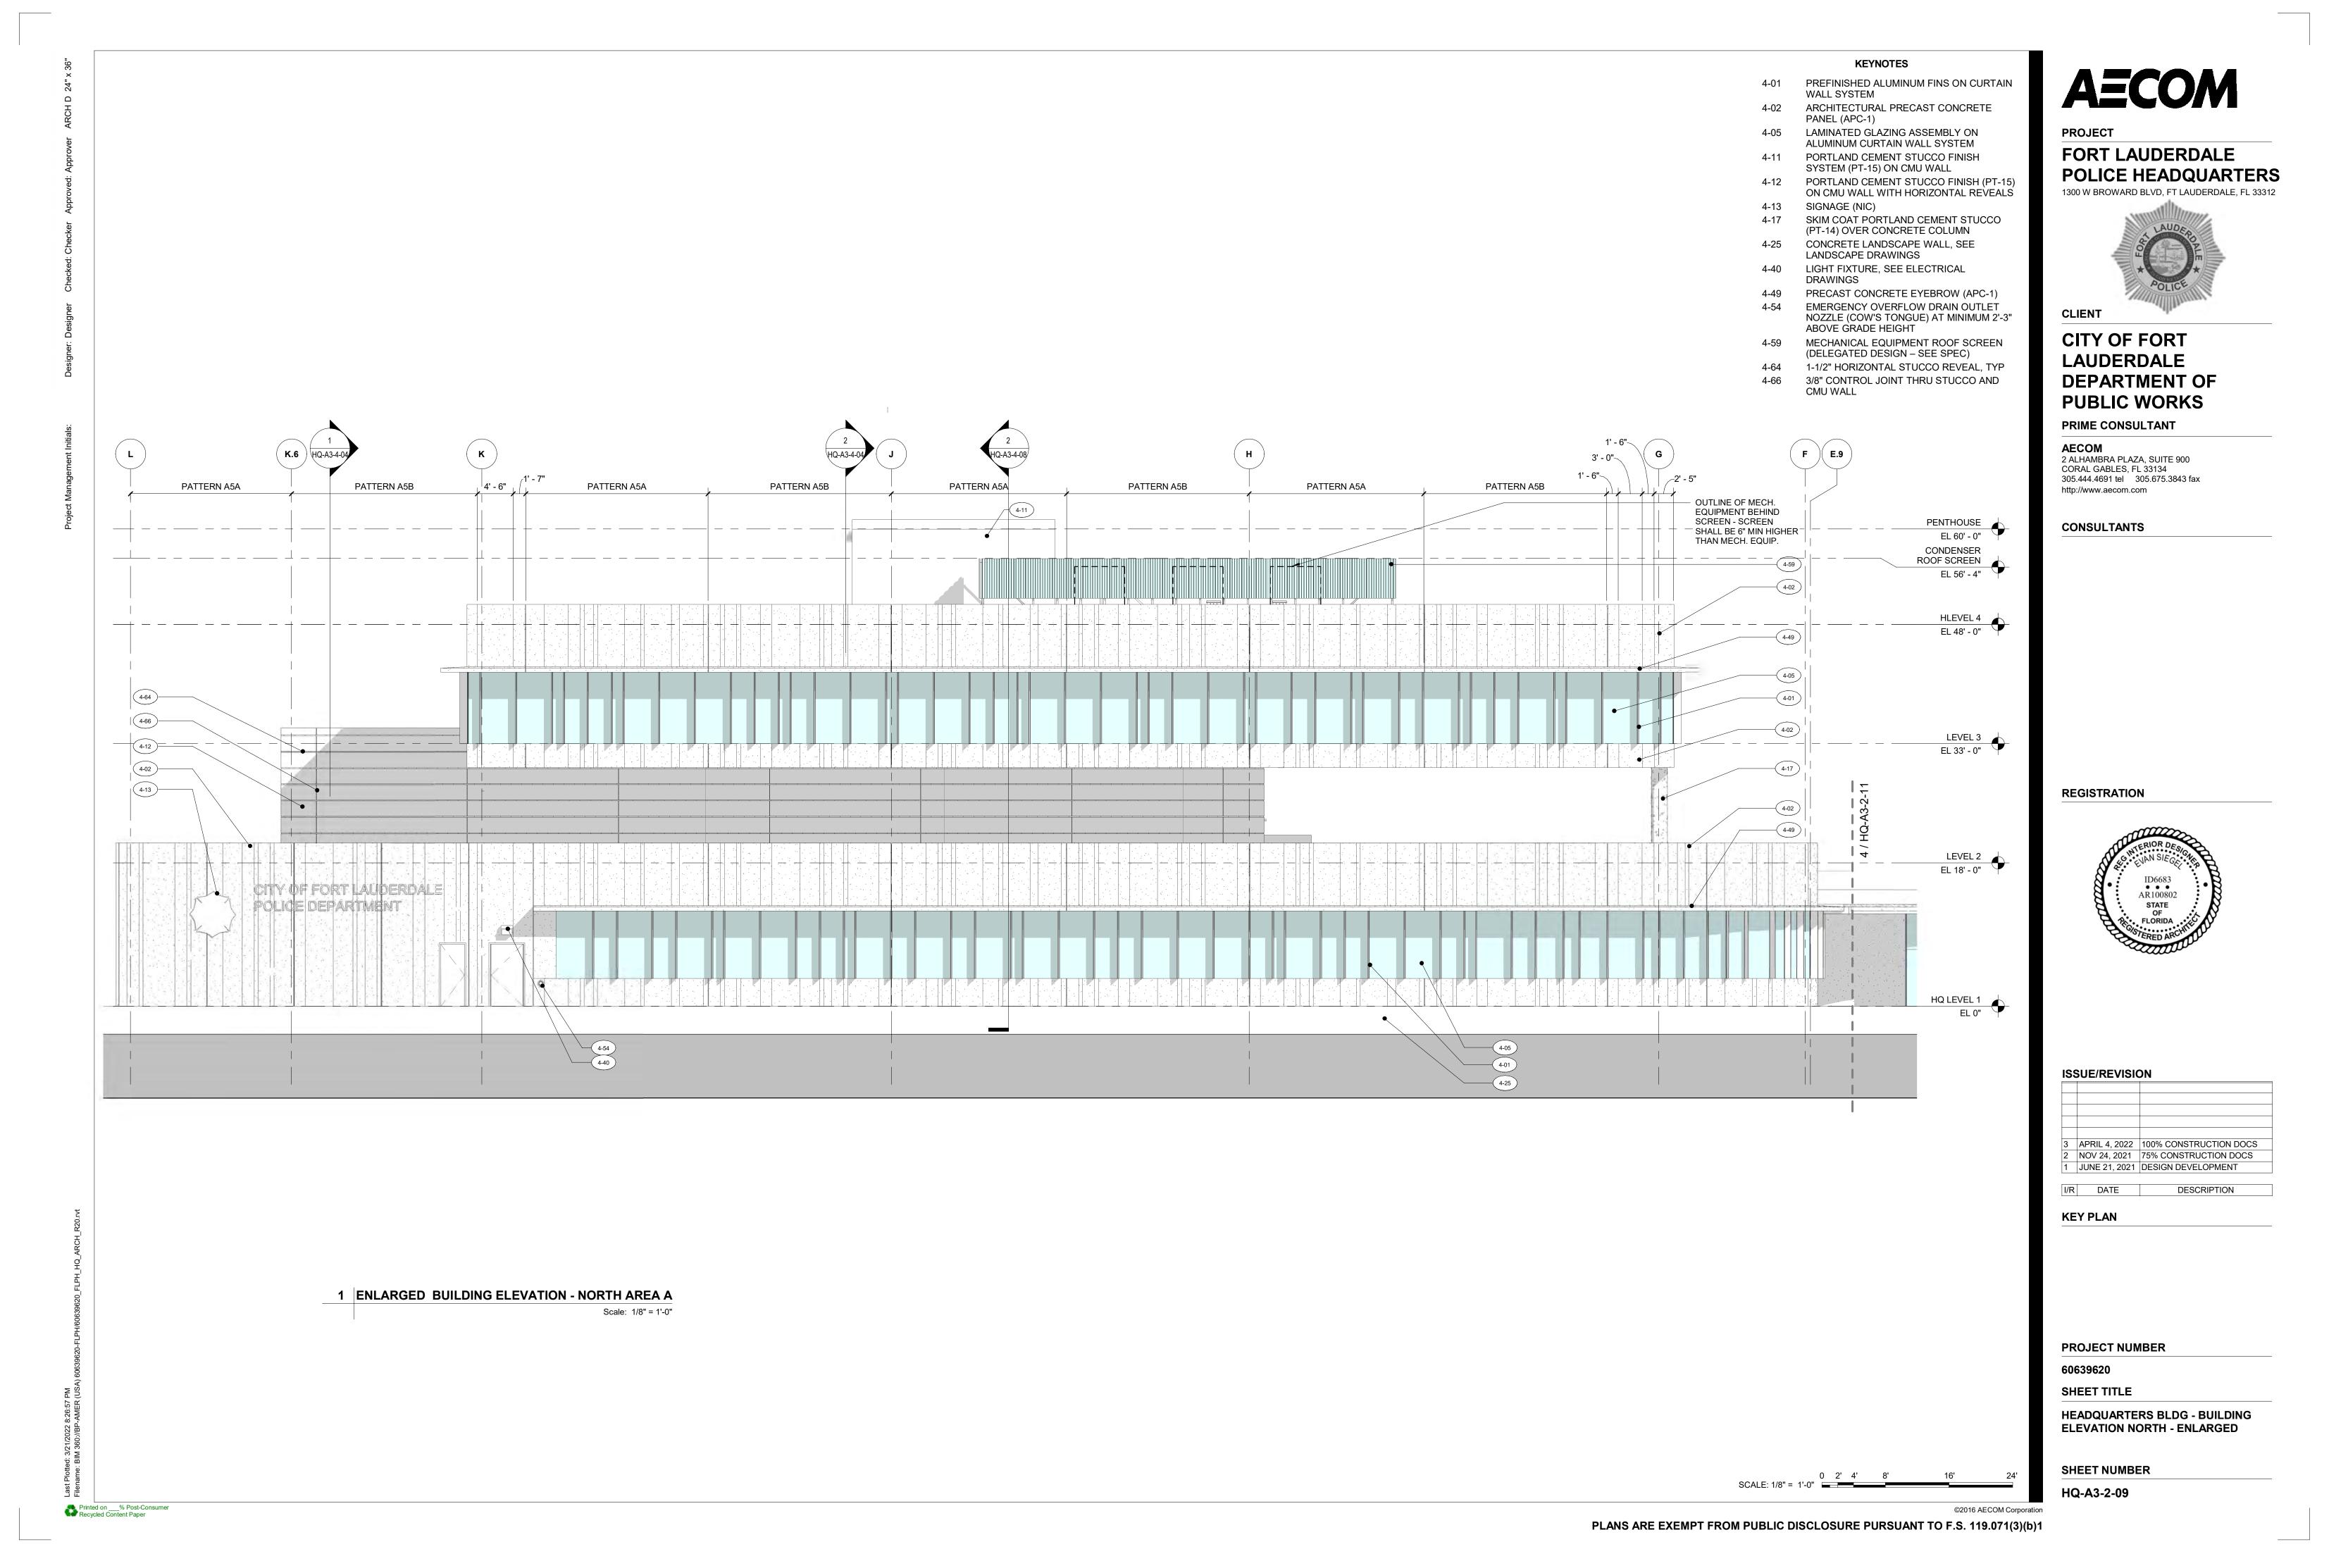
PROJECT NUMBER


60639620


SHEET TITLE

HEADQUARTERS BLDG - BUILDING ELEVATION EAST - ENLARGED

SHEET NUMBER



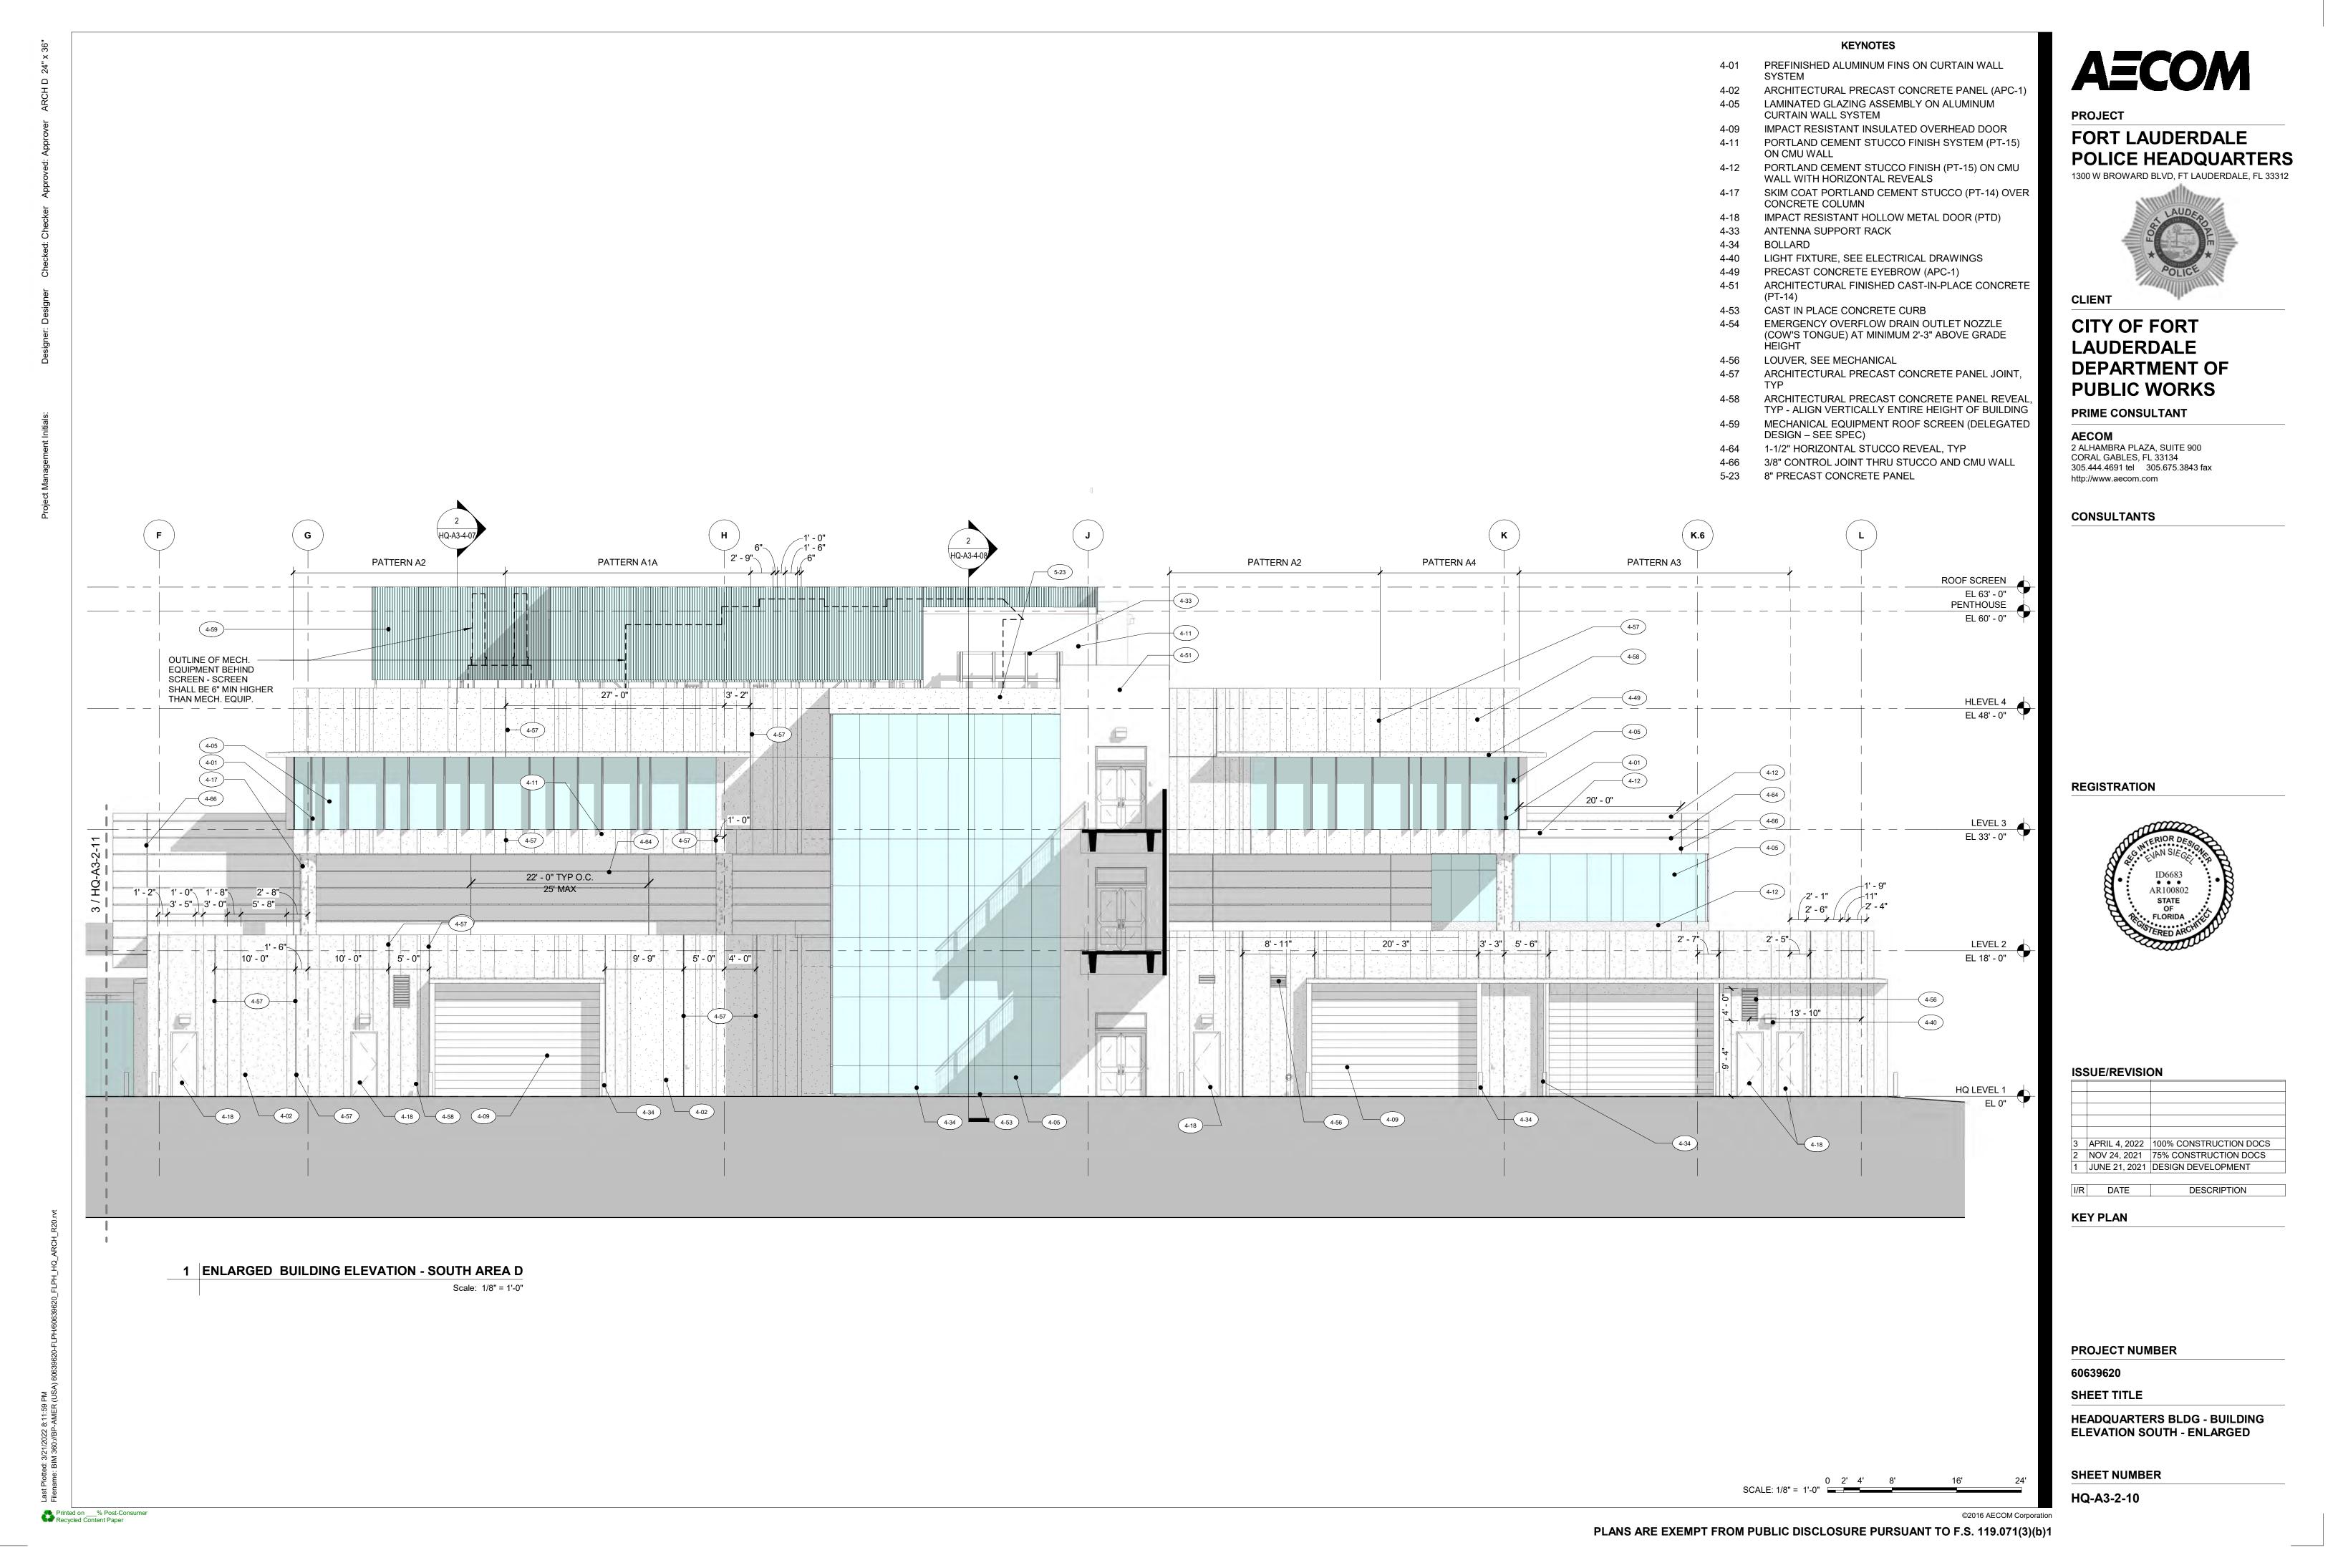

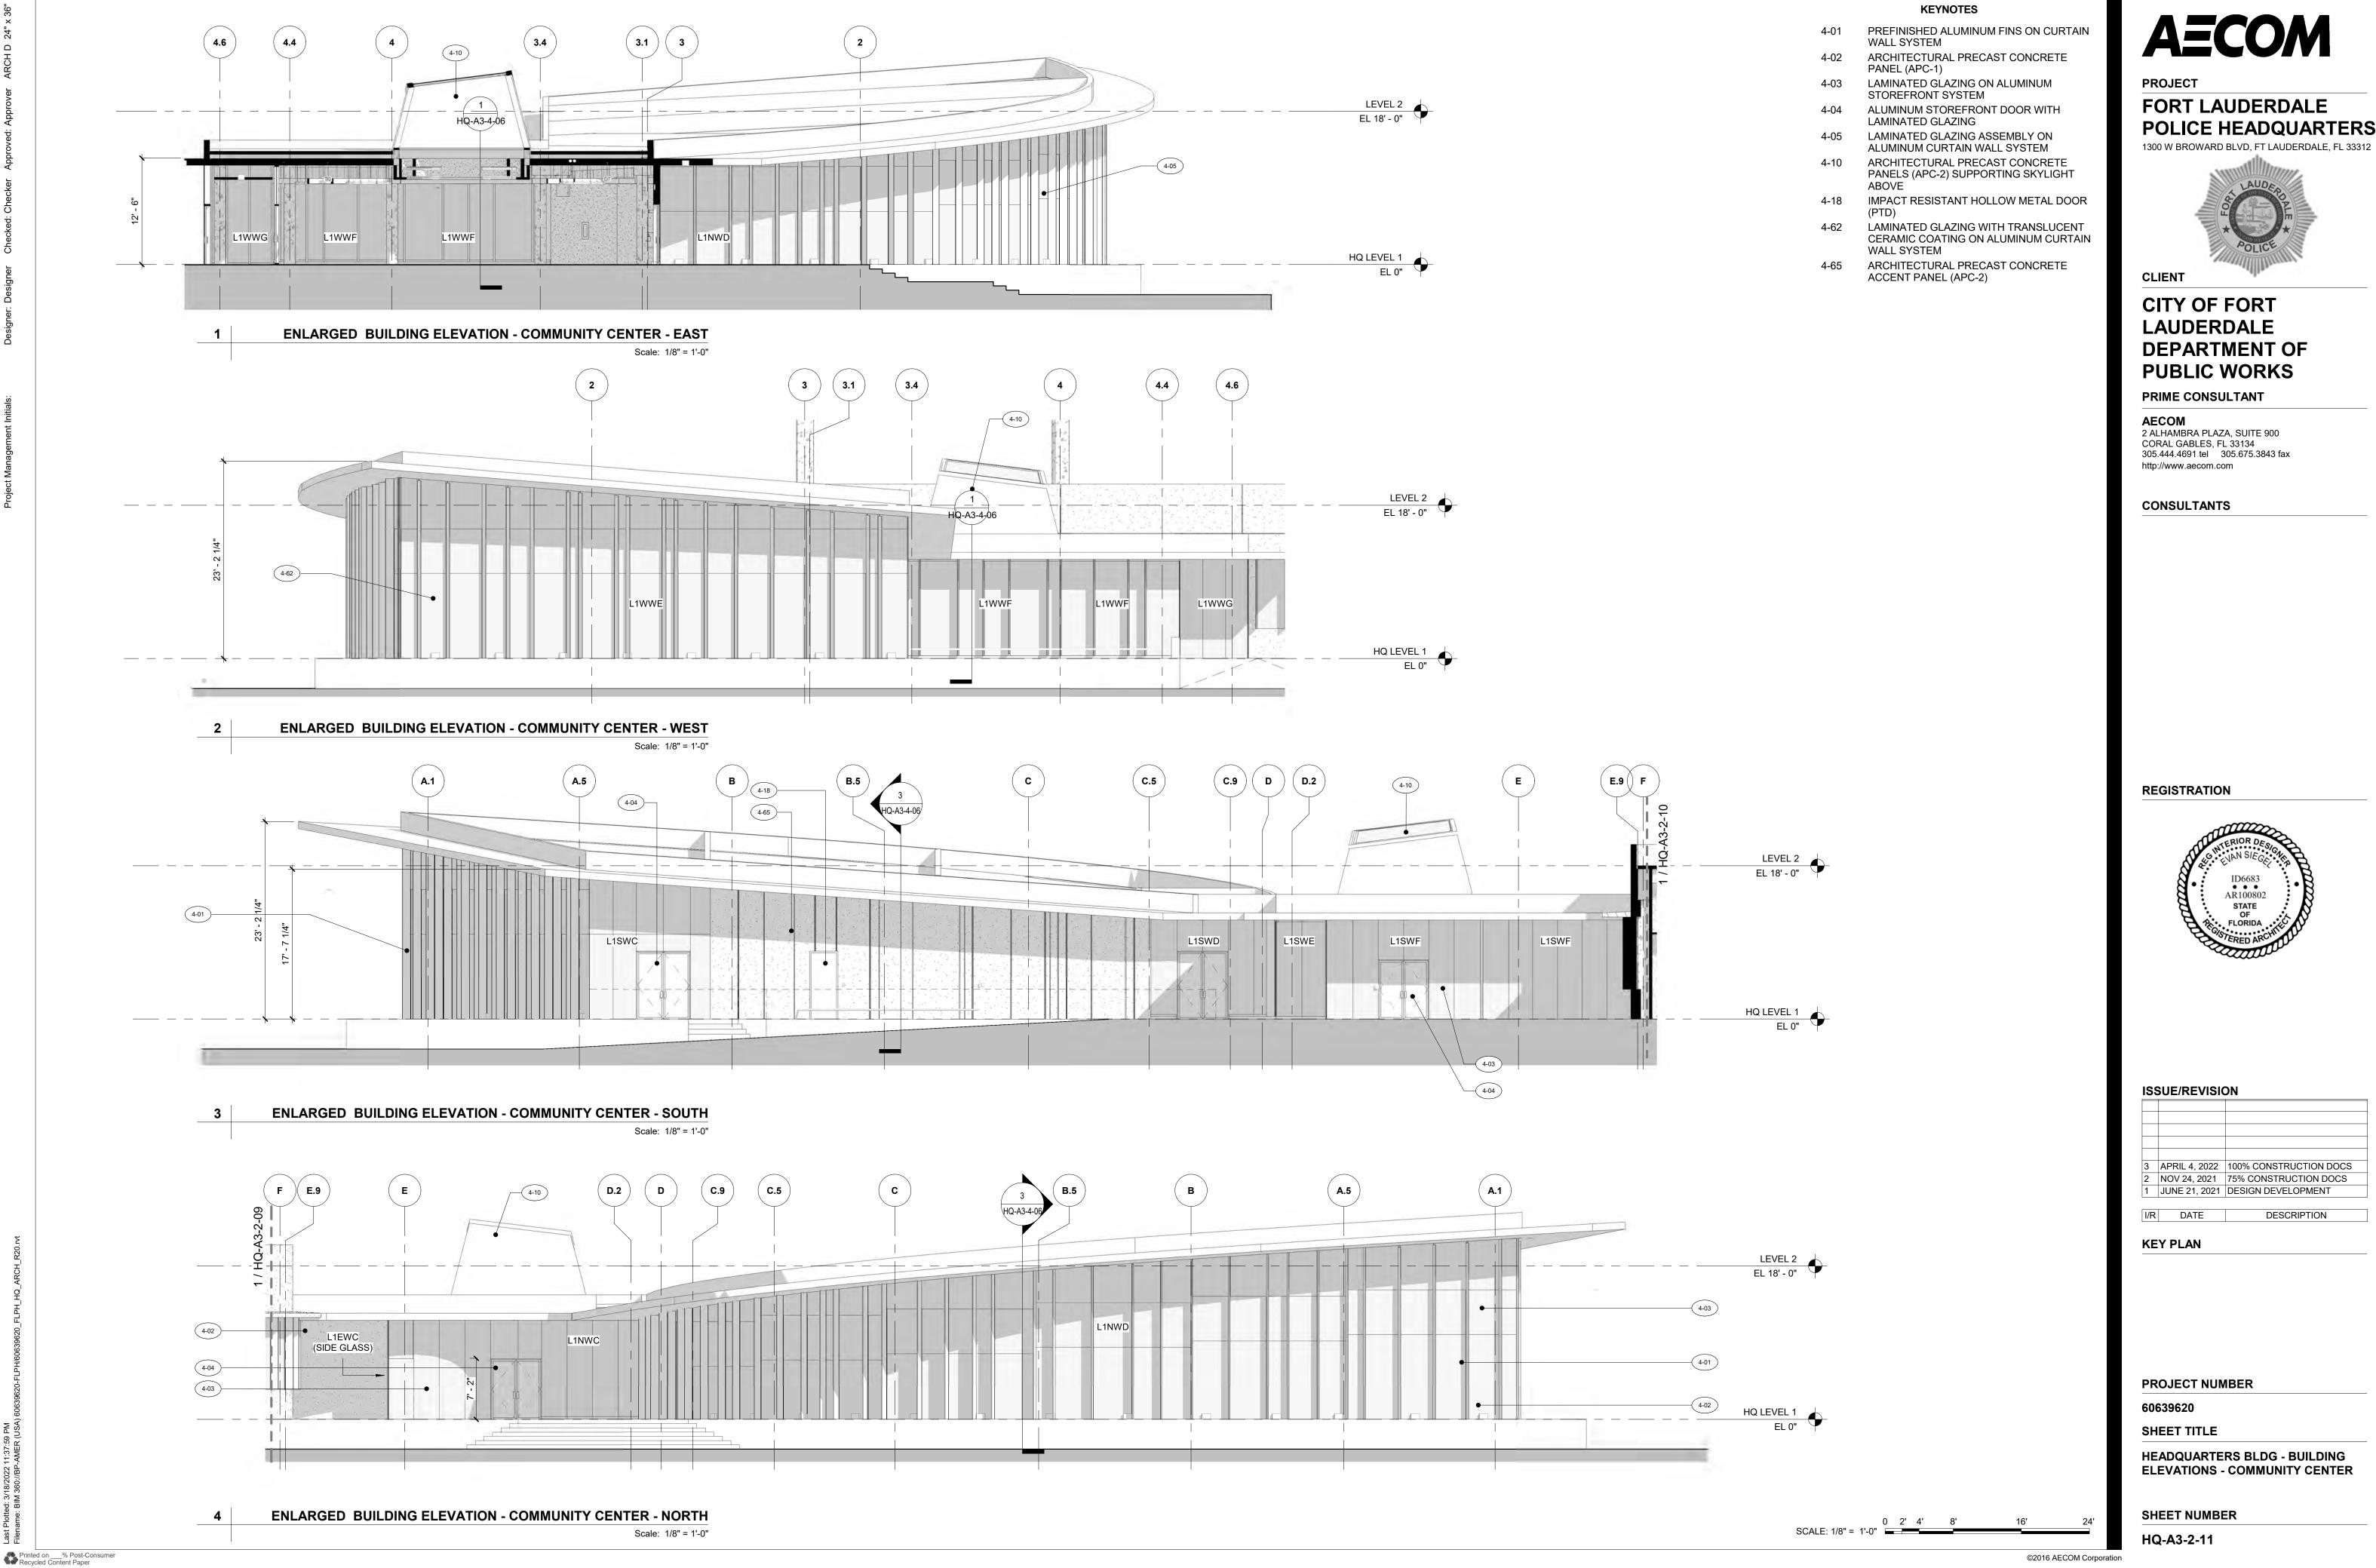

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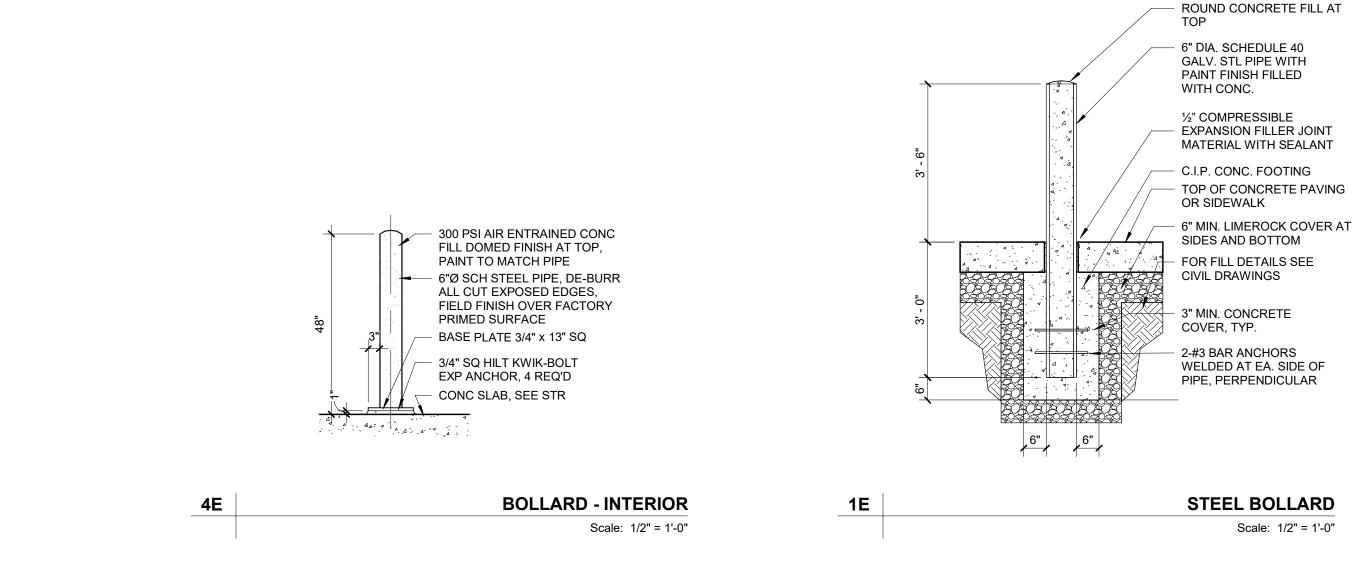
POLICE HEADQUARTERS






APRIL 4, 2022 100% CONSTRUCTION DOCS NOV 24, 2021 75% CONSTRUCTION DOCS JUNE 21, 2021 DESIGN DEVELOPMENT

ELEVATIONS - COMMUNITY CENTER



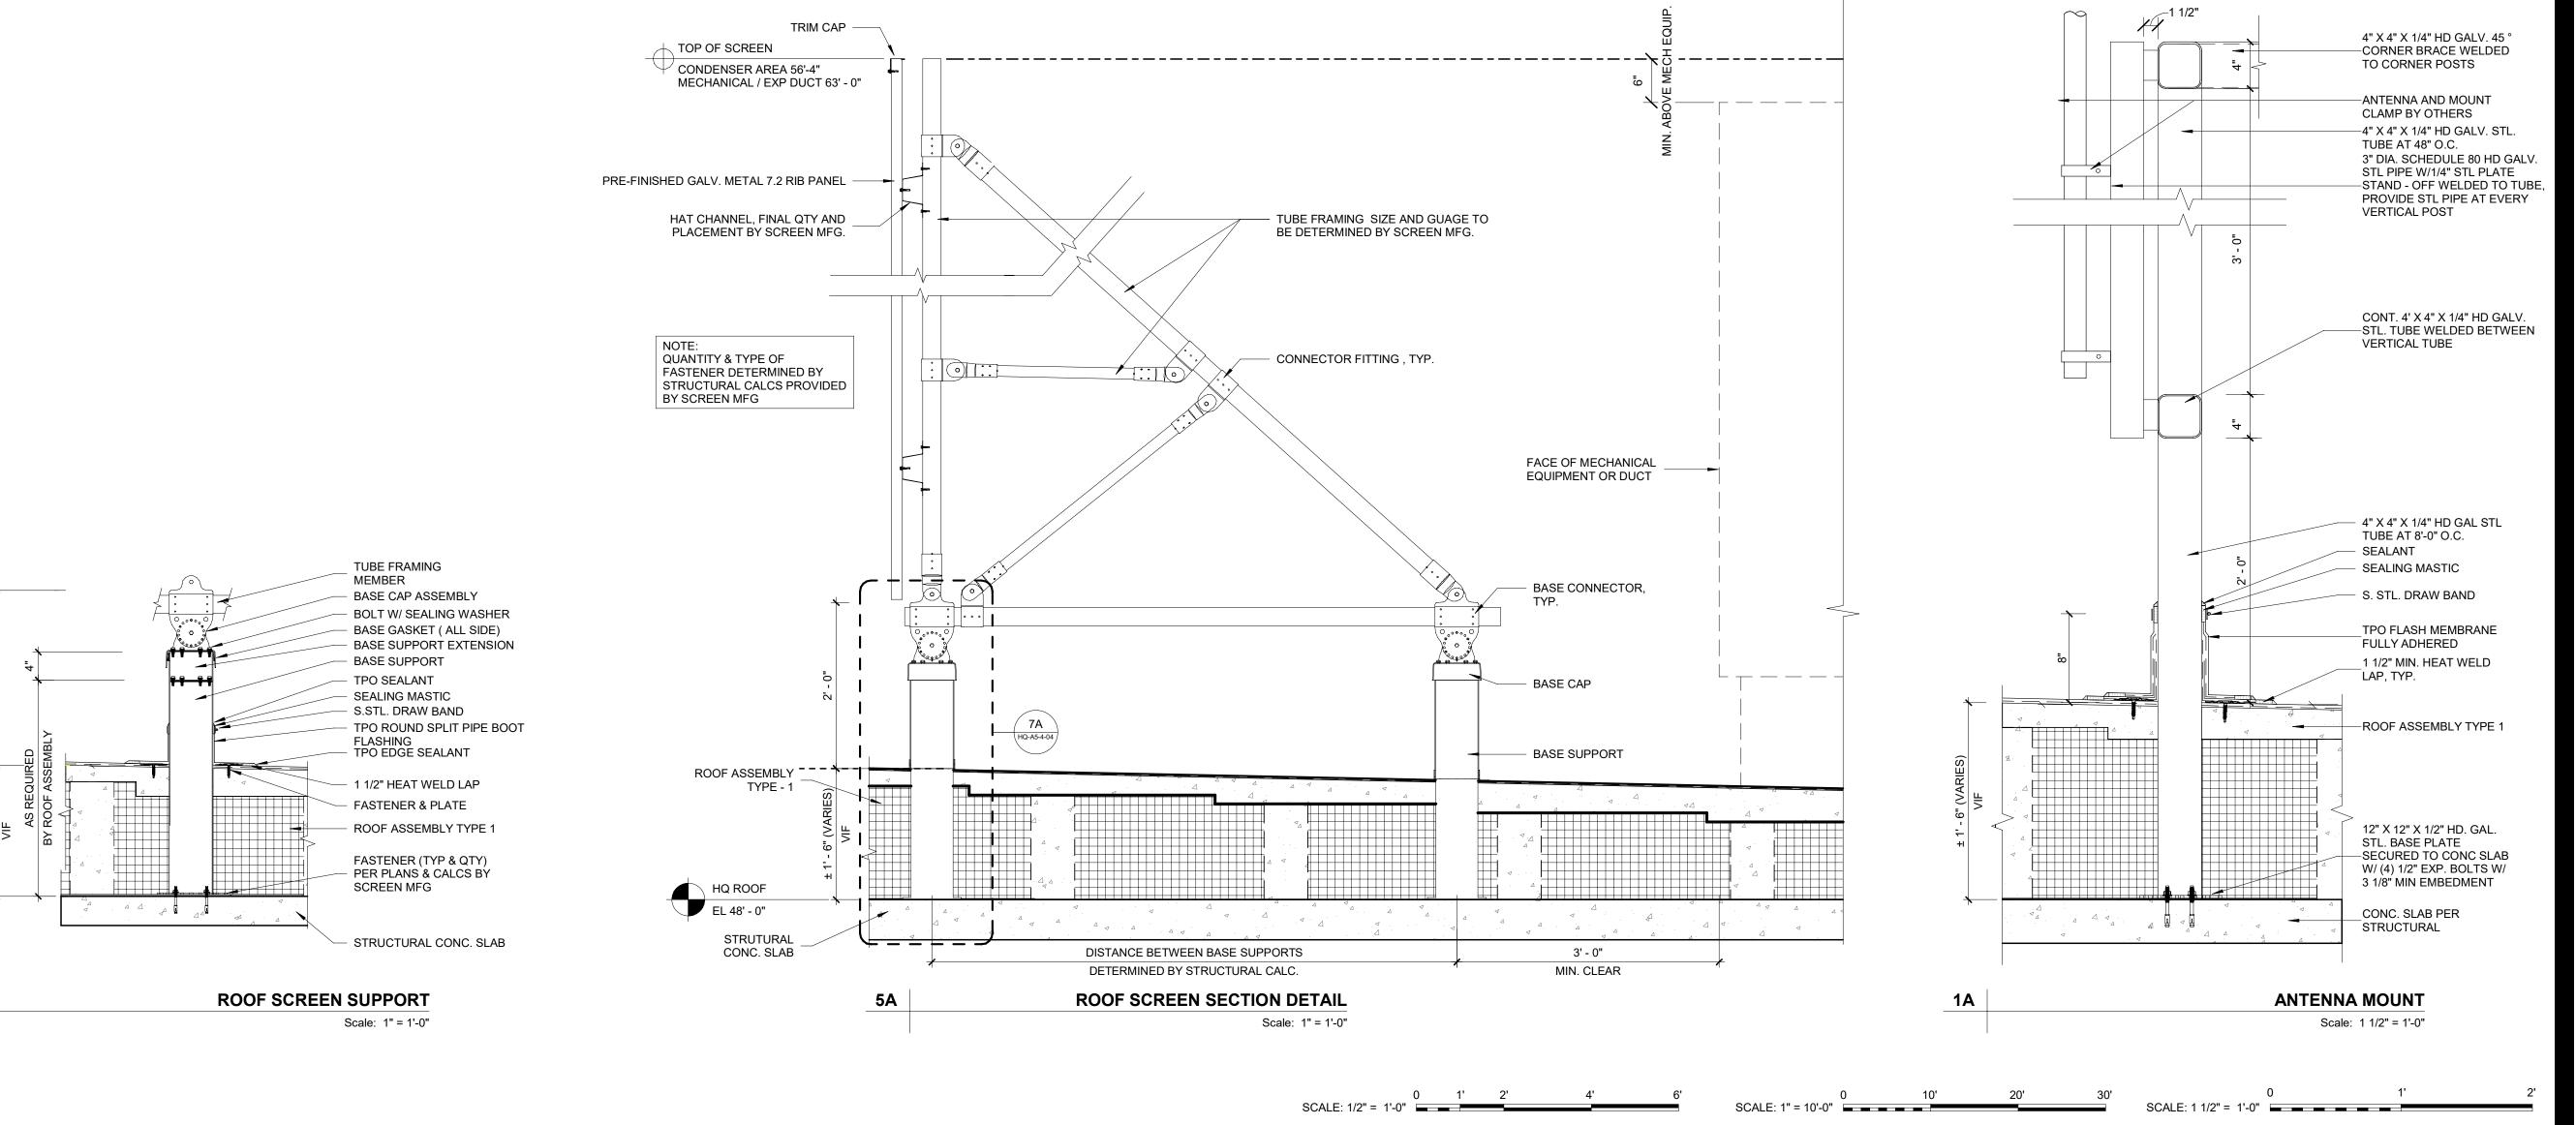

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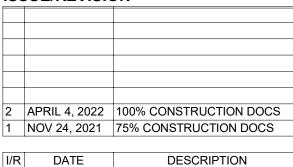
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SHEET TITLE

HEADQUARTERS BLDG - DETAILS -MISCELLANEOUS

SHEET NUMBER

HQ-A5-4-04

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3D VIEW-NORTHWEST CORNER (FOR INFORMATION ONLY)

Scale: NTS



3D VIEW-NORTHEAST CORNER (FOR INFORMATION ONLY)

Scale: NTS



3D VIEW-ENTRANCE PLAZA (FOR INFORMATION ONLY)



3D VIEW-NORTH ELEVATION (FOR INFORMATION ONLY)

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PROJECT

FORT LAUDERDALE POLICE HEADQUARTERS 1300 W BROWARD BLVD, FT LAUDERDALE, FL 33312



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I/R	DATE	DESCRIPTION

KEY PLAN

PROJECT NUMBER

60639620

SHEET TITLE

HEADQUARTERS BLDG -RENDERINGS (FOR INFORMATION

SHEET NUMBER

HQ-A8-1-01

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3D VIEW-OFFICER BRIDGE ENTRANCE (FOR INFORMATION ONLY)



3D VIEW-SOUTHEAST CORNER (FOR INFORMATION ONLY)

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PROJECT

FORT LAUDERDALE **POLICE HEADQUARTERS** 1300 W BROWARD BLVD, FT LAUDERDALE, FL 33312



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PROJECT NUMBER

60639620

SHEET TITLE

HEADQUARTERS BLDG -RENDERINGS (FOR INFORMATION


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HQ-A8-1-02




3D VIEW-LOADING DOCK/TRASH AREA (FOR INFORMATION ONLY)

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3D VIEW-PERSPECTIVE SECTION 1 Scale: N.T.S.

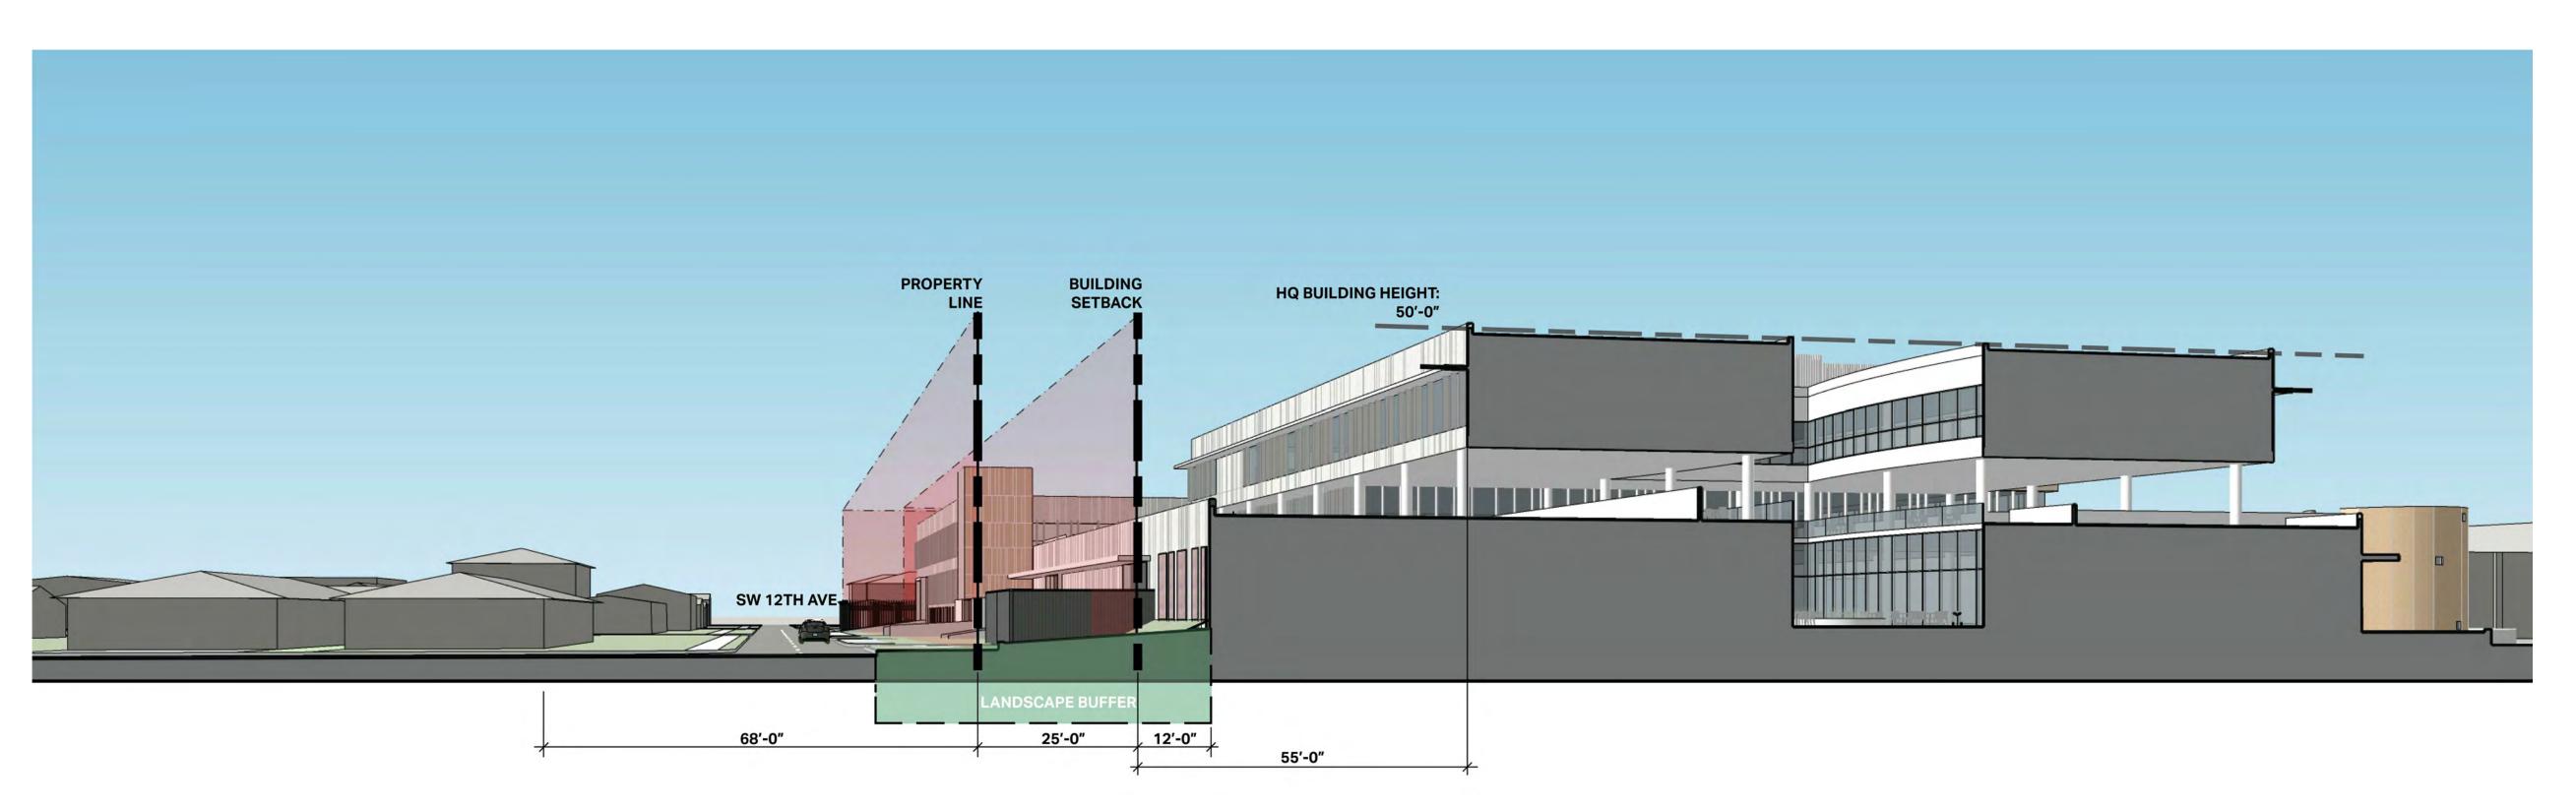

3D VIEW-PERSPECTIVE SECTION 2 Scale: N.T.S. **AECOM**
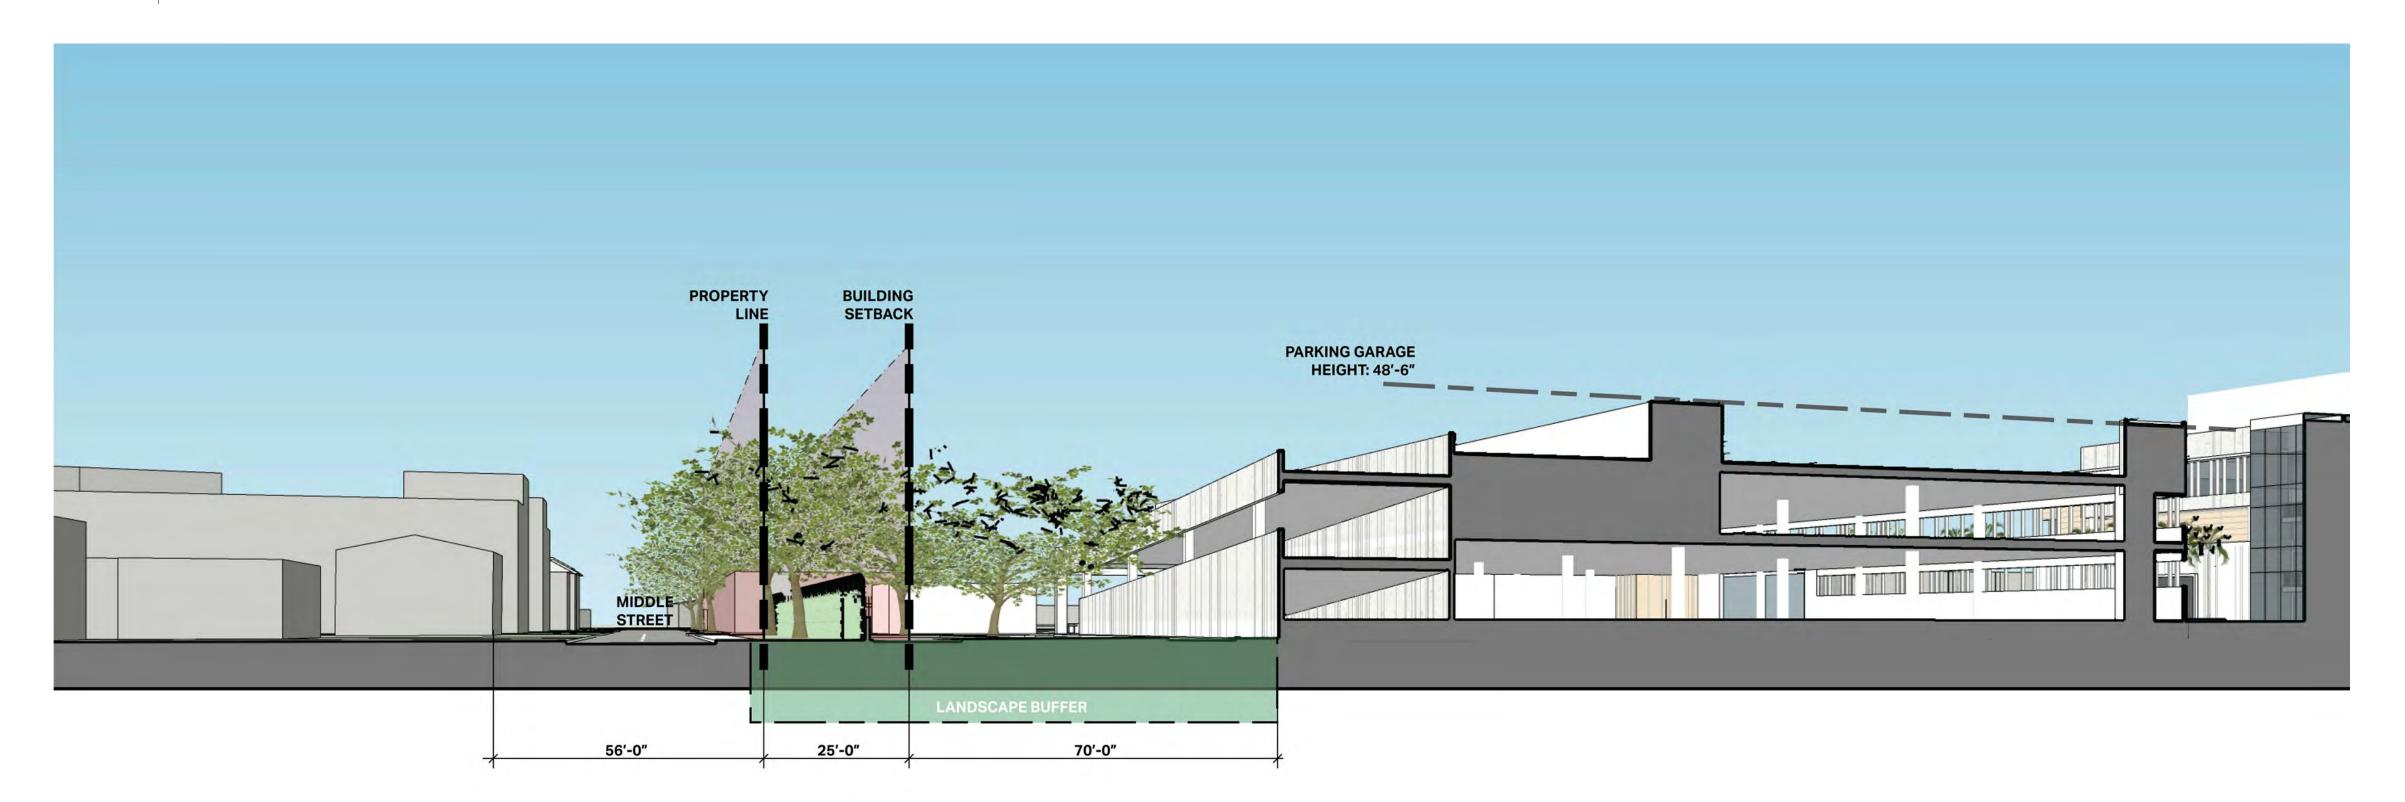
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FORT LAUDERDALE **POLICE HEADQUARTERS** 1300 W BROWARD BLVD, FT LAUDERDALE, FL 33312



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HEADQUARTERS BLDG -PERSPECTIVE SECTION DIAGRAMS (FOR INFORMATION ONLY)

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HQ-A8-1-03

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GREEN SCREENS CONCEPT



2 GREEN SCREENS HARDWARE

Scale: NTS

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1300 W BROWARD BLVD, FT LAUDERDALE, FL 33312



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SHEET TITLE

GREEN SCREENS CONCEPT


SHEET NUMBER

HQ-A8-1-04

PRECAST CONCRETE BASE WALLS




PRECAST CONCRETE ACCENT WALLS

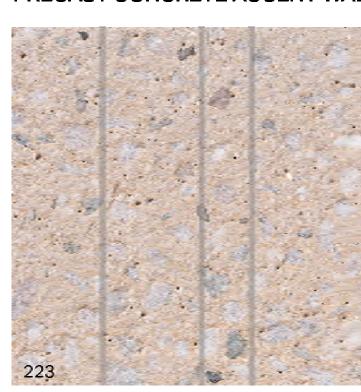




EXTERIOR SOFFITS

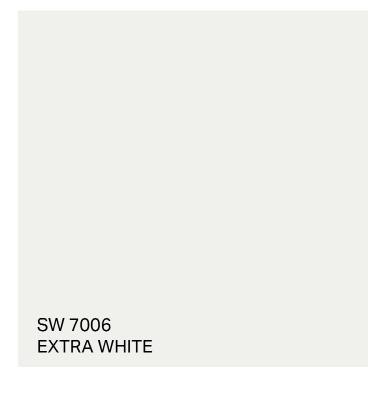

CURTAIN WALL FINS

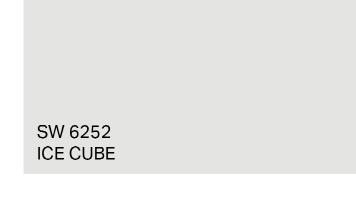



EXTERIOR ELEMENTS (BOLLARDS,





SECURITY FENCING

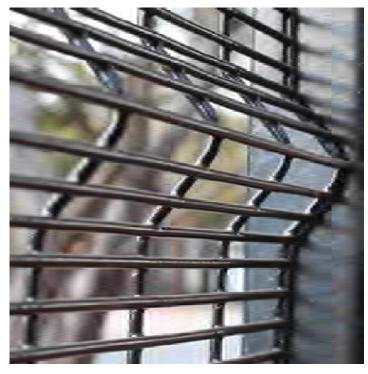

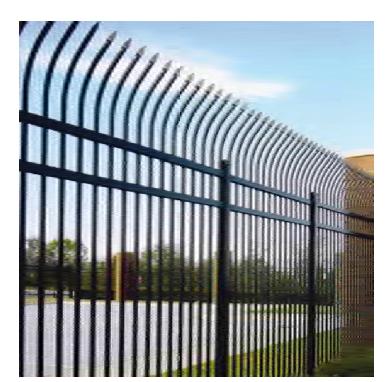


MATERIAL BOARD


EXTERIOR CURTAIN WALL GLAZING





EXTERIOR PAVERS

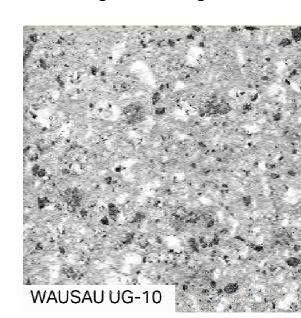

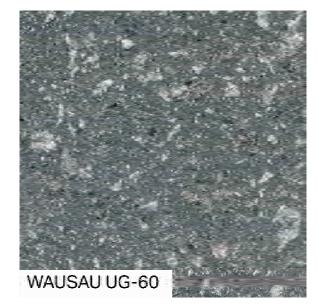

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POLICE HEADQUARTERS 1300 W BROWARD BLVD, FT LAUDERDALE, FL 33312

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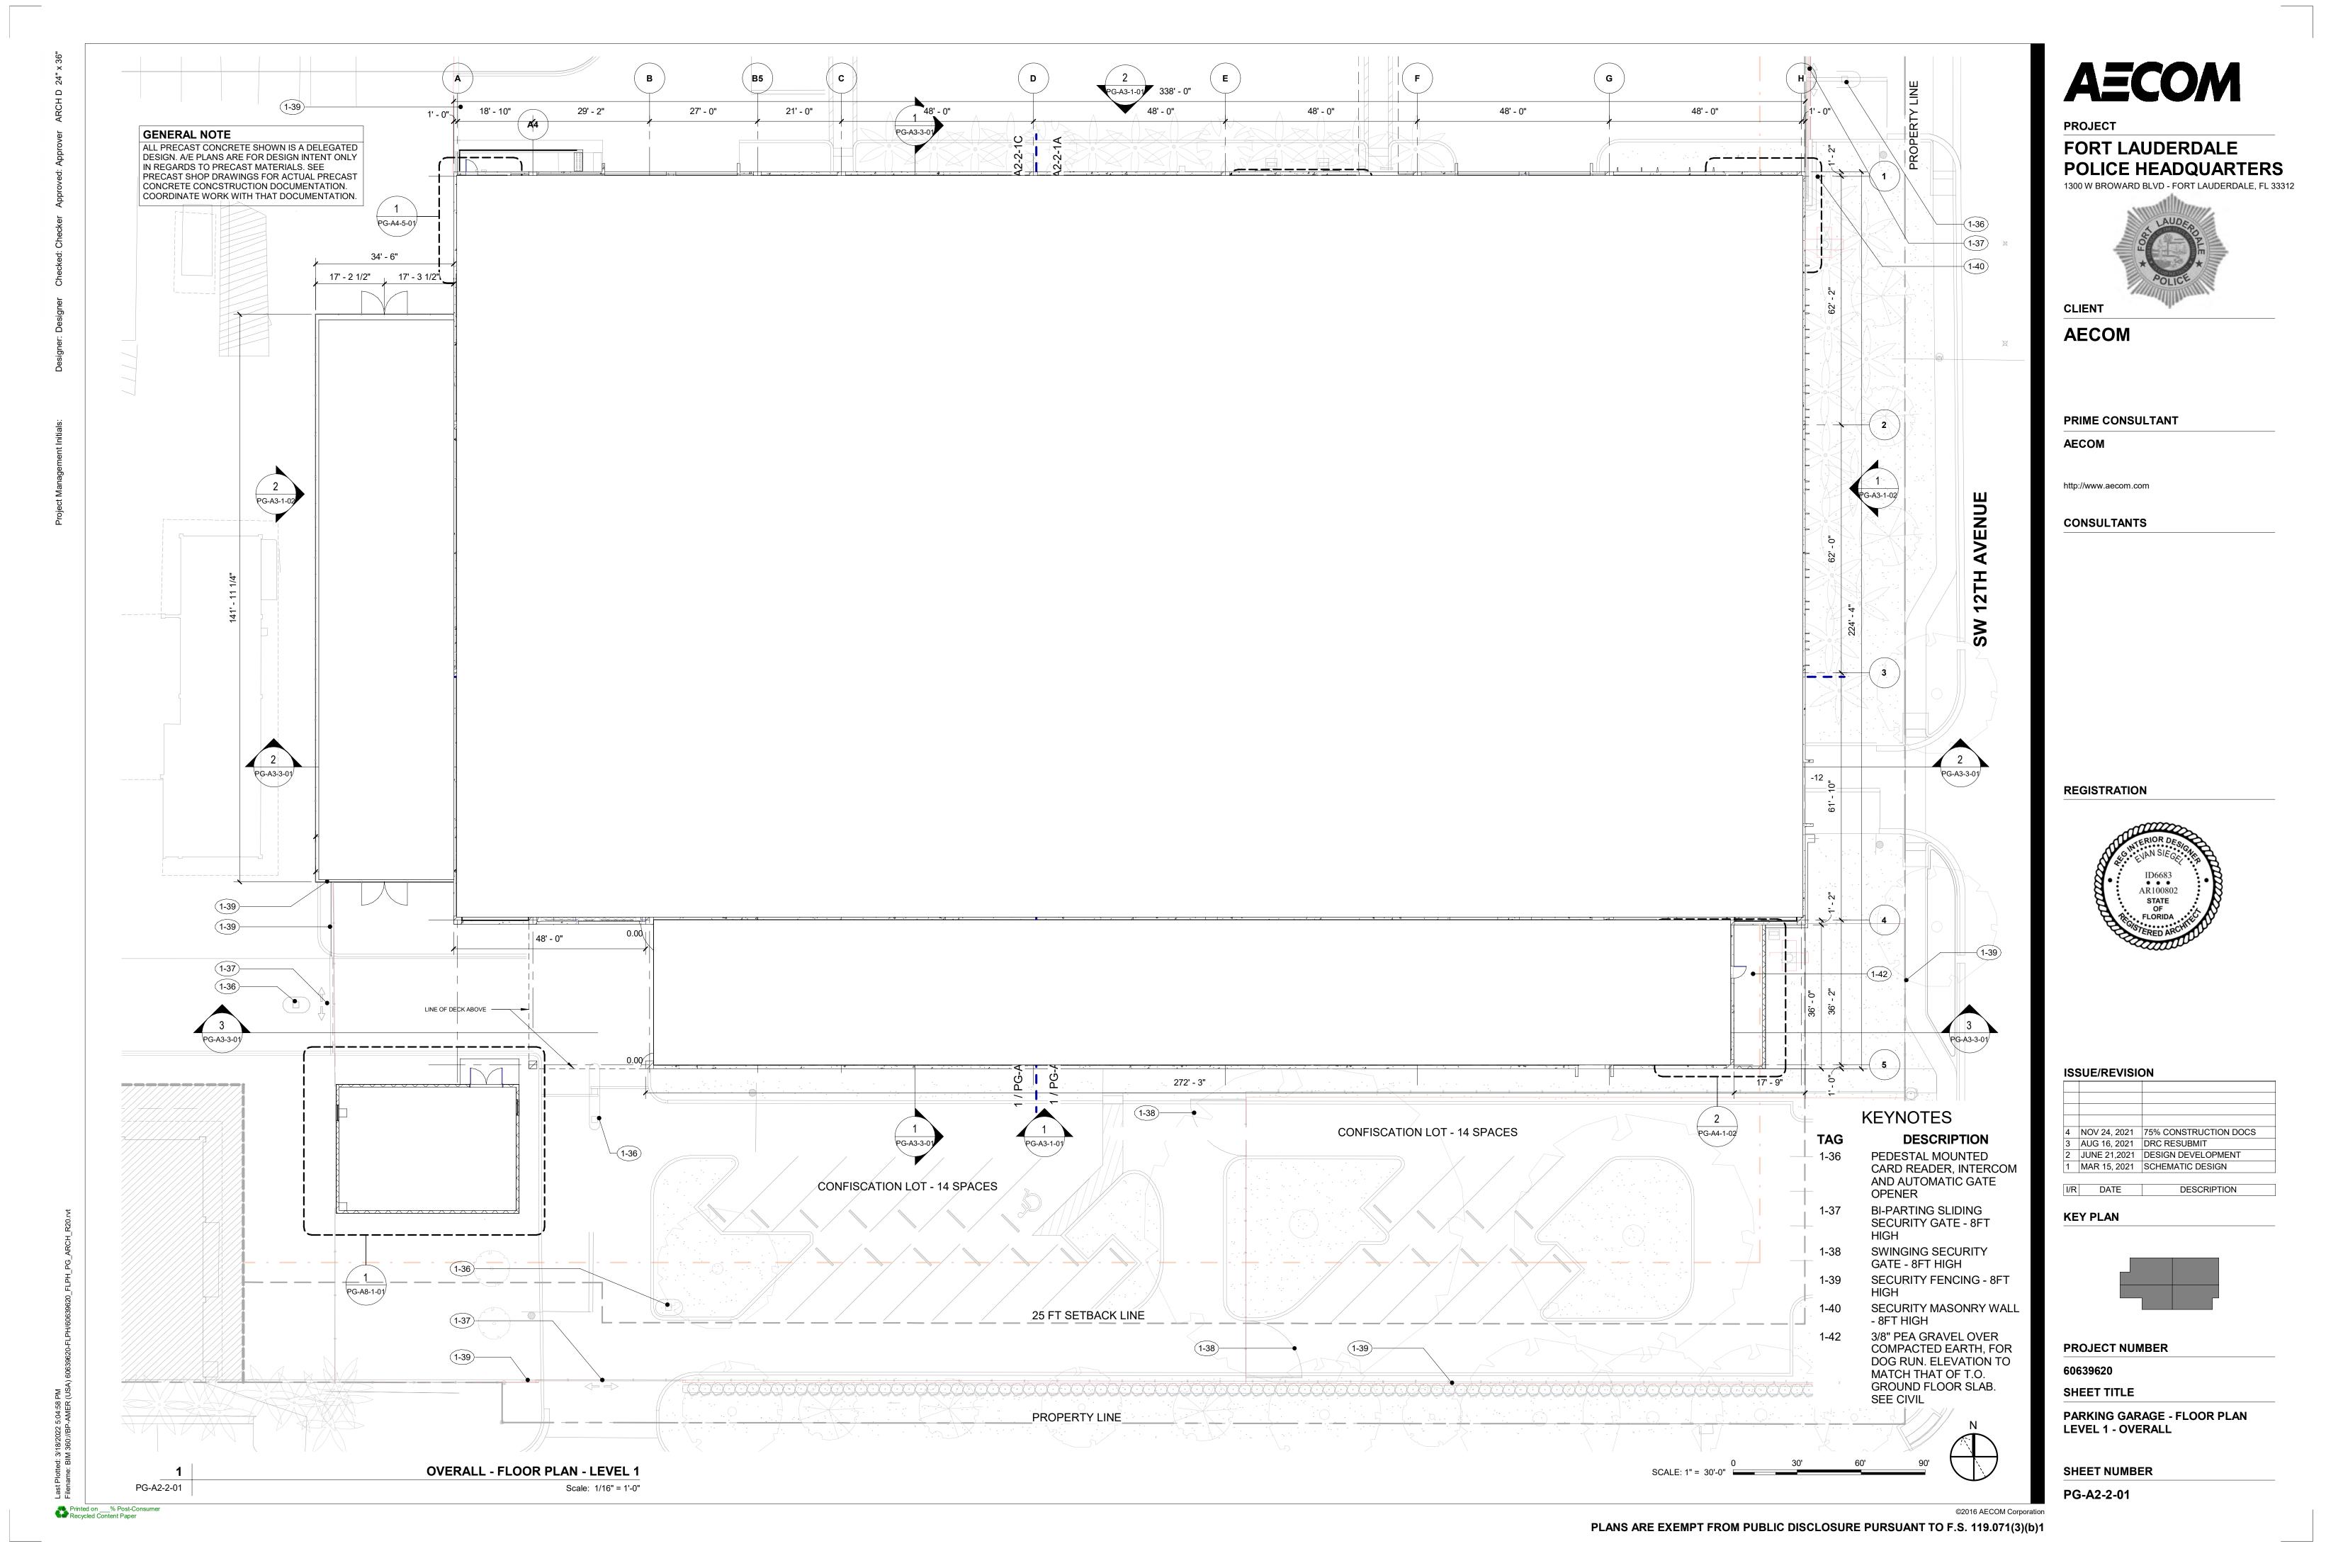
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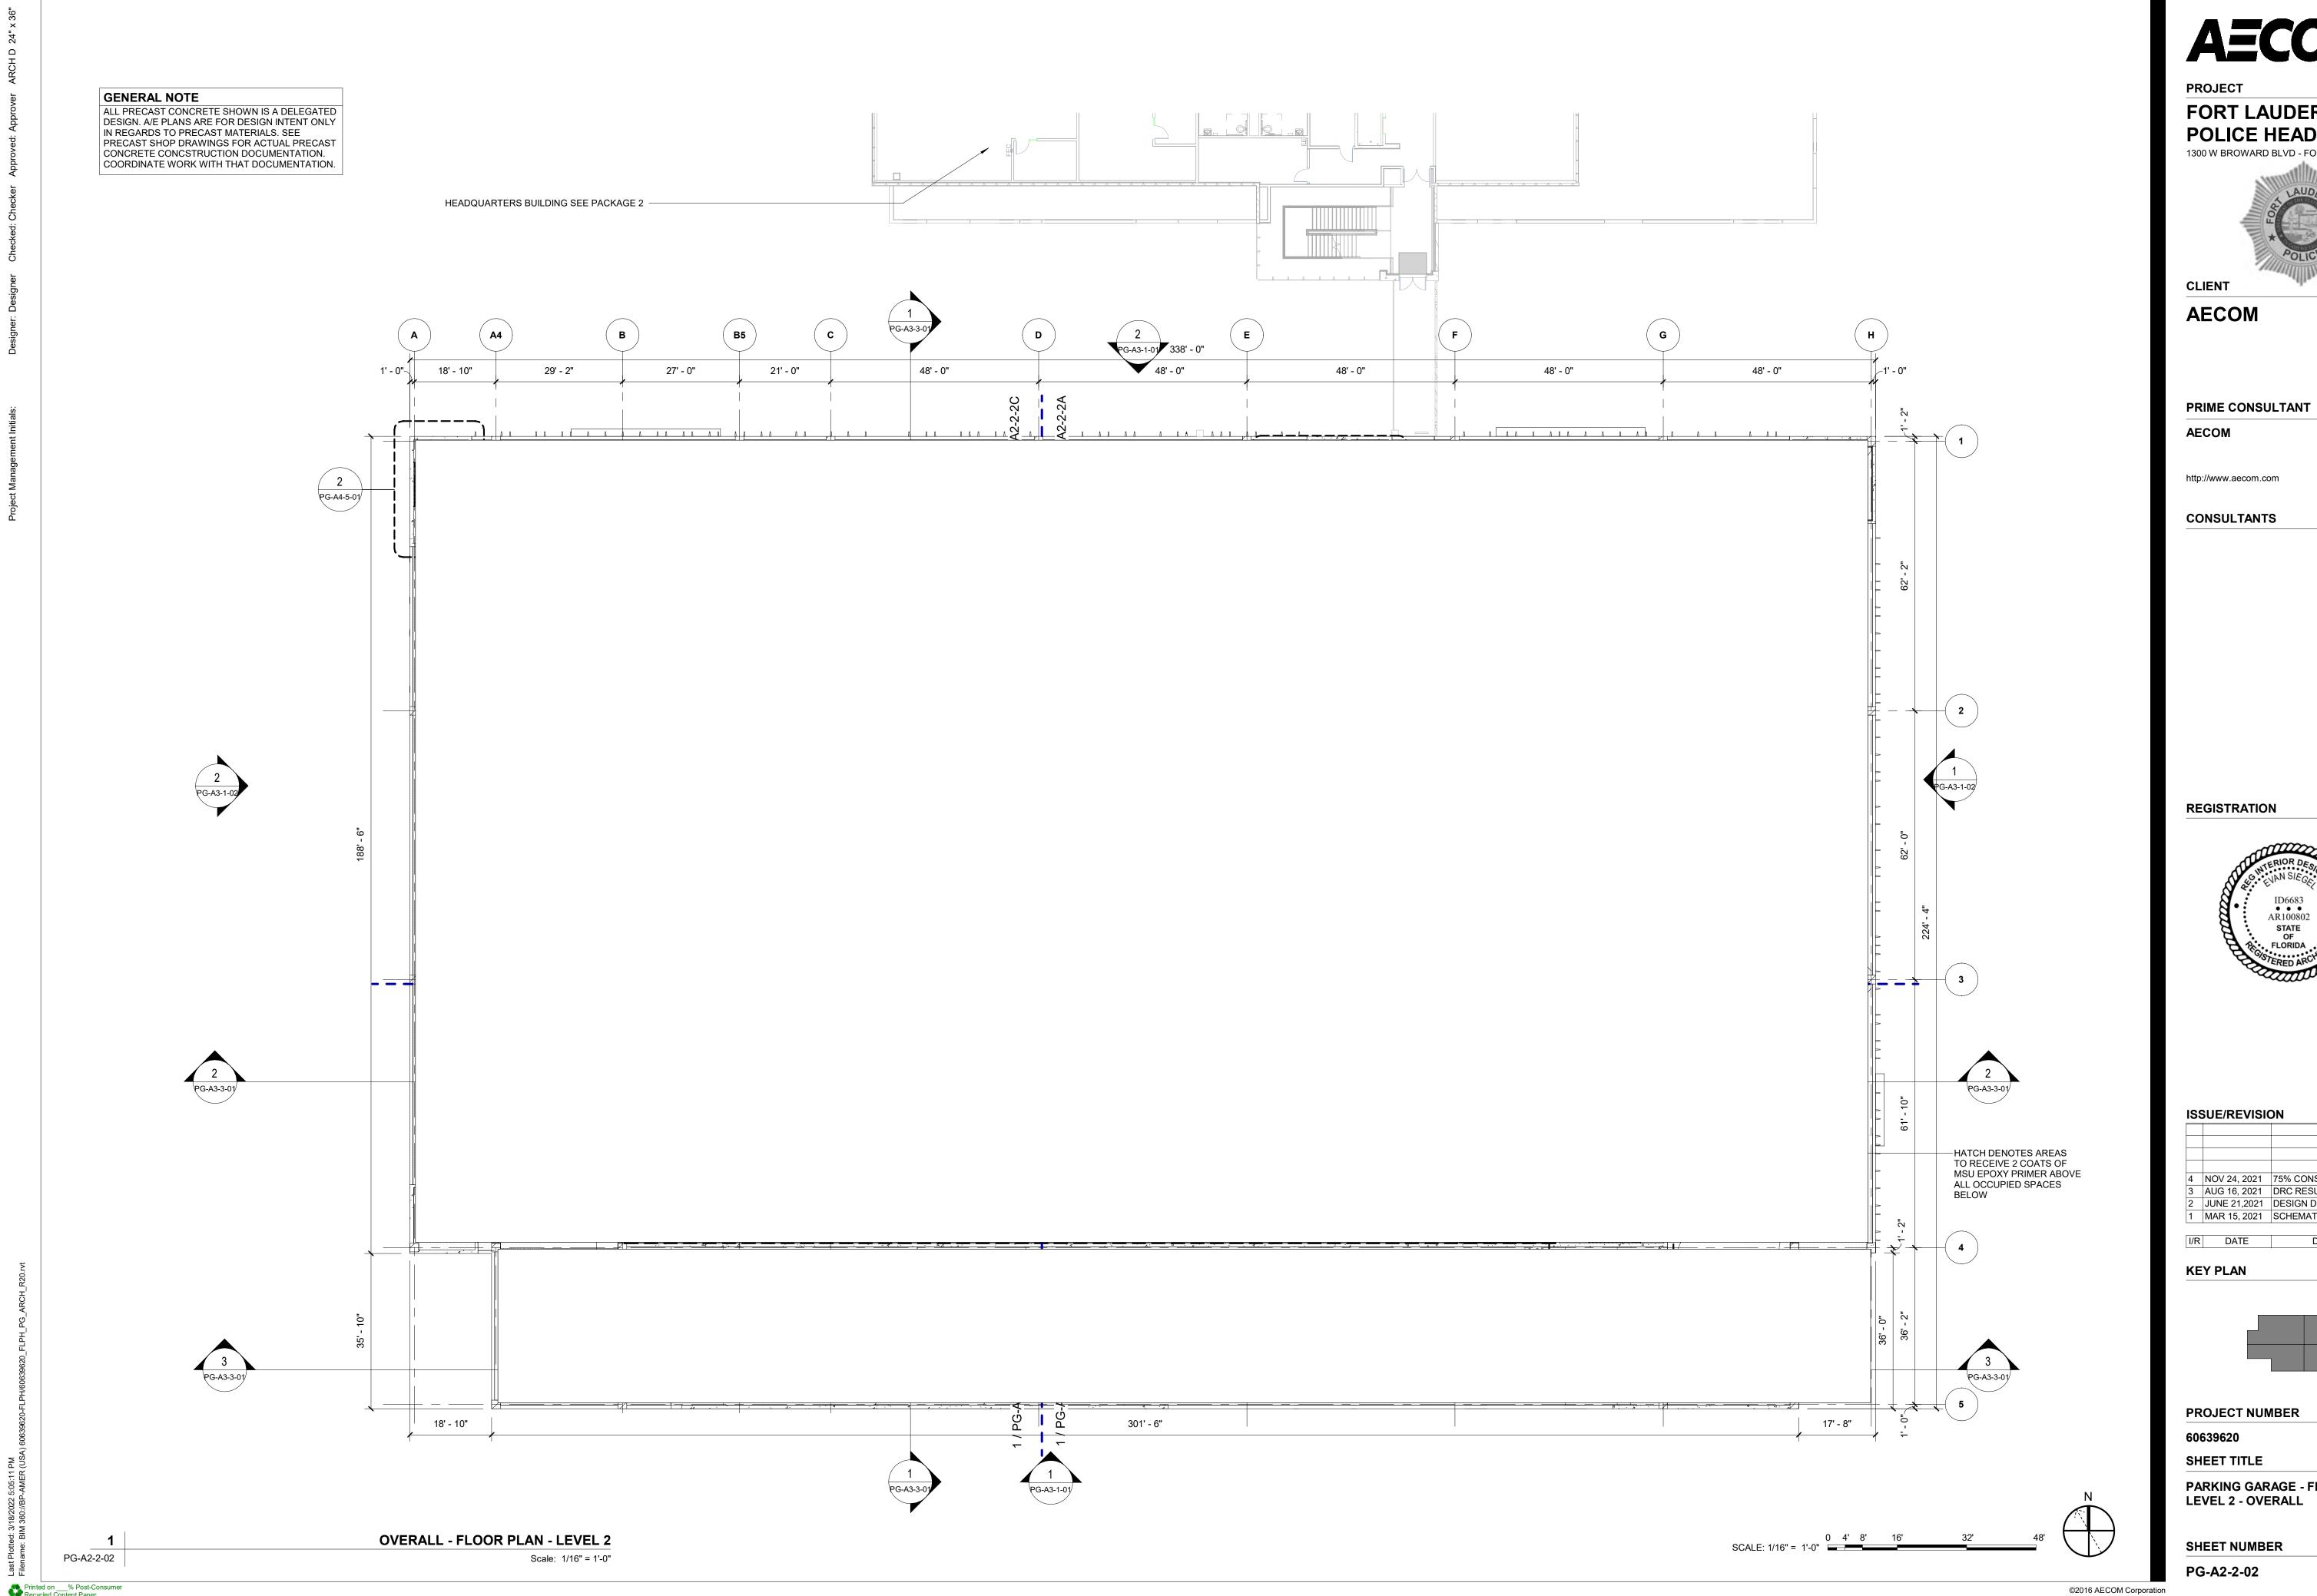
SHEET TITLE MATERIALS BOARD

SHEET NUMBER

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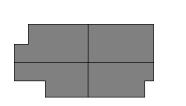


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I/R DATE DESCRIPTION

KEY PLAN




PROJECT NUMBER

SHEET TITLE

PARKING GARAGE - FLOOR PLAN **LEVEL 2 - OVERALL**

SHEET NUMBER

PG-A2-2-02

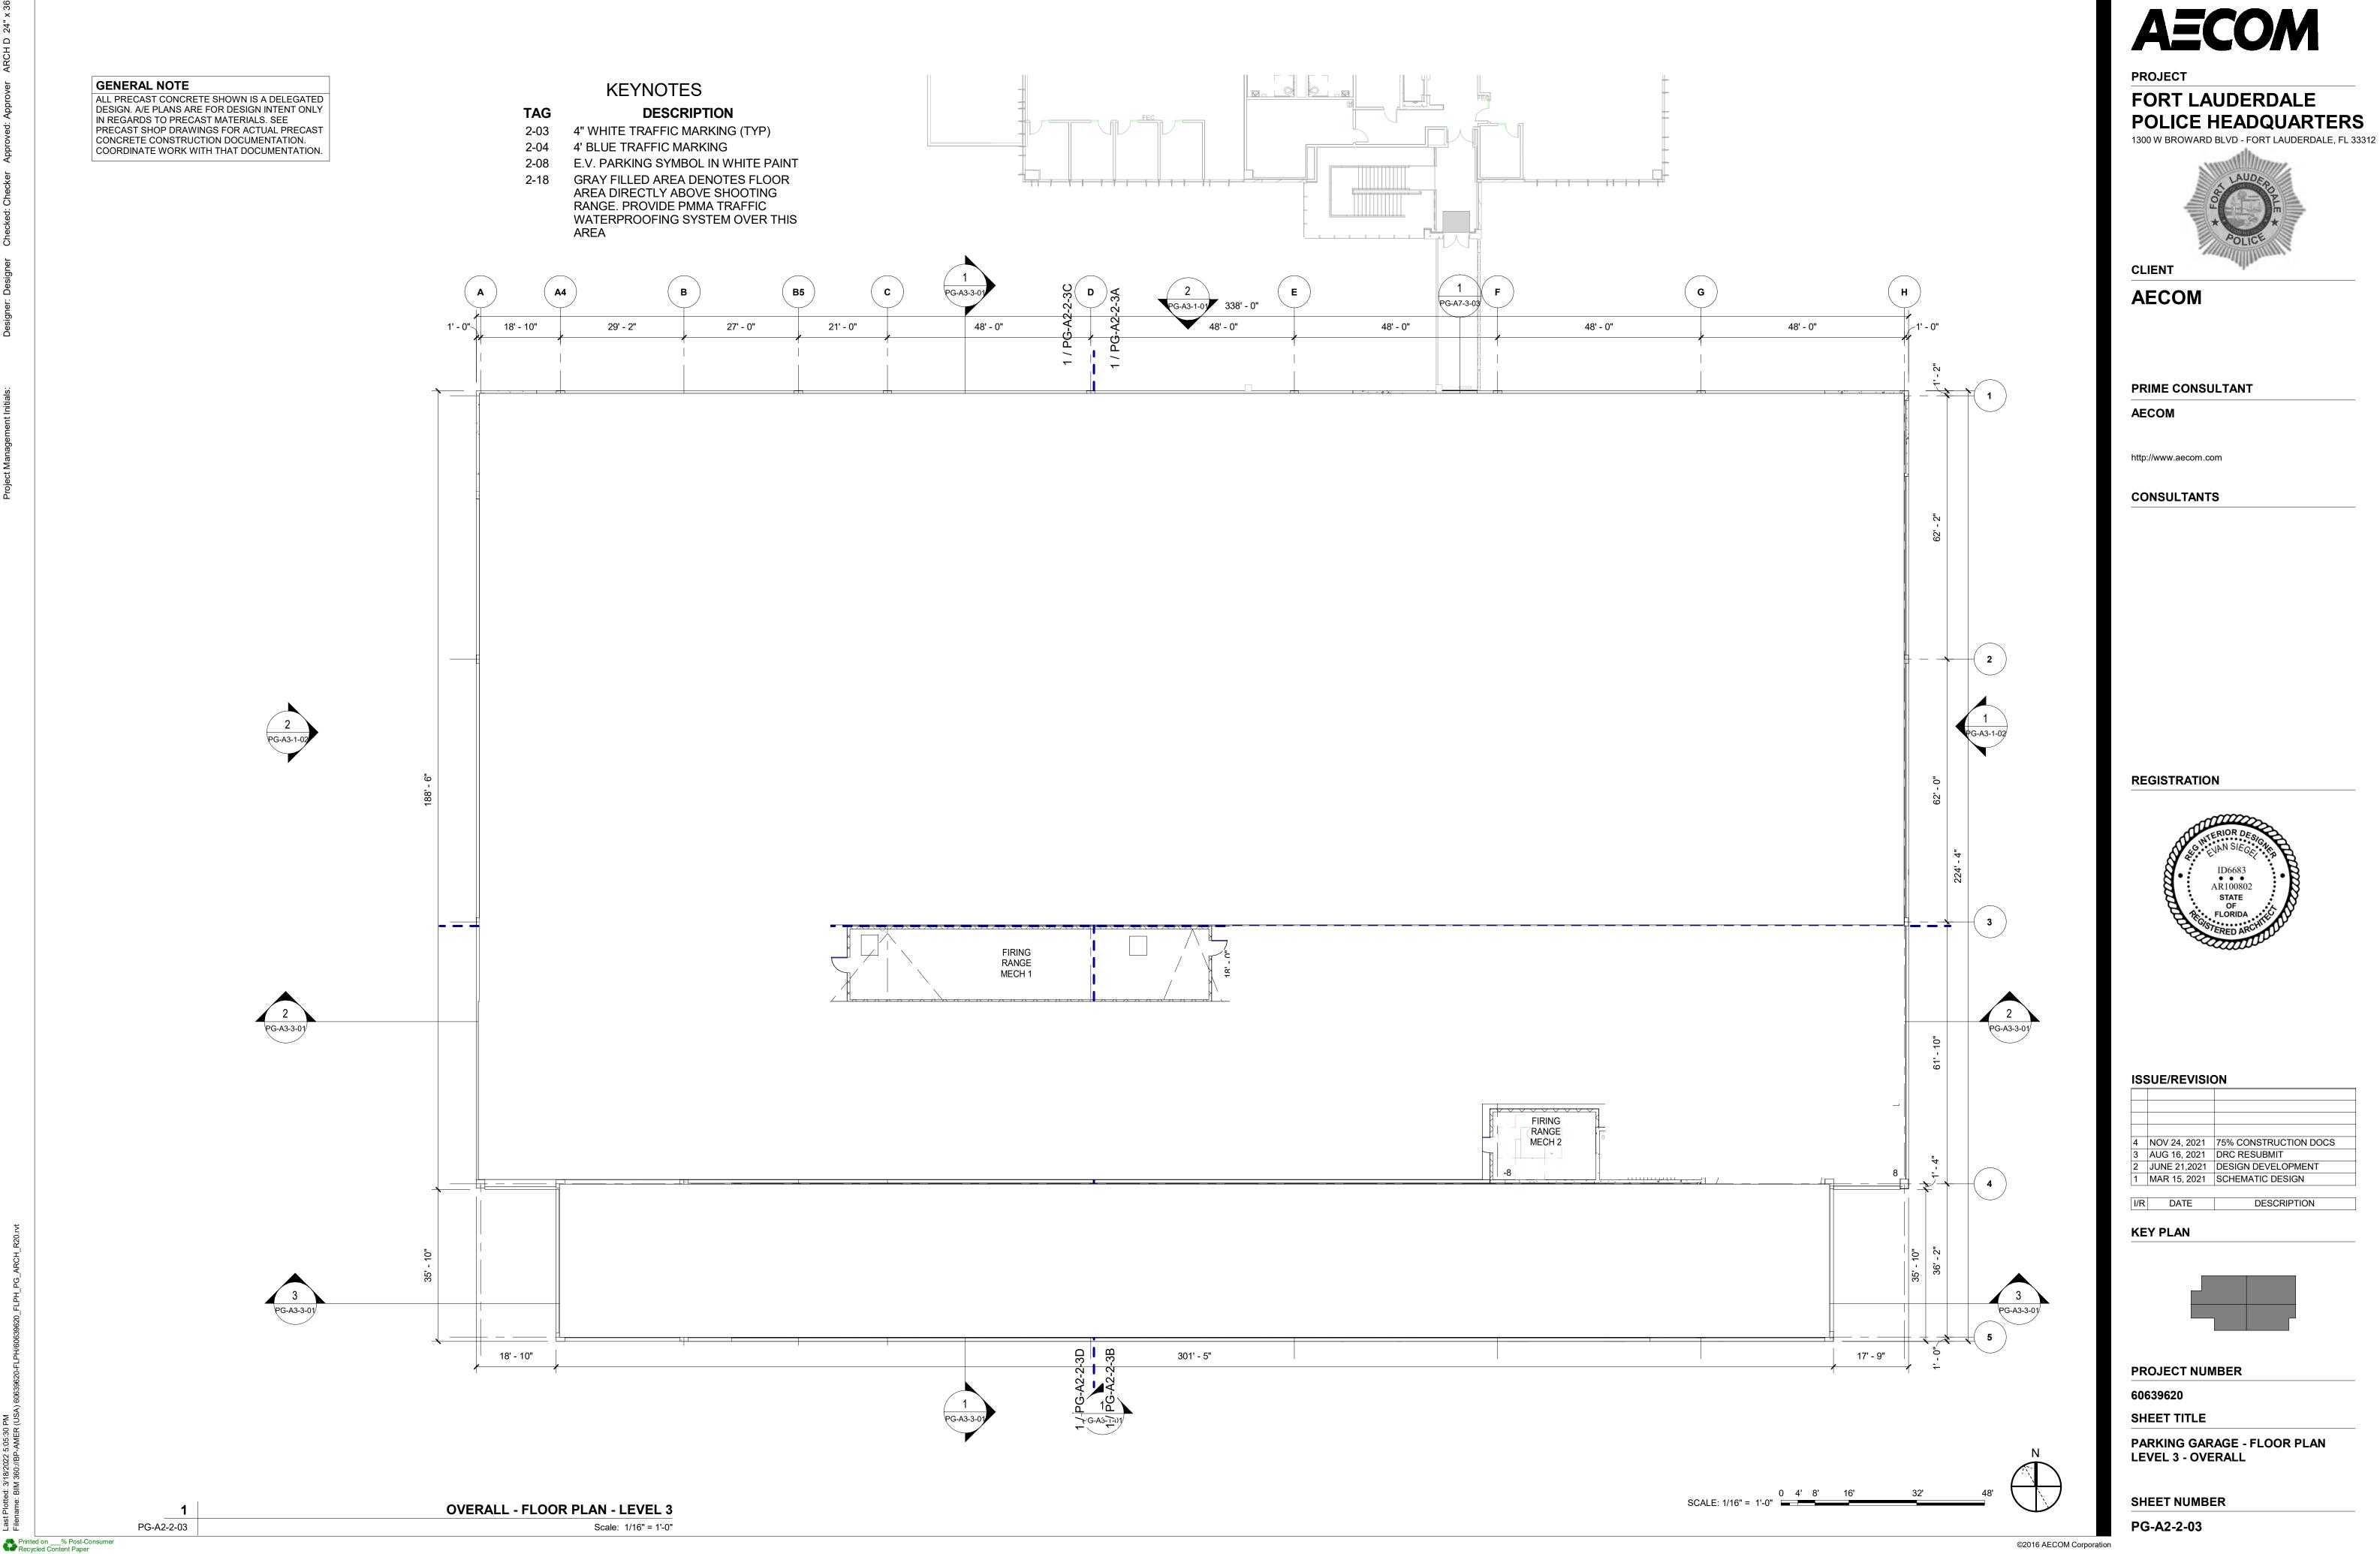

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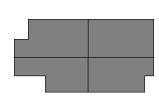
FORT LAUDERDALE POLICE HEADQUARTERS





4 NOV 24, 2021 75% CONSTRUCTION DOCS 3 AUG 16, 2021 DRC RESUBMIT
2 JUNE 21,2021 DESIGN DEVELOPMENT MAR 15, 2021 SCHEMATIC DESIGN

DESCRIPTION



LEVEL 3 - OVERALL


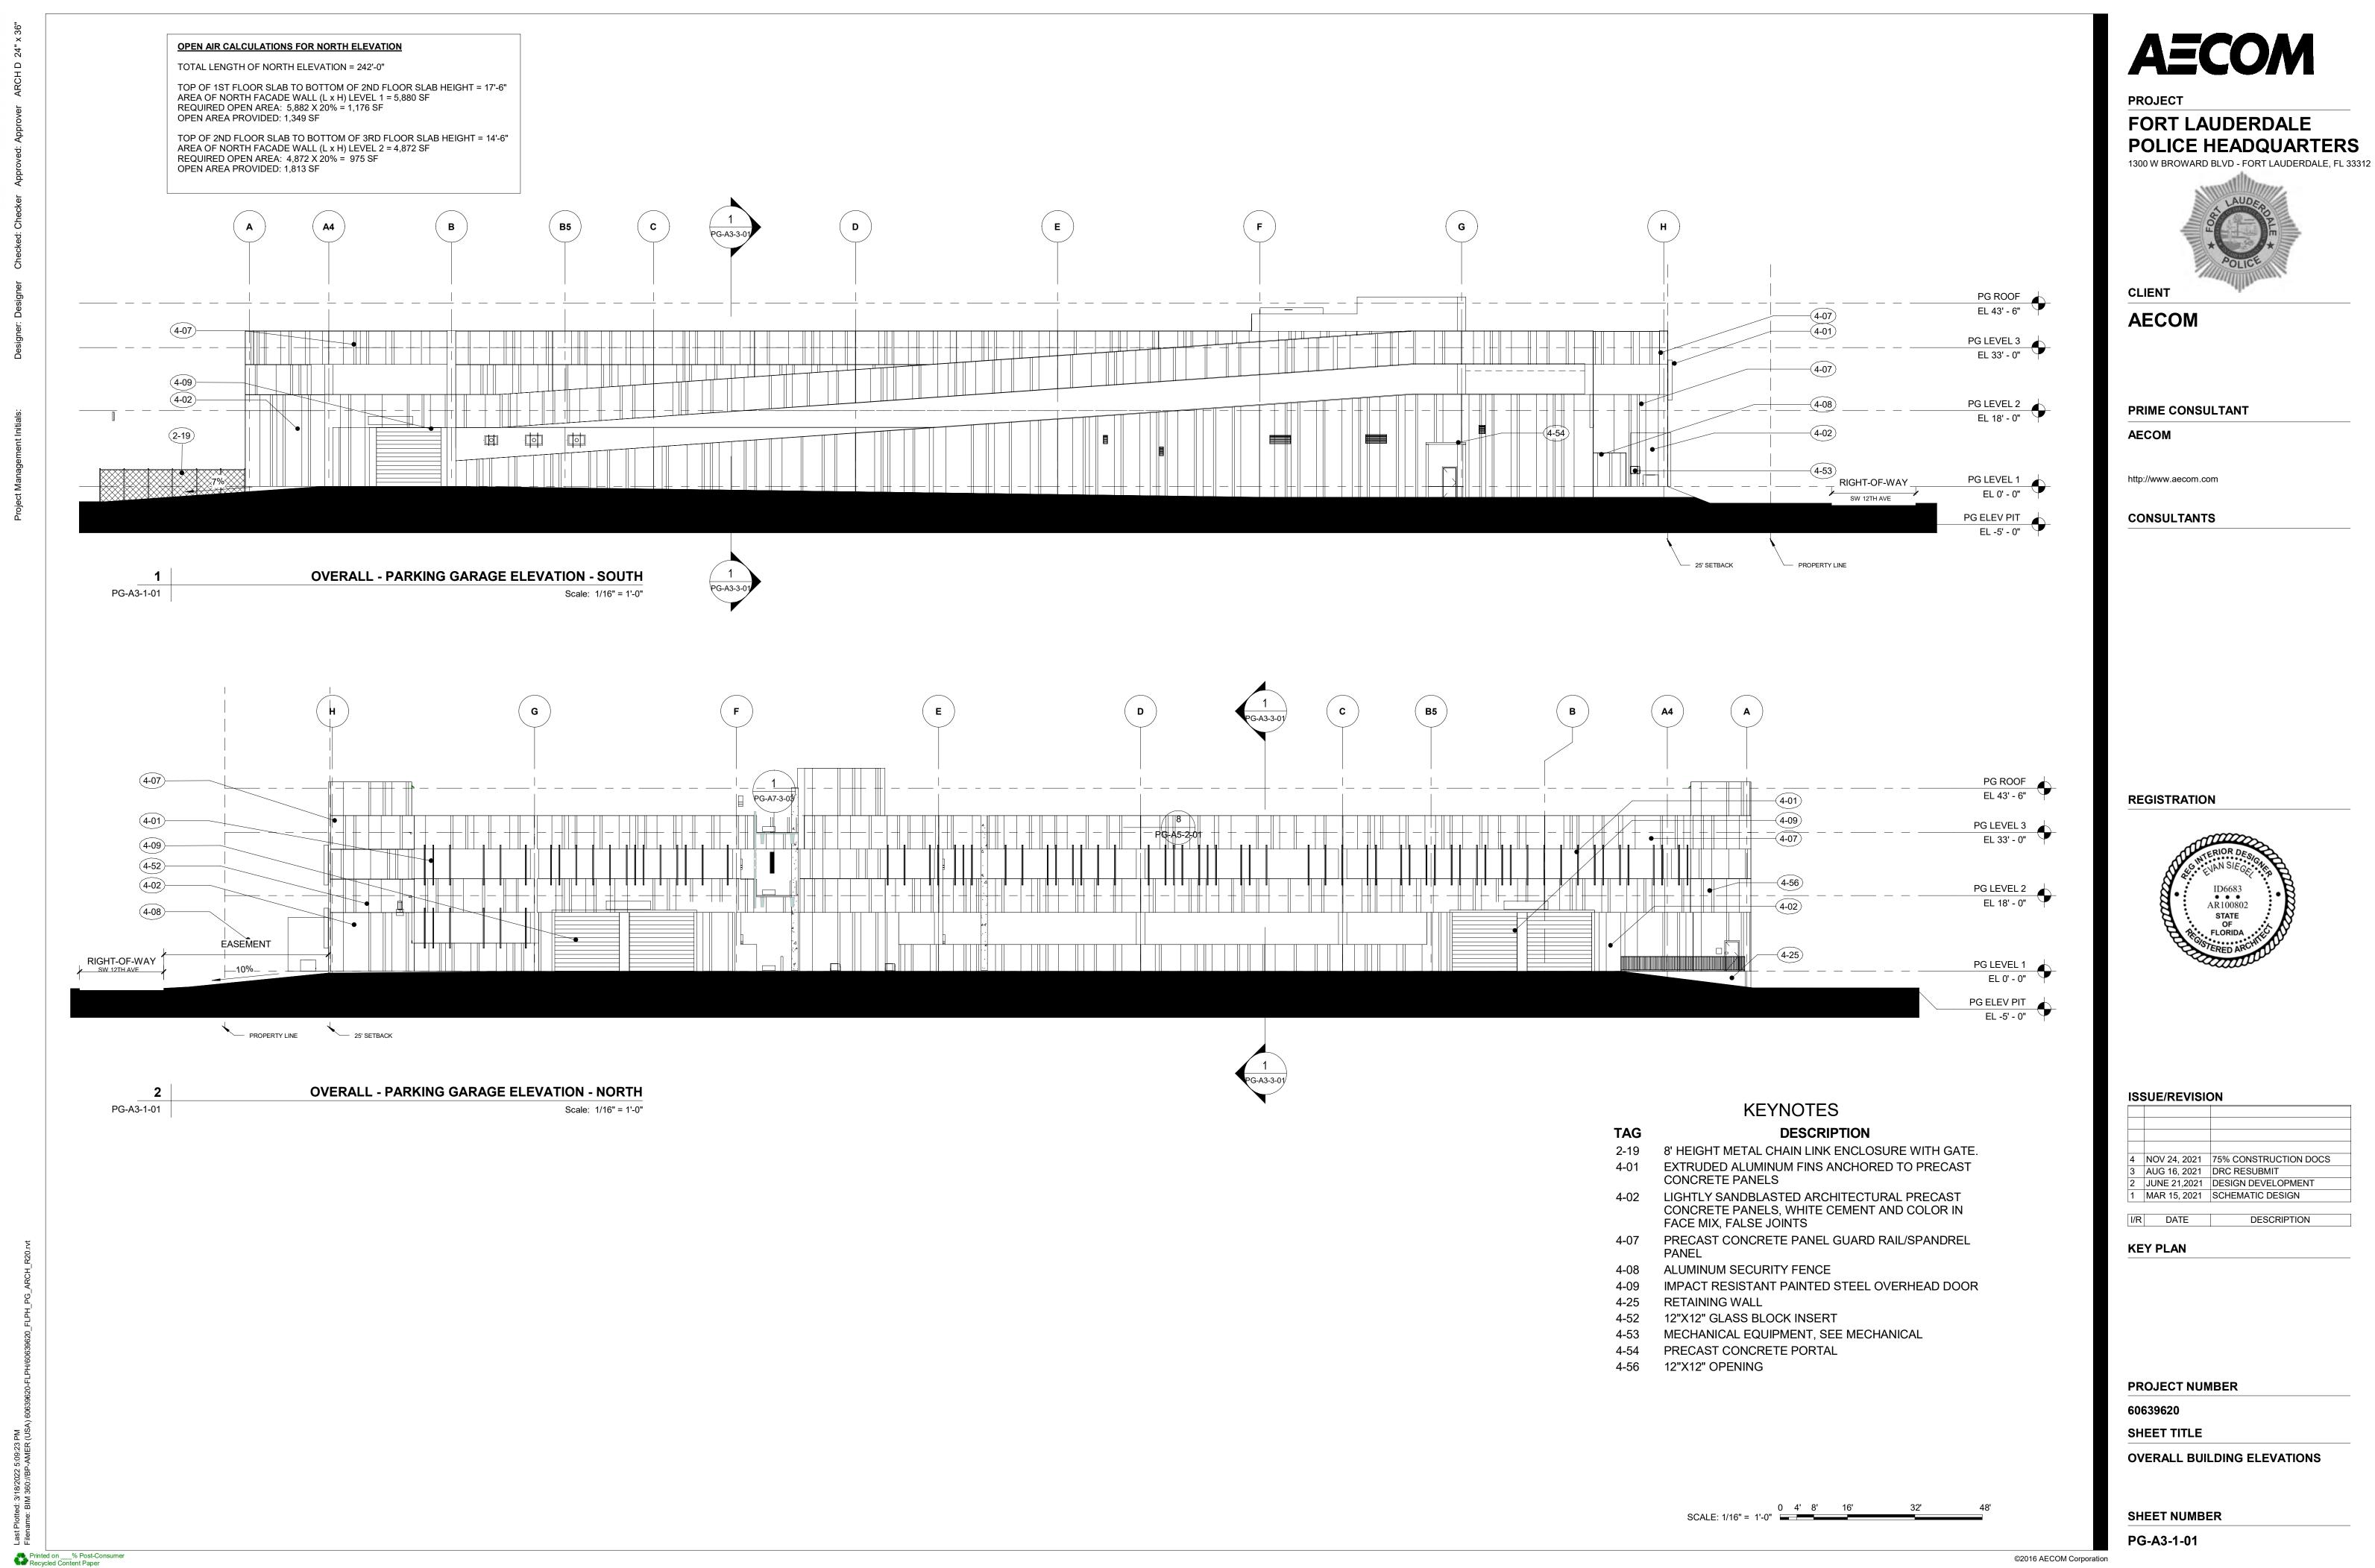


Exhibit 2





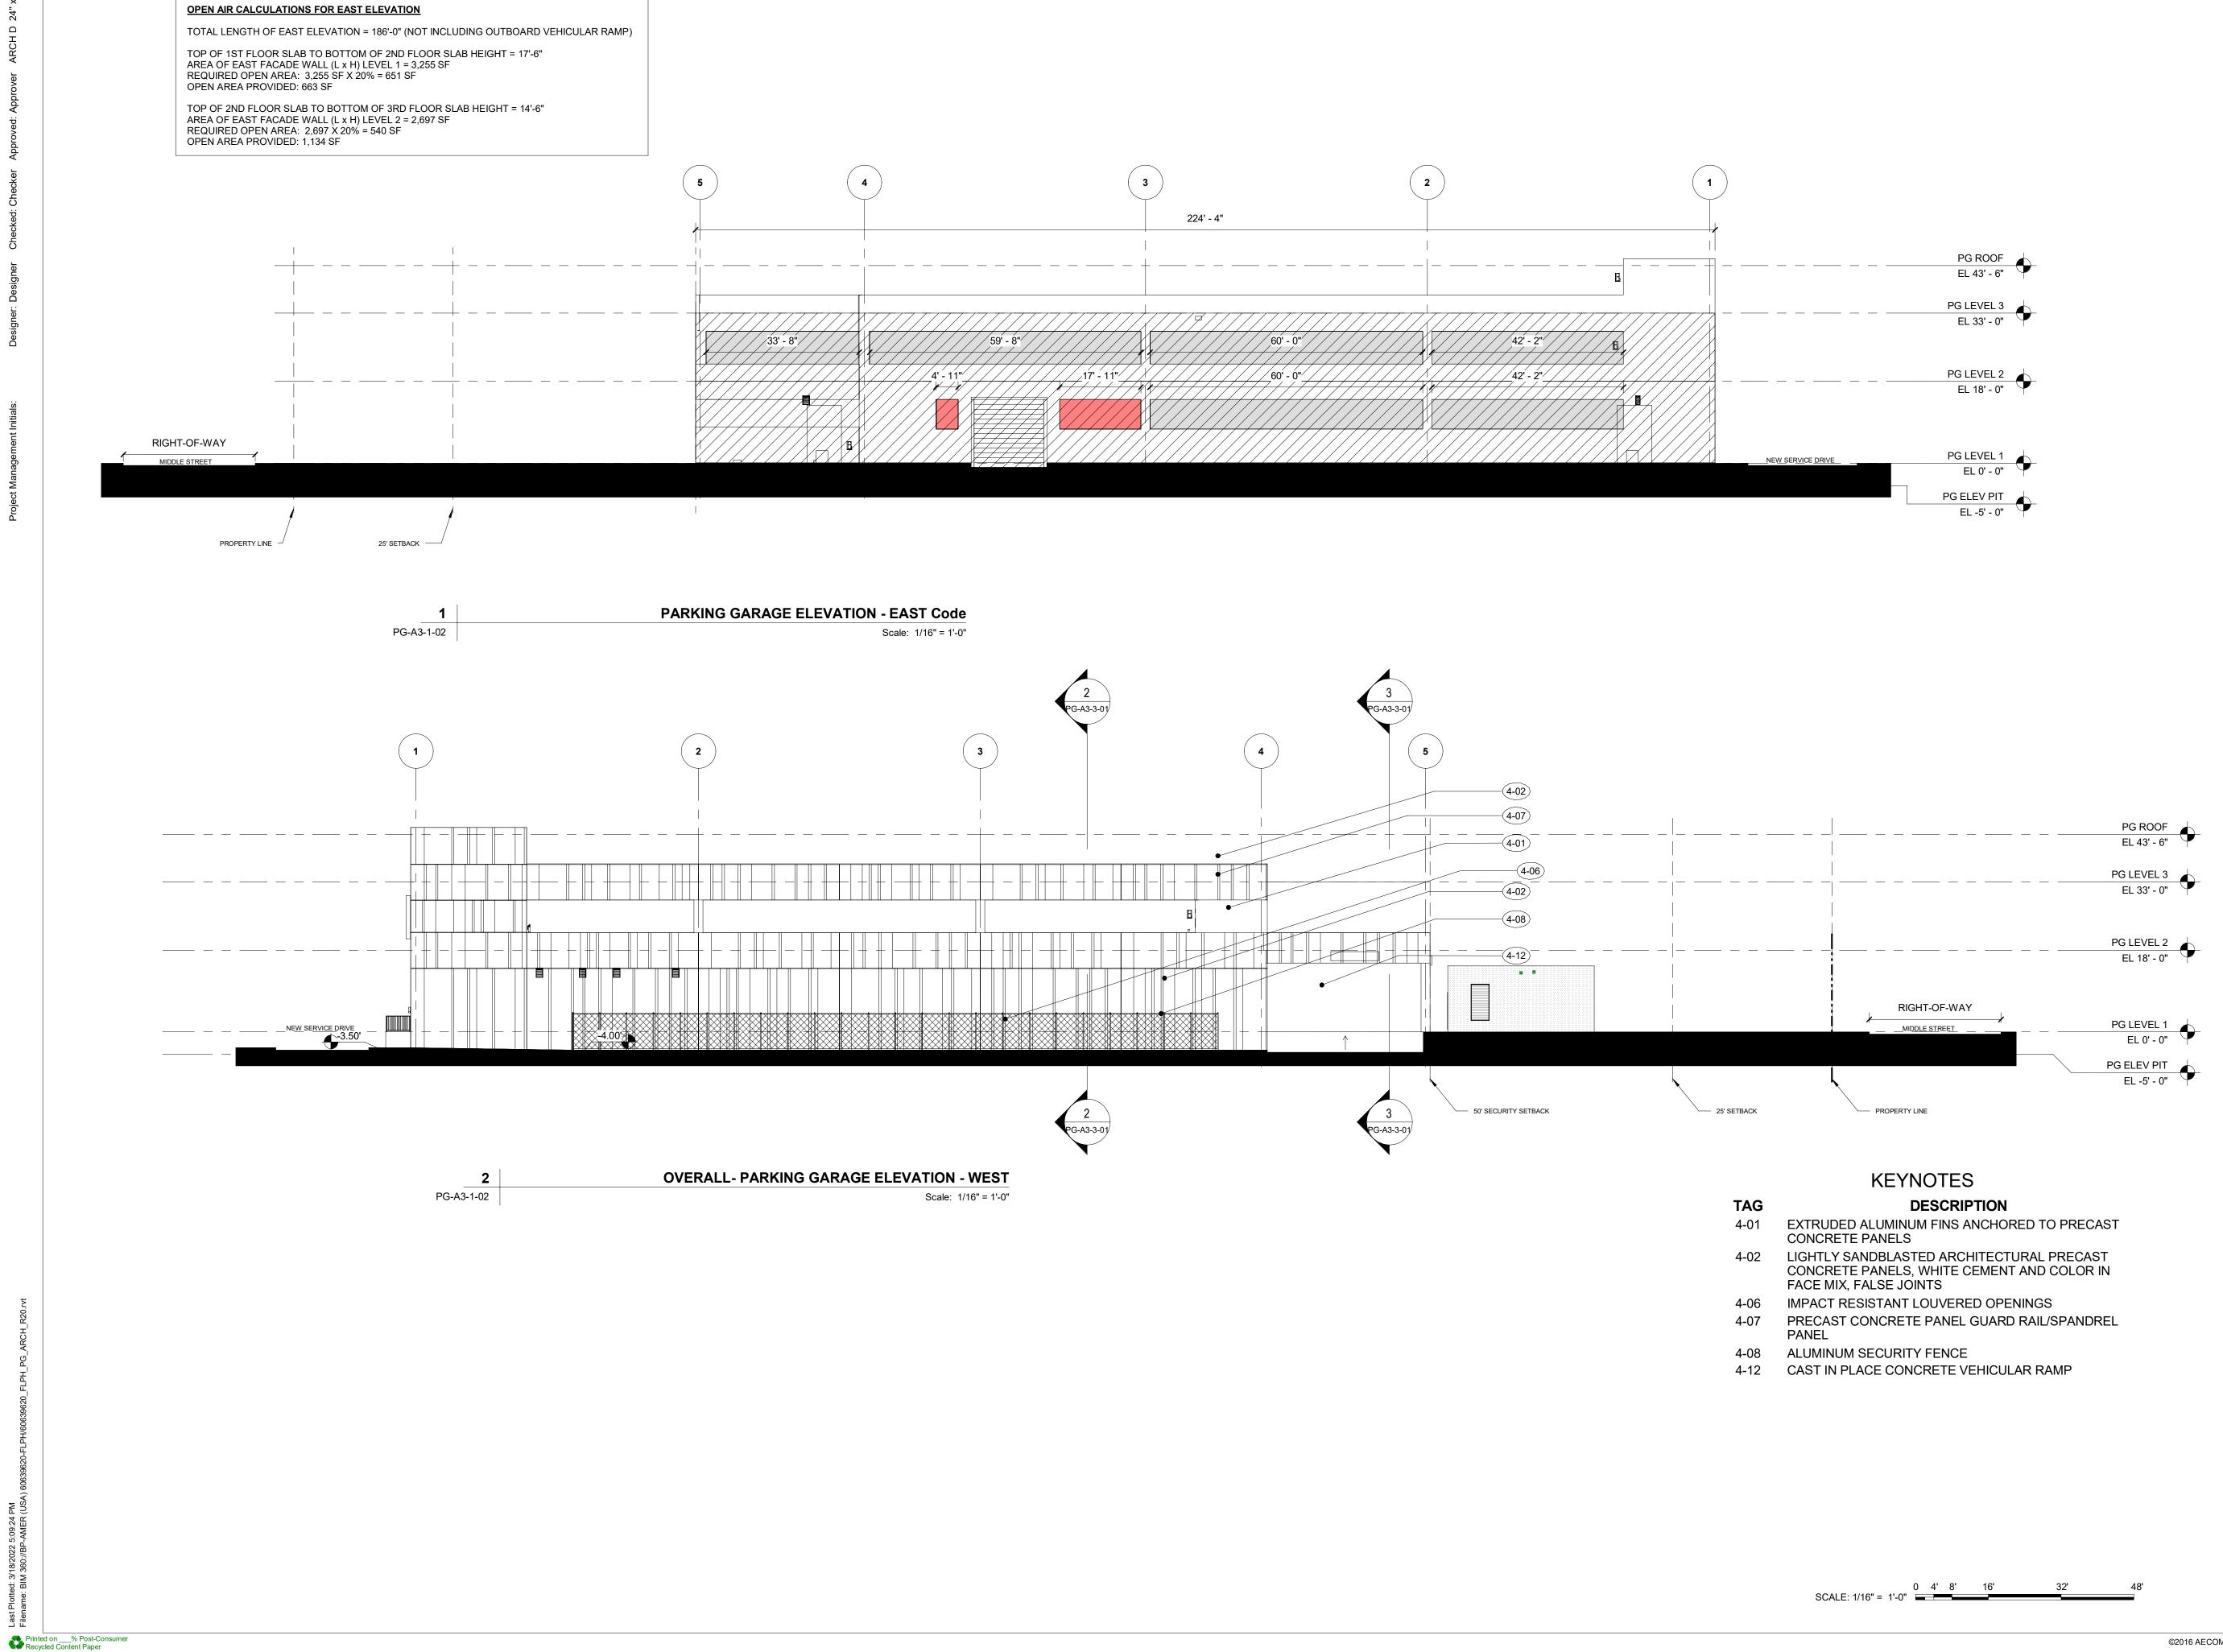

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FORT LAUDERDALE POLICE HEADQUARTERS 1300 W BROWARD BLVD - FORT LAUDERDALE, FL 33312



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DESCRIPTION

KEY PLAN

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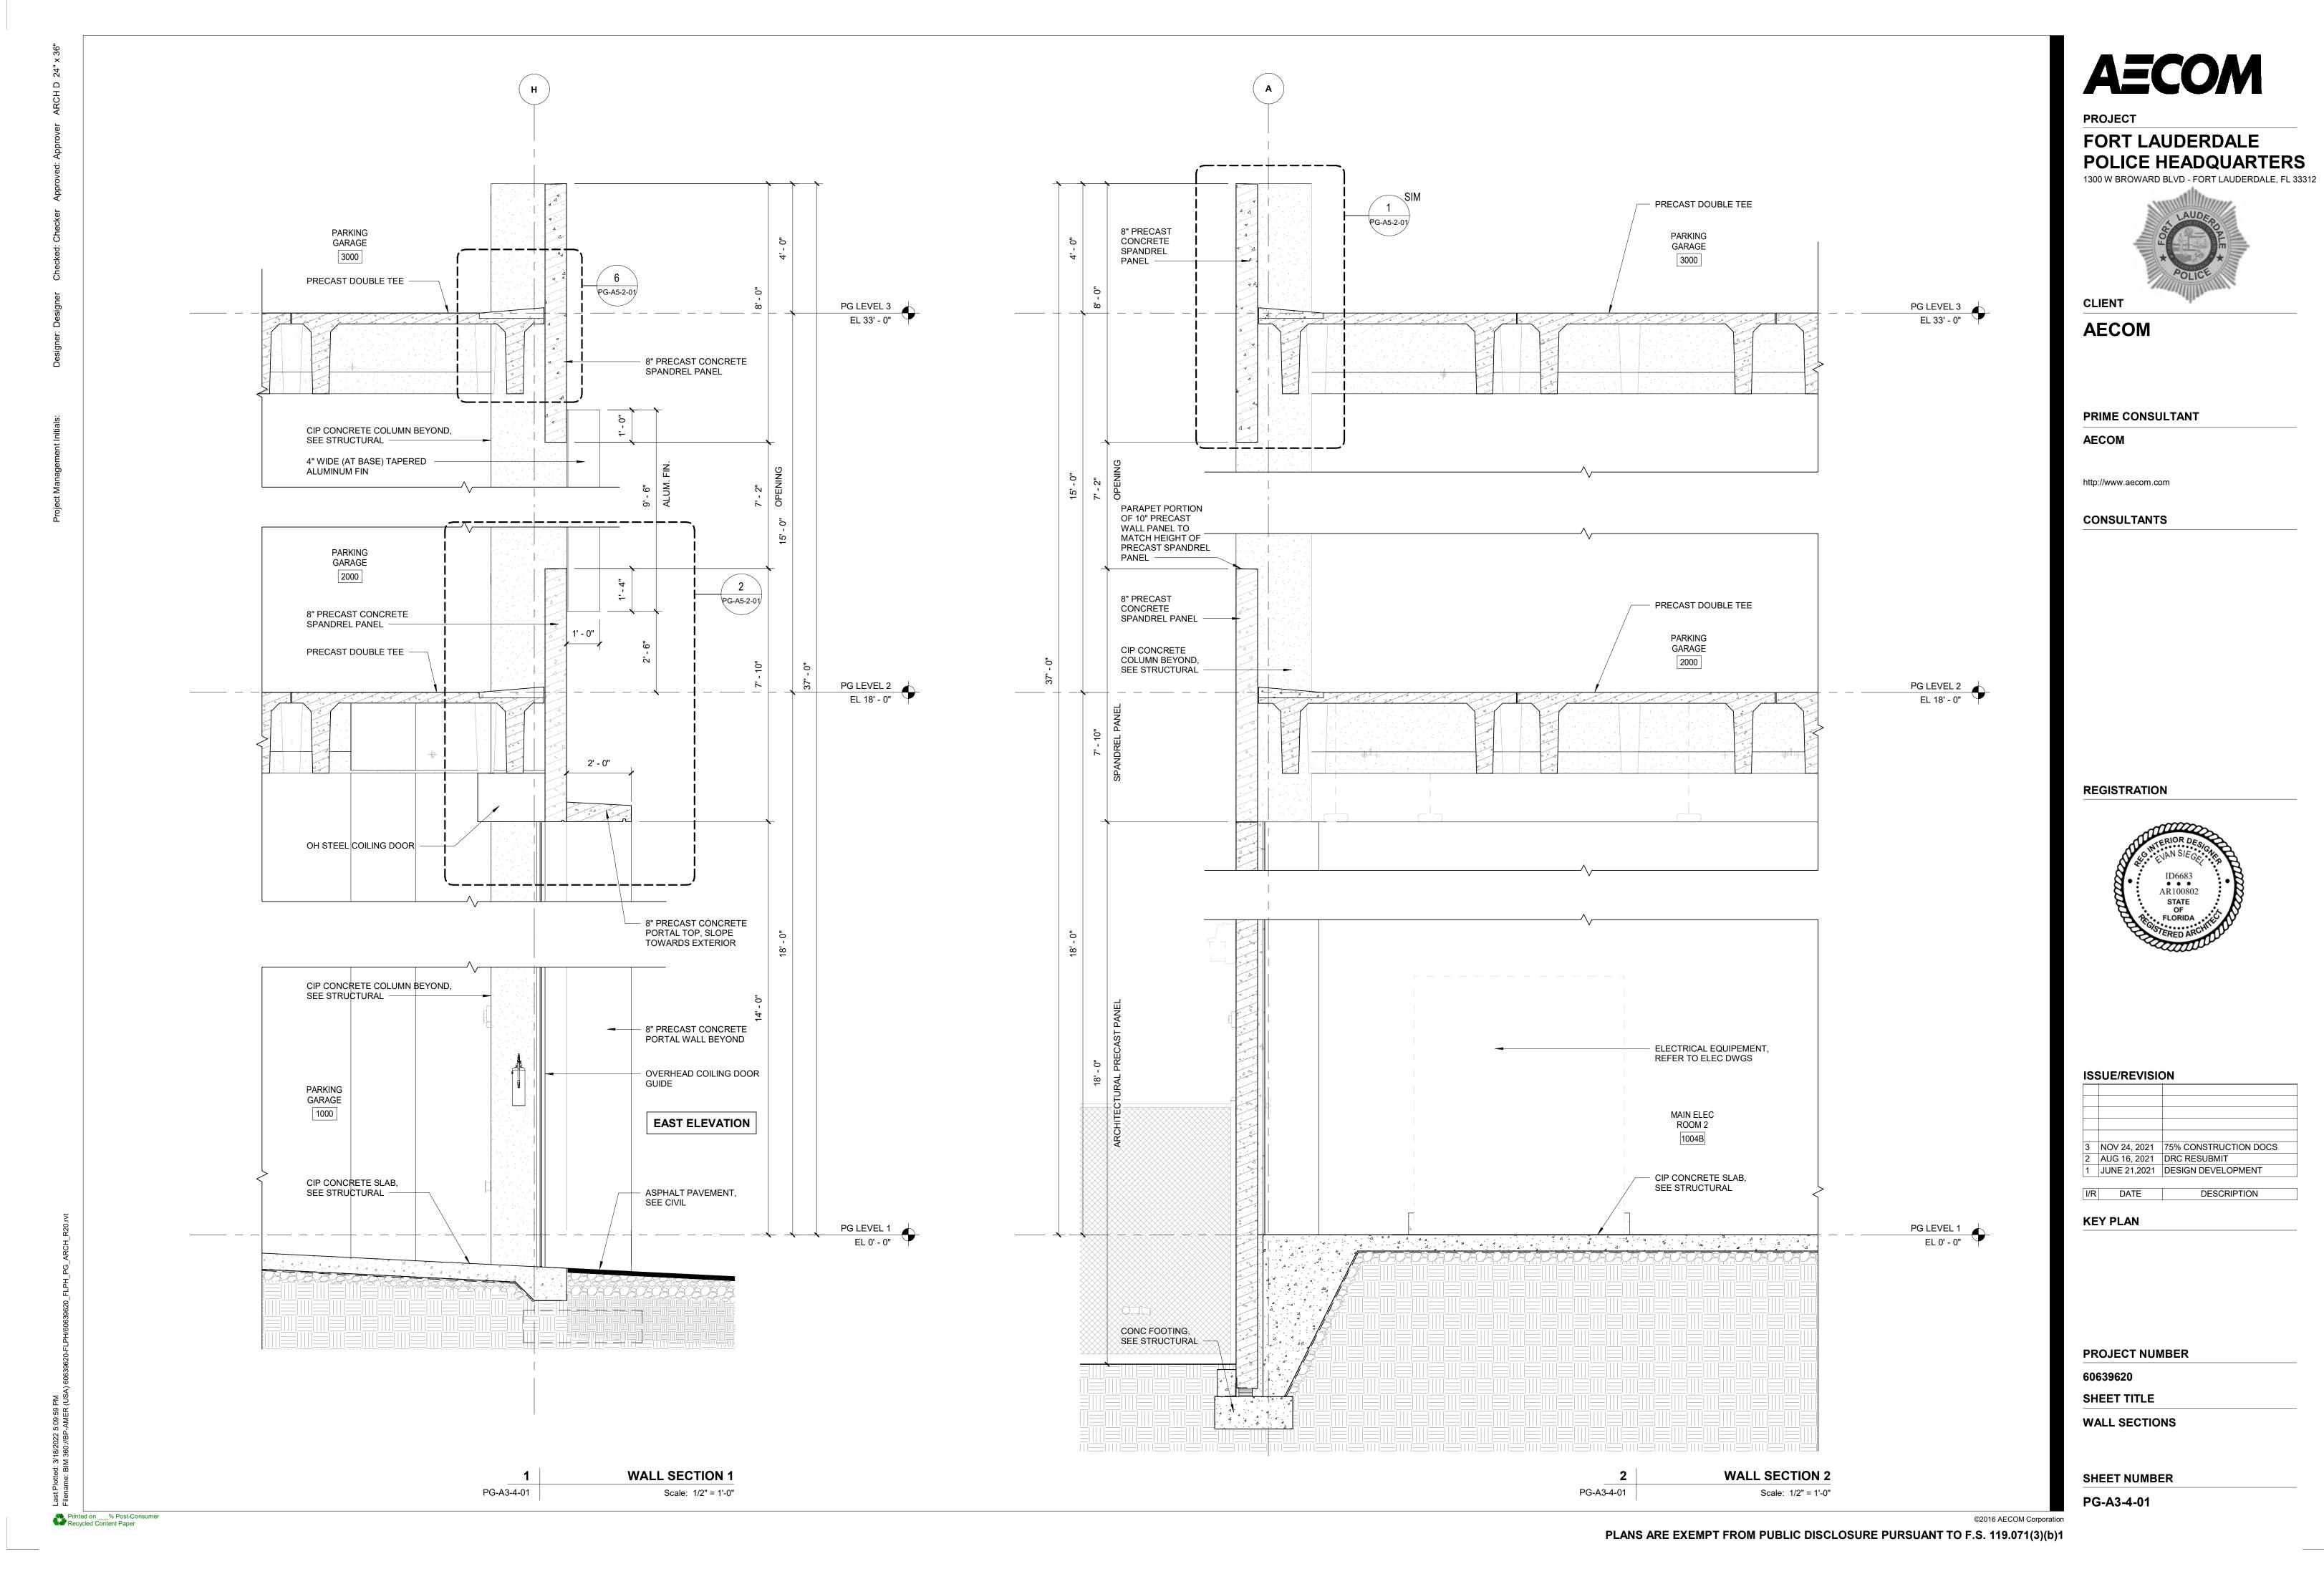
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OVERALL BUILDING ELEVATIONS


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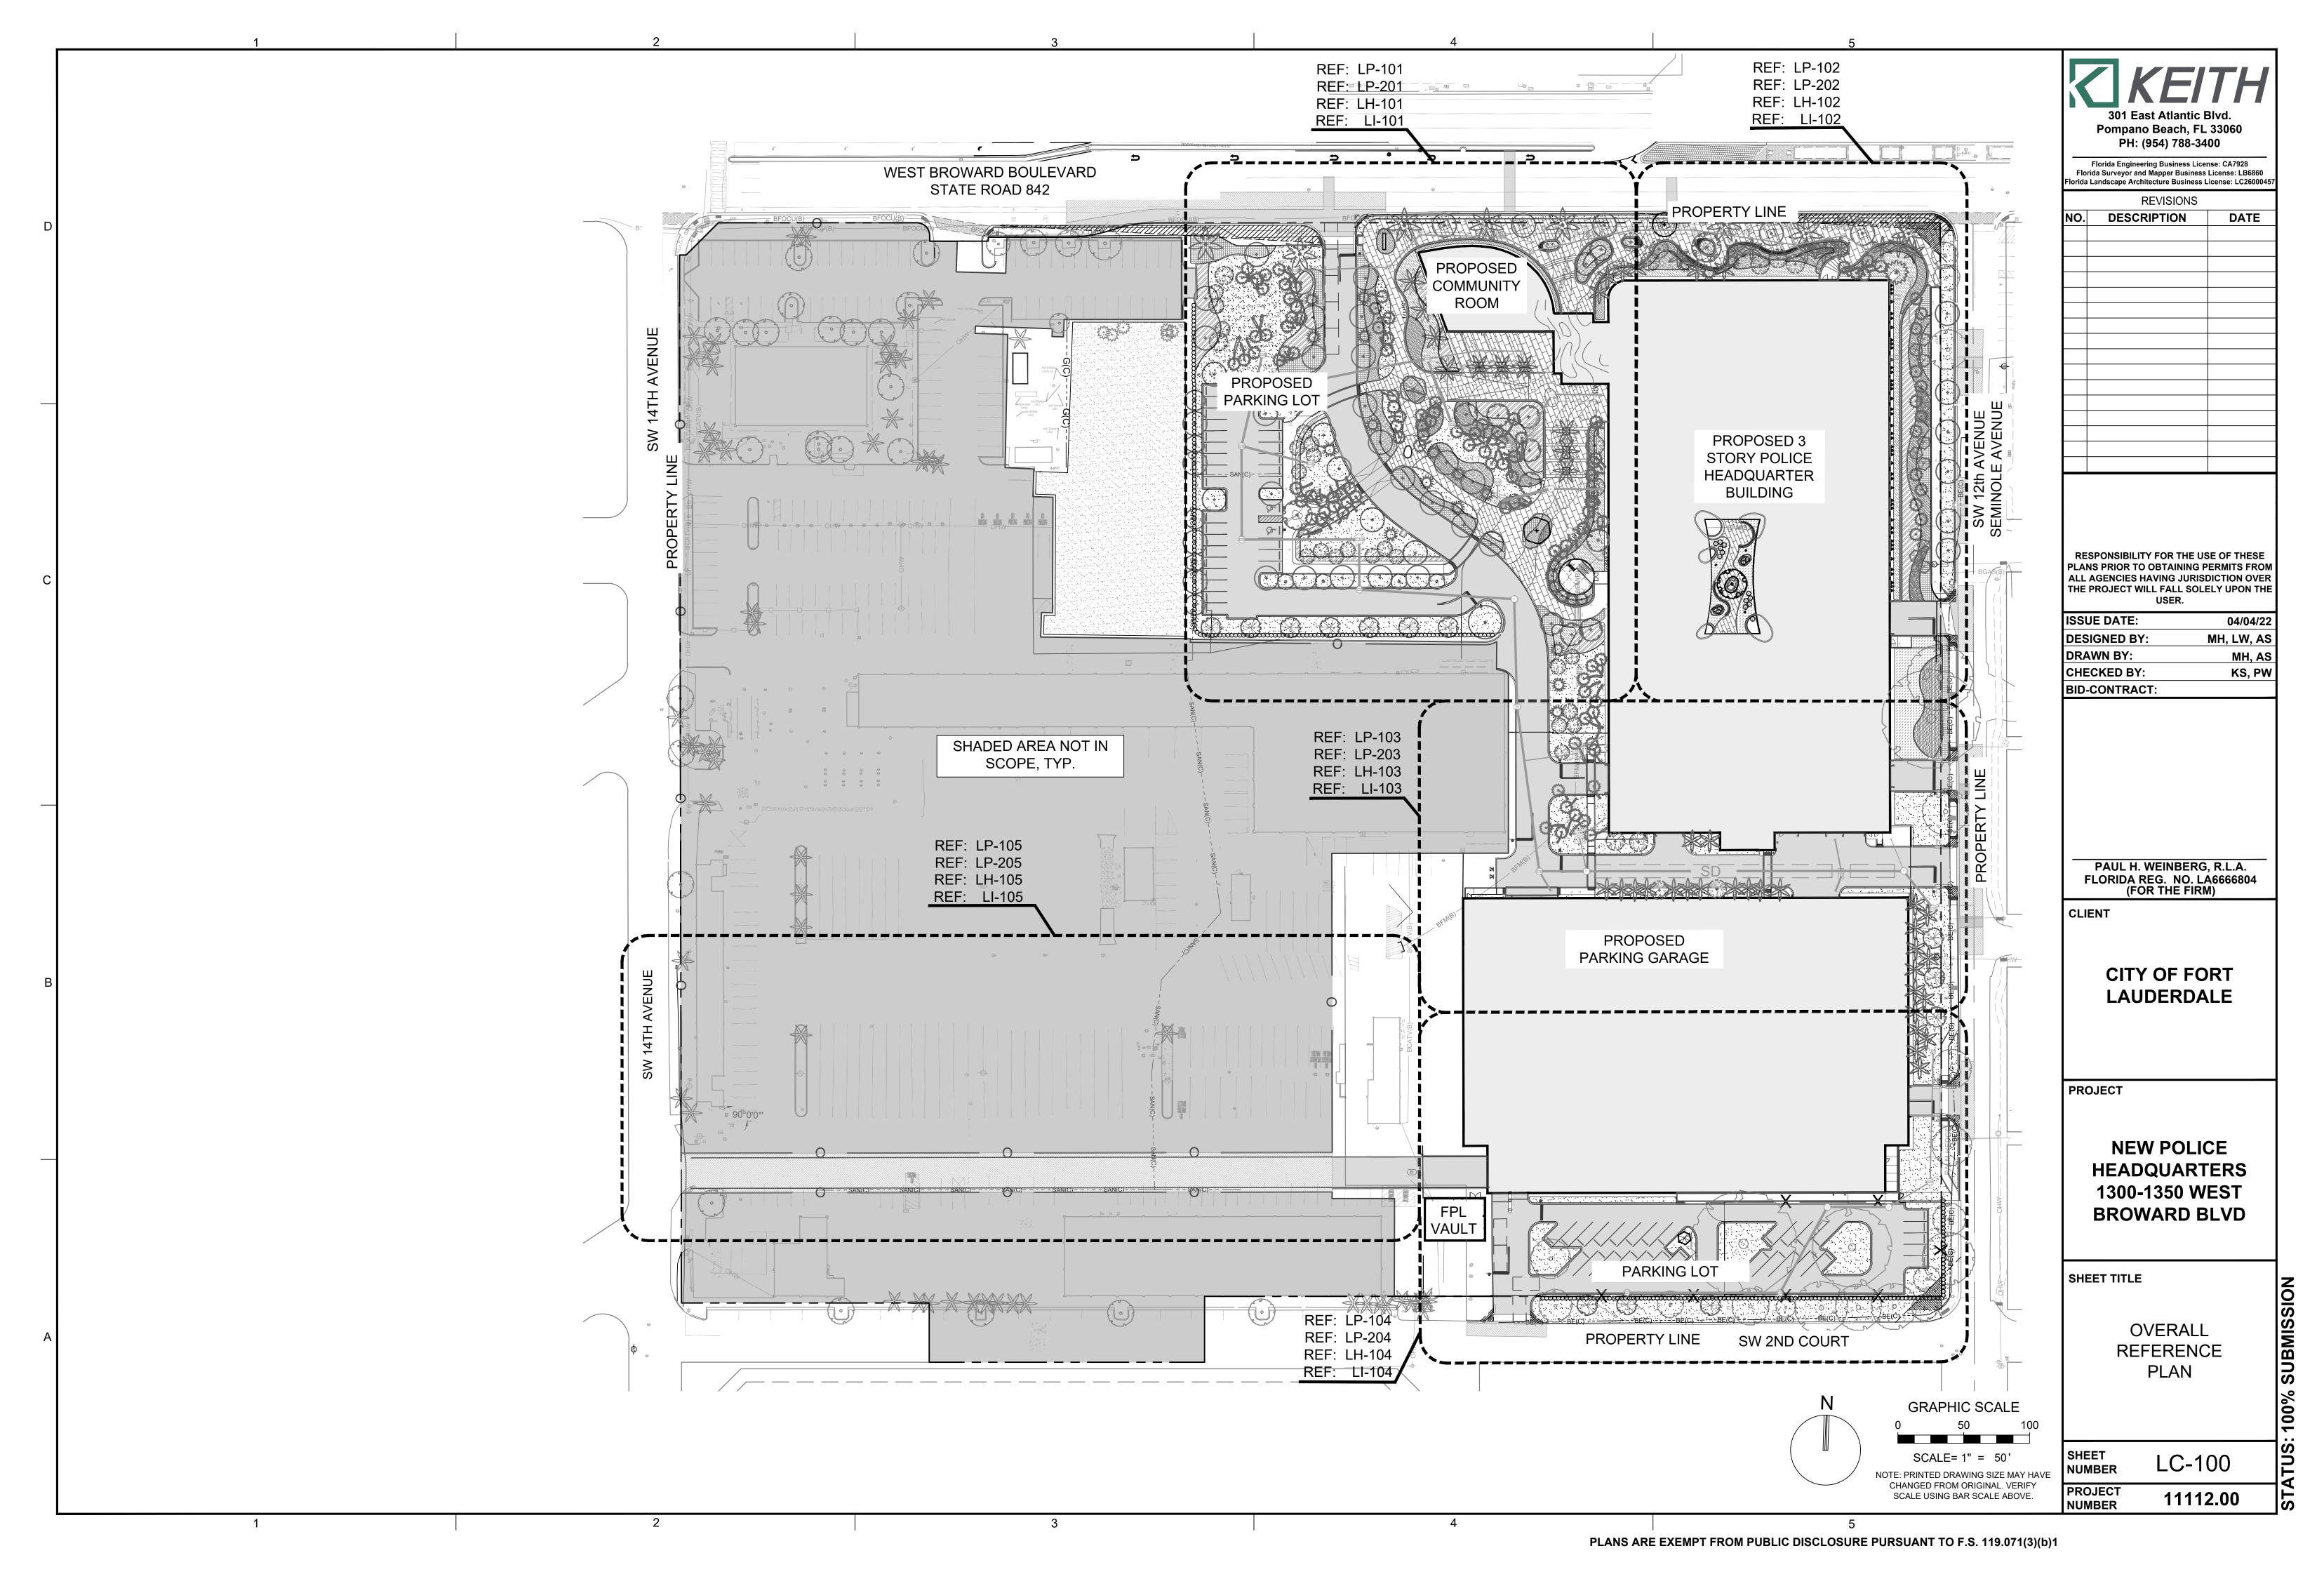
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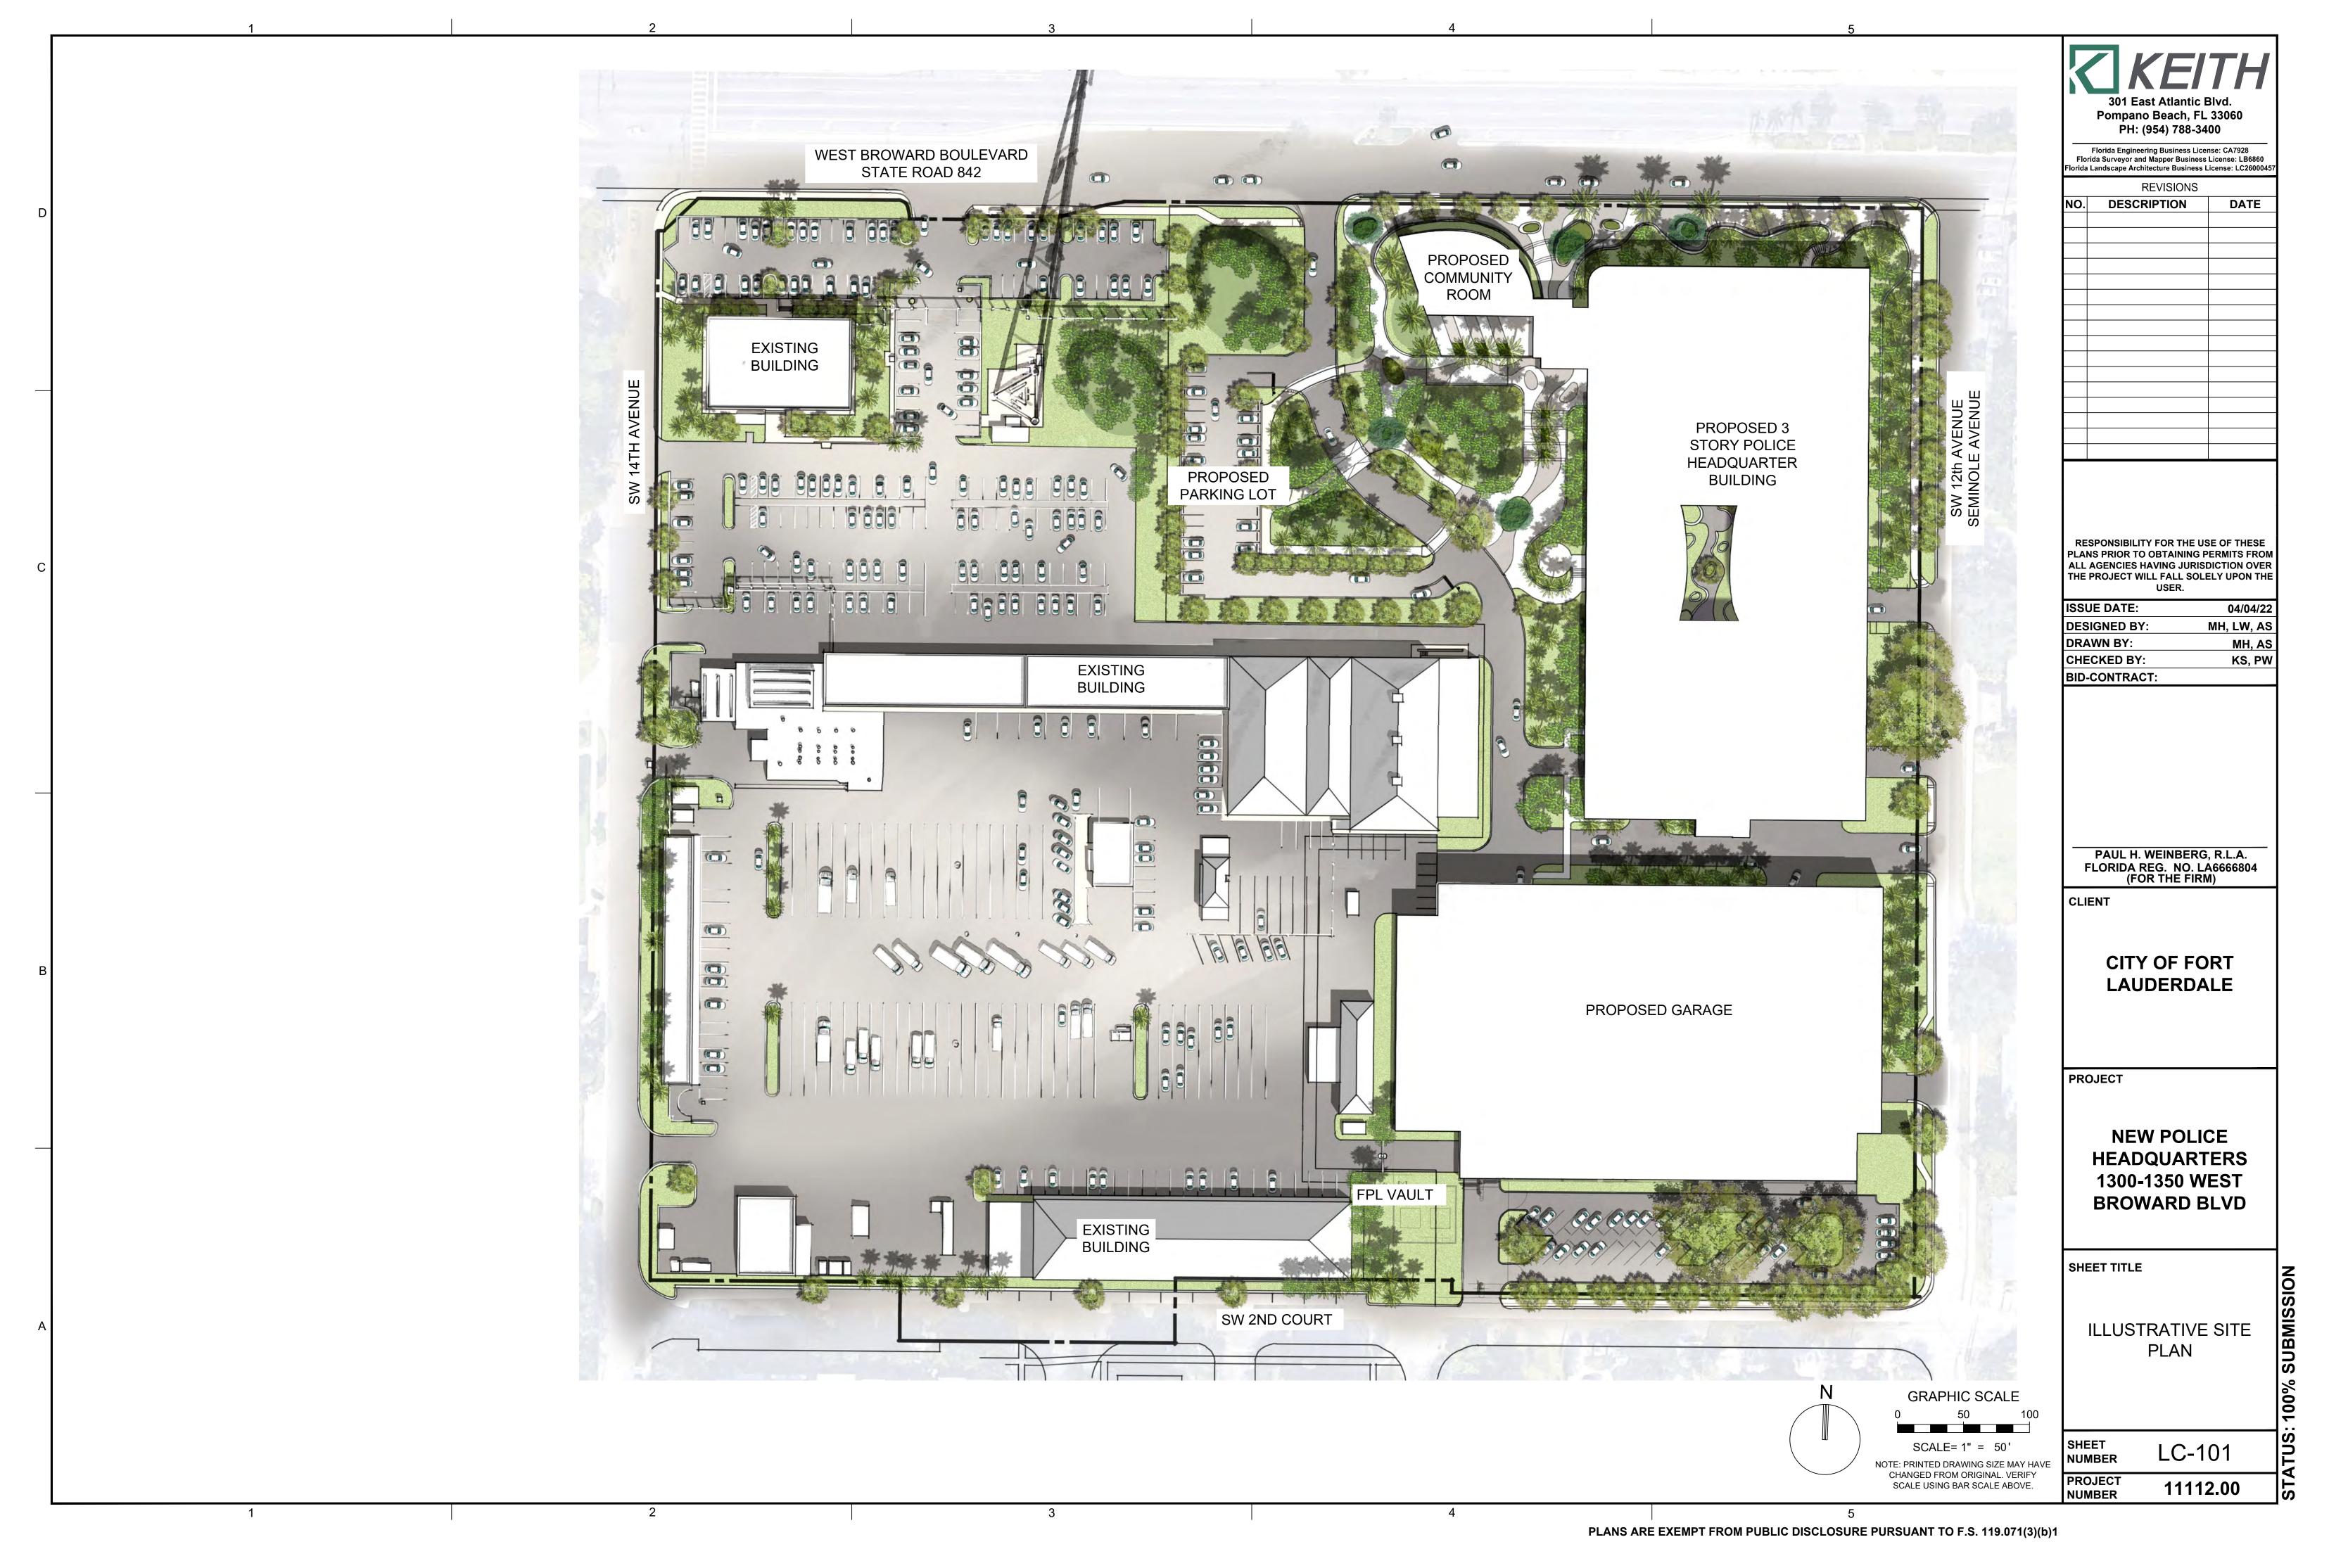



CAM #22-0702 Exhibit 2 Page 45 of 65



CAM #22-0702 Exhibit 2 Page 46 of 65



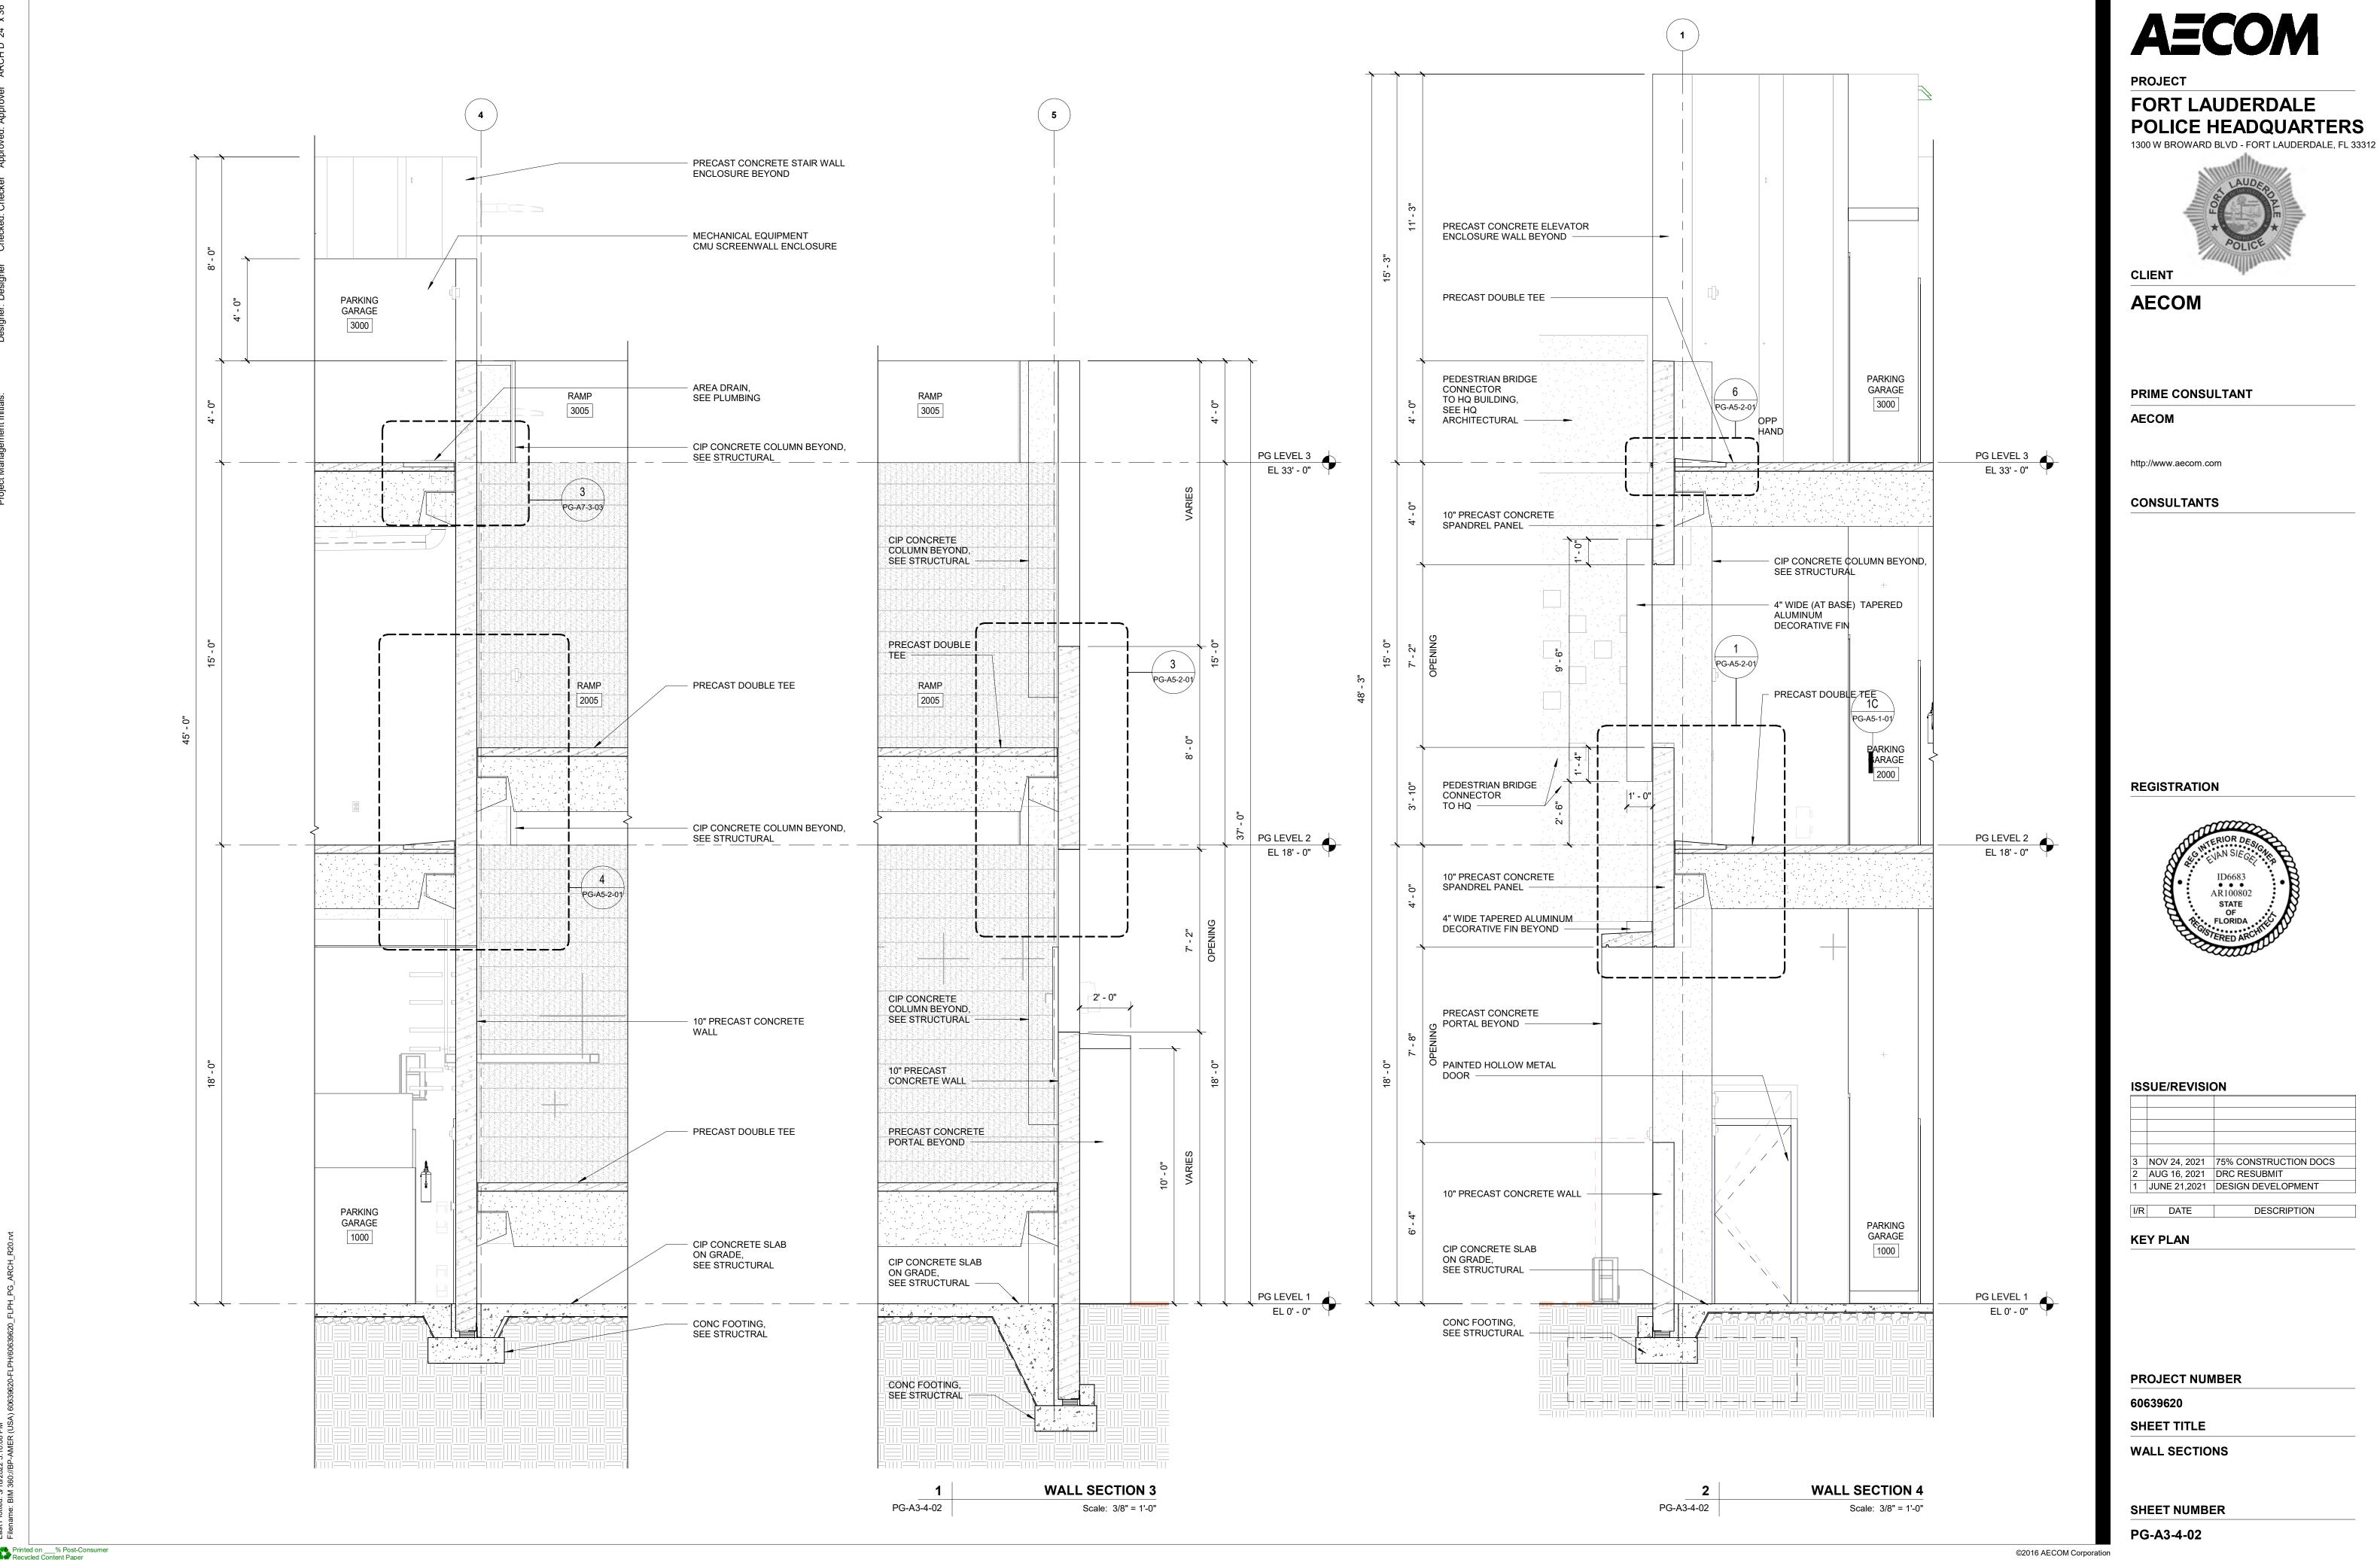

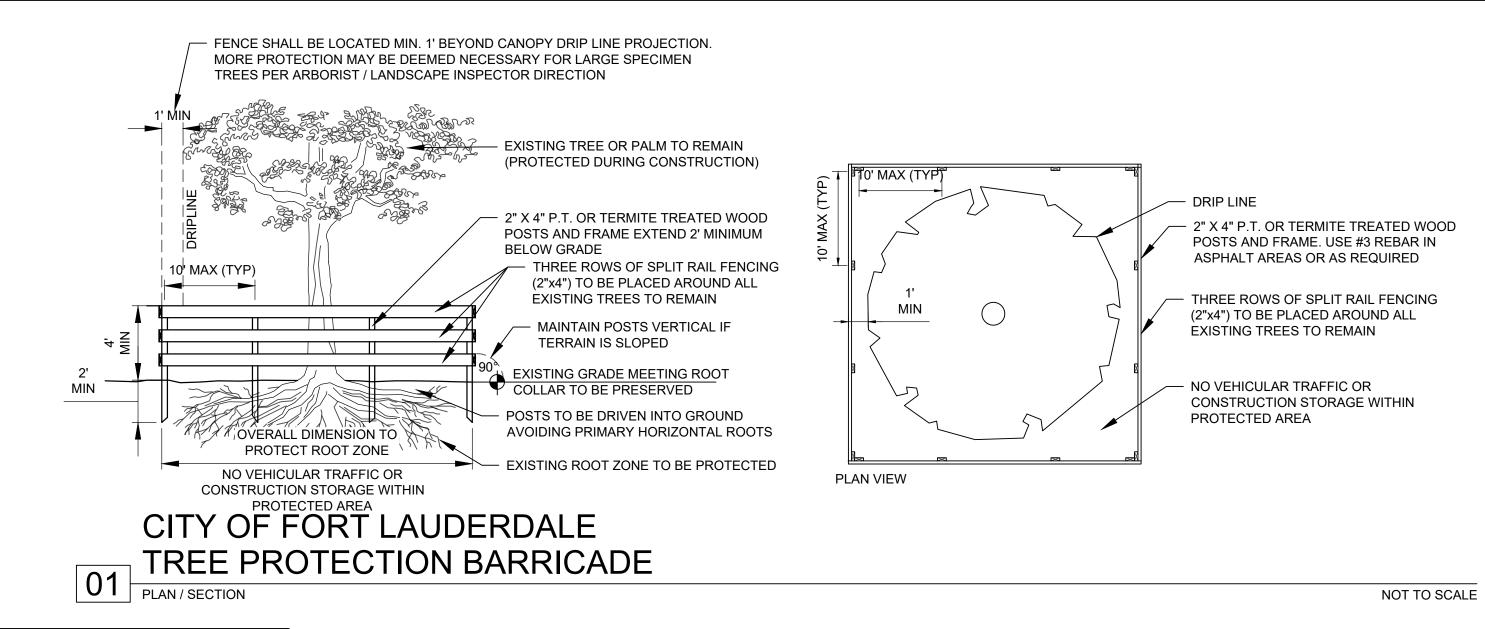

TREE DISPOSITION TABLE

TREE DISPOSITION TABLE PROJECT #: 11112.00 PROJECT NAME: FORT LAUDERDALE POLICE HEADQUARTERS DBH HT. CNPY. TREE % TREE TOTAL DBH TO # COMMONNAME SCIENTIFIC NAME IN. FT. FT. CONDITION DISPOSITION REMOVE
 26
 60
 70
 80%
 REMOVE
 26
 LEANING SLIGHTLY

 5
 16
 10
 60%
 REMOVE
 5
 POOR, SHADED, CO-[
 1 LIVE OAK "Quercus virginiana" 2 PINK TAB 5 POOR, SHADED, CO-D Tabebuia heterophylla' 3 LIVE OAK 15 25 25 60% REMOVE 15 INC, 1-SIDED, CO-D, SHADED, MAJOR BD "Quercus virginiana" 15 23 25 60% REMOVE 15 LEANING, SHARED ROOTS, BD, LEANING 4 LIVE OAK "Quercus virginiana" 5 LIVE OAK "Quercus virginiana" | 23 | 40 | 60 | 65% REMOVE 23 CO-D, SHARED ROOTS, BD, OPEN WOUND 6 LIVE OAK 23 SHARED CANOPY, LEANING, SURFACE ROOTS "Quercus virginiana" 70% REMOVE 70% REMOVE 17 SHARED CANOPY, LEANING, SURFACE ROOTS 7 LIVE OAK "Quercus virginiana" SHARED CANOPY, LEANING, CO-D, CONJOINED, POOR 8 LIVE OAK REMOVE 37 "Quercus virginiana" PRUNING, CUT STEM, SURFACE ROOTS, ROOT DAMAGE 9 LIVE OAK 20 | 30 | 35 | 65% | REMOVE | 20 | SUCKERS, LEANING, BRANCH DMG "Quercus virginiana" 10 LIVE OAK 15 | 25 | 30 | 65% | REMOVE | 15 | SHARED CANOPY "Quercus virginiana" 11 LIVE OAK 32 SHARED CANOPY, FICUS ATTACHED, BD "Quercus virginiana" 75% REMOVE 12 LAUREL OAK 30% | REMOVE | 30 | POOR, T DMG, DEAD WOOD "Quercus laurifolia" 14, 16 | 25 | 30 | 13 LIVE OAK REMOVE 24 POOR, T DMG, ONE SIDED, MAJOR WOUND, LEANING "Quercus virginiana" 24 | 25 | 40 | 60% 14 LIVE OAK 37 DECAY, BREAKAGE, LEANING REMOVE "Quercus virginiana" 65% 15 LIVE OAK 75% REMOVE "Quercus virginiana" 16 LIVE OAK 18 PHY TOPIAS, EXPOSED WOOD "Quercus virginiana" 55% | REMOVE | 18 | 48 | 17 LIVE OAK 15 25 50 55% REMOVE 15 "Quercus virginiana" 18 LIVE OAK "Quercus virginiana" 16 30 45 55% REMOVE 16 EXPOSED WOOD, SUCKERS 19 WATER OAK 33 POOR, BD, DEAD, STUMP 33 0 0 0% REMOVE "Quercus nigra" 30 35 70% REMAIN 20 LIVE OAK SHARED CANOPY "Quercus virginiana" 21 LIVE OAK "Quercus virginiana" 31 | 30 | 60 | 70% | REMAIN 22 |LIVE OAK 70% REMAIN SPARCE CANOPY 23 LIVE OAK 60% REMAIN CO-D, SURFACE ROOTS, SPARCE CANOPY "Quercus virginiana" 24 LIVE OAK 60% REMOVE 12.5 DB, DECLINE, SPARCE CANOPY "Quercus virginiana" SURFACE ROOTS DECAY ROOT DAMAGE FROM VEHICLES 25 LIVE OAK 60% REMOVE "Quercus virginiana" 26 LAUREL OAK 60% REMOVE "Quercus laurifolia" 27 PINK TAB 0% REMOVE 3 DEAD "Tabebuia heterophylla" 3 14 5 38 30 40 65% REMOVE 38 CO-D, VINES, POOR PRUNING, THIN SHARED CANOPY 28 LIVE OAK "Quercus virginiana" 29 LIVE OAK
30 LIVE OAK
31 SLASH PINE
 36
 35
 65
 65%
 REMOVE
 36
 DECAY, TERMITES PRESENT, CO-D

 41
 50
 80
 70%
 REMOVE
 41
 SURFACE ROOTS, TERMITES
 "Quercus virginiana" "Quercus virginiana" "Pinus elliottii" 17 40 35 60% REMOVE 17 BD, THIN CANOPY 32 LIVE OAK "Quercus virginiana" 27 35 35 70% REMOVE 27 DB 33 LIVE OAK 32 30 40 60% REMOVE 32 POOR PRUNING, SUCKERS, DECAY, CO-D "Quercus virginiana" 34 SLASH PINE "Pinus elliottii" 17 40 35 60% REMOVE 17 THIN 35 LIVE OAK 32 40 50 50% REMOVE 32 BD, DECAY, CLUSIA VINES "Quercus virginiana" 36 PONGAM "Pongamia pinnata" 17 30 24 60% REMOVE 37 PONGAM "Pongamia pinnata" 9 | 15 | 20 | 50% | REMOVE | 38 LIVE OAK 39 LIVE OAK 65% REMOVE 13 SHARED CANOPY, RESTRICTED ROOT ZONES "Quercus virginiana" "Quercus virginiana" 60% REMOVE 9 SHARED CANOPY, RESTRICTED ROOT ZONES 40 LIVE OAK "Quercus virginiana" 18 45 35 60% REMOVE 18 SHARED CANOPY, RESTRICTED ROOT ZONES 10 40 30 60% REMOVE 10 SHARED CANOPY, RESTRICTED ROOT ZONES 41 LIVE OAK "Quercus virginiana" 42 LIVE OAK 60% REMOVE 17.5 SHARED CANOPY, RESTRICTED ROOT ZONES, DB "Quercus virginiana" 43 LIVE OAK 60% REMOVE 16 SHARED CANOPY, RESTRICTED ROOT ZONES, BAD STRUCTUR "Quercus virginiana" 44 ACACIA 19 40 40 50% REMOVE 19 POOR "Acacia auriculiformis" 45 ACACIA "Acacia auriculiformis" 46 LIVE OAK "Quercus virginiana" 15.5 25 25 70% REMOVE 15.5 SHARED CANOPY 47 LIVE OAK 25 25 70% REMOVE 25 25 70% REMOVE "Quercus virginiana" 15 SHARED CANOPY 48 LIVE OAK "Quercus virginiana" SHARED CANOPY 49 LIVE OAK 15 25 25 55% REMOVE 15 SHARED CANOPY, CO-D, POOR "Quercus virginiana" 50 LIVE OAK 15 25 25 65% REMOVE "Quercus virginiana" 15 INC, OVER PRUNED 51 SABAL PALM
 18 CT
 12
 65%
 REMOVE

 16 CT
 12
 65%
 REMOVE
 "Sabal palmetto" CONSTRICTION 52 SABAL PALM "Sabal palmetto" CONSTRICTION 18 CT 12 65% REMOVE 53 SABAL PALM "Sabal palmetto" CONSTRICTION 54 SABAL PALM "Sabal palmetto" 16 CT 12 65% REMOVE CONSTRICTION, CURVED 10 22 20 70% REMAIN 55 LIVE OAK "Quercus virginiana" STREET TREE, 56 LIVE OAK
 10
 20
 20
 65%
 REMAIN

 12
 25
 30
 70%
 REMAIN
 "Quercus virginiana" STREET TREE, PRUNING 57 LIVE OAK "Quercus virginiana" 58 SABAL PALM "Sabal palmetto" 18 CT 12 65% REMOVE CONSTRICTION 58B SABAL PALM 16 CT 12 65% "Sabal palmetto" CONSTRICTION 59 SABAL PALM 65% REMOVE "Sabal palmetto" CONSTRICTION 60 SABAL PALM 16 CT 12 65% REMOVE "Sabal palmetto" CONSTRICTION 15 CT 12 65% REMOVE 61 SABAL PALM "Sabal palmetto" CONSTRICTION 62 LIVE OAK 23 50 35 65% REMOVE "Quercus virginiana" LEANING, UTILITY PRUNED, CO-D, SUCKERS "Quercus virginiana" 63 LIVE OAK 22 | 25 | 30 | 70% | REMOVE SHARED CAN, FENCE 26 40 50 75% REMAIN 64 JAVA PLUM "Syzygium cumini" 65 LIVE OAK 25, 35 45 75 70% REMAIN "Quercus virginiana" EXPOSED WOOD. MINOR BD 66 SABAL PALM 16 CT 12 65% REMOVE "Sabal palmetto" CONSTRICTION, LEANING 67 MAHOGANY 20 30 45 70% REMOVE 'Swietenia mahagoni" 68 MAHOGANY REMAIN Swietenia mahagoni" EANING, VINES, MINOR DB 69 MAHOGANY 18.5 30 30 70% REMAIN Swietenia mahagoni" DB, VINES, CO-D 70 MAHOGANY "Swietenia mahagoni" 11 20 30 REMAIN D, ONE-SIDED 60% 71 MAHOGANY 'Swietenia mahagoni" 10 | 25 | 30 | 70% REMAIN 'Swietenia mahagoni" 72 MAHOGANY 9 25 28 75% REMAIN 15 20 25 65% REMAIN 73 MAHOGANY 'Swietenia mahagoni" EANING, THIN, DB 18 20 40 65% REMAIN 74 MAHOGANY Swietenia mahagoni" 75 MAHOGANY 12 35 25 65% REMAIN "Swietenia mahagoni" MAJOR TW, FIRE ANTS 76 MAHOGANY Swietenia mahagoni" 12 20 35 70% REMAIN 77 MAHOGANY "Swietenia mahagoni" 16 25 35 60% REMAIN

PRUNING DMG, MAJOR TD, DECAY

!	COMMONNAME	SCIENTIFIC NAME	DBH IN.	HT.	CNPY.	TREE %	TREE DISPOSITION	TOTAL DBH TO REM OVE	COMMENTS
'8	MAHOGANY	"Swietenia mahagoni"	21.5	40	40	60%	REMAIN	INCIVI UVE	LEANING, BD, PRUNING DMG
' 9	MAHOGANY	"Swietenia mahagoni"	8, 7	30	15	65%	REMAIN		SHADED, THIN CANOPY, PRUNING DMG, CO-D
30	MAHOGANY	"Swietenia mahagoni"	15	35	28	70%	REMAIN		CO-D, SHARED CANOPY
31	MAHOGANY	"Swietenia mahagoni"	15	40	20	70%	REMAIN		
32	MAHOGANY	"Swietenia mahagoni"	14	35	25	60%	REMAIN		BD, DECAY, ONE SIDED, SURFACE ROOTS
33	MAHOGANY	"Swietenia mahagoni"	16	28	28	70%	REMOVE	16	CO-D, SURFACE ROOTS
34	TAMARIND	"Lysiloma latisiliquum"	11	22	30	70%	REMOVE	11	SURFACE ROOTS, ONE-SIDED
35	SABAL PALM	"Sabal palmetto"	111	15 CT		65%	REMOVE	11	TRUNK DAMAGE
36 36	SABAL PALM	"Sabal palmetto"	1	16 CT		65%	REMOVE		
		· · · · · · · · · · · · · · · · · · ·							CONSTRICTION
37	SABAL PALM	"Sabal palmetto"		16 CT		65%	REMOVE		CONSTRICTION
88	SABAL PALM	"Sabal palmetto"		17 CT		65%	REMOVE		CONSTRICTION
39	SABAL PALM	"Sabal palmetto"	10	15 CT	12	65%	REMOVE	40	CONSTRICTION
90	BEAUTYLEAF	"Calophyllum inophyllum"	12			60%	REMOVE	12	DMG
OB .	LAUREL OAK	"Quercus laurifolia"	11			60%	REMOVE	11	SHADED
91	BLACK OLIVE	"Bucida buceras"	14			60%	REMOVE	14	
2	BLACK OLIVE	"Bucída buceras"	15				REMOVE	15	
93	BLACK OLIVE	"Bucida buceras"	15	25	30		REMOVE	15	
94	LIVE OAK	"Quercus virginiana"	25	35	60	75%	REMOVE	25	
95	COCONUT PALM	"Cocos nucifera"		32 CT	15		REMAIN		
96	COCONUT PALM	"Cocos nucifera"	1	35 CT			REMAIN		
97	BLACK OLIVE	"Bucida buceras"	19	35	35		REMAIN		SHARED CANOPY, CO-D
8	BLACK OLIVE	"Bucida buceras"	20	35	35		REMAIN		
9	COCONUT PALM	"Cocos nucifera"		40 CT	•	70%	REMOVE		
00	COCONUT PALM	"Cocos nucifera"		40 CT		70%	REMOVE		
01	CHRISTMAS PALM	"Adonidia memillii"		12 CT	15	75%	REMOVE		TRIPLE
02	COCONUT PALM	"Cocos nucifera"		40 CT		70%	REMOVE		
03	COCONUT PALM	"Cocos nucifera"		40 CT		70%	REMOVE		
04	CHRISTMAS PALM	"Adonidia memillii"		12 CT	15	75%	REMOVE		
05	BLACK OLIVE	"Bucida buceras"	13	25	25	65%	REMOVE	13	
06	BLACK OLIVE	"Bucida buceras"	27	35	40	65%	REMOVE	27	
07	BLACK OLIVE	"Bucida buceras"	16	35	20	65%	REMOVE	16	
80	BLACK OLIVE	"Bucida buceras"	12	35	20	60%	REMOVE	12	
09	BLACK OLIVE	"Bucida buceras"	18	30	30	60%	REMOVE	18	
10	BLACK OLIVE	"Bucida buceras"	19	30	30	65%	REMOVE	19	
11	BLACK OLIVE	"Bucida buceras"	14	20	25	65%	REMAIN		
12	BLACK OLIVE	"Bucida buceras"	13	20	25	60%	REMAIN		
13	BLACK OLIVE	"Bucida buceras"	12	20	20	65%	REMAIN		THIN
14	BLACK OLIVE	"Bucida buceras"	12	20	18	60%	REMAIN		THIN
15	ORANGE GEIGER	"Cordia sebestena"	6	12	15	65%	REMAIN		LEANING
16	SABAL PALM	"Sabal palmetto"	1	22 CT	12	65%	REMAIN		CONSTRICTION, LEANING
17	SABAL PALM	"Sabal palmetto"		28 CT		65%	REMAIN		CONSTRICTION
18	SABAL PALM	"Sabal palmetto"		20 CT		65%	REMAIN		CONSTRICTION, LEANING
19	PAUROTIS PALM	"Acoelomhaphe wrightii"		18 CT		60%	REMAIN		GOTTO THOTAL ESTATION
20	PAUROTIS PALM	"Acoelomhaphe wrightii"		19 CT		60%	REMAIN		
<u>20</u> 21	PAUROTIS PALM	"Acoelomhaphe wrightii"	1	20 CT	1	60%	REMAIN		
22	SABAL PALM	"Sabal palmetto"		22 CT		65%	REMAIN		
<u>22</u> 23	COCONUT PALM	"Cocos nucifera"		48 CT		65%	REMOVE		
<u>23 </u>	COCONUT PALM	"Cocos nucifera"		48 CT		65%	REMOVE		
24 25	SABAL PALM	"Sabal palmetto"		18 CT		70%	REMOVE		
		·							
26 27	SABAL PALM	"Sabal palmetto"		18 CT		70%	REMOVE		
27	SABAL PALM	"Sabal palmetto"		20 CT		65%	REMOVE		
28	SABAL PALM	"Sabal palmetto"		20 CT		70%	REMOVE		
29	SABAL PALM	"Sabal palmetto"	ļ	22 CT	+	65%	REMOVE		
30	BOTTLE PALM	"Hyophorbe lagenicaulis"		8 CT	10	55%	REMOVE		
31	COCONUT PALM	"Cocos nucifera"		35 CT		65%	REMOVE		
32	COCONUT PALM	"Cocos nucifera"		36 CT		65%	REMOVE		
33	SABAL PALM	"Sabal palmetto"		8 CT	12	70%	REMOVE		
34	SABAL PALM	"Sabal palmetto"		13 CT		65%	REMOVE		
35	SABAL PALM	"Sabal palmetto"		10 CT	12	70%	REMOVE		
36	SABAL PALM	"Sabal palmetto"		3 CT	12	65%	REMOVE		
37	LIVE OAK	"Quercus virginiana"	16	40	60	65%	REMOVE	16	POOR PRUNING
38	LIVE OAK	"Quercus virginiana"	16	30	45	70%	REMOVE	16	
39	LIVE OAK	"Quercus virginiana"	23	30	45	60%	REMOVE	23	VINES, BD, TD
40	MAHOGANY	"Swietenia mahagoni"	25	40	60	30%	REMOVE	25	MAJOR INCLUSION FAILURE, TD,
41	LIVE OAK	"Quercus virginiana"	13	20	30	65%	REMOVE	13	CO-D, EXPOSED WOOD
42	LIVE OAK	"Quercus virginiana"	12	20	30	65%	REMOVE	12	
43	LIVE OAK	"Quercus virginiana"	14	30	35	65%	REMOVE	14	<u> </u>
44	LIVE OAK	"Quercus virginiana"	26	40	55	65%	REMOVE	26	B DMG, EXPOSED WOOD, DEAD WOOD
 45	SEAGRAPE	"Coccoloba uvifera"	42	40	55	50%	REMOVE	42	MULTI-STEM, B. DMG, UTILITY PRUNED
45 46	SABAL PALM	"Sabal palmetto"	74	10 CT		70%	REMOVE	74	NOCTESTER, D. DRIG, OTILITY PRONED
		"Quercus virginiana"		10 01	14	1 0 70			Official trace increal to be obtained
47 40	LIVE OAK					,	REMOVE	0	Offsite trees - parcel to be obtained
48	LIVE OAK	"Quercus virginiana" "Quercus virginiana"					REMOVE REMOVE	0	Offsite trees - parcel to be obtained
49	LIVE OAK						N/()\/ -	0	Offsite trees - parcel to be obtained

301 East Atlantic Blvd. Pompano Beach, FL 33060 PH: (954) 788-3400

Florida Engineering Business License: CA7928 Florida Surveyor and Mapper Business License: LB6860 orida Landscape Architecture Business License: LC260004

RESPONSIBILITY FOR THE USE OF THESE PLANS PRIOR TO OBTAINING PERMITS FROM **ALL AGENCIES HAVING JURISDICTION OVER** THE PROJECT WILL FALL SOLELY UPON THE USER.

ISSUE DATE:	04/04/22
DESIGNED BY:	MH, LW, AS
DRAWN BY:	MH, AS
CHECKED BY:	KS, PW
BID-CONTRACT:	

PAUL H. WEINBERG, R.L.A. FLORIDA REG. NO. LÁ6666804 (FOR THE FIRM)

CLIENT

CITY OF FORT LAUDERDALE


PROJECT

NEW POLICE HEADQUARTERS 1300-1350 WEST **BROWARD BLVD**

SHEET TITLE

TREE DISPOSITION LIST

SHEET NUMBER LD-001 PROJECT 11112.00 **NUMBER**

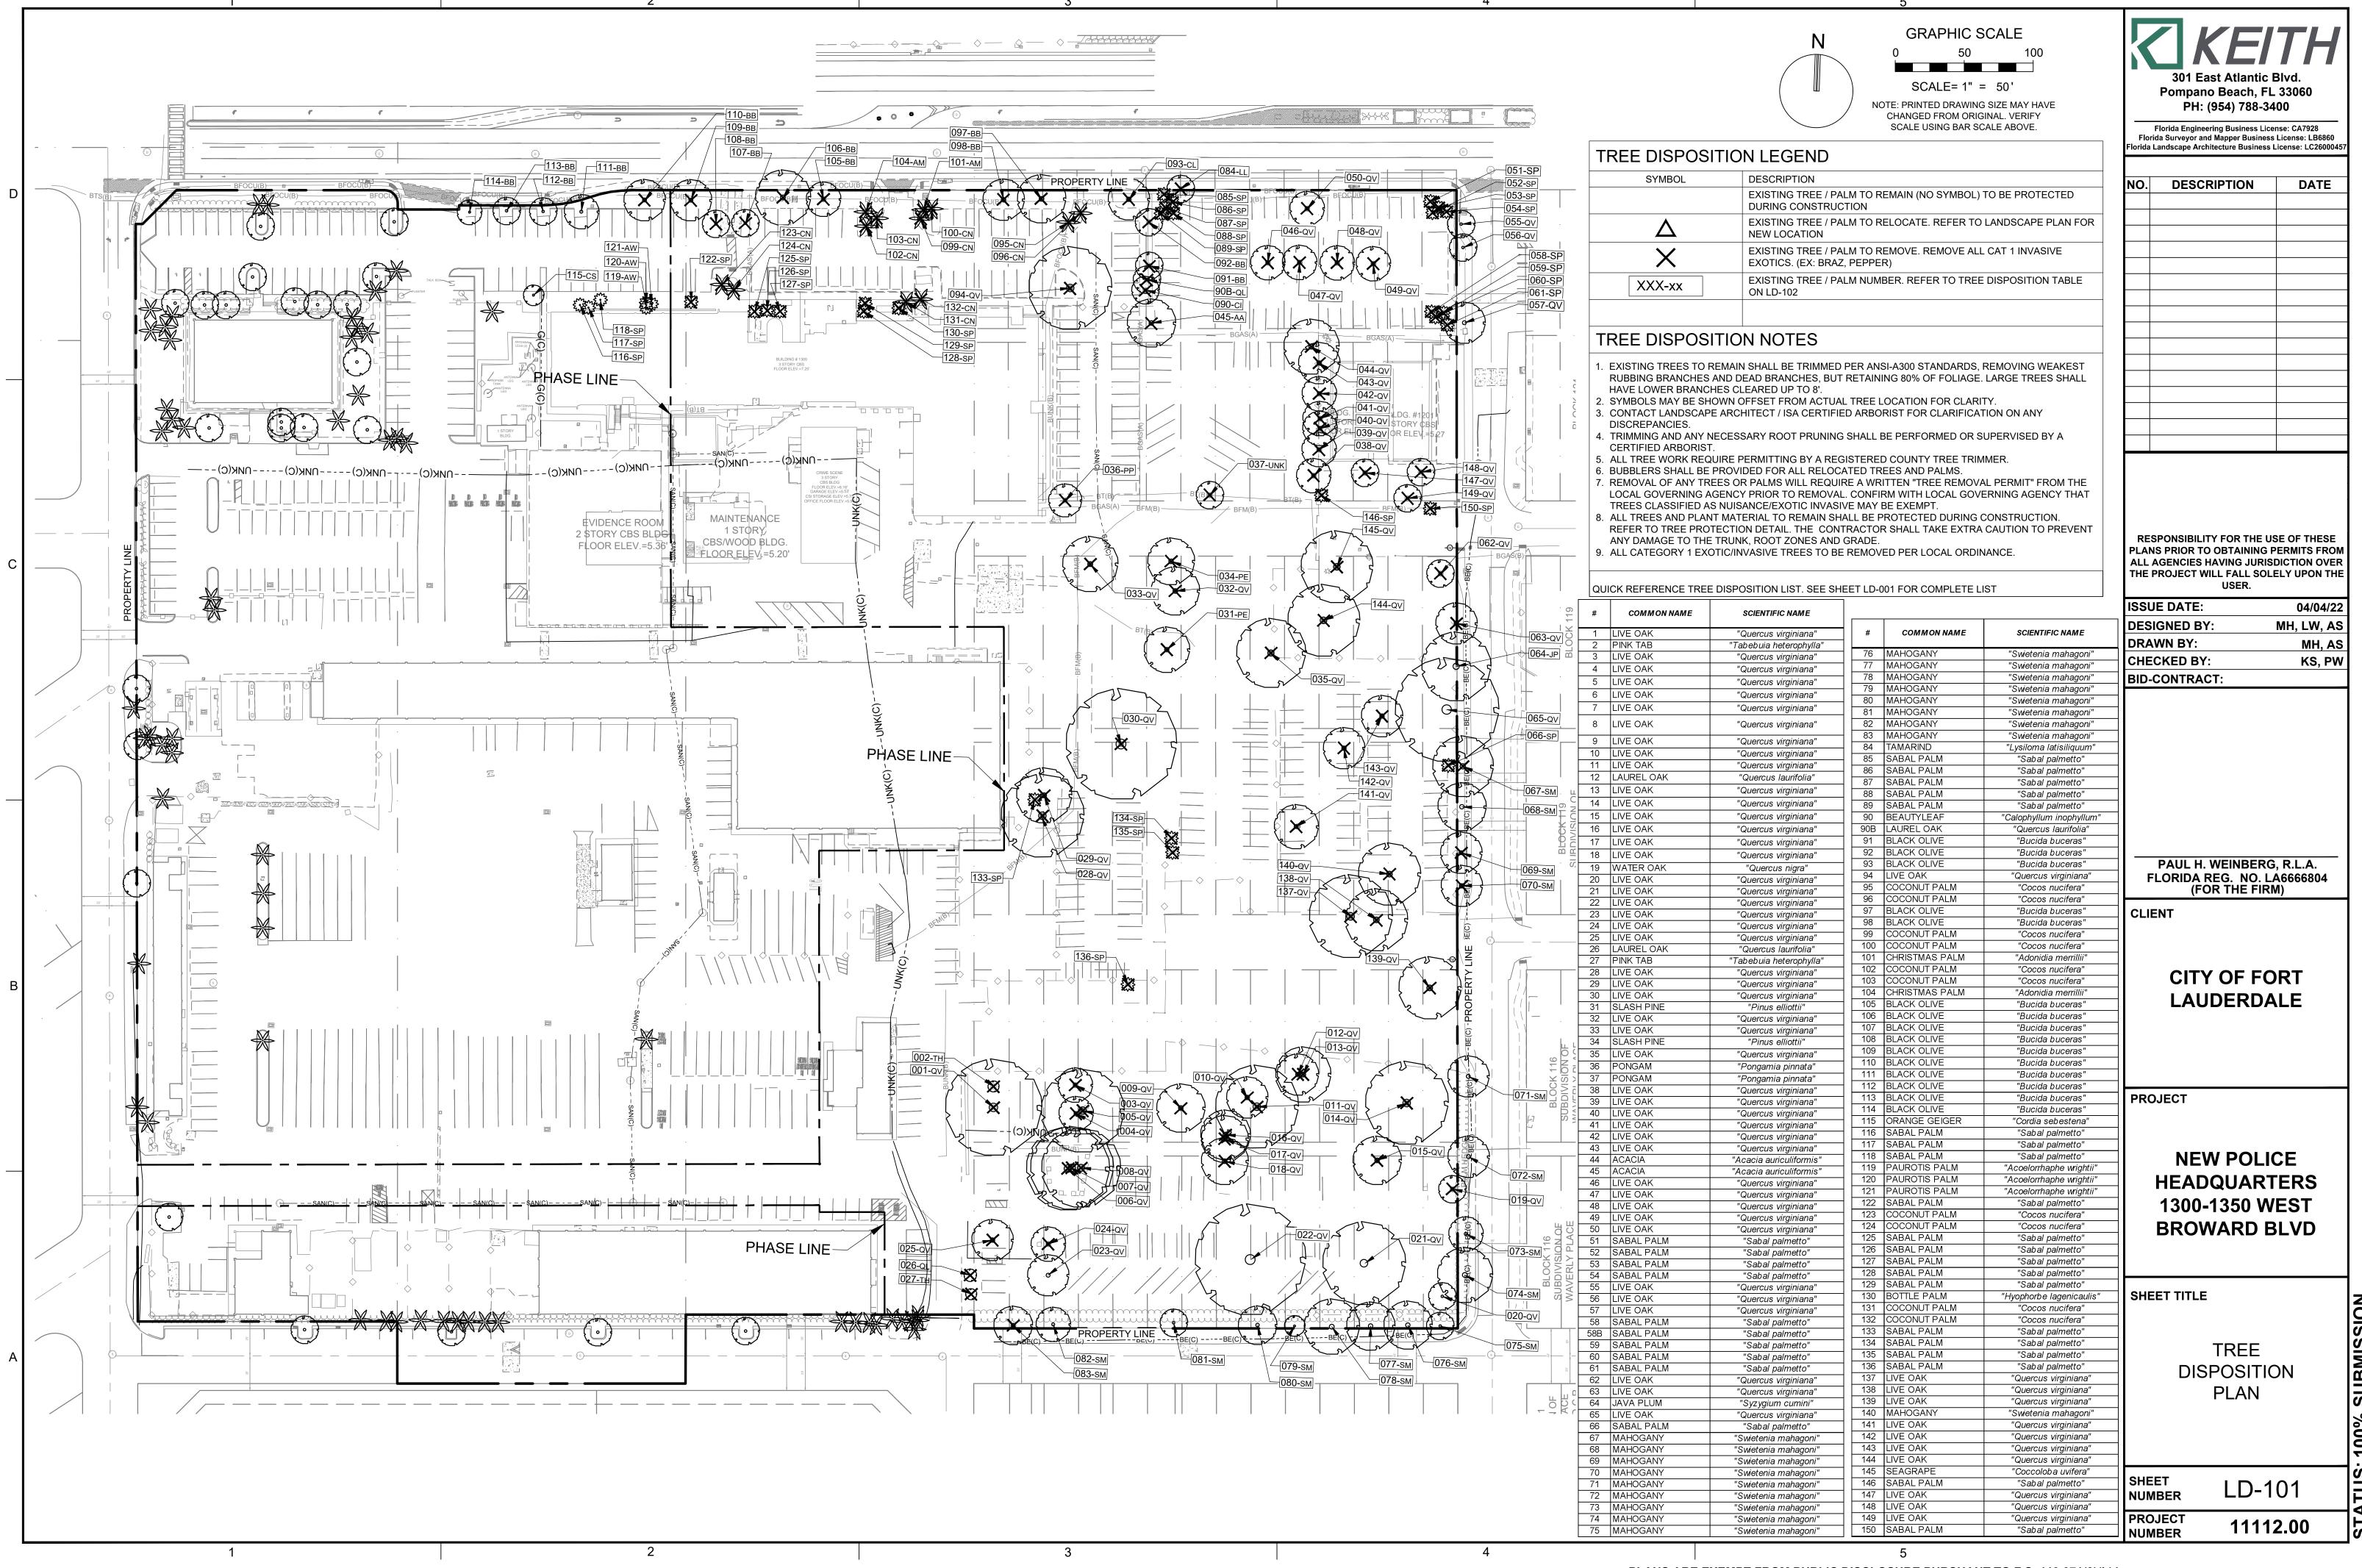

The location of plants, as shown on the plans, is approximate. The final locations may be adjusted slightly to accommodate unforeseen field conditions, to comply with safety setback criteria, to avoid creating unsafe sight conditions, or as otherwise directed or approved by the Landscape Architect / owner in writing. All other location adjustments to the layout are to be approved in advance in writing by the Landscape Architect and owner. Contractor understands that an important element of the design of this project is meeting landscape ordinances with a design flare that includes symmetry, alignment, focal points and / or smooth curvilinear forms where applied and contractor shall follow and instruct the working crews accordingly. In the event of any doubt as to how to execute the plans, Contractor shall immediately consult with Architect and/or Owner. Landscape Contractor shall fine grade, prepare site as outlined in the following notes and per plans; furnish and install all plants, shrubs, trees and / or palms meeting minimum requirements and brace them per details provided. Furnish and install soil, gravel, boulders, sod and mulch as specified in plans and notes below. Landscape contractor shall furnish and install all trees, palms, shrubs, groundcover, sod, planting soil, fertilizer, herbicide, pre-emergence herbicide, seed, and mulch. BIDDING Contractor to have liability insurance including Owner and Landscaper as insured's in excess of \$10,000 as well as Worker's Compensation 2. Contractors and Subs must ensure they are doing take offs from Bldg Dept.. Revised sets and / or Bid Set documents. Verify with this Office that you are bidding from latest available plans. Read ALL notes and typical planting details sheets prior to submitting RFIs and prior to bidding. When submitting an RFI reference sheet number, detail number and/or note category and number. 5. Landscape contractor shall verify all estimated quantities of material shown on the drawings prior to submitting their bid. Plant list pricing (if shown) is for permitting / mitigation comparison purposes only, any prices shown are to be disregarded by Landscape Contractor. 6. All Plant Material shall meet or exceed height and spread requirement. Heights are local code requirement and / or design intent related and always governs over container size. Container size given for reference only and must be sized-up to meet height requirements of plant list. Plant material available with excessive height beyond specifications must be consulted with Landscape Architect for design intent. All landscape material was confirmed to be available at time of design. Landscape contractor understands that some material may not be available locally, however is available in Tri-County Region. Plant material supply is the responsibility of the Landscape Contractor that is awarded the contract and he/she shall take steps to ensure Pre-inspections of site required prior to bidding.

availability at the time of installation. Bring to the attention of Landscape Architect if specific material is no longer available at the time of bidding and / or prior to actual construction. Substitutions must be approved prior to 9. The plant list is intended only as an aid to bidding. Any discrepancies found between the quantities on the plan and the quantities on the plant list shall be brought to the attention of the Landscape Architect for clarification. 10. All labor and material for soil amendments and fertilizer that is required to ensure the successful establishment

and survival of the proposed vegetation, as well as all the cost for the removal of unsuitable or excess backfill material from plant beds, in addition to fine grading and mulching all plant beds and individual trees shall be included in the contractor's bid to perform the work represented in this plan set. 11. Bid shall be itemized for possible value engineering. 12. Sod and Rocks (if specified) shall be estimated by scaling plans. Include price per square foot for sod. Rocks

(include price per ton). Small rocks and gravel beds shall have landscape fabric material and minimum 4" depth. Boulders to be bid by unit. 13. All S.F. if noted is approximate and shall not be considered all inclusive; it is the contractor's responsibility to do his or her take off, submit price per S.F. and in the end, sod all areas that are not covered either by plants, mulch and/or rocks. It shall be the responsibility of the contractor to include in the bid, the repair of any existing sod which may be damaged during construction.

14. Final payment to the Contractor shall be for actual plants installed on the project. 15. Contractor shall be responsible for obtaining and paying for costs of all permits described in bid whether permit costs are reimbursable by owner or included in bid. Research permit status and research all permits and additional documentation and certifications required such as separate tree removal permit for example, and consider prior to bidding. 16. General / Landscape Contractor shall leave a 5% unforeseen conditions allowance such as for additional root

barriers determined to be needed on site and as job progresses. 17. Refer to Section T, Watering, for supplemental watering requirement. 18. Landscape contractor is responsible for verifying all plant quantities prior to bidding and within 7 calendar days of receipt of these plans shall notify the landscape architect in writing of any and all discrepancies. In case of discrepancies, planting plans shall take precedence over plant list. No substitutions are to be made without prior

GENERAL LANDSCAPE NOTES

consent of the Landscape Architect.

Plants grown in containers prior to installation shall be removed from their containers before they are planted in the ground and have circling roots removed. All screening shrubs shall be planted for proper operation of equipment being screened and/or per the requirements of the utility as necessary. All hedge material required for screening purposes shall be planted with branches touching. Adjust spacing as necessary and/or provide additional plants to provide an adequate screen as required by code. Leave access to utility or clearance as required.

2. All landscaping shall be installed according to sound nursery practices. Contractor shall comply with federal, state and local laws and regulations pertaining to the inspection for plant disease and insect infestation. All ideas, designs and plans indicated or represented by this drawing are owned by and are the exclusive property of Keith and Associates and may not be duplicated without authorization or used for other projects than

The Landscape Contractor shall exercise caution to protect any existing sod, electrical and irrigation. Any damage to the sod, electrical or irrigation shall be replaced or repaired to the original state by the Landscape Contractor at no additional cost to the owner. 5. Tree, palm, accent shrubs and bed lines are to be located in the field and approved by the Landscape Architect /

owner prior to planting. Landscape Contractor acknowledges that material planted without approval of location may be subject to relocation by Landscape Architect to maintain design intent if not followed properly. 6. All trees must be pruned as per Landscape Architect's direction.

In areas where asphalt is removed in order to receive landscape material, the lime rock sub-base material must also be removed and replaced with approved planting soil mix. 8. Landscape contractor is responsible for sending photographs to the landscape architect to pre-approve all trees, palms, and shrubs prior to delivery to project site.

Landscape contractor shall coordinate his or her work with that of the irrigation, landscape lighting, and hardscape contractor if different. 10. The landscape contractor shall treat plant areas with pre-emergence herbicide after weeds and grass have been

removed. Landscape contractor shall wait 7 days after pre-emergence treatment prior to planting.

PERMITS & REGULATIONS

Contractor(s) must obtain separate landscape, irrigation and tree relocation/removal permits from the governing authority prior to the issuance of the first building permit for the project. 2. Landscape contractor to call the local Landscape Inspector to schedule a pre-construction meeting prior to installation if required.

3. All mandatory requirements by local Landscape Departments and their inspectors shall govern and landscape contractor commits by accepting contract to comply promptly for builder/owner to obtain C.O.

TREE REMOVAL

Removal of any trees or palms will require a written "tree removal permit" from the local governing agency prior to removal. Non-native trees classified as "prohibited" trees may be exempt from the permit if listed as Category 1 by Florida Exotic Pest Plant Council. Confirm with Local Municipality.

2. Landscape Contractor is responsible to remove ALL invasive nuisance trees such as Brazilian Pepper, Melaleuca, Australian Pine and all invasive trees as categorized by the governing agencies, whether listed on

The Landscape Contractor is responsible for coordinating tree and palm removals and transplants shown on the tree/palm Disposition Plan. The Landscape Contractor is to remove and discard from site existing unwanted trees, palms, shrubs, ground covers, sod and weeds within landscape areas.

EXISTING TREES

Existing trees designated to remain shall be protected during all construction phases. Any trees or shrubs designated to remain that are scarred or destroyed will be replaced at the contractor's expense, per the appraised value.

Existing plant material not shown on the plan and in conflict with new planting shall be evaluated at the time of new planting installation by the Landscape Architect. Trees and plant material indicated to be relocated with no new location provided in plans shall be moved to a location on site designated as a nursery holding area with the root ball protected from direct sunlight, maintained and irrigated until new location is determined. Prune trees to remove damaged branches and improve natural shape and thin out structure. Do not remove

more than 15% of branches. Do not prune back terminal leader. 4. Prune existing shrubs to remove damaged branches and improve natural shape.

5. Existing trees to remain shall be trimmed per Ansi-A300 standards. Supervision of the trimming shall be performed by an ISA Certified Arborist to ensure quality work.

6. All existing trees shall be "lifted and thinned" to provide an 8' minimum clearance for sidewalks and pedestrian

walkways and a 14' minimum clearance for roadways, driveways and all vehicular use areas. Selective canopy and root pruning of existing trees can be conducted (only as necessary and in no event more than 35%) to accommodate for new approved construction. Pruning shall be conducted / supervised by an ISA

8. If plans call for relocation of trees, palms or plants. High level of care should be exercised to assure that they are not damaged in the process and that they are promptly replanted upon being dug up.

9. All underground utilities and drain or irrigation lines shall be routed outside the tree protection zone. If lines must

traverse the protection area, they shall be tunneled or bored under the tree. 10. Erosion control devices such as silt fencing, debris basins, and water diversion structures shall be installed to

prevent siltation and/or erosion within the tree protection zone. 11. Roots shall be cut manually by digging a trench and cutting exposed roots with a saw, vibrating knife, rock saw, narrow trencher with sharp blades, or other approved root pruning equipment.

G. TREE RELOCATION (These notes for relocation trees only and if applicable) Flag all trees and palms to be transplanted with differentiating color than those to be saved or removed.

Tree Relocation process must be performed or supervised by ISA Certified Arborist. Water the root zones to field capacity for 5 continuous days before root pruning. At a minimum soak the soil to a 4'-0" depth within a 6' radius. Root prune a minimum of six weeks before relocation. Prune away all dead or damaged limbs or fronds. For trees, prune out 1/3 of the existing canopy by selectively trimming small internal branches. For palms, gather

fronds above the bud and tie them loosely with jute twine to avoid damage. 4. Brace root pruned trees awaiting relocation.

5. Root prune $\frac{1}{3}$ rd of the root system, irrigate daily for 2 weeks then root prune another $\frac{1}{3}$ rd, irrigate daily and prune last $\frac{1}{3}$ rd on actual relocation date, no less than two weeks (six weeks total minimum root pruning by stages). ISA Arborist on staff shall observe for intense shock. Canopy pruning may be deemed necessary by Arborist on staff to balance for intense root ball loss, canopy shall be trimmed only as necessary to increase survival.

Root prune with proper clean equipment to sever roots. Ensure roots are not torn or pulled apart. With hand tools, dig a 2'-0" wide by 3'-0" deep trench at a minimum distance as determined by the consulting arborist to expose roots. Cut all roots 1.5" and larger in diameter with a clean, sharp pruning saw. Treat all cuts with a fungicidal barrier. Backfill the trench, within 4 hours of digging, with a 1:1 mixture of site soil and sawdust or other fine organic material. Do not compact.

Form a rootball size in compliance with Florida grades and Florida standards number 1 or better.

9. Maintain the soil moisture at field capacity throughout the six weeks. 10. Allow the plant to regenerate roots over a period of six weeks.

11. At the end of six weeks, prepare the planting pit at the new location. Overdig the hole diameter a minimum of 2' beyond the root ball, with the recipient hole to be at least 1/3 larger than the area that was trenched for transplanting.

12. With the consulting arborist present, undercut the entire root ball of the plants to be transplanted at a depth specified by the arborist. The undercutting method may be a choker cable drawn through the root ball with 13. At the direction of a professional rigger, assemble slings, padding, guiding ropes and cables for attachment to

the crane or backhoe. The professional rigger shall determine the size of machinery necessary to execute the lifting and moving operation 14. Install trees within 24 hours of removal from their original location to locations provided by Landscape Architect

or Developer with approval of municipal / Landscape Inspector. 15. Experienced Tree Spade operator shall move tree or experienced tree mover shall choose best means and methods to strap and rig tree for transporting safely without damage to new location.

16. Maintain trees in a healthy and vigorous condition during installation and throughout the plant establishment period. Replace trees that do not meet this requirement with the same species, size, and quality or per mitigation requirements specific to the governing authority with jurisdiction. 17. Fertilize the plant as directed by the consulting arborist.

18. When the plant is placed in the new location, backfill the planting pit with topsoil and water thoroughly to eliminate air pockets and compact the soil. Set the tree no deeper than its original condition.

19. Cover the root ball area with 3" depth of organic mulch.

20. Provide fungicide and fertility applications at the direction of the consulting arborist. 21. Post transplant watering to provide moisture and reduce any excessive stress due to root desiccation. Watering

to be adjusted according to conditions and at the supervision and direction of the ISA certified arborist. 22. The diameter of the root--pruning or transplanting circle shall be at a distance away from the trunk equal to 12 times each inch of trunk diameter at breast height.

23. For all palms except Sabal palmetto, the lower fronds shall be pruned leaving 9-11 fronds that can be tied without an extensive amount of weight that may damage the heart of the palm. The Sabal palmetto shall have all fronds cut without damaging the bud.

24. Transplanting must occur within 24 hours after being dug for relocation. Trees/palms should be kept in shade and the canopy kept moist. 25. Digging and preparation of the new hole for the transplant shall be done prior to removing the tree from the

existing location 26. The landscape Contractor is to verify that all new holes have appropriate percolation.

27. Padding the sling may be necessary so that the trunk or "boots" are not damaged. 28. A 6" saucer shall be created around the edge of the plant pit to help hold water, see planting detail for additional

29. Over the guarantee period the Landscape contractor shall be responsible for resetting any trees or palms that are not vertical when caused by winds less than 74 mph.

30. After transplanting trees and palms, the landscape contractor shall be responsible for obtaining water and watering to maintain soil moisture during the guarantee period at a minimum of: First month- daily, Second month - three times per week, Third and Fourth months - two times per week, Last eight months - one time per

31. For trees over 4" in caliper at the time of planting, the schedule should be: First six weeks, daily, one and a half months to six months - three times per week, last six months - one time per week.

H. SITE PREPARATION & GRADING

1. Landscape contractor shall loosen and till compacted soils that are overly compacted in all planting areas of the project to provide for proper soil aeration for plant establishment.

Planted areas shall be cleared of underground rocks, construction debris and other materials detrimental to the health of the plants. Lime rock base material shall be removed within planting pits and adjacent to pavement. The planting areas should be clean to a depth equal to the root ball of the trees/palms proposed for the area. Planting area soils shall be tested for ph before planting. Soils showing high (alkaline) ph (over 7.5) shall be amended or replaced with native soil having a ph range of 6.5 - 7.5, as approved by Landscape Architect.

3. All planting areas and planting pits shall be tested for sufficient percolation prior to final planting and irrigation installation to ensure proper drainage. Plant beds in parking lots and in areas compacted by heavy equipment shall be de-compacted so that drainage is not impeded.

4. Landscape Contractor shall treat plant areas with pre-emergence herbicide after weeds and grass have been removed. Landscape Contractor shall wait (7) seven days after pre-emergence treatment prior to planting. 5. Site preparation shall include the eradication and removal of any weeds, clean-up of any dead material, debris,

6. General site and berm grading to +/- 1 inch (1") shall be provided by the general contractor. All finished site grading shall be provided by the Landscape Contractor. All planting beds shall be free of all rocks 1/2" or larger, sticks, and objectionable material including weeds and weed seeds. All lime rock shall be removed/cleaned down

The Landscape contractor shall ensure the planting areas are at finish grade prior to installing plant materials. 8. All trees and plant material to remain shall be protected during construction. Contractor shall install protective barriers such as "Tenax" orange safety fencing or similar, to be installed before the beginning of the project. Barriers shall be located to include the drip line of the trees, palms and plant material. The contractor shall take extra caution to prevent any damage to the trunk, root zones and grade.

9. Final grade within planting areas to be 4" below adjacent paved areas or top of curb. Sod areas to be 2" below. 10. All planting beds shall be shaped and sloped to provide proper drainage away from building and structures and to swales, if applicable.

Any Irrigation Notes and specifications included in Irrigation Sheets govern over the following Irrigation Notes. 2. The Landscape Contractor shall coordinate with the irrigation contractor if not the same and leave provisions for

all individual trees in turf areas and all planting beds. 3. Irrigation / Landscape contractor to guarantee 100% coverage and 50% overlap (head to head coverage) to all landscaped areas and furnish and install a rain sensor.

4. Irrigation Contractor to adapt design to onsite conditions adjusting heads and changing nozzles as required to avoid overspray onto buildings or paved areas.

The contractor shall ensure that the irrigation system is operational and free of leaks prior to any planting being finalized. Plant material that is installed prior to the irrigation system being operational shall be watered by the contractor at his or her expense. Water for plant establishment should be included in the cost of the plant.

6. All guidelines as outlined by the South Florida Water Management District (SFWMD) or water management district with jurisdiction shall be strictly adhered to. 7. Irrigation water whether pumped from a lake or a well shall be treated for algae, rust, etc. to provide clean treated

irrigation water that will not clog or stain property or components. 8. Any existing irrigation system shall be retrofitted to comply with the specifications as outlined above.

J. HARDSCAPE & OTHER MATERIALS

surfaces, unless otherwise indicated on the plans. Refer to details.

1. Face of trees and palms to be located a minimum of 2' setback from all fences, walkways, walls, and paved

1. The contractor shall be responsible for determining the location of and avoid and protect utility lines, buried cables, and other utilities. The owner or Landscape Architect shall not be responsible for damage to utility or

2. Trees shall be placed a minimum of 5 ft. from underground utilities, unless otherwise approved in writing by Landscape Architect and Owner. 3. All canopy trees to be planted min. of 15' from light source/poles. Unless otherwise approved by the governing

authority / Landscape Architect and Owner. 4. Landscape contractor shall contact the county, governing authority and/or utility companies to locate all underground utilities or structures prior to digging. Landscape contractor shall repair all damage to underground utilities, and/or construction caused by utility damage, at no cost to the owner

5. All plant material symbols shown on landscape plan shall be considered diagrammatic and should be adjusted in

the field by contractor to avoid all utilities, and all other obstructions. 6. If/ When digging in right of way needed: Two (2) full business days before digging, call toll free 1-800-432-4770, or 811, Sunshine State One Call of Florida, inc. Notification Center. In addition, call the Governing Agency's Utilities/Public Works Department. Contractors are responsible for coordinating with the owners and appropriate public agencies to assist in locating and verifying all underground utilities prior to excavation. All existing utilities shown on the plans are to be considered approximate and should be verified by the contractor prior to the start

7. Above and below ground utilities shall be verified and located in the field by the contractor prior to commencing work in the project area. The contractor shall examine available utility plans and confirm conflicts between indicated or located utilities and landscape work. The contractor shall then notify the Project Engineer of said conflicts and the Engineer will coordinate any necessary adjustments with the utility provider. Tree locations will be adjusted as necessary when in conflict with existing utilities.

8. The final plant locations may be adjusted, as approved / directed by the Landscape Architect in writing, to accommodate utilities compliance. Excavations within 5' of known utilities should be done by hand. 9. Contractor shall familiarize himself with the location of and avoid and protect utility lines, buried cables, and all

other utilities, noted or not, on plans. 10. Leave clearance and access to all above ground or at grade meters and equipment. 11. Landscape planting shall be in conformance with FPL guidelines for setbacks from overhead utility lines. 12. Landscaping shall not interfere with light poles, fire hydrants, electrical/mechanical equipment access, signs,

drainage structures, etc. Bring to the attention of Landscape Architect any conflicts.

approved construction or as may be deemed necessary as job progresses.

1. Root barriers will be installed to protect building foundations, curbing, walkways, paved areas, roadway base material and utilities from existing large trees or proposed new trees that are within 5' of existing or new

2. Mechanical Root barriers will be used for large existing Canopy Trees and chemical type barriers will be used for 3. Mechanical Root barriers will be "DeepRoot" and Chemical Root barriers will be "Biobarrier". Substitutions must be of approved equal or better quality.

4. Root barriers will be installed per manufacturer specifications. 5. Root barrier depths will be determined by the manufacturer recommended depth chart and as required by on-site conditions in a case by case basis as deemed necessary by Landscape Architect Architect / ISA Arborist and Landscape Inspector.

LANDSCAPE BACKFILL & SOIL AMENDMENT

All building construction material and foreign material shall be removed from the planting areas and replaced with 70/30 mix (70% sand / 30% organic compost) or amend existing soils per section H.2. 2. Planting soil mix shall be delivered to the site in a clean loose and friable condition and is required around the root ball of all trees and shrubs, the top 6" of all shrubs and ground cover beds and top 2" of all grassed areas. This soil shall be tilled into the existing soil after the existing soil has been cleaned of all undesirable foreign materials. Recycled compost is encouraged as a soil amendment alternative. Planting soil to be weed free.

Planting backfill for palms shall be clean coarse native sand unless specified elsewhere. 4. Do not allow air pockets to form when backfilling. All trees shall be watered-in utilizing water probe or a tree bar.

N. PLANT SIZE & QUALITY 1. All plant material must meet or exceed the minimum size requirements as specified on the plant list. Height

specification governs over container size if both specifications given cannot be met. Any other requirements for specific shape or effect as noted on the plan shall also be required for acceptance 2. Material specified as Balled and Burlapped (B&B) can be accepted in container if not available as B&B at the discretion of Landscape Architect; if so, root bound and/or circling roots shall be removed and root ball must be

proportionate to Tree / Palm. 3. U.O.N, All trees designated as single trunk shall have a single, relatively straight, dominant leader, proper structural branching and even branch distribution. Trunks on palms shall be uniform in thickness for the entire length of the palm and shall not taper off to disproportionate thinness towards the crown. Trees with bark

plunging roots will be rejected. 4. Use nursery grown plant materials that complies with all required inspection, grading standards, and plant regulations in accordance with the latest edition of Florida Department of Agriculture, "Grade & Standards for

inclusion, tipped branches, and co-dominant trunks will not be accepted. Trees with girdling, circling and/or

5. All trees and palms shall be free of open wounds and unsightly visible scars. 6. All substitutions must be approved by the governing authority if it is required Canopy and by Landscape Architect / Owner if supplementary accent material.

7. Contractor shall comply with Federal, State, and Local laws and regulations pertaining to the inspection for plant disease and insect infestation.

8. Trees, palms, shrubs, ground covers: Plant species and sizes shall conform to those indicated on the drawings. All nursery stock shall be in accordance with grades and standards for nursery plants parts 1 and 2, latest edition published by the Florida Department of Agriculture and Consumer Services, unless specified otherwise. All plants shall be Florida grade number 1 or better as determined by the Florida Division of Plant Industry and tightly knit plant, so trained or favored in its development that first appearance is unquestionable and it is outstandingly superior in form, number of branches, compactness and symmetry. All plants shall be freshly dug, sound, healthy, vigorous, well branched and free of disease and insect eggs and larvae and shall have adequate root systems. Trees and palms shall be uniform in size and shape. All materials shall be subject to approval by the Landscape architect.

Plants shall be pruned prior to delivery only upon the approval of the Landscape Architect. 9. All container grown material shall be healthy, vigorous, well-rooted plants and established in the container in which they are sold. The plants shall have tops of good quality and be in a healthy growing condition. An established container grown plant shall be transplanted into a container and grown in that container sufficiently long enough for the new fibrous roots to have developed so that the root mass will retain its shape and hold together when removed from the container.

10. Field grown trees and palms previously root pruned shall obtain a root ball with sufficient roots for continued growth without resulting shock.

11. Root suckers on any tree are not acceptable and must be properly pruned. 12. Contractor shall coordinate with Landscape Architect and Owner to obtain prior approval for the selection of the specific specimens of all palms and any trees of more than six feet in height. Contractor to supply photograph of trees prior to purchase and installation.

O. PLANTING NOTES 1. At the discretion of the Landscape Architect, plants are subject to review for approval for size, variety, condition

and appropriateness to the design intent. 2. All synthetic burlap, synthetic string or cords, or wire baskets shall be removed before any trees are planted. All synthetic tape (i.e. tagging tape, nursery tape) shall be removed from trunks, branches, etc. before inspection. The top 1/3 of any natural burlap shall be removed or tucked into the planting hole before the trees are back

3. All "groundcover" requires 75% coverage and 100% within 3 months of installation. Bring to the attention of Landscape Architect in writing before commencing if this is not achievable with the design. 4. Set tree no deeper than it was in its original growing condition with the top of the root ball even with, or slightly

higher (+/- 1") than the finished grade. 5. All trees/palms shall be planted so the top of the root ball, root flair are slightly above final grade. Shrub material

shall be planted such that the top of the plant ball is flush with the surrounding grade. 6. All trees and palms shall be braced / staked per accepted standards by the Florida Nursery, Growers & Landscape Association (FNGLA). Nailing into trees and palms for any reason is prohibited and the material will

be rejected. Please refer to the planting details. 7. All trees, new or relocated, to be staked and guyed as detailed. 8. Layout shrubs to create a continuous smooth front line and fill in behind with triangular spacing.

9. Excavate pit or trench to 1-1/2 times the diameter of the balls or containers or 1' wider than the spread of roots and 3" deeper than required for positioning at proper height . Compact a layer of topsoil in bottom before placing plants. Backfill around plants with planting mixture, compacted to eliminate voids and air pockets. Form grade

slightly dished and bermed at edges of excavation. Apply 3" of mulch. 10. Groundcover and shrubs to be spaced in a uniform and consistent pattern per planting details.

11. All mechanical equipment, irrigation pumps, FPL transformers, pool pumps, etc. shall be screened on a minimum of three sides by landscape shrubs. 12. Contractor shall not mark or scar trunks in any fashion.

13. When requested by Landscape Architect, demonstration of healthy root system if not previously approved, can include tree removal and re-installation for inspection at no additional cost to the owner. 14. Remove rejected Plant material from the Site immediately and replace with acceptable plants.

1. All Fertilization shall comply with state fertilization laws. Fertilization shall be Agriform "20-10-5 Plus minors" or similar approved slow-release tablets applied per manufacturer suggested application rate chart:

Agriform® 21-gm Tablets (SKU# 90026*; 500 tablets/case) NEW Tree / Shrub Container Size 1 Gal 2 Gal 3 Gal 5 Gal 7 Gal 15 Gal 24" Box Installation: 1 1 to 2 2 to 3 2 to 3 3 to 5 7 to 10 15 to 24

 Place plant in the hole and backfill to halfway point. • Do not place tablets in the bottom of the planting hole. • Place Agriform Tablets in the hole about 1to 2 inches away from root tips. Finish filling the hole around the plant to grade level.

SCOTTS: 1-800-492-8255 or visit www.scottspro.com

1. All areas disturbed during construction shall be sodded with St. Augustine 'Seville' unless otherwise noted.

These disturbed areas shall have proper irrigation established or re-established if they were disrupted or

Landscape Contractor to supply and install 2" soil layer 50/50 mix blanket for all new sod areas. 2. All open areas not covered by trees, palms, shrubs, vines, ground covers or existing sod in good condition to remain, shall receive Stenotaphrum Secundatum, St. Augustine 'Seville' sod, whether labeled on the plans or not, unless a different species is indicated on the planting plan. Sod shall be strongly rooted, free from weed, fungus, insects and disease. Contractor shall be paid by the total sodded area x the unit price submitted (field verified).

3. Sod shall be machine stripped no more than 24 hours prior to laying. 4. Lay sod strips with tight joints, do not overlap, stagger strips to offset joints in adjacent courses. Work sifted soil mix into minor cracks between pieces of sod and remove excess soil deposits from sodded areas. Sod on slopes greater than 3:1 shall be immediately staked after planting.

R. SUBMITTALS 1. Submit 1 gallon container of all planting media for landscape architect review. Samples to include specified

planting mix, topsoil, container planting mix (if applicable) and mulch. 2. Submit representative nursery photos of all Trees and Palms for review prior to delivery to the site. Include scale

S. INSPECTION & ACCEPTANCE

Notify the governing Agency if required and Landscape Architect of commencement. 2. Onsite plant deliveries shall occur on Monday through Friday only unless otherwise directed by the Landscape Architect / Owner. The contractor shall ensure that plant material is delivered undamaged from transportation or digging operations. The Landscape Architect may reject material that has been damaged or rendered unacceptable due to relocation or transportation from the point of origin. All plant material shall be available for inspection and approval by the Landscape Architect prior to final installation.

3. There shall be one final inspection for approval by each of the presiding governing agency, Landscape Architect and owner. Contractor shall ensure that the plans, details, specifications and notes have been adhered to and that the landscape and irrigation installation is compliant to all items as directed on the plans prior to scheduling of the final inspection

4. Upon completion of the work, the Landscape Contractor shall notify the Landscape Architect and request a final inspection. Any items that are judged incomplete or unacceptable by the Landscape Architect or owner shall be promptly corrected by the Landscape Contractor.

5. No substitution of plant material, type or sizes will be permitted without prior written authorization from the Landscape Architect and owner. 6. To obtain final payment, Contractor must provide release of all mechanic's liens and material liens.

1. All planting beds shall be mulched to a depth of 3" with an organic mulch approved by Landscape Architect. No heavy metals, such as arsenic, etc. are to be contained in the mulch. The contractor shall provide certification if requested or proof that all mulch is free of heavy metals or similar environmental contaminants. 2. Shredded approved organic mulch to be used beyond trunk in all directions and throughout all hedges and plant

3. All trees in sodded areas shall have a clean cut 4' diameter mulch ring.

4. Preferred mulch is shredded melaleuca. Cypress, red, gold and green mulch is prohibited. 5. All mulch shall have a minimum 3" separation from the trunk of the tree/palm trunk to avoid rotting.

U. WATERING

1. All plant material shall be watered in thoroughly at the time of planting. 2. It is the sole responsibility of the Landscape Contractor to ensure that all new plantings receive adequate water during the installation and until completion of contract. Deep watering of all new trees and palms and any supplemental watering that may be required to augment natural rainfall and site irrigation is mandatory to ensure

V. CLEAN UP 1. The Landscape Contractor is responsible for maintaining all landscape planting areas until final acceptance of

proper plant establishment and development and shall be provided by Contractor as a part of this contract.

2. The contractor is responsible for mowing the entire project during planting and establishment periods, based on mowing project once a month from October to April, and twice a month from April to October (During installation

and plant establishment only and until final inspection and owner accepts and takes ownership). 3. Any excess soil, undesired stones or debris resulting from landscape operations shall be removed promptly, keeping the site clean as work progresses 4. The Landscape Contractor shall at all times keep the premises free from accumulation of waste material or

debris caused by their crews during the performance of the work. Upon completion of the work, the contractor

shall promptly remove all waste materials, debris, unused plant material, empty plant containers, and all

equipment from the project site.

W. MAINTENANCE 1. Landscape Contractor to return to job site 12 months after tree bracing and remove all tree braces. Owner may choose to retain 5% of payment to ensure compliance. 2. The Landscape Contractor shall water, mulch, weed, prune, and otherwise maintain all plants, including sod, until completion of contract or acceptance by landscape architect. Settled plants shall be reset to proper grade,

planting saucers restored, and defective work corrected. 3. Trees and shrubs shall be maintained to keep clearance of stop signs and safety clearance for visibility at traffic intersection

X. GUARANTEE & REPLACEMENT

1. By accepting the contract, the Contractor is thereby guaranteeing all plant materials and design for a period of not less than one (1) year from the time of final acceptance by the owner. Contractor shall replace any plants which die or wither within such period with healthy plants that meet specifications of the same species and size without additional cost to the owner unless such death or withering is due to Owner's failure to do ordinary maintenance on such plants after final acceptance in accordance with any maintenance instructions given by Landscape Architect for such plants. Such replacement shall include all plants and labor to plant the replacement plants. Any plant materials damaged by lightning, storms, freeze damage or other "acts of God" as well plants damaged by vehicles, vandalism or neglect are not included in this replacement agreement. If requested, the Landscape Architect may act as a mediator between owner and Landscape Contractor on a time material basis. "Plants" includes all trees, palms, shrubs, grass and other plants provided or planted by Contractor.

Y. MISCELLANEOUS.

1. All work to be done in a professional manner. 2. No change order shall be valid, due or paid unless it is approved by Owner in writing in advance. 3. These notes shall be an integral part of the contract of Contractor and shall be deemed incorporated therein by reference. In the event of a conflict among the terms among the plans and these notes, the terms of this document shall control.

ABBREVIATIONS IN NOTES AND PLANS

UNO = Unless Otherwise Noted L.A = Landscape Architect S.F. = Square Feet STD = Standard (single trunk) B&B = Balled and Burlapped BLDG DEP = Building Department RFI = Request for Information FPL= Florida Power & Light

C.O. = Certificate of Occupancy ISA CA or ISA Arborist = International Society of Arboriculture Certified Arborist

Florida Engineering Business License: CA7928 Florida Surveyor and Mapper Business License: LB6860 orida Landscape Architecture Business License: LC260004 **REVISIONS** DESCRIPTION DATE 3. Submit representative nursery photos of all shrub and groundcover material for review prior to delivery to the site.

301 East Atlantic Blvd.

Pompano Beach, FL 33060

PH: (954) 788-3400

RESPONSIBILITY FOR THE USE OF THESE PLANS PRIOR TO OBTAINING PERMITS FROM **ALL AGENCIES HAVING JURISDICTION OVER** THE PROJECT WILL FALL SOLELY UPON THE

ISSUE DATE: 04/04/22 **DESIGNED BY:** MH, LW, AS **DRAWN BY:** MH, AS **CHECKED BY:** KS, PW **BID-CONTRACT:**

PAUL H. WEINBERG, R.L.A. FLORIDA REG. NO. LA6666804 (FOR THE FIRM)

CLIENT

CITY OF FORT **LAUDERDALE**

PROJECT

NEW POLICE HEADQUARTERS 1300-1350 WEST **BROWARD BLVD**

SHEET TITLE

NUMBER

PLANTING NOTES

SHEET LP-001 **NUMBER PROJECT** 11112.00

PLANS ARE EXEMPT FROM PUBLIC DISCLOSURE PURSUANT TO F.S. 119.071(3)(b)1

CAM #22-0702 Exhibit 2 Page 51 of 65

301 East Atlantic Blvd. Pompano Beach, FL 33060 PH: (954) 788-3400 Florida Engineering Business License: CA7928 Florida Surveyor and Mapper Business License: LB6860 lorida Landscape Architecture Business License: LC260004 REVISIONS PLANT SCHEDULE DESCRIPTION DATE NATIVE/ REMARKS TREES | QTY | BOTANICAL / COMMON NAME SIZE DROUGHT BURSERA SIMARUBA 14` HT. X 6` SPRD., 4" CAL GUMBO LIMBO BURSERA SIMARUBA 20` HT X 14` SPRD, 8" CAL SPECIMEN TREE CITY OF FORT LAUDERDALE - LANDSCAPE REQUIREMENTS SPECIMEN GUMBO LIMBO IUNIFIED LAND DEVELOPMENT REGULATIONS, CHAPTER 47, ARTICLE III, SECTION 47-21 LANDSCAPE AND TREE PRESERVATION REQUIREMENTS] CEIBA PENTANDRA PROPOSED VEHICULAR USE AREAS [SEC. 47-21.9 LANDSCAPING REQUIREMENTS FOR VEHICULAR USE AREAS] 25` HT. X 20` SPRD., 10" CAL COLLECTED SPECIMEN KAPOK TREE <u>REQUIRED</u> <u>PROVIDED</u> CEIBA SPECIOSA TOTAL SITE AREA: **404,295** S.F. = **9.28** ACRES 20` HT X 15` SPRD., 8" CAL | COLLECTED SPECIMEN **104,731** S.F. = FLOSS SILK TREE NET LOT AREA: **2.40** ACRES VUA AREA: **78,817** S.F. = 1.81 ACRES CONOCARPUS ERECTUS `SERICEUS` 14` HT. X 6` SPRD, 3" DBH, FULL [AS DEFINED BY SEC. 47-58.2] MULTI-TRUNK CES SILVER BUTTONWOOD CANOPY VUA LANDSCAPE REQUIRED (20% OF VUA) **15,763** S.F **23,774** S.F. PERIMETER LANDSCAPE AREA LAGERSTROEMIA INDICA 10` HT X 5` SPRD, 1.5" DBH, FULL MULTI-TRUNK **18,682** S.F ABUTTING A STREET CRAPE MYRTLE CANOPY **3,170** S.F **3,500** S.F. NOT ABUTTING A STREET >**5,000** S.F MYRCIANTHES FRAGRANS **1,890** S.F INTERIOR LANDSCAPE AREA (30 S.F./PKNG SPACE) 63 SPACES 10` HT. X 5` SPRD., 2" CAL. MULTI-TRUNK SIMPSON`S STOPPER REQUIRED LANDSCAPE: QUERCUS VIRGINIANA 1 TREE REQUIRED PER 1,000 S.F. VUA AREA **79** TREES QV 15` HT X 6` SPRD, 4" CAL, MIN. SOUTHERN LIVE OAK 3" CALIPER SHADE TREES (25%) QUERCUS VIRGINIANA TREES 21 TREES 2"- <3" CALIPER SHADE TREES (25%) QV-1 25` HT X 15` SPR, 8" CAL SPECIMEN TREE FLOWERING TREE SPECIES (20%) SPECIMEN SOUTHERN LIVE OAK 16 TREES 16 TREES TREES 16 TREES PALM TREES (20%) SWIETENIA MAHAGONI 15 TREES 12` HT X 6` SPRD., 2" CAL. OTHER TREES (FPL SMALL TREES) (10%) 8 TREES MAHOGANY **= 473** SHRUBS >1000 SHRUBS 6 SHRUBS PER 1,000 S.F. VUA AREA TABEBU**I**A CARAIBA 12` HT. X 6` SPRD., 2" CAL RESPONSIBILITY FOR THE USE OF THESE YELLOW TABEBUIA PLANS PRIOR TO OBTAINING PERMITS FROM SITE LANDSCAPE REQUIREMENTS [SEC. 47-21.10 LANDSCAPE REQUIREMENTS FOR ALL ZONED DISTRICTS] ALL AGENCIES HAVING JURISDICTION OVER TABEBUIA IMPETIGINOSA 12` HT X 6` SPRD, 2" DBH, FULL PROVIDED THE PROJECT WILL FALL SOLELY UPON THE PURPLE TRUMPET TREE CANOPY LOT ZONING DESIGNATION TAXODIUM DISTICHUM 16` HT X 8` SPRD, 4" DBH, FULL **ISSUE DATE:** NET LOT AREA **104,731** S.F. BALD CYPRESS CANOPY 04/04/22 REQUIRED LANDSCAPE: **DESIGNED BY:** MH, LW, AS
 105
 TREES
 226
 TREES

 21
 SHADE TREES
 38
 SHADE TREES
 1 TREE/1000 S.F. OF NET LOT AREA (IN ADDITION TO VUA LANDSCAPE) DRAWN BY: NATIVE/ MH, AS SHADE SPECIES (20% MIN.) PALMS QTY BOTANICAL / COMMON NAME SIZE REMARKS DROUGHT CHECKED BY: KS, PW EXISTING SHADE TREES TREES PROVIDED BREAKDOWN: PHOENIX RECLINATA EXISTING PALM TREES TREES BID-CONTRACT: 12`-16` CT, 20` OA MIN 5-7 STEMS PROPOSED SHADE TREES 30 TREES SENEGAL DATE PALM 182 PROPOSED PALM TREES TREES PHOENIX SYLVESTRIS 14` CT., 22` OA., 12" CAL MIN. HEAVY, MATCHED 12 SHRUBS/1000 S.F. OF NET LOT AREA (IN ADDITION TO VUA LANDSCAPE) 1257 SHRUBS 2348 SHRUBS WILD DATE PALM ROYSTONEA ELATA STREET TREES: 20° CT, 30° OA FLORIDA ROYAL PALM 1 TREE/30 LF OF STREET FRONTAGE 14`, 18`, 22` CT, CURVED TRUNKS, | N** SABAL PALMETTO EXISTING TREES 21 TREES BOOTED PROPOSED SHADE TREES STAGGERED PER PLAN TREES CABBAGE PALMETTO 25 SHADE SPECIES (50% MIN.) 22 SHADE TREES 46 SHADE TREES SABAL PALMETTO 14`, 20`, 26` CT CURVED, SLICK **CABBAGE PALMETTO** <u>PROVIDED</u> <u>ALLOWED</u> TURF GRASS: THRINAX RADIATA 4-6` CT, 10-12` OA. LESS THAN 50% LANDSCAPE TO BE SOD 50% <50% | HEAVY FLORIDA THATCH PALM VEITCHIA MONTGOMERYANA PAUL H. WEINBERG, R.L.A. HEAVY, TRIPLE 14` CT., 22` OA. MONTGOMERY PALM FLORIDA REG. NO. LA6666804 (FOR THE FIRM) CLIENT SHRUBS QTY BOTANICAL / COMMON NAME SIZE REMARKS **PLANTING** DROUGHT ACCENT SHRUBS **ABBREVIATIONS** 3 GAL. CONT BROMELIADS, ALOCASIAS BALLED AND BURLAPPED **CITY OF FORT** CONOCARPUS ERECTUS 2` OC CON 24" HT. X 24" SPRD. GREEN BUTTONWOOD HEDGE LAUDERDALE CAL. CALIPER NATIVE/ CLEAR TRUNK QTY BOTANICAL / COMMON NAME SIZE REMARKS DROUGHT CRITCAL ROOT ZONE PASSIFLORA INCARNATA FULL VINE ON TRELLIS, 6-8` HT PASSION FLOWER VINE ATTACH TO WIRE FIELD GROWN TRACHELOSPERMUM JASMINOIDES 'CONFEDERATE' | FULL VINE ON TRELLIS, PROJECT GAL. GALLON CONFEDERATE JASMINE ATTACH TO WIRE GW GREY WOOD NATIVE/ SIZE QTY BOTANICAL / COMMON NAME SPACING HEIGHT **AREAS** DROUGHT **NEW POLICE** ARACHIS GLABRATA MIN. MINIMUM ARG 4" HT. X 12" SPRD. 12" OC **HEADQUARTERS** PERENNIAL PEANUT MULTI MULTI-TRUNK CHRYSOBALANUS ICACO `HORIZONTALIS` 1300-1350 WEST 18" HT. X 24" SPRD. 24" OC HORIZONTAL COCOPLUM OA OVERALL **BROWARD BLVD** CHRYSOBALANUS ICACO `RED TIP` CHR 24" HT. X 24" SPRD. 24" OC O.C. RED TIP COCOPLUM ON CENTER CRINUM JAGUS CRJ 24" HT X 24" SPRD 36" OC QUANTITY ST. CHRISTOPHER LILY SPRD. SPREAD MUHLENBERGIA CAPILLARIS SHEET TITLE MUH 24" HT. X 24" SPRD. 30" OC PINK MUHLY GRASS TYPICAL TYP. NEPHROLEPIS BISERRATA `MACHO FERN` NEB 24" HT. X 24" SPRD. 36" OC MACHO FERN U.N.O. UNLESS NOTED NEPHROLEPIS EXALTATA 12" HT X 14" SPRD., CERTIFIED OTHERWISE PLANTING NOTES & NEP 24" OC BOSTON FERN NATIVE ONLY SCHEDULE NERIUM OLEANDER 'PETITE PINK' 18" HT. X 18" SPRD. 24" OC OLEANDER PENNISETUM SETACEUM 24" HT. X 24" SPRD. 24" OC WHITE FOUNTAIN GRASS

24" OC

24" OC

36" OC

12" HT., 4" POT

12" HT., 4" POT

24" HT. X 24" SPRD.

PONTEDERIA CORDATA

SAGITTARIA LATIFOLIA

FAKAHATCHEE GRASS

LANCE-LEAFED ARROWHEAD
TRIPSACUM DACTYLOIDES

PICKEREL WEED

TRD


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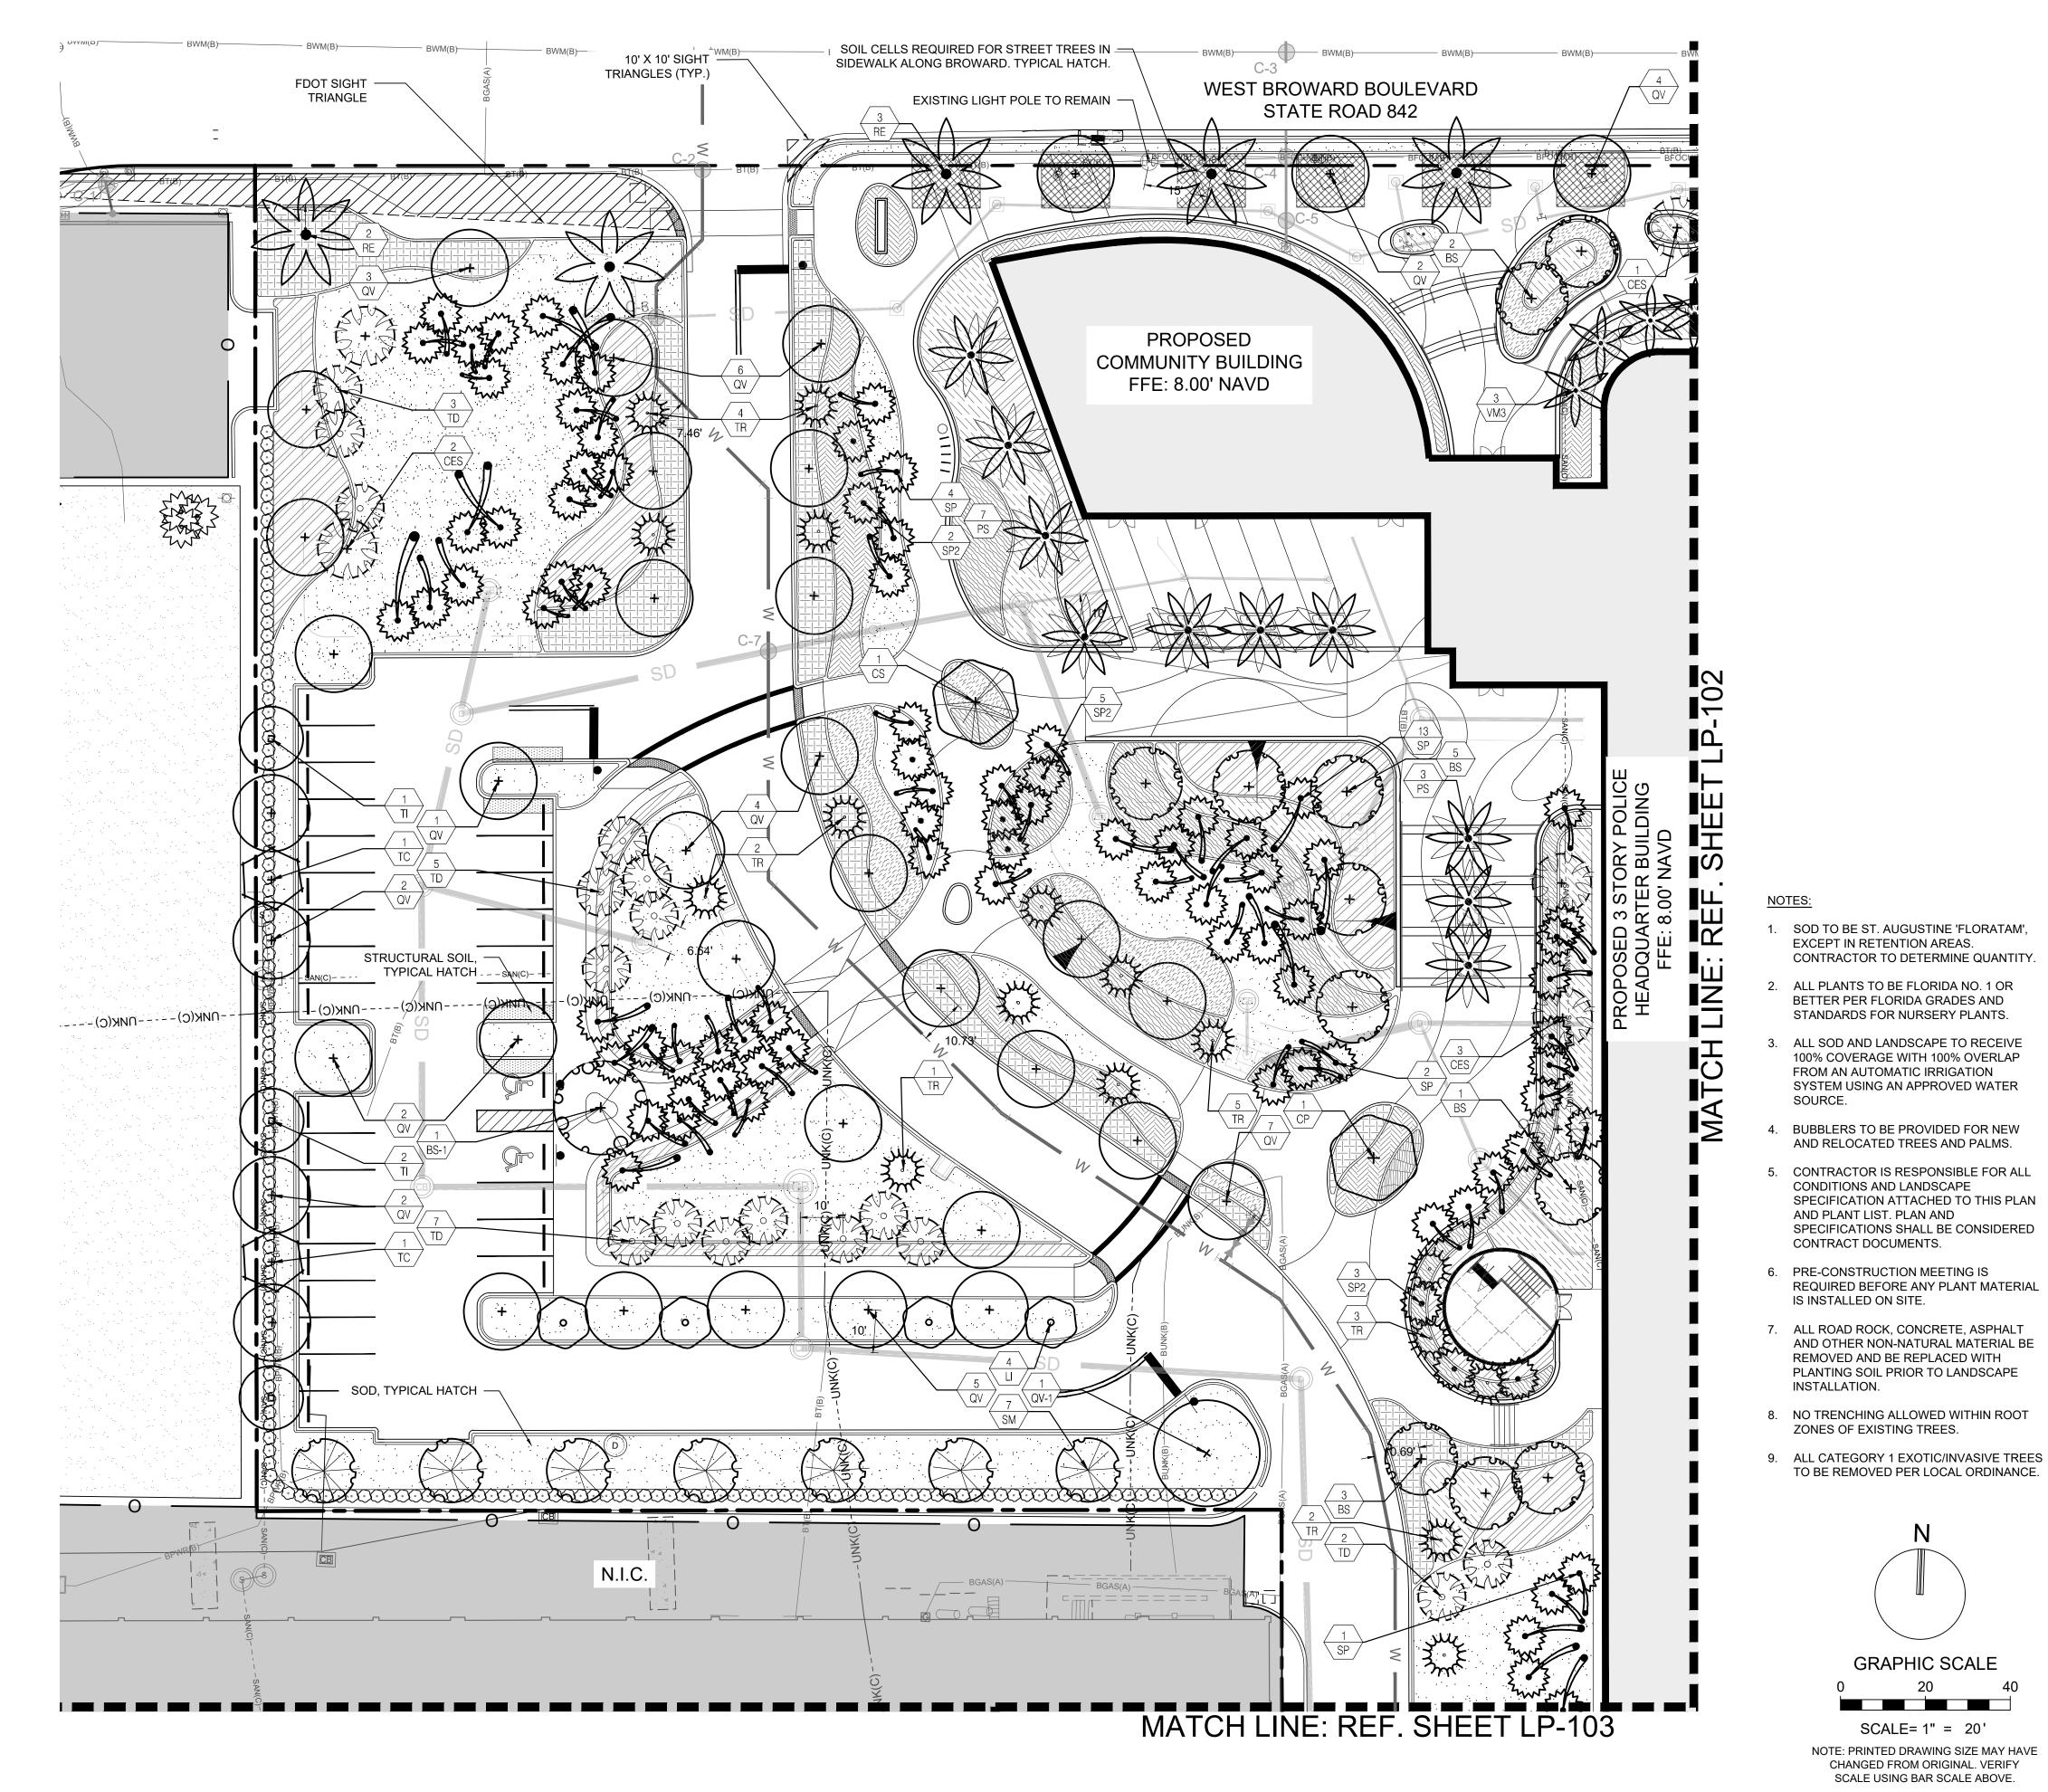
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QUICK REFERENCE PLANT LIST. SEE SHEET LP-002

FOR COMPLETE PLANT LIST AND NOTES

		HEDULE
TREES	QTY	BOTANICAL / COMMON NAME
BS	11	BURSERA SIMARUBA GUMBO LIMBO
BS-1	3	BURSERA SIMARUBA SPECIMEN GUMBO LIMBO
СР	1	CEIBA PENTANDRA KAPOK TREE
CS	1	CEIBA SPECIOSA FLOSS SILK TREE
CES	15	CONOCARPUS ERECTUS `SERICEUS SILVER BUTTONWOOD
LI	4	LAGERSTROEMIA INDICA CRAPE MYRTLE
MF	10	MYRCIANTHES FRAGRANS SIMPSON`S STOPPER
QV	46	QUERCUS VIRGINIANA SOUTHERN LIVE OAK
QV-1	1	QUERCUS VIRGINIANA SPECIMEN SOUTHERN LIVE OAK
SM	13	SWIETENIA MAHAGONI MAHOGANY
TC	2	TABEBUIA CARAIBA YELLOW TABEBUIA
TI	3	TABEBUIA IMPETIGINOSA PURPLE TRUMPET TREE
TD	24	TAXODIUM DISTICHUM BALD CYPRESS
PALMS	QTY	BOTANICAL / COMMON NAME
PR	1	PHOENIX RECLINATA SENEGAL DATE PALM
PS	10	PHOENIX SYLVESTRIS WILD DATE PALM
RE	8	ROYSTONEA ELATA FLORIDA ROYAL PALM
SP2	23	SABAL PALMETTO CABBAGE PALMETTO
SP	98	SABAL PALMETTO CABBAGE PALMETTO
TR	23	THRINAX RADIATA FLORIDA THATCH PALM
VM3	41	VEITCHIA MONTGOMERYANA MONTGOMERY PALM



301 East Atlantic Blvd. Pompano Beach, FL 33060 PH: (954) 788-3400 Florida Engineering Business License: CA7928 Florida Surveyor and Mapper Business License: LB6860 Florida Landscape Architecture Business License: LC260004 REVISIONS

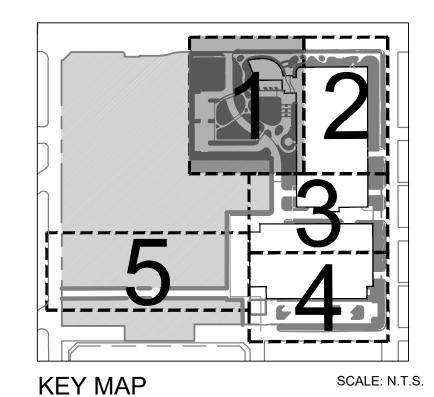DESCRIPTION DATE

RESPONSIBILITY FOR THE USE OF THESE PLANS PRIOR TO OBTAINING PERMITS FROM ALL AGENCIES HAVING JURISDICTION OVER THE PROJECT WILL FALL SOLELY UPON THE

ISSUE DATE:	04/04/22
DESIGNED BY:	MH, LW, AS
DRAWN BY:	MH, AS
CHECKED BY:	KS, PW
BID-CONTRACT:	

PAUL H. WEINBERG, R.L.A. FLORIDA REG. NO. LA6666804 (FOR THE FIRM)

CLIENT

CITY OF FORT LAUDERDALE

PROJECT

NEW POLICE HEADQUARTERS 1300-1350 WEST **BROWARD BLVD**


SHEET TITLE

CANOPY PLANTING PLAN

GRAPHIC SCALE 40


SCALE= 1" = 20' NOTE: PRINTED DRAWING SIZE MAY HAVE CHANGED FROM ORIGINAL. VERIFY SCALE USING BAR SCALE ABOVE.


LP-101 NUMBER **PROJECT** 11112.00 NUMBER

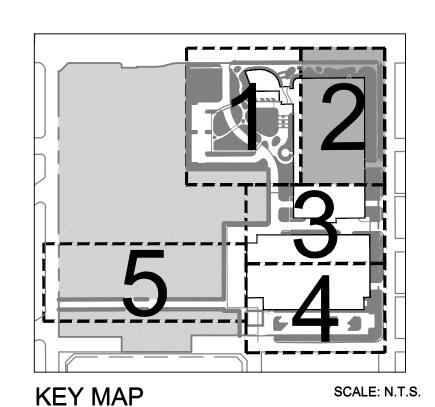

QUICK REFERENCE PLANT LIST. SEE SHEET LP-002 FOR COMPLETE PLANT LIST AND NOTES

PLAN [®]	T SCH	IEDULE
TREES	QTY	BOTANICAL / COMMON NAME
BS	11	BURSERA SIMARUBA GUMBO LIMBO
BS-1	3	BURSERA SIMARUBA SPECIMEN GUMBO LIMBO
СР	1	CEIBA PENTANDRA KAPOK TREE
CS	1	CEIBA SPECIOSA FLOSS SILK TREE
CES	15	CONOCARPUS ERECTUS `SERICEUS` SILVER BUTTONWOOD
LI	4	LAGERSTROEMIA INDICA CRAPE MYRTLE
MF	10	MYRCIANTHES FRAGRANS SIMPSON`S STOPPER
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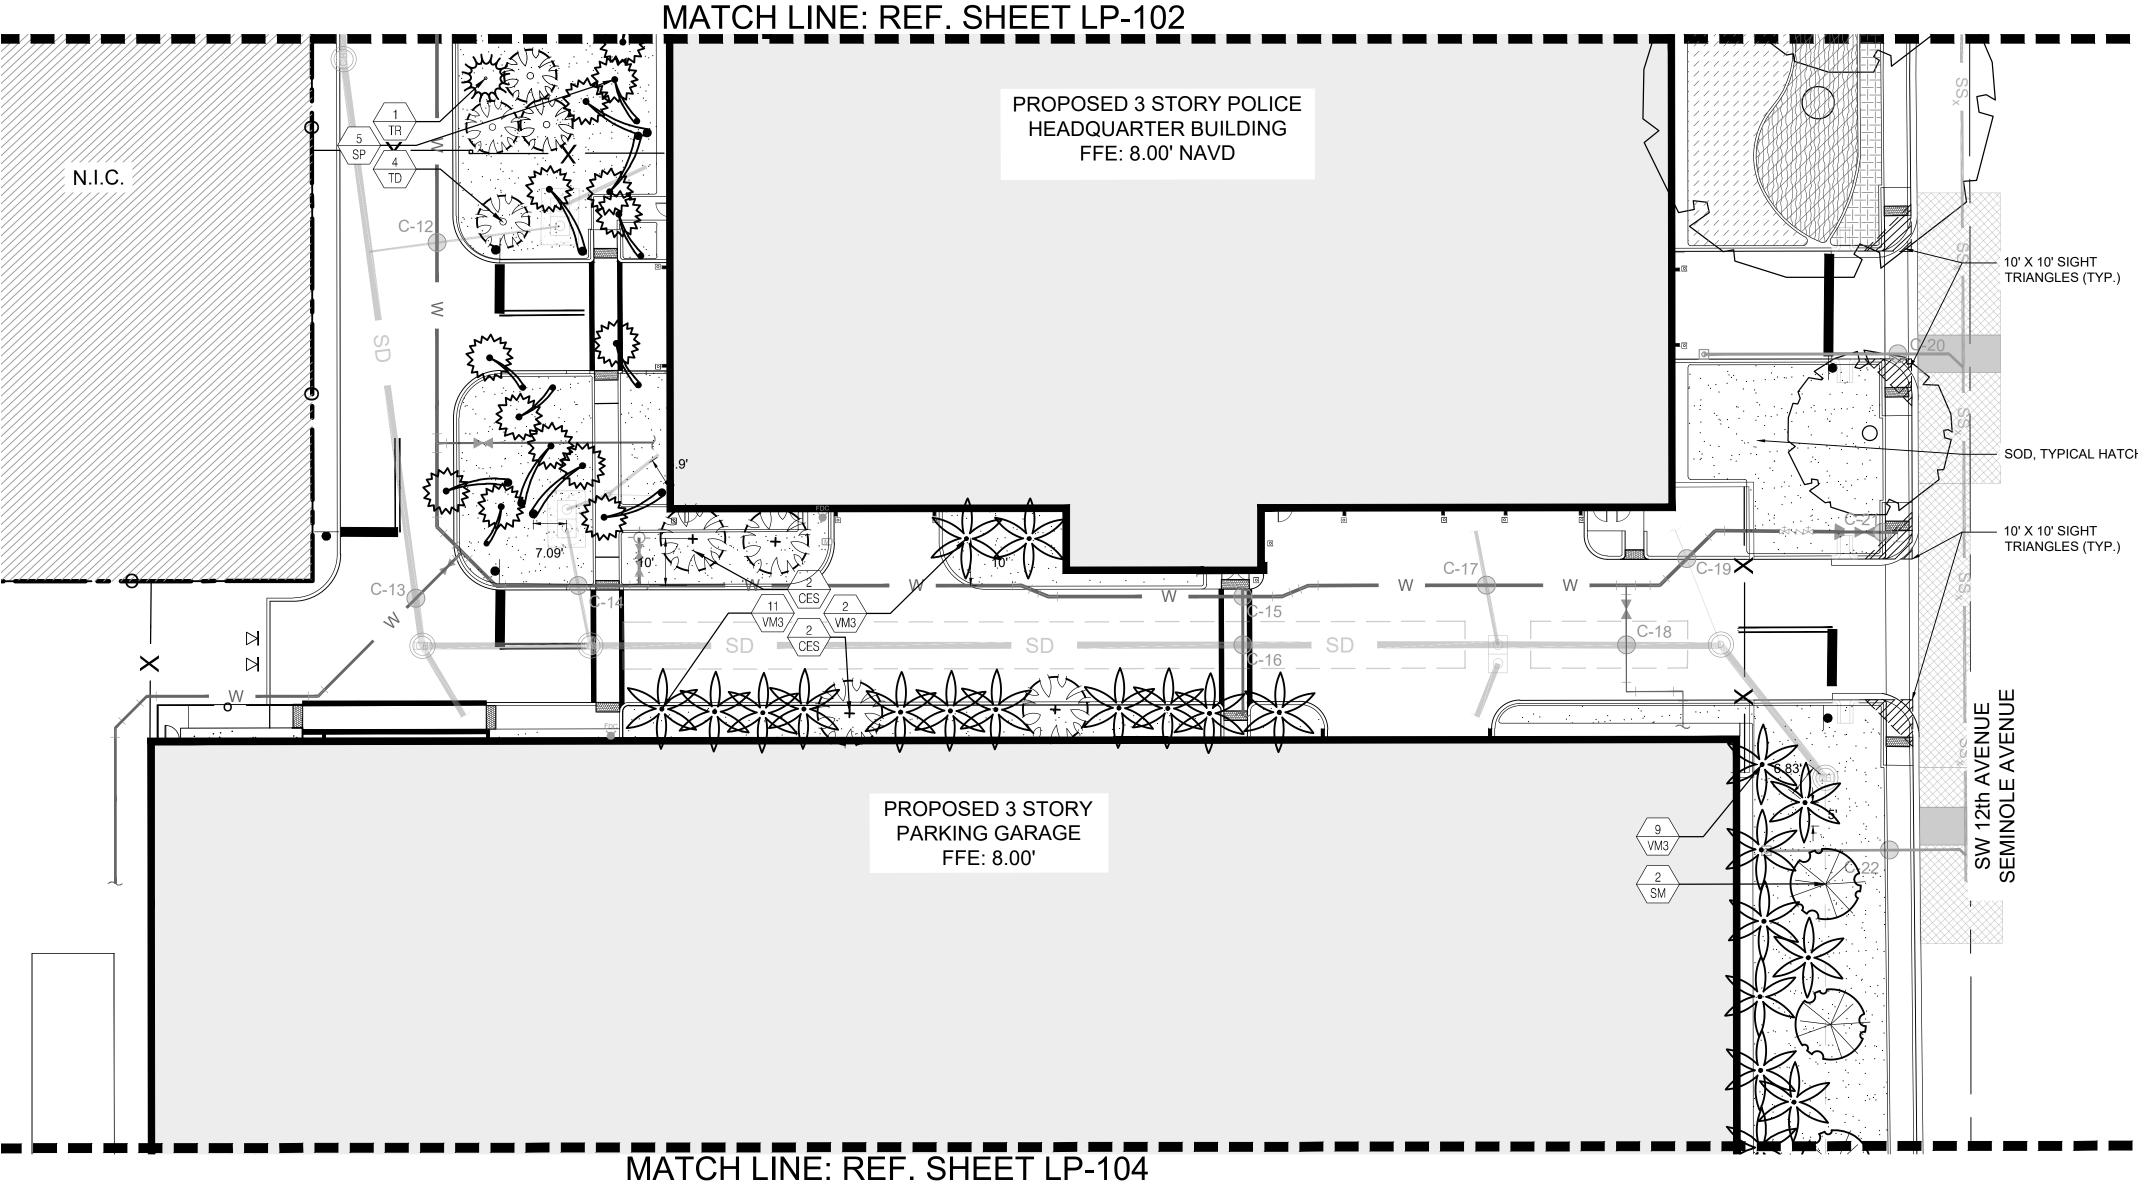

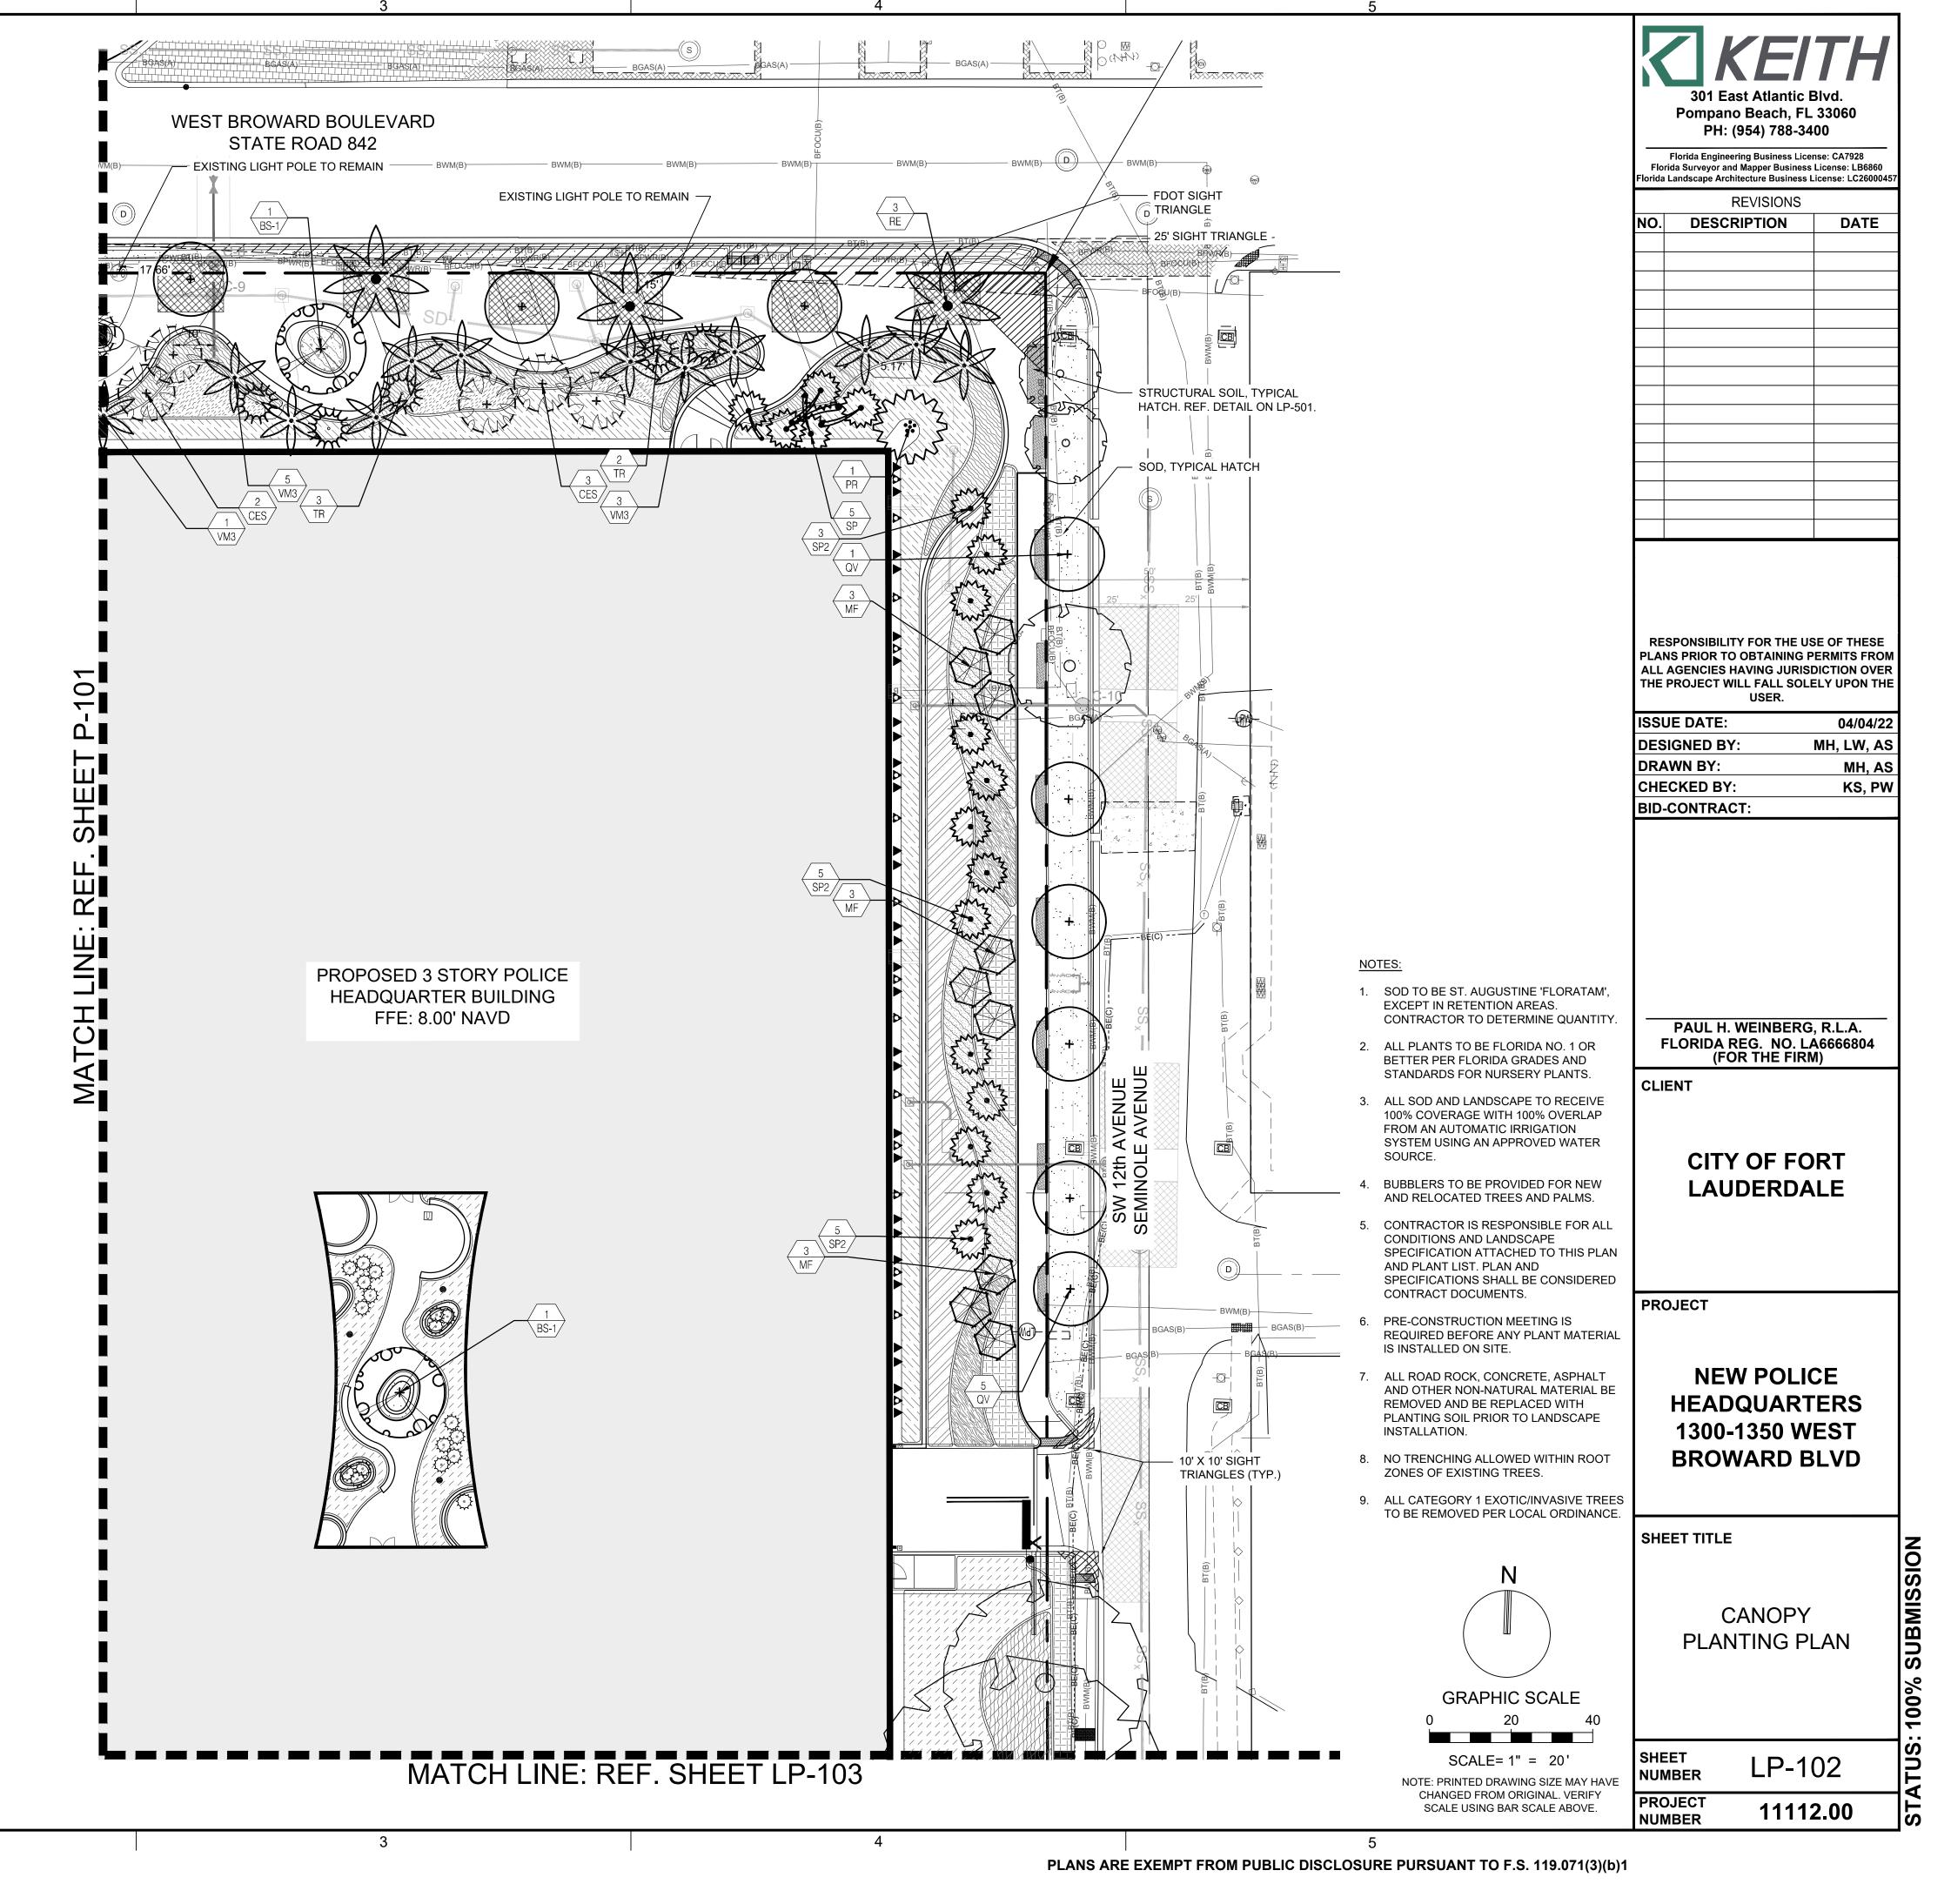
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FOR COMPLETE PLANT LIST AND NOTES
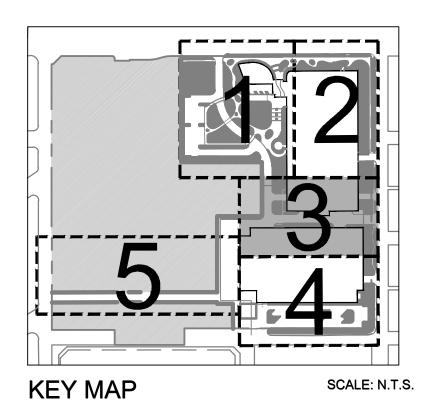
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VM3	41	VEITCHIA MONTGOMERYANA			

MONTGOMERY PALM



9. ALL CATEGORY 1 EXOTIC/INVASIVE TREES TO BE REMOVED PER

PLANS ARE EXEMPT FROM PUBLIC DISCLOSURE PURSUANT TO F.S. 119.071(3)(b)1

LOCAL ORDINANCE.

5. CONTRACTOR IS RESPONSIBLE FOR ALL CONDITIONS AND

7. ALL ROAD ROCK, CONCRETE, ASPHALT AND OTHER

PLANTING SOIL PRIOR TO LANDSCAPE INSTALLATION.

8. NO TRENCHING ALLOWED WITHIN ROOT ZONES OF EXISTING

CONTRACT DOCUMENTS.

TREES.

MATERIAL IS INSTALLED ON SITE.

LIST. PLAN AND SPECIFICATIONS SHALL BE CONSIDERED

6. PRE-CONSTRUCTION MEETING IS REQUIRED BEFORE ANY PLANT

NON-NATURAL MATERIAL BE REMOVED AND BE REPLACED WITH

1. SOD TO BE ST. AUGUSTINE 'FLORATAM', EXCEPT IN RETENTION

2. ALL PLANTS TO BE FLORIDA NO. 1 OR BETTER PER FLORIDA

3. ALL SOD AND LANDSCAPE TO RECEIVE 100% COVERAGE WITH

4. BUBBLERS TO BE PROVIDED FOR NEW AND RELOCATED TREES

100% OVERLAP FROM AN AUTOMATIC IRRIGATION SYSTEM USING

AREAS. CONTRACTOR TO DETERMINE QUANTITY.

GRADES AND STANDARDS FOR NURSERY PLANTS.

AN APPROVED WATER SOURCE.

AND PALMS.

LANDSCAPE SPECIFICATION ATTACHED TO THIS PLAN AND PLANT

