ARTHAUS

ALL RIGHTS RESERVED

CITY OF FORT LAUDERDALE, FLORIDA

DEVELOPMENT SERVICES DEPARTMENT SUBMITTAL FOR:

PROJECT TEAM DEVELOPMENT REVIEW COMMITTEE (DRC)

DEVELOPER / OWNER:

MODERNO DEVELOPMENT GROUP

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LANDSCAPE ARCHITECT: ARCHITECTURAL ALLIANCE LANDSCAPE

612 S.W. 4th Avenue Ft. Lauderdale, FL 33315

Ph: 954.249.1136

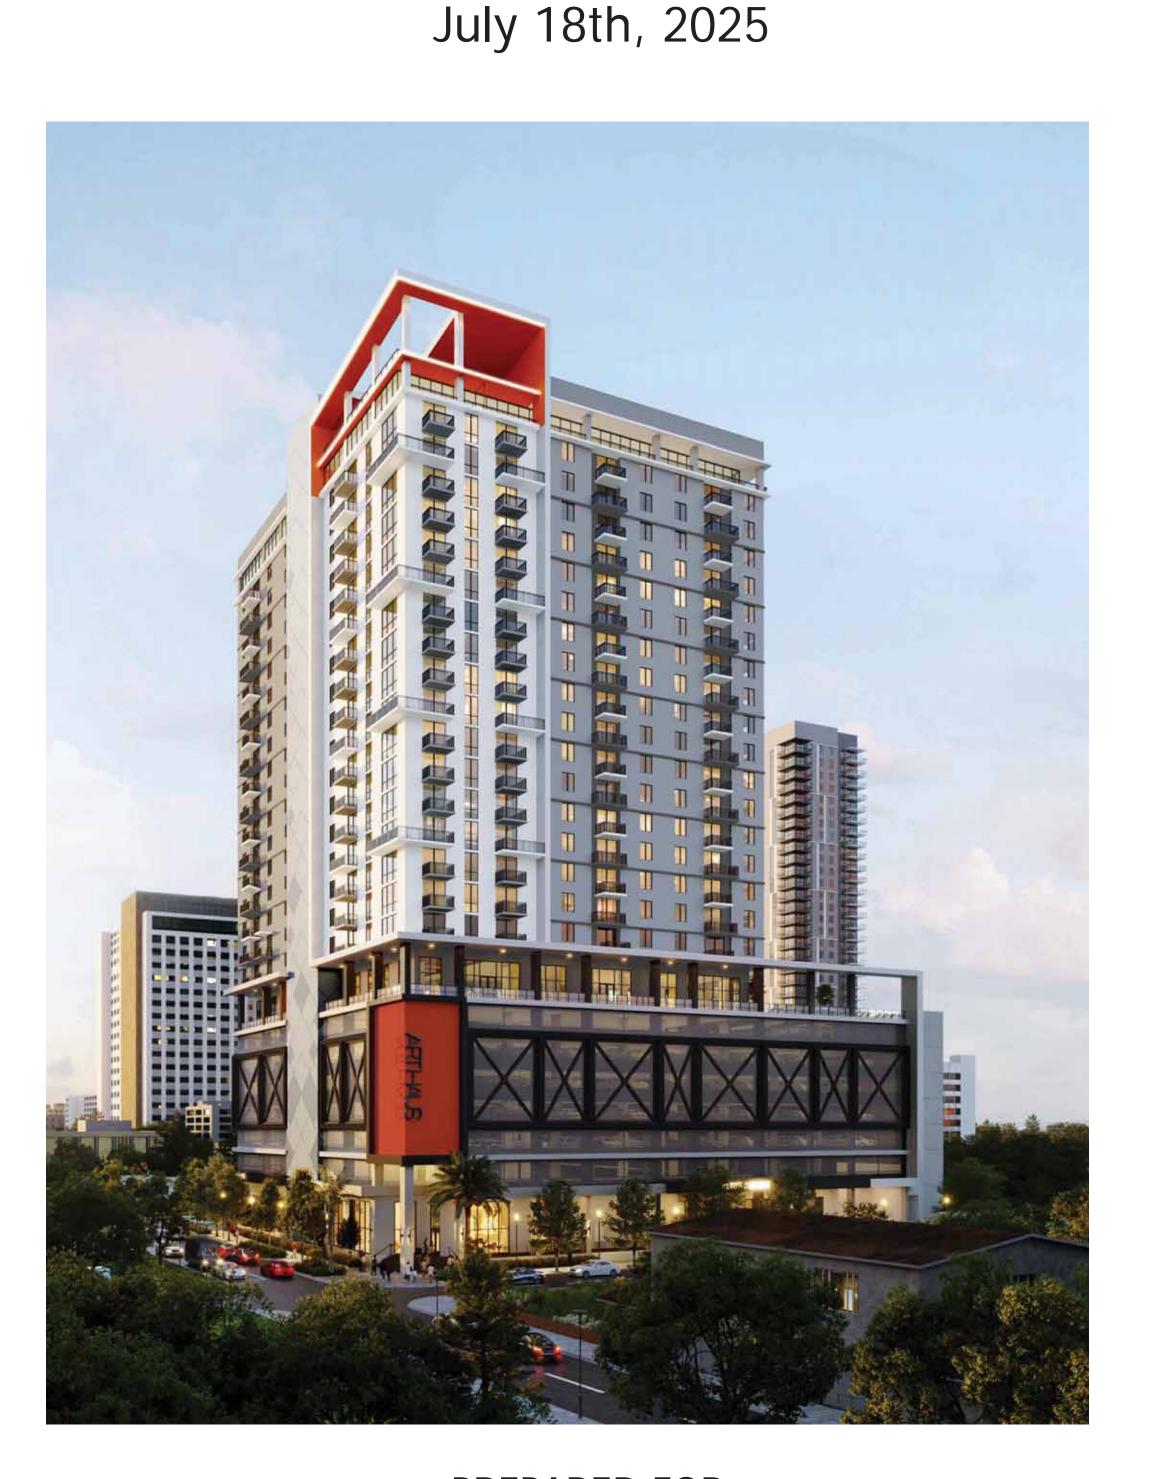
CIVIL ENGINEER / LAND PLANNING:

FLYNN ENGINEERING SERVICES, P.A.

241 Commercial Blvd.

Lauderdale by the Sea, Florida 33308

Ph: 954.522.1004 Fax: 954.522.7630



PREPARED FOR:

Moderno Development Group

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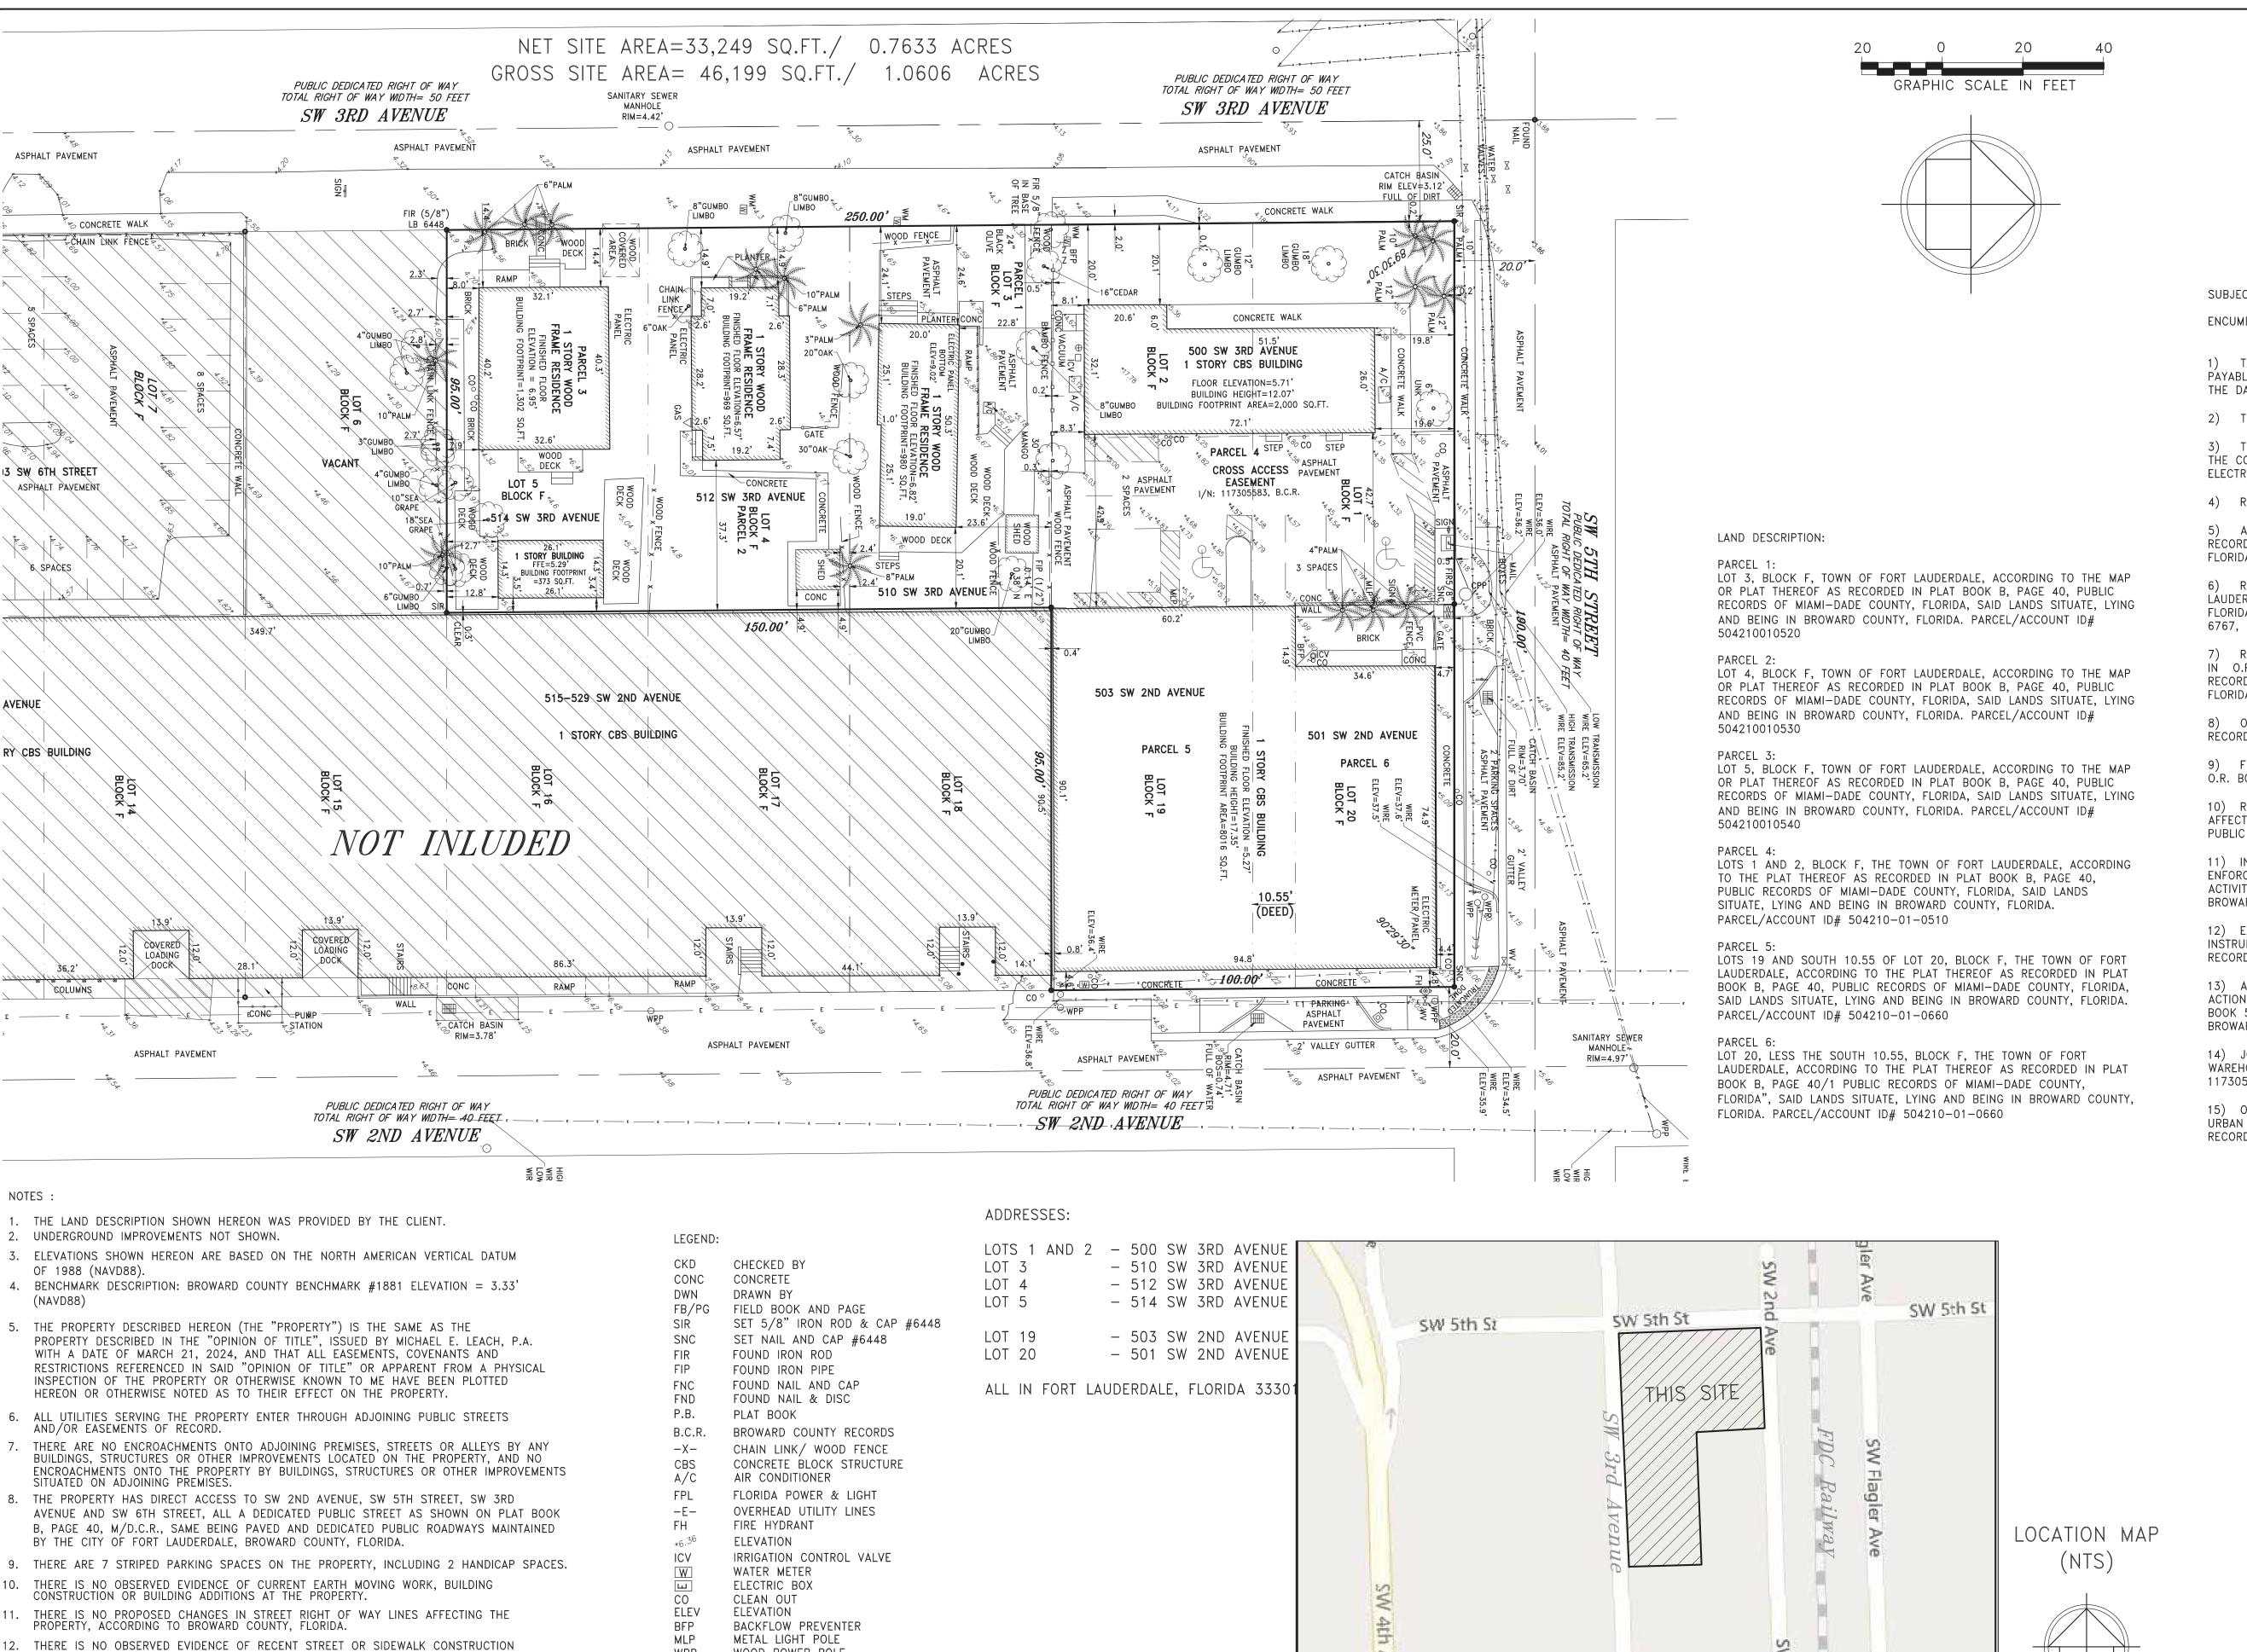
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FLOOD ZONE INFORMATION

COMMUNITY NUMBER 125105

PANEL NUMBER 0557H

ZONE X

BASE FLOOD ELEVATION N/A

EFFECTIVE DATE 08/18/14

SUBJECT TO THE FOLLOWING: (PER OPINION OF TITLE)

ENCUMBRANCES:

1) TAXES AND ASSESSMENTS FOR THE YEAR 2024 WHICH ARE NOT YET DUE AND PAYABLE, AND ALL TAXES AND ASSESSMENTS LEVIED AND PAYABLE SUBSEQUENT TO THE DATE OF THIS OPINION.

2) THE EFFECT OF MUNICIPAL ZONING ORDINANCES ON SUBJECT PROPERTY.

3) TERMS AND PROVISIONS OF ALL AGREEMENTS AND FRANCHISES PERTAINING TO THE COSTS, INSTALLATION, OPERATION AND MAINTENANCE OF GAS, WATER, SEWER AND ELECTRICAL FACILITIES.

4) RIGHTS OF THE LESSEES UNDER UNRECORDED LEASES.

5) ALL MATTERS CONTAINED ON THE PLAT OF THE TOWN OF FORT LAUDERDALE, AS RECORDED IN PLAT BOOK B, PAGE 40, PUBLIC RECORDS OF MIAMI-DADE COUNTY, FLORIDA, SAID LANDS SITUATE, LYING AND BEING IN BROWARD COUNTY, FLORIDA.

6) RIGHTS AS CONTAINED IN THAT CERTAIN CITY DEED BETWEEN THE CITY OF FORT LAUDERDALE AND THE STATE OF FLORIDA FOR THE USE AND BENEFIT OF THE STATE OF FLORIDA DEPARTMENT OF TRANSPORTATION RECORDED OCTOBER 20, 1976, IN Q.R. BOOK 6767, PAGE 200, PUBLIC RECORDS OF BROWARD COUNTY, FLORIDA.

(DOES NOT AFFECT/NOT PLOTTABLE)

7) RESOLUTION BY THE CITY OF FORT LAUDERDALE RECORDED FEBRUARY 10, 1994, IN O.R. BOOK 21744, PAGE 116, AS AFFECTED BY RELEASE OF IMPROVEMENT LIEN RECORDED IN O.R. BOOK 26908, PAGE 772, PUBLIC RECORDS OF BROWARD COUNTY, FLORIDA. (AFFECTS/NOT PLOTTABLE)

8) ORDINANCE NO. 2005-20 RECORDED IN O.R. BOOK 40082, PAGE 1796, PUBLIC RECORDS OF BROWARD COUNTY, FLORIDA. (AFFECTS/NOT PLOTTABLE)

9) FINAL ORDER ON THE BOARD OF ADJUSTMENT REGARDING VARIANCE RECORDED IN O.R. BOOK 46242, PAGE 350, PUBLIC RECORDS OF BROWARD COUNTY, FLORIDA.

(AFFECTS/NOT PLOTTABLE)

10) RESOLUTION NO. 12-241, RECORDED IN O.R. BOOK 49431, PAGE 825, AS AFFECTED BY RESOLUTION NO. 19-126 RECORDED IN INSTRUMENT NUMBER 115980965 PUBLIC RECORDS OF BROWARD COUNTY, FLORIDA. (AFFECTS/NOT PLOTTABLE)

11) INTERLOCAL AGREEMENT FOR MONITORING OF DEVELOPMENT ACTIVITY AND ENFORCEMENT OF PERMITTED LAND USES IN DOWNTOWN FORT LAUDERDALE REGIONAL ACTIVITY CENTER RECORDED IN INSTRUMENT NUMBER 114050934, PUBLIC RECORDS OF BROWARD COUNTY, FLORIDA. (AFFECTS/NOT PLOTTABLE)

12) EASEMENT IN FAVOR OF FLORIDA POWER AND LIGHT COMPANY CONTAINED IN INSTRUMENT RECORDED JUNE 24, 1985, UNDER O.R. BOOK 12633, PAGE 188, PUBLIC RECORDS OF BROWARD COUNTY, FLORIDA. (DOES NOT AFFECT/NOT PLOTTED)

13) AMENDED EASEMENT DEED BY COURT ORDER IN SETTLEMENT OF LANDOWNER ACTION RECORDED IN O.R. BOOK 49510, PAGE 562, O.R. BOOK 49885, PAGE 466, O.R. BOOK 50264, PAGE 1803, AND O.R. BOOK 50355, PAGE 1901, PUBLIC RECORDS OF BROWARD COUNTY, FLORIDA. (DOES NOT AFFECT/NOT PLOTTABLE)

14) JOINT USE AND CROSS ACCESS EASEMENT AGREEMENT BETWEEN 501 URBAN WAREHOUSE LLC AND 501 URBAN WAREHOUSE LLC, RECORDED IN INSTRUMENT NUMBER 117305583, PUBLIC RECORDS OF BROWARD COUNTY, FLORIDA. (AFFECTS/PLOTTED)

15) OFF-SITE PARKING AGREEMENT BETWEEN THE CITY OF FORT LAUDERDALE AND 501 URBAN WAREHOUSE LLC, RECORDED IN INSTRUMENT NUMBER 117305584, PUBLIC RECORDS OF BROWARD COUNTY, FLORIDA. (AFFECTS/NOT PLOTTABLE)

CERTIFIED TO:

THIS IS TO CERTIFY THAT THIS MAP OR PLAT AND THE SURVEY ON WHICH IT IS BASED WERE MADE IN ACCORDANCE WITH THE 2021 MINIMUM STANDARD DETAIL REQUIREMENTS FOR ALTA/NSPS LAND TITLE SURVEYS, JOINTLY ESTABLISHED AND ADOPTED BY ALTA AND NSPS, AND INCLUDES ITEMS 1, 2, 3, 4, 5, 6 (A) (B) (NON SUPPLYED), 7 (A), (B) AND (C), 8, 9, 13, 14, 16 AND 17 OF TABLE A THEREOF.

THE FIELDWORK WAS COMPLETED ON APRIL 05, 2024.

Dodrand E. Com

RICHARD E. COUSINS
PROFESSIONAL SURVEYOR AND MAPPER FLORIDA
REGISTRATION NO. 4188

COUSINS SURVEYORS & ASSOCIATES, INC.

PHONE (954)689-7766 EMAIL: OFFICE@CSASURVEY.NET

15. ZONING: REGIONAL ACTIVITY CENTER - SOUTHWEST MIXED USE ("RAC-SMU") ZONING DISTRICT

3921 SW 47TH AVENUE, SUITE 1011
DAVIE, FLORIDA 33314
CERTIFICATE OF AUTHORIZATION: LB # 6448

13. THERE IS NO OBSERVED EVIDENCE OF USE OF THE PROPERTY AS A SOLID WASTE

14. NO FIELD DELINEATION OF WETLANDS MARKERS WERE OBSERVED.

OR REPAIRS AFFECTING THE PROPERTY.

DUMP, SUMP OR SANITARY LANDFILL

501 URBAN WAREHOUSE LLC

FO

CTV

CLIENT:

WOOD POWER POLE

AMERICAN LAND TITLE ASSOCIATION

NATIONAL SOCIETY OF PROFESSIONAL SURVEYORS

WATER VALVE

DROPPED CURB

CABLE TELEVISION

FIBER OPTIC

TOWN OF FORT LAUDERDALE

P.B. B, PG. 40, M/D.C.R. SAID LANDS SITUATE,

LYING AND BEING IN BROWARD COUNTY, FLORIDA.

REVISIONS

DATE FB/PG DWN CKD

ALTA/NSPS LAND TITLE SURVEY

COMBINE LOTS 1 THROUGH 5 AND LOTS 19 AND 20

TREES ADDED

REVIEWED OPINION OF TITLE

ADDITIONAL INFORMATION ADDED

ADDRESS ENGINEERS COMMENTS

DATE FB/PG DWN CKD

07/11/22 DATA/COLL AM REC

07/11/22 DATA/

SW 6th St

ALTA/NSPS LAND TITLE SURVEY

PROJECT NUMBER: 9823-2

SCALE : 1" = 20'



- PROPOSED PROJECT SHALL COMPLY WITH FBC SECTION 403 HIGH-RISE BUILDINGS

OCCUPANCY CLASSIFICATION - MIXED USE

M - MERCANTILE

INCLUDES AMONG OTHERS, THE USE OF A BUILDING OR STRUCTURE OR PORTION THEREOF, FOR THE DISPLAY AND SALE OF MERCHANDISE AND INVOLVES STOCKS OF GOODS, WARES OR MERCHANDISE INCIDENTAL TO SUCH PURPOSES AND ACCESSIBLE TO THE PUBLIC.

R-2 - RESIDENTIAL

RESIDENTIAL OCCUPANCIES CONTAINING SLEEPING UNITS OR MORE THAN TWO DWELLING UNITS WHERE THE OCCUPANTS ARE PRIMARILY PERMANENT IN NATURE

S-2 - LOW HAZARD STORAGE

INCLUDES, AMONG OTHERS, BUILDINGS USED FOR THE STORAGE OF NONCOMBUSTIBLE MATERIALS

CONSTRUCTION TYPE

TYPE 1-A , SPRINKLERED

FIRE SPRINKLER SYSTEM

THE PROPOSED BUILDING IS TO INCORPORATE A COMPLETE SUPERVISED SPRINKLER SYSTEM AND FIRE ALARM SYSTEM. FIRE ALARM SHEETS FA, AND FIRE PROTECTION SHEETS FS TO BE PROVIDED DURING THE PERMITTING PROCESS.

PARKING GARAGE

THE PROPOSED PARKING GARAGE COMPONENT OF THE BUILDING IS DESIGNED TO BE MECHANICAL VENTILATED AS PER FBC 406.6.2 THE MAJOR APPLICABLE CODES FOR THE PROJECT INCLUDE, BUT ARE NOT LIMITED TO, THE FOLLOWING:

BUILDING CODE

FBC FLORIDA BUILDING CODE, 8TH EDITION (2023).

FIRE PREVENTION/LIFE SAFETY CODE

- FFPC FLORIDA FIRE PREVENTION CODE, 8TH EDITION

NFPA 70 NATIONAL ELECTRICAL CODE® (NEC), 2023 EDITION.

MECHANICAL CODE

FBC-M FLORIDA BUILDING CODE - MECHANICAL, 8TH EDITION.

PLUMBING CODE

- FBC-P FLORIDA BUILDING CODE - PLUMBING, 8TH EDITION.

- MAJOR NFPA STANDARDS

NFPA 10 STANDARD FOR PORTABLE FIRE EXTINGUISHERS, 2022 EDITION.

NFPA 13 STANDARD FOR THE INSTALLATION OF SPRINKLER SYSTEMS, 2022 EDITION

NFPA 14 STANDARD FOR THE INSTALLATION OF STANDPIPE AND HOSE SYSTEMS, 2024 EDITION.

NFPA 20 STANDARD FOR INSTALLATION OF STATIONARY FIRE PUMPS FOR FIRE PROTECTION, 2022 EDITION.

NFPA 72® NATIONAL FIRE ALARM AND SIGNALING CODE®, 2022 EDITION.

NFPA 88A STANDARD FOR PARKING GARAGE STRUCTURES, 2023 EDITION.

NFPA 90A STANDARD FOR THE INSTALLATION OF AIR-CONDITIONING AND VENTILATING SYSTEMS, 2024 EDITION.

NFPA 92 STANDARD FOR SMOKE CONTROL SYSTEMS, 2024 EDITION.

NFPA 110 STANDARD FOR EMERGENCY AND STANDBY POWER SYSTEMS, 2022 EDITION.

FAIR HOUSING ACT DESIGN MANUAL, 1998

Project site, building and units must meet or exceed Fair Housing Accessibility requiremens as published in the Federal Register Volume 56 Number 44 on March 6,1991. The following 7 Requirements must be addressed in meeting the guideline:

- Requirement 1 : Accessible Building Entrance on an Accessible Route

- Requirement 2 : Accessible and Usable Public and Common Use Areas

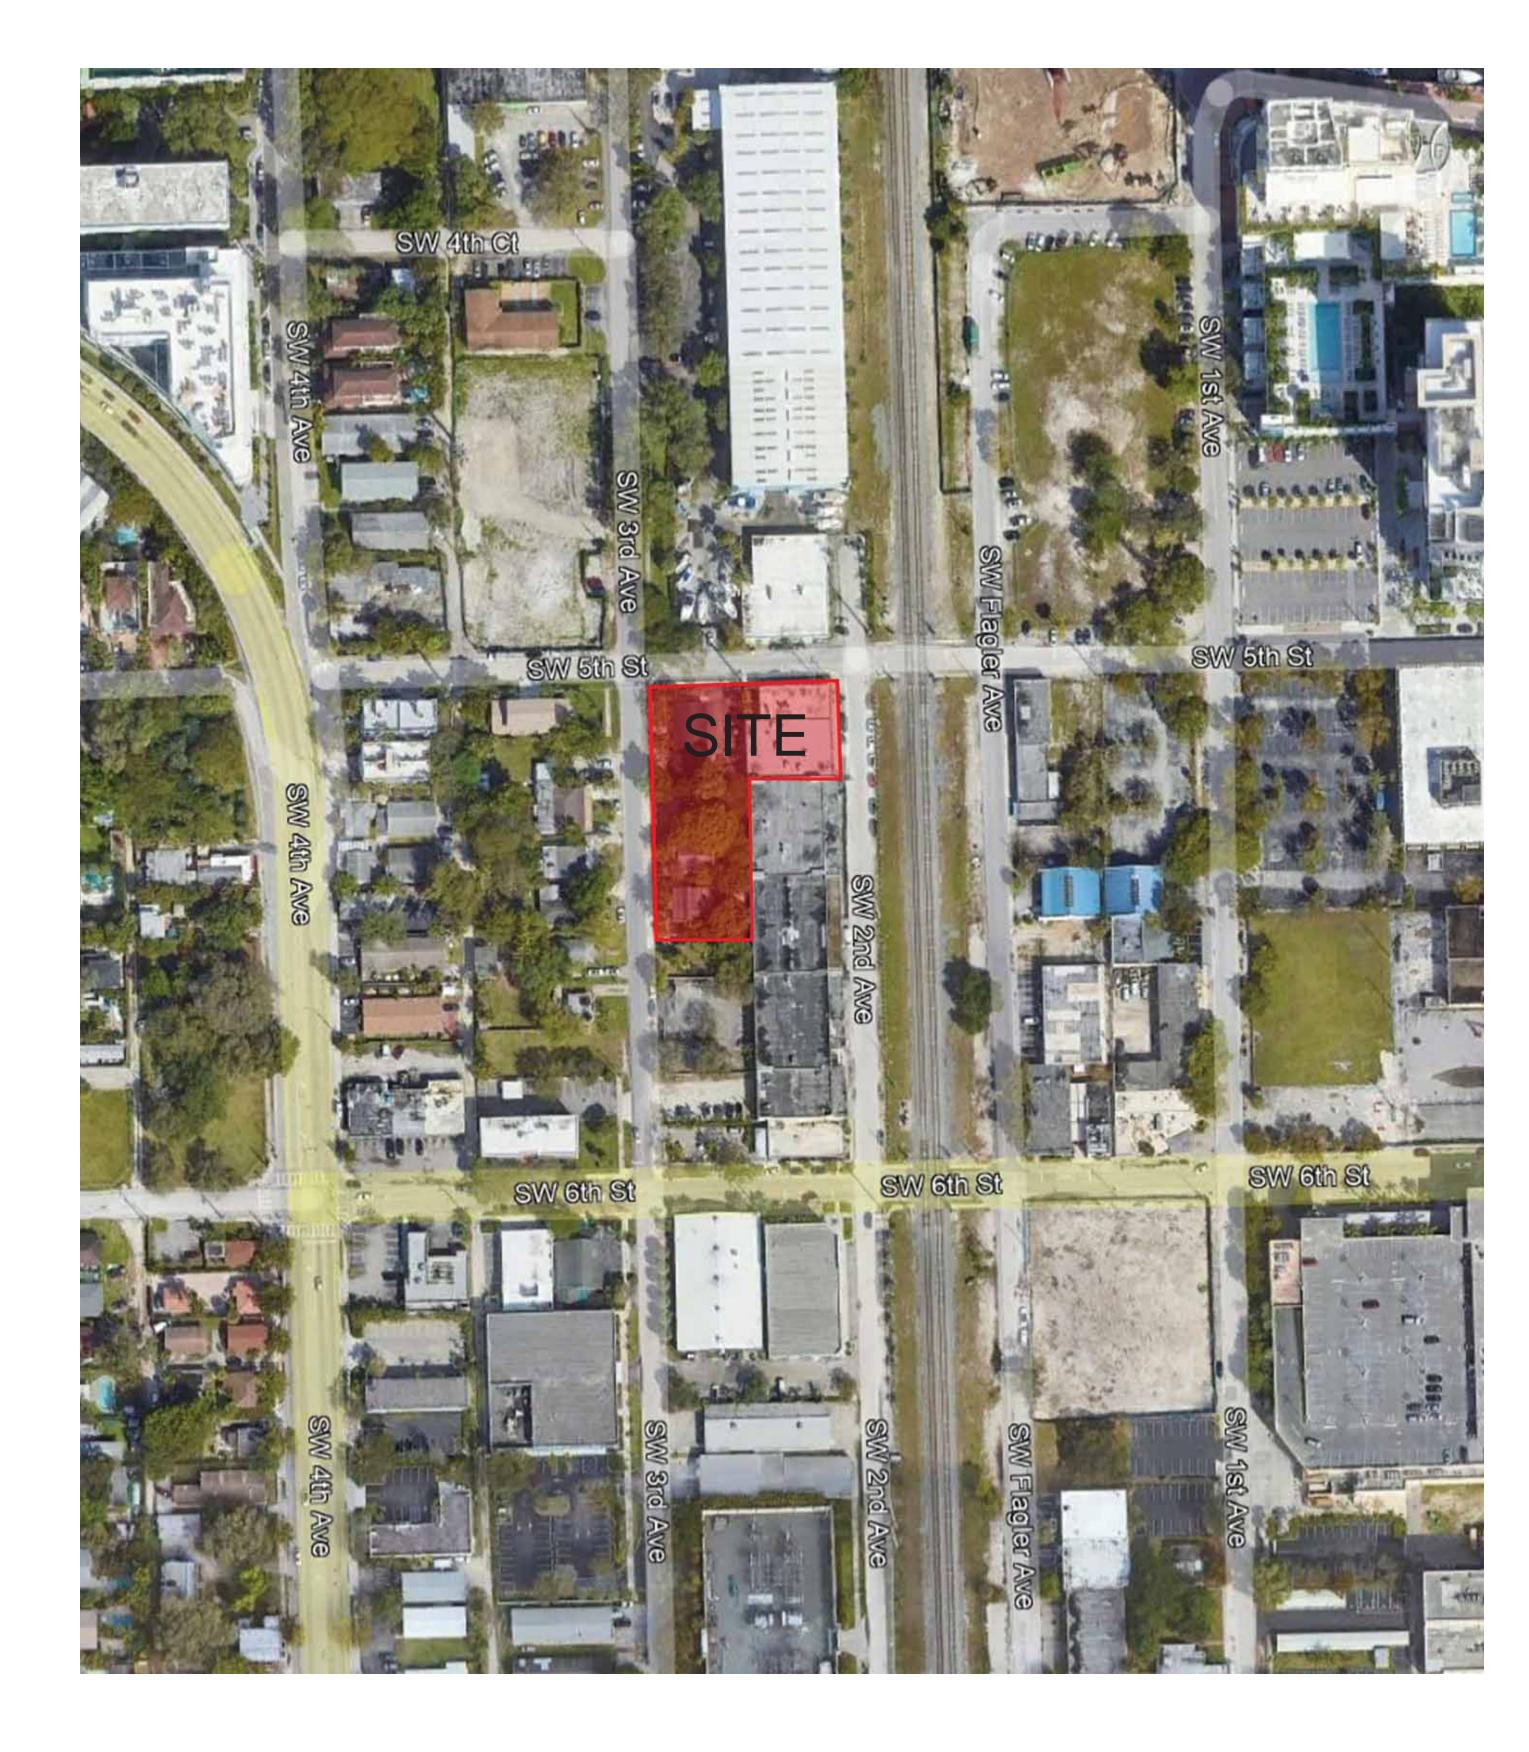
- Requirement 3 : Usable Doors

- Requirement 4 : Accessible Route Into and Through the Dwelling Unit

- Requirement 5 : Light Switches, Electrical Outlets, Thermostats and Other Environmental Controls in Accessible Locations

- Requirement 6 : Reinforced Walls for Grab Bars

- Requirement 7: Usable Kitchens and Baths







NOTES GENERAL AND























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No: Issue Date

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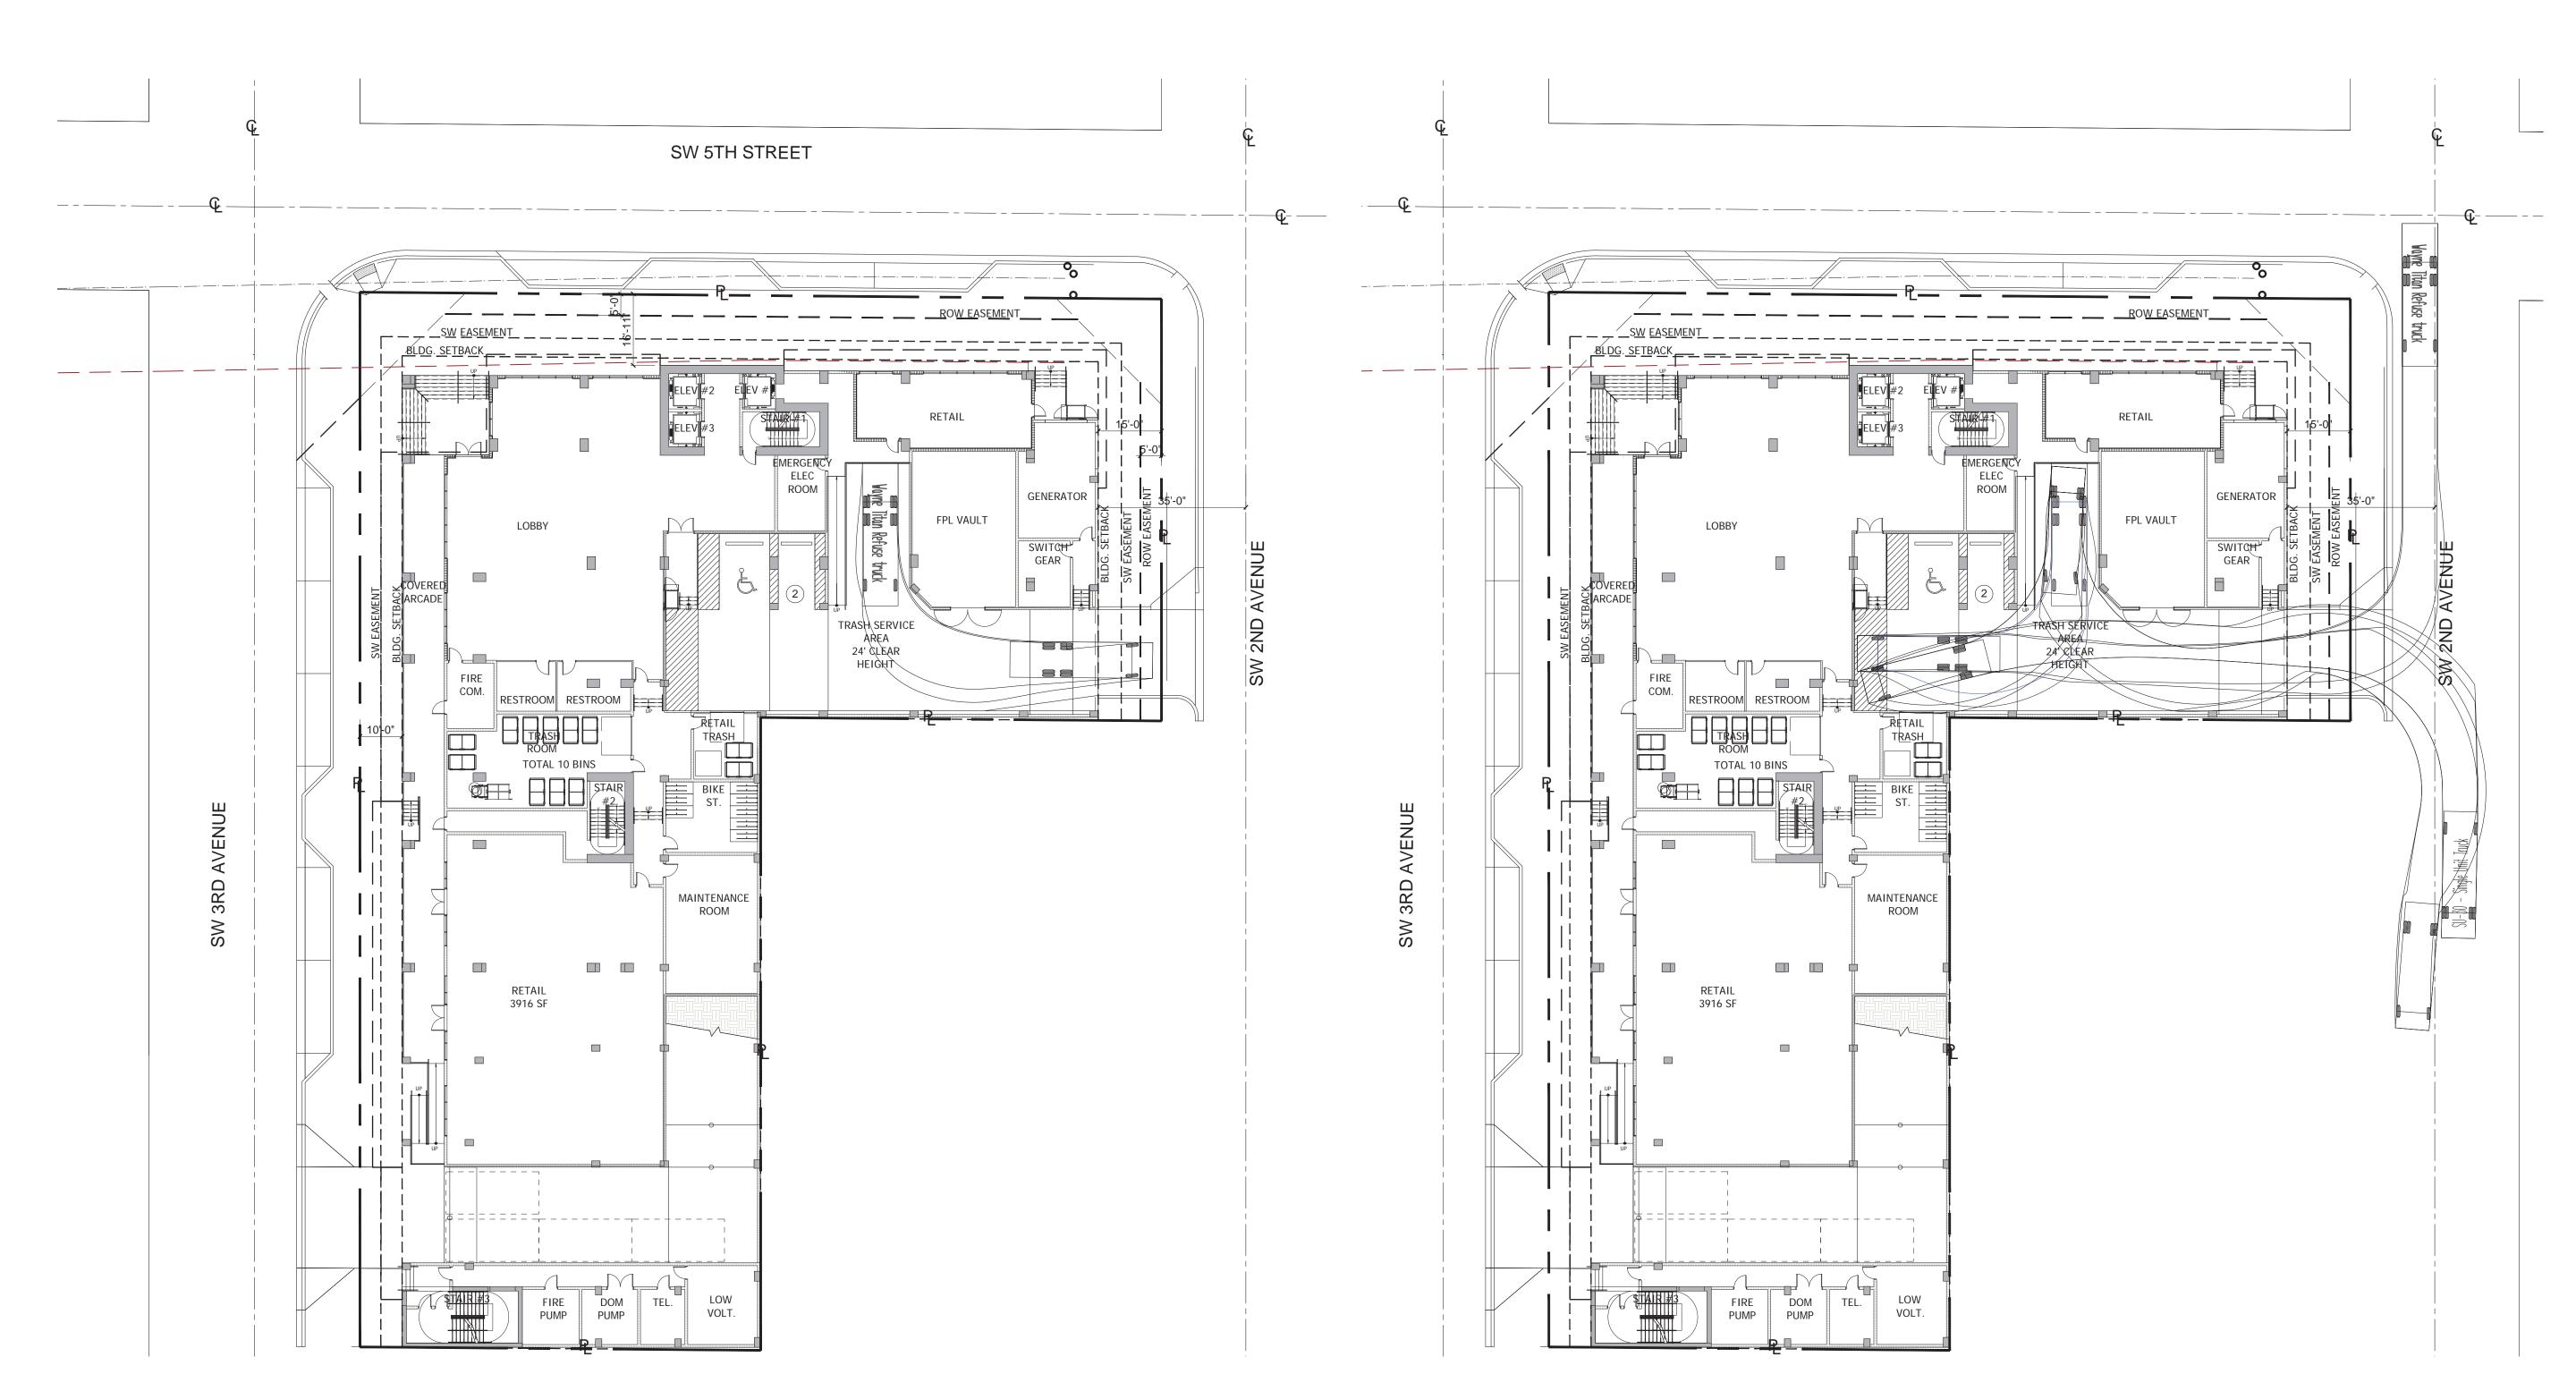
FORT LAUDERDALE, FLORIDA

AERIAL EXHIBIT

b No.: Drawn: Checked: Date: 06/16/2025



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PROPOSED SOLID WASTE AND RECYCLING PLAN

- 1. Residential units (265 units) will be served with 1 solid waste trash chute which terminate at enclosed trash room on ground level. One compactor will be provided (Wilkinson Hi-Rise Model 400-C5). The room is provided with total of 8- 2 cy containers. (5 bins required+ 3 additional bins for servicing) Per calculations below, residential units could produce total of 172.25 CY per week. Based on five times a week pickup schedule, solid waste service will be for 34.45 CY.
- 2. Retail and potential restaurant use will be serviced by one Accu-Pak vertical compactor with a compaction ratio of 3. Per projection below, retail and restaurant use will produce 1.6 cy waste after compaction.
- 3. The service, loading and unloading will be coordinated and actively managed by the property management company.

Estimated Waste Loads - Residential

Solid Waste

- 1. 265 units are estimated to produce 172.25 cubic yards (CY) of solid waste per week.
- 2. Given the Specified Wilkinson model 400 2 CY Compactor Unit, with a compaction ratio of 4 the estimate waste will result in 8.61 CY.
- 3. 2 CY containers shall be provided which will result in 5 containers for five times a week.

Recyclables- Residential

Management will provide recycling bins to the residents and inform them about the recyclable materials as per the City of Fort Lauderdale guidelines. The management will periodically collect recycled materials from residents and will store within the trash room in 2cy bins for pickup by Recycling Service Provider. Total of 2 bins will be provided for the residential trash room.



MINIMUM SERVICES REQUIREMENTS - ARTHAUS									
	GENERATION RATES	SERVICE LEVELS	UNITS/ROOMS	AREA (SQ. FT)	CY/WEEK SOLID WASTE	CY/ FIVE TIMES A WEEK WASTE	COMPACTOR RATIO	AFTER COMPACTION	_
ARTHAUS									
			PER 10,000	SQ FT					
RETAIL	4 LBS/ 100 SF / DAY	31 CY/ WEEK		2,687	8.32	2.77	3	0.92 CY	1 BIN REQ.
RESTAURANT	2 LBS/ MEAL / DAY	31 CY/ WEEK		2,000	6.2	2.06	3	0.68 CY	1 BIN REQ.
RESIDENTIAL	1 TON / UNIT/ YEAR	0.65 CY/ UNIT/ WEEK	265		172.25	34.45	4	8.61 CY	5 BINS REQ

CY= CUBIC YARD DISPOSAL FACTOR: 90 LBS/ CUBIC YARD

TOR K. YUE	AR 0013087
AR001	3087
AR001	3087 Date

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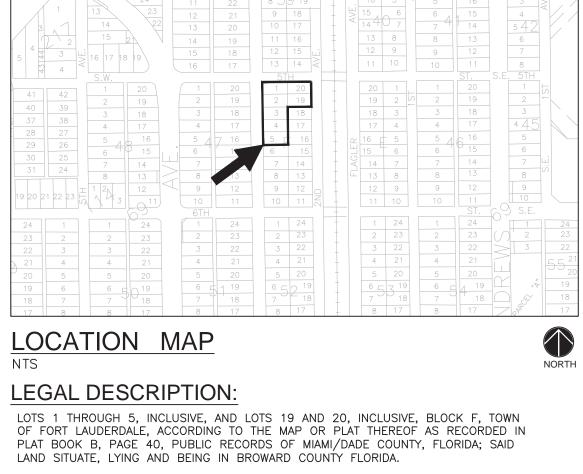
ARTHAUS	FORT LAUDERDALE, FLORIDA ALL RIGHTS RESERVED
	te: /16/2025

WASTE PICKUP EXHIBIT

Job No.: Drawn: Checked: Date:

DY202334 06/16/2025

SURPLUS)



PLAT BOOK B, PAGE 40, PUBLIC RECORDS OF MIAMI/DADE COUNTY, FLORIDA; SAID LAND SITUATE, LYING AND BEING IN BROWARD COUNTY FLORIDA.

SITE PLAN INFORMATION

CURRENT USE OF PROPERTY	RESIDENTIAL/COMMERCIAL
CURRENT LAND USE DESIGNATION	D-RAC
PROPOSED LAND USE DESIGNATION	D-RAC
CURRENT ZONING DESIGNATION	RAC-SMU (NEAR DOWNTOWN)
PROPOSED ZONING DESIGNATION	RAC-SMU (NEAR DOWNTOWN)
ADJACENT ZONING DESIGNATION-NORTH	RAC-SMU
ADJACENT ZONING DESIGNATION—SOUTH	RAC-SMU
ADJACENT ZONING DESIGNATION—EAST	RAC-SMU
ADJACENT ZONING DESIGNATION-WEST	RAC-SMU
	<u> </u>

TOTAL PERVIOUS EXISTING (LANDSCAPE)	9,582 SF	29
TOTAL PERVIOUS PROPOSED (LANDSCAPE)	2,668 SF	89
TOTAL IMPERVIOUS EXISTING	9,949 SF	30
TOTAL IMPERVIOUS PROPOSED	6,622 SF	20
TOTAL BUILDING FOOT PRINT EXISTING	13,719 SF	41
TOTAL BUILDING FOOT PRINT PROPOSED	23,959 SF	72
TOTAL BUILDING SQUARE FOOTAGE (PROPOSED MIXED USE)	256,500	G.S.F.
FLOOR AREA RATIO (F.A.R.) (256,500/33,249)	7.7	′
LOT DENSITY (265 UNITS/0.76 AC)	349 UNI	TS/AC
PROPOSED RESIDENTIAL UNIT COUNT	265 UI	VITS
BUILDING HEIGHT	272'-	4"
PROPOSED RESIDENTIAL SF	181,02	24 SF
PROPOSED COMMERCIAL SF	4,68	7 SF
PROPOSED AMENITY/TENANT STORAGE SF	14,60	7 SF
PROPOSED SERVICE/OTHER SF	56,18	2 SF
PROPOSED PARKING GARAGE	151,370	SF (NIC

PARKING DATA:

PEDESTRIAN WALKS & PLAZAS

.,	_			REQUIRED	
PARKING DATA:			CODE	PER PKG	PROVIDED
	SF/UNIT	RATIO	CODE	REDUCTION	I KOVIDED
(RESIDENTIAL – MARKET – STUDIO)	88 UNITS	1.75/UNIT	154.0	105.6	
(RESIDENTIAL - AFFORDABLE - STUDIO)	18 UNITS	1.00/UNIT	18.0	18.0	
(RESIDENTIAL - MARKET - 1BR)	115 UNITS	1.75/UNIT	201.3	138	
(RESIDENTIAL – AFFORDABLE – 1BR)	21 UNITS	1.00/UNIT	21.0	21.0	
(RESIDENTIAL - MARKET - 2BR)	19 UNITS	2.00/UNIT	38.0	22.8	
(RESIDENTIAL – AFFORDABLE – 2BR)	4 UNITS	1.00/UNIT	4.0	4.0	
	265 TOTAL	UNITS			
R	ESIDENTIAL S	UBTOTAL:	436.3	309.4	309.0
(RETAIL)	2,500 SF ((EXEMPT)**	0.0	0.0	
(RETAIL)	2,187 SF	1/250	8.7	8.7	6.0
			-35**	-3.5**	

COMMERCIAL SUBTOTAL: 5.2 5.2 6.0 REQUIRED PROVIDED 442

*PARKING PER ULDR SEC 47-20.3., REDUCTIONS & EXEMPTIONS, A PARKING REDUCTION IS BEING REQUESTED THE PARKING REDUCTION REQUEST IS (1.2 SPACE/MARKET RATE UNIT) PER THE PARKING REDUCTION, 295 SPÀCES IS RÉQUIRED **PER SEC 47-20, TABLE 3, NONRESIDENTIAL

 <2,500 SF EXEMPT. • >2,500 SF = 40% REDUCTION = 3.5 SPACES

PARKING GARAGE DATA:

	PROVIDED	TYPE
GROUND LEVEL PARKING	2	1S + 0C + 1HC
2ND LEVEL PARKING	53	51S + 1C + 1HC
3RD LEVEL PARKING	55	51S + 3C + 1HC
4TH LEVEL PARKING	55	51S + 3C + 1HC
5TH LEVEL PARKING	55	51S + 3C + 1HC
6TH LEVEL PARKING	53	49S + 3C + 1HC
7TH LEVEL PARKING	42	37S + 3C + 2HC
	TOTAL ₌ 315	291 STANDARD - 94% 16 C SPACES - 3% 8 HC SPACES - 3%

BICYCLE REQUIREMENTS:		REQUIRED	PRO
TOTAL BICYCLE PARKING INTERIOR (1/10 UNITS)		30	
*LOCATED ON GROUND FLOOR			
	1		
LOADING REQUIREMENTS:			
LOADING REQUIREMENTS:	GSF	REQUIRED	PRO
LOADING REQUIREMENTS: RESIDENTIAL	GSF *		PRO
		0	PRC
RESIDENTIAL	*	0	PRC

*RAC LOADING REQ. FOR NON-RESIDENTIAL NOT REQUIRED.

STACKING REQUIREMENTS:		IN-BOUND	IN-BOUND	OUT-BOUND	OUT-BOUN
		REQUIRED	PROVIDED	REQUIRED	PROVIDED
SW 3rd AVE] [3	3+	1	1+
* STACKING REQUIREMENT PER ULDR	SE	C 47-20.5	5.C.6.		

SETBACK TABLE REQUIRED PROVIDED FRONT YARD (WEST) -35' TO CL 35.0' BLDG TO CL SW 3RD AVENUE REAR YARD (SOUTH) -0' from PL 0' from PL (SE) ADJ PROPERTY 0' from PL (SW) SIDE YARD (NORTH) -35' TO CL 36.5' BLDG from CL* SW 5TH STREET 35' TO CL | 35.0' BLDG TO CL (NE) SIDE YARD (EAST) -SW 2ND AVENUE 0.0' BLDG TO PL (SE) *BUILDING REQUIRED TO BE 15' FROM EXISTING LIGHT POLE INDICATED ON SITE PLAN (17.8' PROVIDED FROM TRANSMISSION POLE

TO BUILDING)

DRT TABLE

NEAR DOWNTOWN:	REQUIRED:	PROPOSED:	DEVIATION:
Max. Bldg Height *	30 floors	26 stories	NO
Max. Bldg Streetwall Length	300'	SW 2ND AVE: 81.9' (BLDG) SW 2ND AVE: 85.8' (BLDG & BALCONY) SW 5TH ST: 165.3' (BLDG) SW 5TH ST: 166.9' (BLDG & BALCONY) SW 3RD AVE: 230.3' (BLDG) SW 3RD AVE: 230.3' (BLDG & BALCONY)	NO
Max. GSF of Bldg Tower Floor Plate Size	Residential:12,500 for entirety of bldg tower up to 30 floors high	12,455 sf	NO
Max. Bldg Podium Height	7 Floors	7 Floors	NO
Min. Bldg Tower Step Back	15' (ROW stepback)	15'-1" E PL 0'-0" W PL 0'-0" N PL	NO YES YES
Min. Separation b/t Towers	60' 30' minimum on subject property if adjacent to abutting lot under separate ownership	30'-1" (S-East) 89'-0" (S-West) 30'-1" (E)	NO NO NO
Min. Residential Unit Size	400 sf	472 sf	NO

	MINIMIIM	MAXIMUM:
T	IVIIIVIIVIOIVI.	IVIAAIIVIOIVI.
North	6"	2'-10"
South	N/A	N/A
East	1'-10"	2'-0"
West	2'-0"	7'-0"
North	N/A	N/A
South	2"	4'-8"
East	1'-10"	5'-0"
	South East West North South	South N/A East 1'-10" West 2'-0" North N/A South 2"

LINIT MIX DATA.

UNIT WILL DATA.						
PARKING DATA:	#MARKET RATE UNITS	#AFFORABLE UNITS	TOTAL # UNITS	% OF TOTAL	AREA	AVERAGE
STUDIO	88	18	106	40%	54,497 SF	514 SF
ONE BEDROOM	115	21	136	51%	102,153 SF	751 SF
TWO BEDROOM	19	4	23	9%	24,374 SF	1,059 SF
TOTAL	222	43	265	100%	181,024 SF	683 SF

N/A

N/A

WATER/WASTEWATER SERVICE PROVIDER: * CITY OF FORT LAUDERDALE

STRUCTURAL SOIL:

STREETWALL LENGTH -(INCLUDES BALCONY) 165.1 STREETWALL LENGTH -(EXCLUDES BALCONY)

ASPHALT PAVEME

3.3' NAVD

MAINTENANCE

8' CLEAR

VOLT.

ROOM

25' SIGHT TRIANGLE —

SIDEWALK

ESMT

(CITY)

STRUCTURAL SOIL (TYP)

5.0'

BALCONY

ENCROACHMENT

SEE SOLID

FOR DETAILS-

7.0' BALCONY ENCROACHMENT

BLDG TO

CL (W)

PED. LIGHT POLE (TYP)—

10' PEDESTRIAN

10' SIGHT TRIANGLE (TYP)

TRIANGLE (TYP)-

WASTE/RECYCLING

TABLE IN SITE DATA

STRUCTURAL SOIL

R25.0'-

CURB RAMP-

SW 5TH STREET

PUBLIC DEDICATED RIGHT OF WAY

OTAL RIGHT OF WAY WIDTH= 40 FEET

CONC POWER POLE

) ON-STREET

PARKING _

BALCONY

ENCROACHMENT

26 STORY - 272'-4" MIXED USE BUILDING 315 PARKING SPACES FFE = 7.40 NAVD

3867 SF

BLOCK F

COM.

EL. +0'-0" = +7.40' NAVD

BLDG. SETBACK

RETAIL

<u>EL. +0'-0" =</u> +7.4' NAVD

10'x15' WATER EASEMENT

CHAIN LINK FENCE

90.5

TOWER

SEPARATION

CONCRETE WALL

BLOCK F

10'X22' ₄) INBOUND STACKING (1) OUTBOUND STACKING

TO REMAIN—

EXIST. OVERHEAD

-BLDG TO

CL (N)

REMAIN

POWER LINES TO

5.5'

5.0'

ROW ESMT-

(2) ON-STREET PARK

SERVICE AREA

30.2

TOWER

SEPARATION

ROOM

5% SLOPE

PL (SE)

TOWER

SEPARATION

7.72 TURNAROUND AREA

SIDEWALK ESMT -

WOODEN POWER POLE

TO BE REMOVED AND

RETAIL LOT

EL. +0'-0" = +7.40' NAVD

FPL VAULT

24' CLEAR HEIGHT

BLDG TO-

LOT 18

BLOCK F

BLOCK F

BLOCK F

BLOCK F

FLOOD DATA:

SEE CIVIL PLAN SHEET C2

10' PEDESTRIAN SIGHT

10' SIGHT TRIANGLE (TYP)-

TRIANGLE (TYP)—

PL (SE)

GENERATOR 5.4' 7.0'

__15.3**'**___

SWITCH

5% SLOPE

GEAR

771 SF BLOCK F

OVERHEAD POWER

LINES TO BE

RELOCATED -

-WOODEN POWER POLE

TO BE RELOCATED

25' SIGHT TRIANGLE

TO TO BEE REMOVED AND

POLE WITH RELOCATED

— CURB RAMP

TOVERHEAD POWER LINES!

OVERHEAD POWER LINES

PROPOSED CONCRETE POWER

FIRE HYDRANT TO BE RELOCATED

-STRUCTURAL SOIL (TYP)

EXIST. POWER POLE

TO BE REMOVED AND POWER LINES TO BE UNDERGROUNDED

PLANTER

TOWER

SEPARATION

<u>'-25.0'4.5</u>'

PED. LIGHT

ROW ESMT

(CITY)

POLE (TYP)

SIDEWALK

ESMT

(CITY)

35.0'

-BLDG TO

CL (NE)

-EXIST. POWER POLE

TO BE SHIFTED

11.3' SOUTH

TO BE

-EXIST. OVERHEAD 문 POWER LINES

UNDERGROUNDED

* STRUCTURAL SOIL WILL BE PROVIDED AS APPLICABLE PER CITY OF FORT LAUDERDALE ULDR * STRUCTURAL SOIL AND PAVER GRATE DETAILS PROVIDED ON LANDSCAPE PLANS.

ROW LIGHTING EXISTING STREET LIGHT ALONG SE 3RD AVE TO REMAIN

UNTIL COORDINATION OF RELOCATION/REMOVAL HAS BEEN APPROVED BY FORT LAUDERDALE FACILITY MANAGER.

ON-STREET PKG:

NONE OF THE ON-STREET SPACES ARE RESERVED FOR THE DEVELOPMENT AND MAY BE USED BY ANY MEMBER OF THE PUBLIC. ON-STREET SPACES WILL NOT COUNT TOWARDS THE PARKING REQUIREMENTS FOR THE PROJECT; THE SPACES MAY BE REMOVED AT ANY TIME FOR ANY REASON AND THE CITY OF FORT LAUDERDALE WILL NOT RELOCATE DISPLACED ON-STREET PARKING.

1"=20' 08/19/25

23-1783.00 08/19/25

Drawn by

SROD

Appr. by

Plot Date

GENERAL BUILDING HEIGHTS AND AREAS (AS PER FBC 2023 TABLE 504.3, TABLE 504.4, TABLE 506.2)							
BUILDING TYPE TYPE IA	ALLOWABLE AREAS	PROVIDED					
BUILDING HEIGHT	UL	291'-8"					
NUMBER OF STORIES	UL	28					
ALLOWABLE AREAS	UL	289,053 (GARAGE NIC)					

FIRE RESIS	FIRE RESISTANCE RATINGS						
(AS PER FBC 202	(AS PER FBC 2023 TABLES 601 AND 602)						
45	INC DEAMS CIDDEDS TOUSSE						

(101211100202	S TABLES OF TARE OUZ,	
PRIMARY STRUCTURAL FRAME	INC. BEAMS, GIRDERS, TRUSSES, SHEAR WALLS	3 HR
BEARING WALLS	EXTERIOR	3 HR
NON BEARING WALLS AND PARTITIONS	EXTERIOR	0 HR
NON BEARING WALLS AND PARTITIONS	INTERIOR	0 HR
FLOOR CONSTRUCTION		2 HR
ROOF CONSTRUCTION		1 1/2 HR

OCCUPANCY LOAD AND EGRESS CALCULATIONS

RKING	BUILDING OCCUPANCY RESIDENTIAL	CLASSIFICAT	ION	FBC 2023- 8th TABLE 1004.5		FFPCC 2023 8th EDITION TABLE 7.3.1.2		
- PA	ROOM NAME	USE GROUP	ROOM AREA	AREA PER OCCUPANT	OCC. LOAD	AREA PER OCCUPANT	OCC. LOAD	
LEVEL	PARKING GARAGE	S-2	24,194 SF	200 GROSS	121	300 GROSS	81	
2ND	TOTAL OCCUPANCY THIS FLOOR				121		81	

	BUILDING OCCUPANCY RESIDENTIAL	CLASSIFICAT	ION	FBC 2023- 8th EDITION TABLE 1004.5		FFPCC 2023 8th EDITION TABLE 7.3.1.2	
RKING 'H)	ROOM NAME	USE GROUP	ROOM AREA	AREA PER OCCUPANT	OCC. LOAD	AREA PER OCCUPANT	OCC. LOAD
PA -	PARKING GARAGE	S-2	24,169 SF	200 GROSS	121	300 GROSS	81
YPICAL (3RD	STORAGE	S-2	391 SF	300 GROSS	2	500 GROSS	1
-	TOTAL OCCUPANCY THIS FLOOR				123		82

	BUILDING OCCUPANCY RESIDENTIAL	FBC 2023- 8th TABLE 1004.5		FFPCC 2023 8th EDITION TABLE 7.3.1.2			
PARKING	ROOM NAME	USE GROUP	ROOM AREA	AREA PER OCCUPANT	OCC. LOAD	AREA PER OCCUPANT	OCC. LOAD
	PARKING GARAGE	S-2	20,314 SF	200 GROSS	102	300 GROSS	68
LEVEL	STORAGE	S-2	391 SF	300 GROSS	2	500 GROSS	1
7TH	POOL EQUIPMENT/ ST.	S-2	3,858 SF	300 GROSS	13	500 GROSS	8
	TOTAL OCCUPANCY THIS FLOOR				117		77

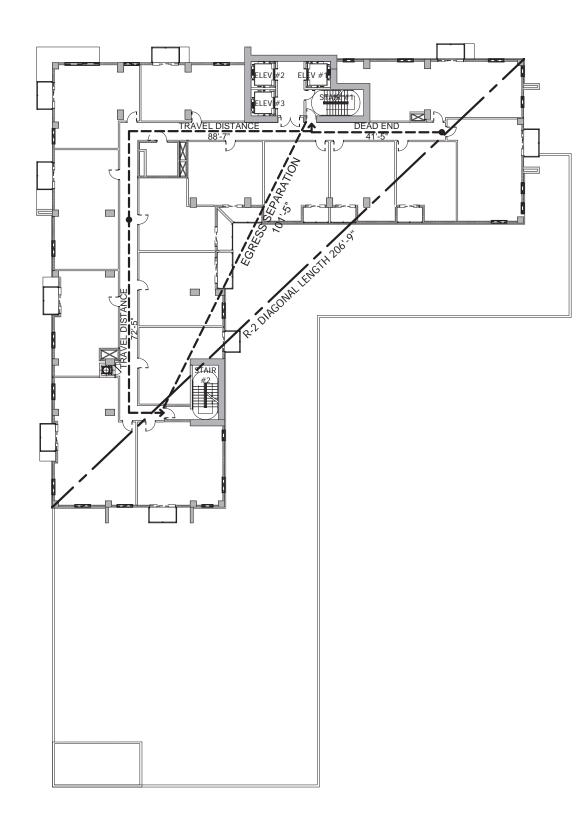
	BUILDING OCCUPANCY RESIDENTIAL	CLASSIFICA	TION		FBC 2023- 8th EDITION TABLE 1004.5		FFPCC 2023 8th EDITIC TABLE 7.3.1.2	
	ROOM NAME	USE GROUP	ROOM AREA	AREA PER OCCUPANT	OCC. LOAD	AREA PER OCCUPANT	OCC. LOAD	
	CLUB ROOM	A-3	1,596 SF	15 NET	106	15 NET	106	
	CLUB ROOM DECK	A-3	319 SF	15 NET	21	15 NET	21	
	OPEN LOUNGE	A-3	1,433 SF	15 NET	96	15 NET	96	
œ	GYM, YOGA	A-3	2,285 SF	50 GROSS	46	50 GROSS	46	
AMENITY FLOOR (8TH LEVEL)	GYM, YOGA DECK	A-3	896 SF	50 GROSS	18	50 GROSS	18	
(8TH LEVEL)	SUNDRY MARKET	В	212 SF	150 GROSS	2	150 GROSS	2	
AME (8	CO-WORK	В	2,638 SF	150 GROSS	17	150 GROSS	17	
	CO-WORK DECK	В	2,207 SF	150 GROSS	15	150 GROSS	15	
	POOL	A-3	1,567 SF	50 GROSS	31	50 GROSS	31	
	POOL DECK	A-3	2,455 SF	15 GROSS	164	30 GROSS	82	
	POOL DECK LOUNGE	A-3			46 SEAT		46 SEA	
	AMENITY DECK	A-3	1,691 SF	15 NET	113	15 NET	113	
	MECH. EQ./ TRASH	S-2	243 SF	300 GROSS	1	500 GROSS	1	
	TOTAL OCCUPANCY TH	HIS FLOOR			676		594	

	BUILDING OCCUPANCY RESIDENTIAL	FBC 2023- 8th EDITION TABLE 1004.5		FFPCC 2023 8th EDITION TABLE 7.3.1.2			
S	KESIDENTIAL			TABLE 1004.	,	TABLE 7.3.1.	
EVELS	ROOM NAME	USE	ROOM	AREA PER	OCC.	AREA PER	OCC.
É _		GROUP	AREA	OCCUPANT	LOAD	OCCUPANT	LOAD
UPPER LE H- 25TH)	RESIDENTIAL	R-2	10,135 SF	200 GROSS	51	200 GROSS	51
	R. TERRACE/BALCONY	R-2	728 SF	200 GROSS	4	200 GROSS	4
TYPICAL (9T	MECH. EQ./ TRASH	S-2	243 SF	300 GROSS	1	500 GROSS	1
	TOTAL OCCUPANCY THI			56		56	

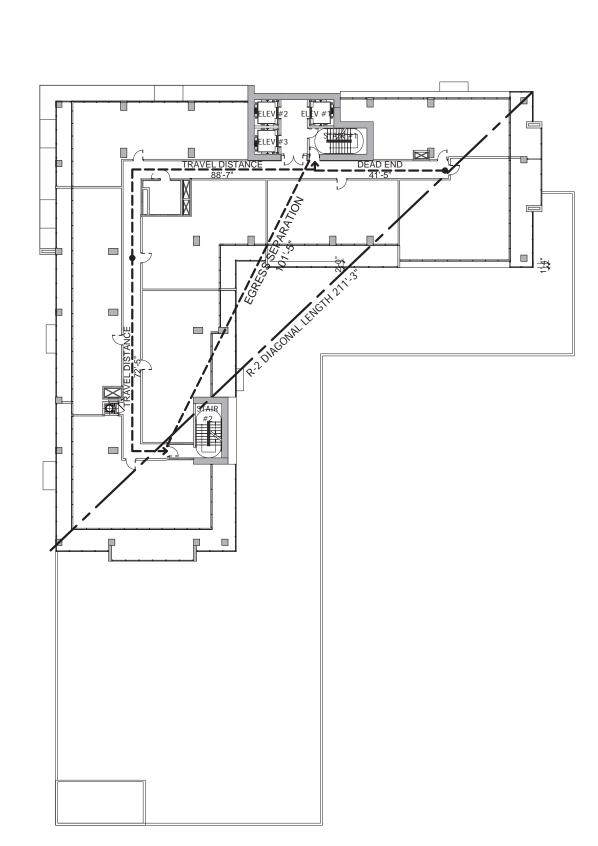
	BUILDING OCCUPANCY CLASSIFICATION RESIDENTIAL			FBC 2023- 8th EDITION TABLE 1004.5		FFPCC 2023 8th EDITION TABLE 7.3.1.2	
EVEL	ROOM NAME	USE GROUP	ROOM AREA	AREA PER OCCUPANT	OCC. LOAD	AREA PER OCCUPANT	OCC. LOAD
지원 (된	RESIDENTIAL	R-2	8,654 SF	200 GROSS	44	200 GROSS	44
ITHOU (26)	R. TERRACE/BALCONY	R-2	2,709 SF	200 GROSS	14	200 GROSS	14
PENTH	MECH. EQ./ TRASH	S-2	243 SF	300 GROSS	1	500 GROSS	1
	TOTAL OCCUPANCY TH	IS FLOOR			59		59

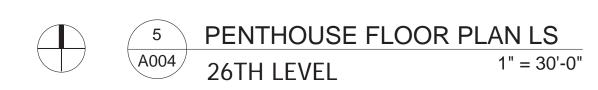
TYPICAL LOWER FLOORS (2ND - 8TH)									
		EGRESS	CALCULATIONS						
	(NFPA 1	101 - FFPC 8 ⁻	TH EDITION TABLE 7.3.3.2))					
	WIDTH	WIDTH	OCCUPANT LOAD	OCCUPANT LOAD					
	REQUIRED	PROVIDED	FBC 1005	FFPC 7.3.3.2					
EGRESS DOOR WIDTH	32"	34"	34/0.15 = 227 PERSONS	34/0.20 = 170 PERSONS					
EGRESS CORRIDOR WIDTH	44"	66"	66/0.15 = 440 PERSONS	66/0.20 = 330 PERSONS					
STAIRWAY #1 WIDTH	44"	48"	48/0.20 = 240 PERSONS	146.7+(48-44/0.218)=165 PER.					
STAIRWAY #2 WIDTH	44"	48"	48/0.20 = 240 PERSONS	146.7+(48-44/0.218)=165 PER.					
STAIRWAY #3 WIDTH	44"	72"	72/0.20 = 360 PERSONS	146.7+(72-44/0.218)=275 PER.					
TOTAL LOAD CAPACITY			840 PERSONS	605 PERSONS					

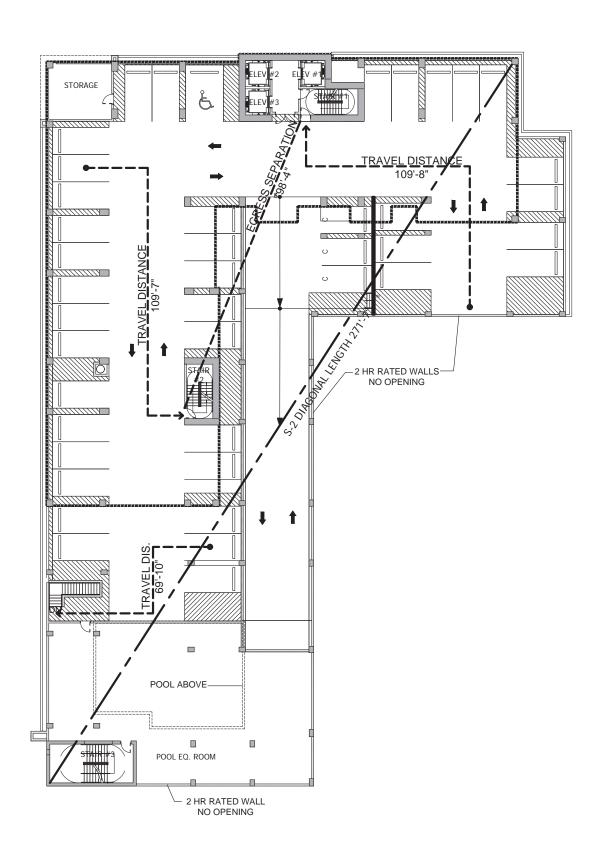
	Т	YPICAL UPPE	ER FLOORS (9TH - 26TH)	
		EGRESS	CALCULATIONS	
	(NFPA 1	101 - FFPC 8	TH EDITION TABLE 7.3.3.2))
	WIDTH	WIDTH	OCCUPANT LOAD	OCCUPANT LOAD
	REQUIRED	PROVIDED	FBC 1005	FFPC 7.3.1.2
EGRESS DOOR WIDTH	32"	34"	34/0.15 = 227 PERSONS	34/0.20 = 170 PERSONS
EGRESS CORRIDOR WIDTH	44"	66"	66/0.15 = 440 PERSONS	66/0.20 = 330 PERSONS
STAIRWAY #1 WIDTH	44"	48"	48/0.20 = 240 PERSONS	146.7+(48-44/0.218)=165 PER.
STAIRWAY #2 WIDTH	44"	48"	48/0.20 = 240 PERSONS	146.7+(48-44/0.218)=165 PER.
TOTAL LOAD CAPACITY			480 PERSONS	330 PERSONS

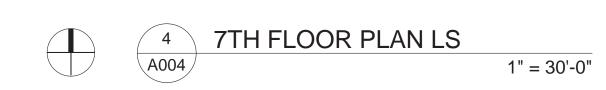


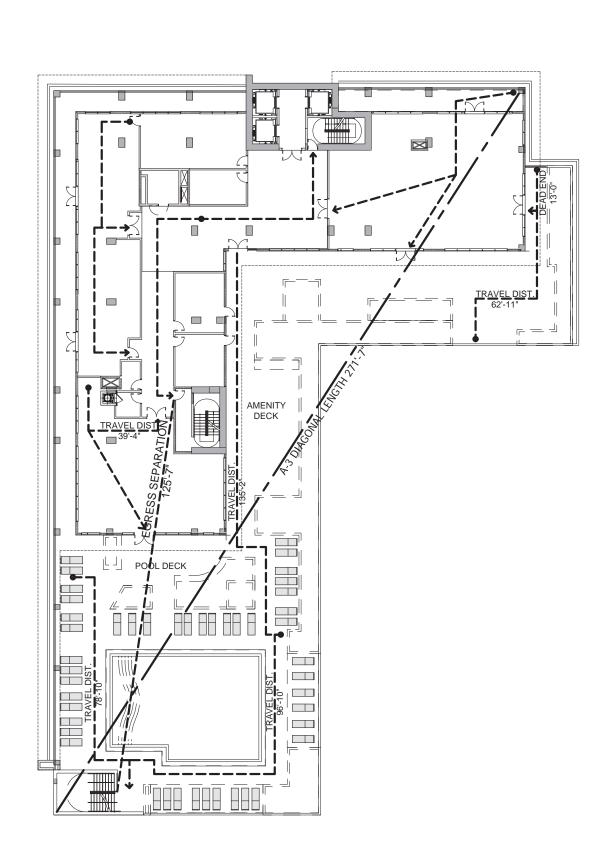




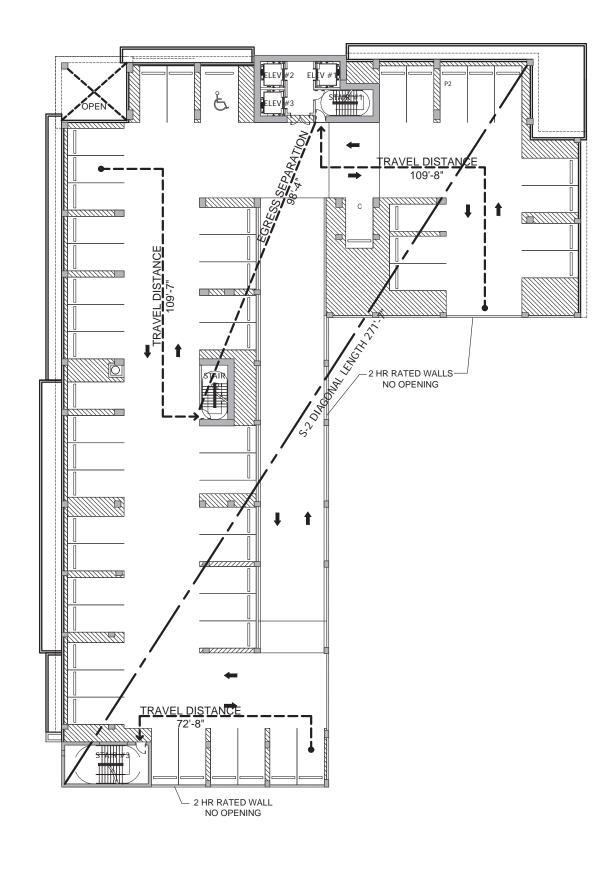




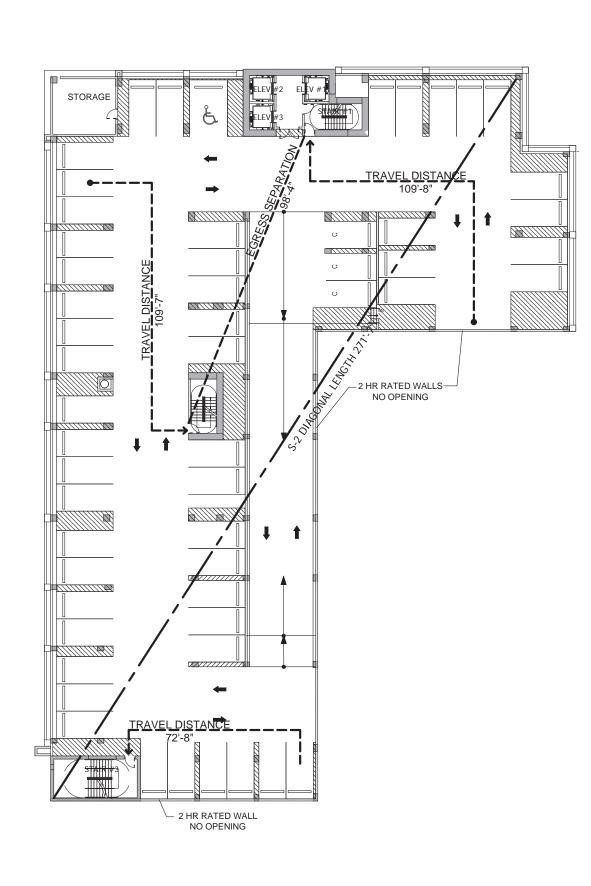













2	TYP. PARKING FLOO	OR PLAN LS
A004	3RD- 6TH LEVELS	1" = 30'-0"

VICTOR K. YUE AR 0013087

ICTOR K. YUE	AR 0013087
AR00130	087
Issue	Date

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ARTHAUS	FORT LAUDERDALE, FLORIDA ALL RIGHTS RESERVED
	Date: 06/16/2025
LIFE SAFETY PLANS	Checked:
SAFET	Drawn:
LIFE	b No.: /202334

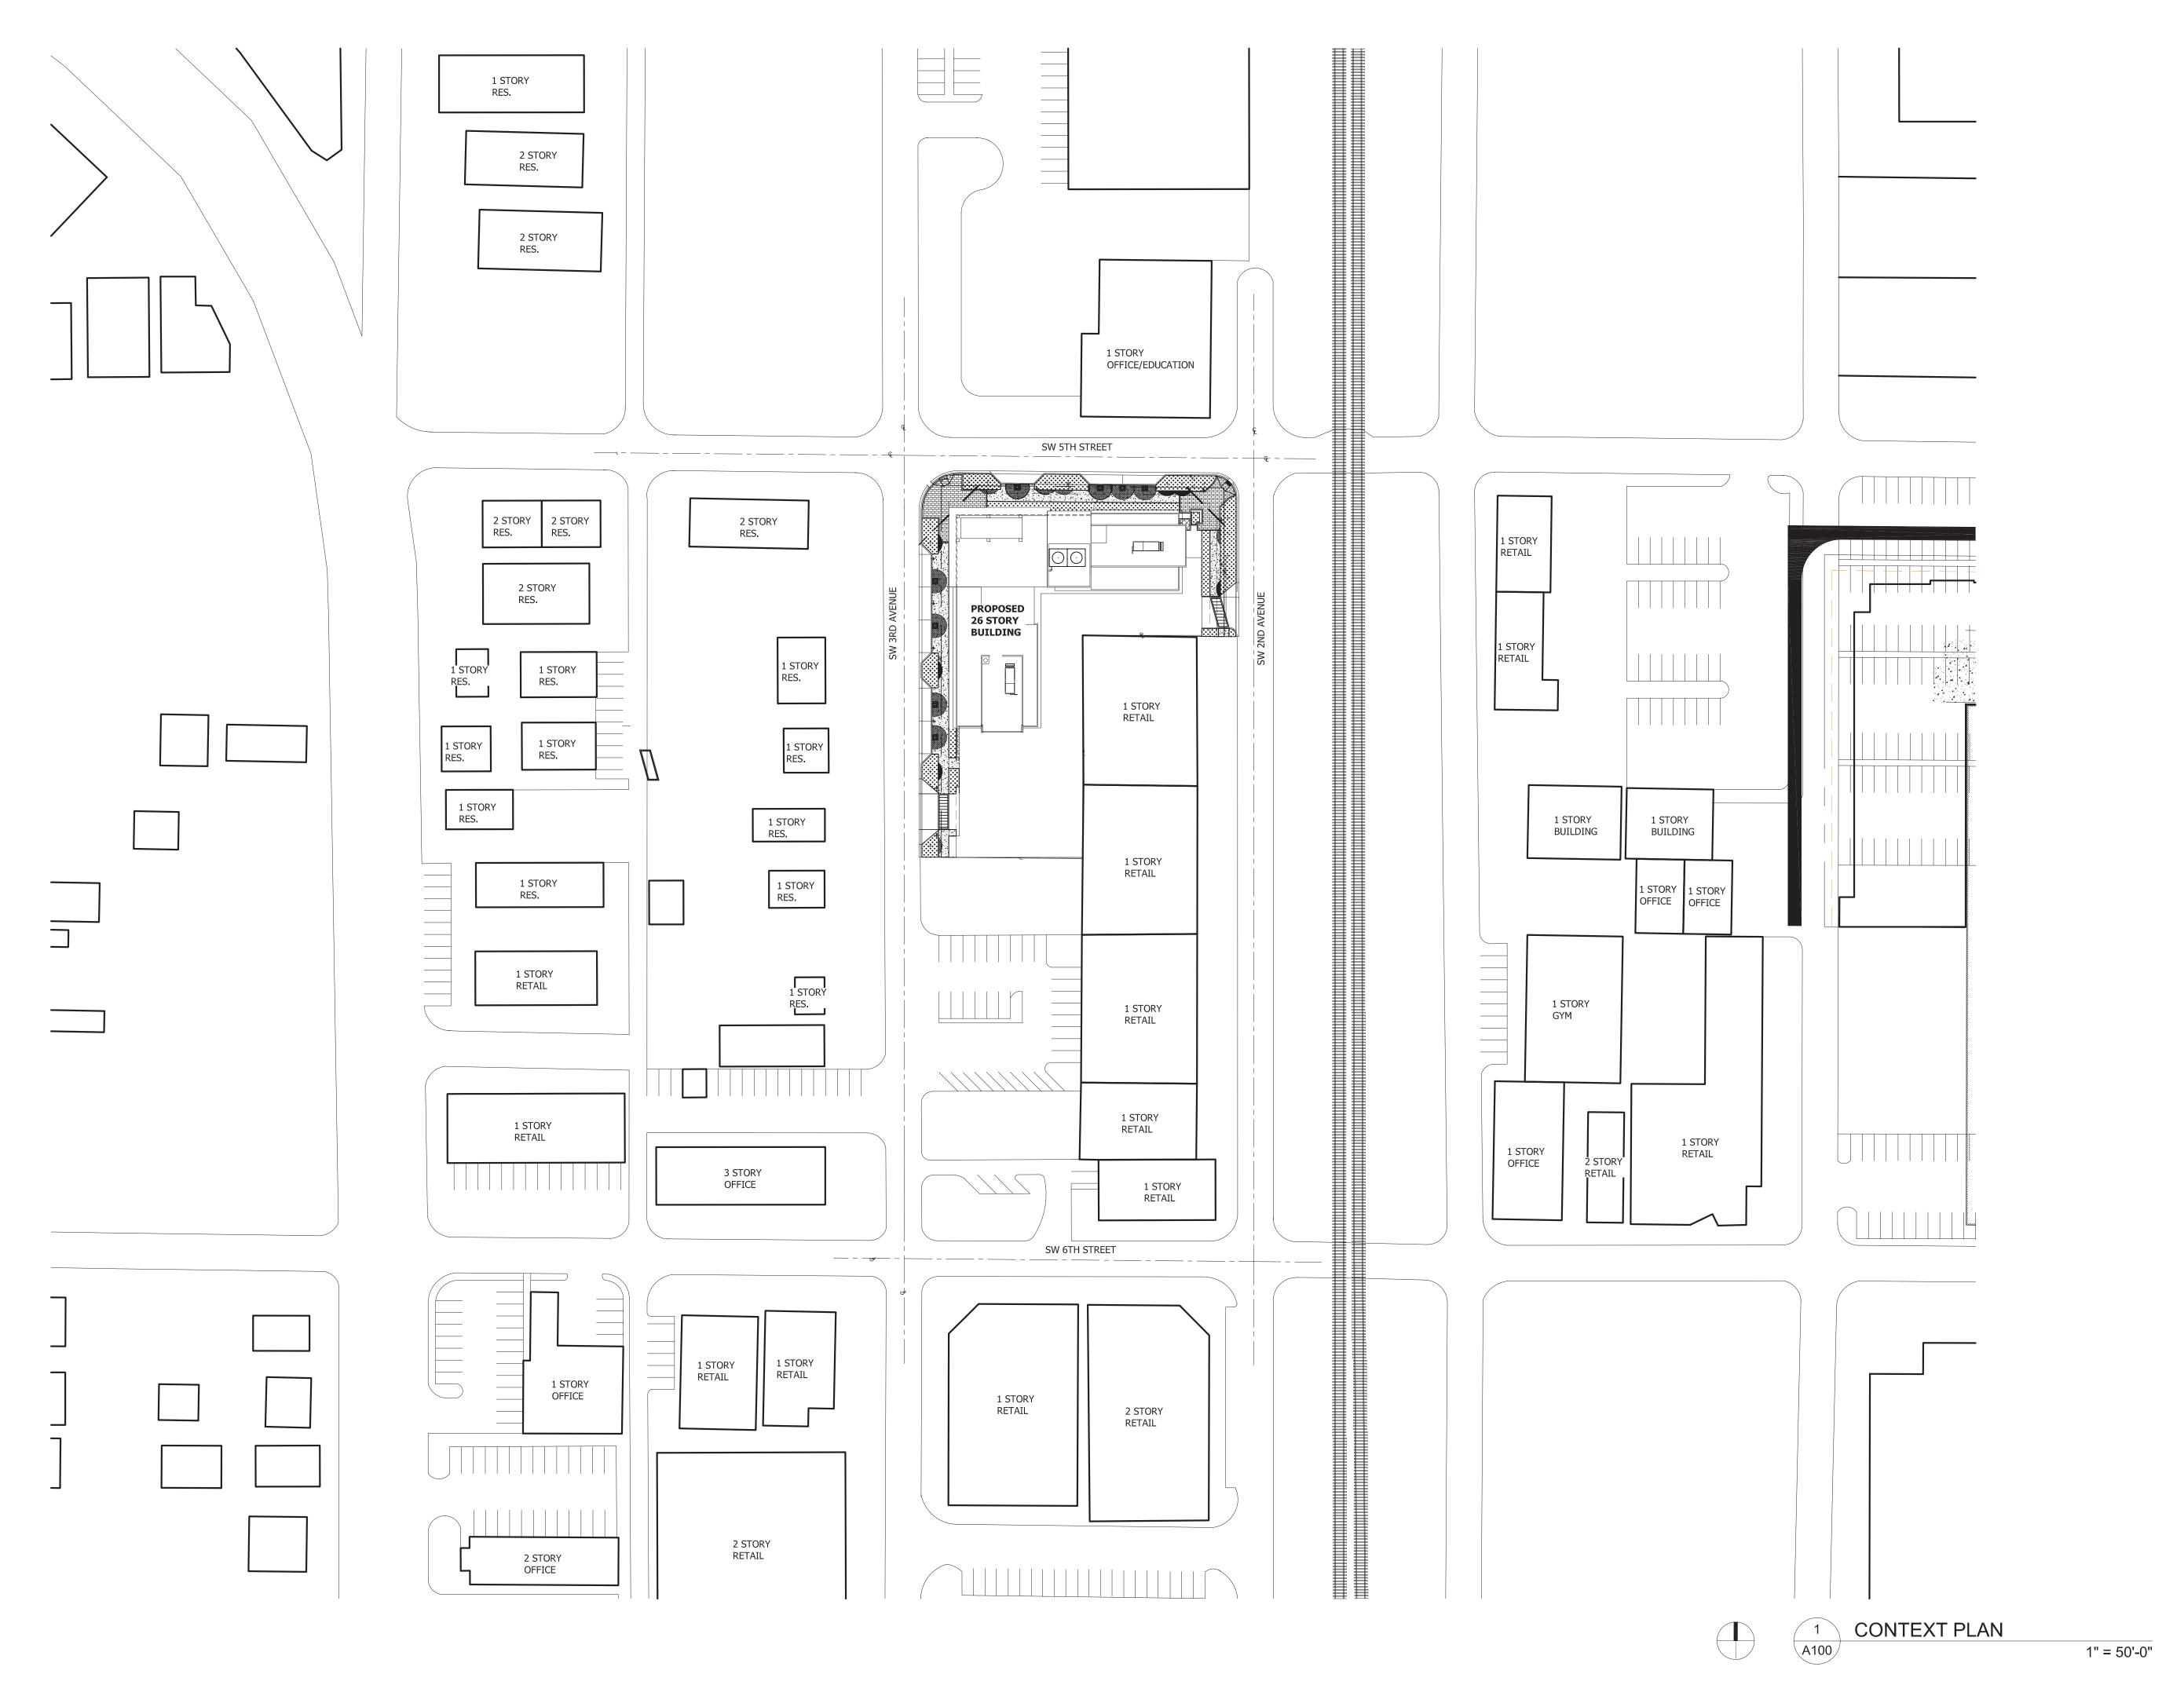

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AROO13087
No: Issue Date

ARTHAUS

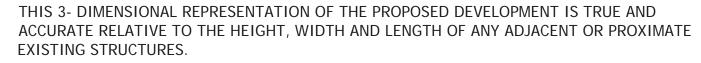
Date:

Col.16/2025

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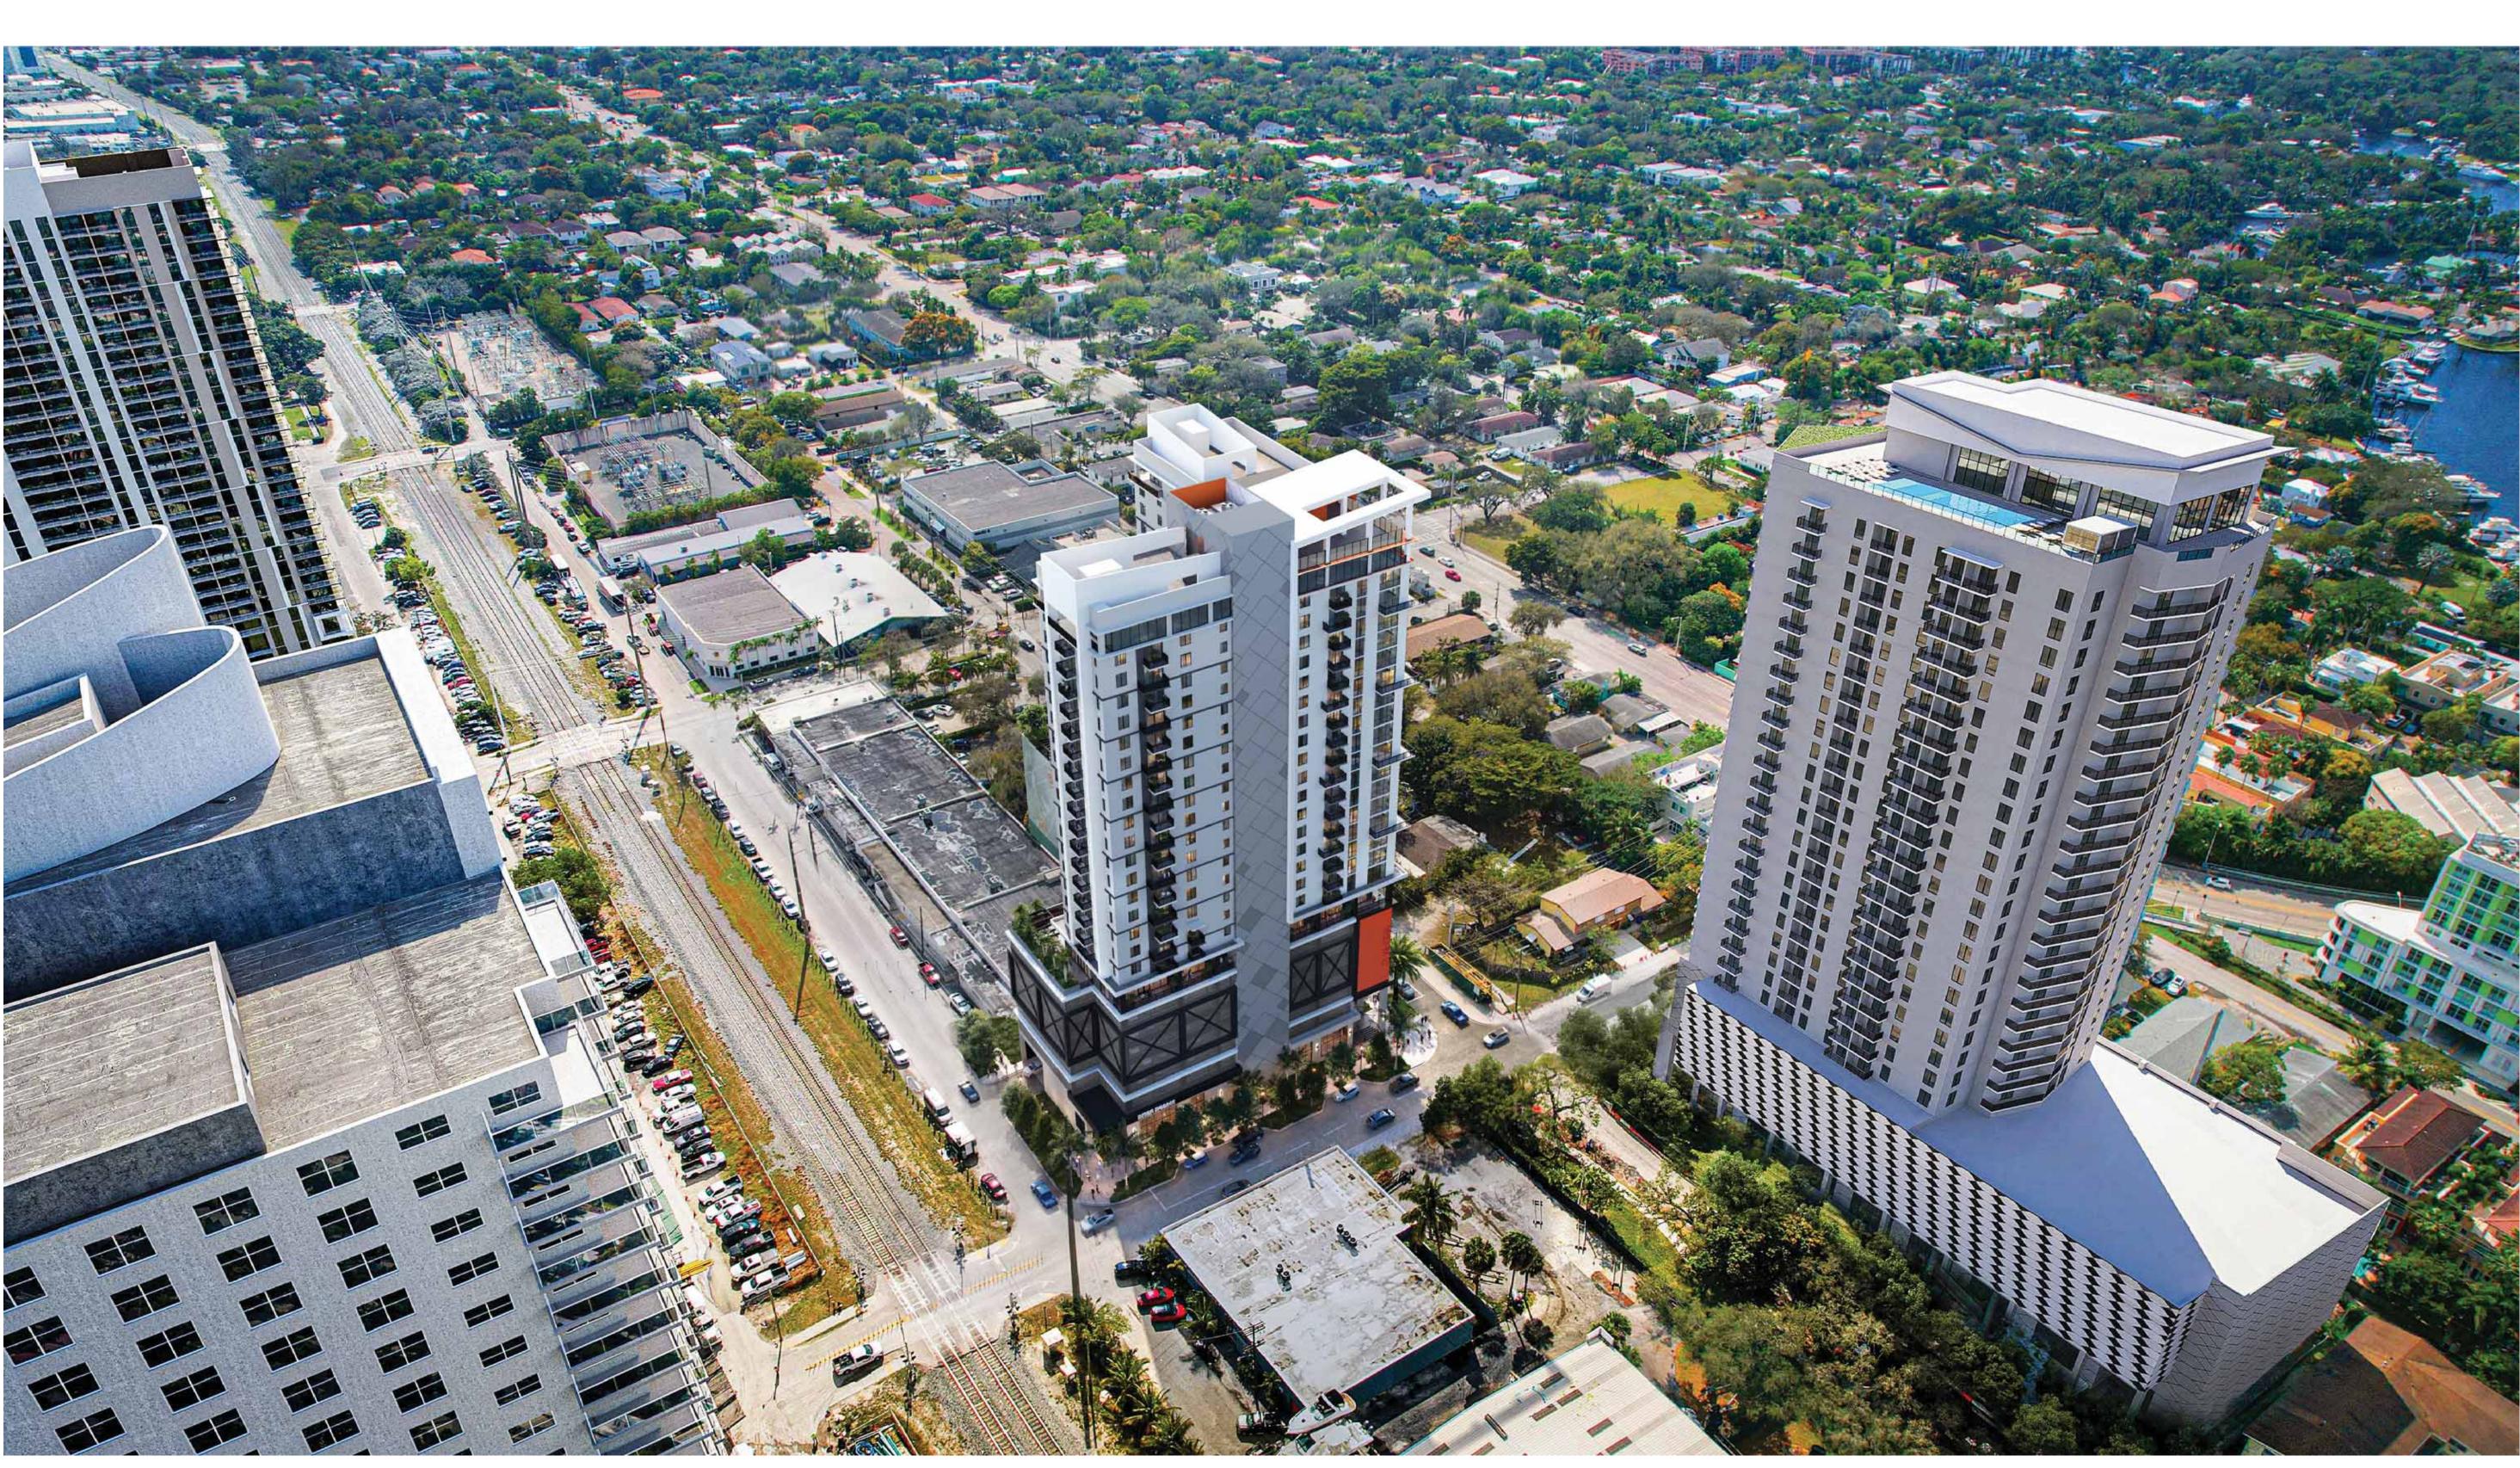
CONTEXT PLAN
Job No.: Drawn: Che








VICTOR K. YUE	AR 00130	187
AR00130)87 Date	
ARTHAUS	FORT LAUDERDALE, FLORIDA	ALL RIGHTS RESERVED
NW AERIAL RENDERING	Drawn: Checked:	DY 202334



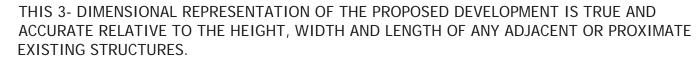








THIS 3- DIMENSIONAL REPRESENTATION OF THE PROPOSED DEVELOPMENT IS TRUE AND ACCURATE RELATIVE TO THE HEIGHT, WIDTH AND LENGTH OF ANY ADJACENT OR PROXIMATE EXISTING STRUCTURES.



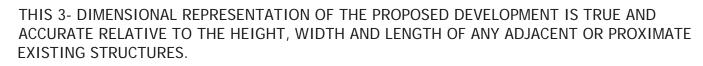VICTOR K. YUE AR 0013087 RENDERING

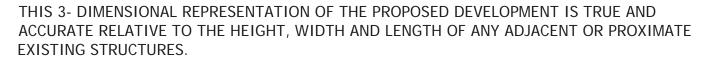
















RENDERING PERSPECTIVE




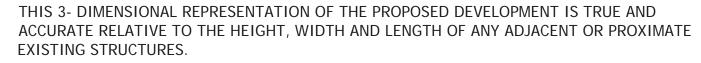

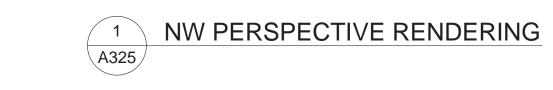


VICTOR K. YUE AROO13C No: Issue		
ARTHAUS	FORT LAUDERDALE, FLORIDA	ALL RIGHTS RESERVED
PERSPECTIVE RENDERING	Drawn: Checked: Date:	06/16/2025




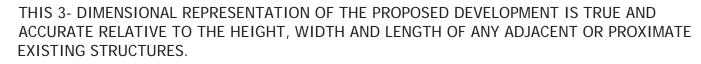





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ARTHAUS	FORT LAUDERDALE, FLORIDA ALL RIGHTS RESERVED
SPECTIVE RENDERING	Drawn: Checked: Date: 06/16/2025

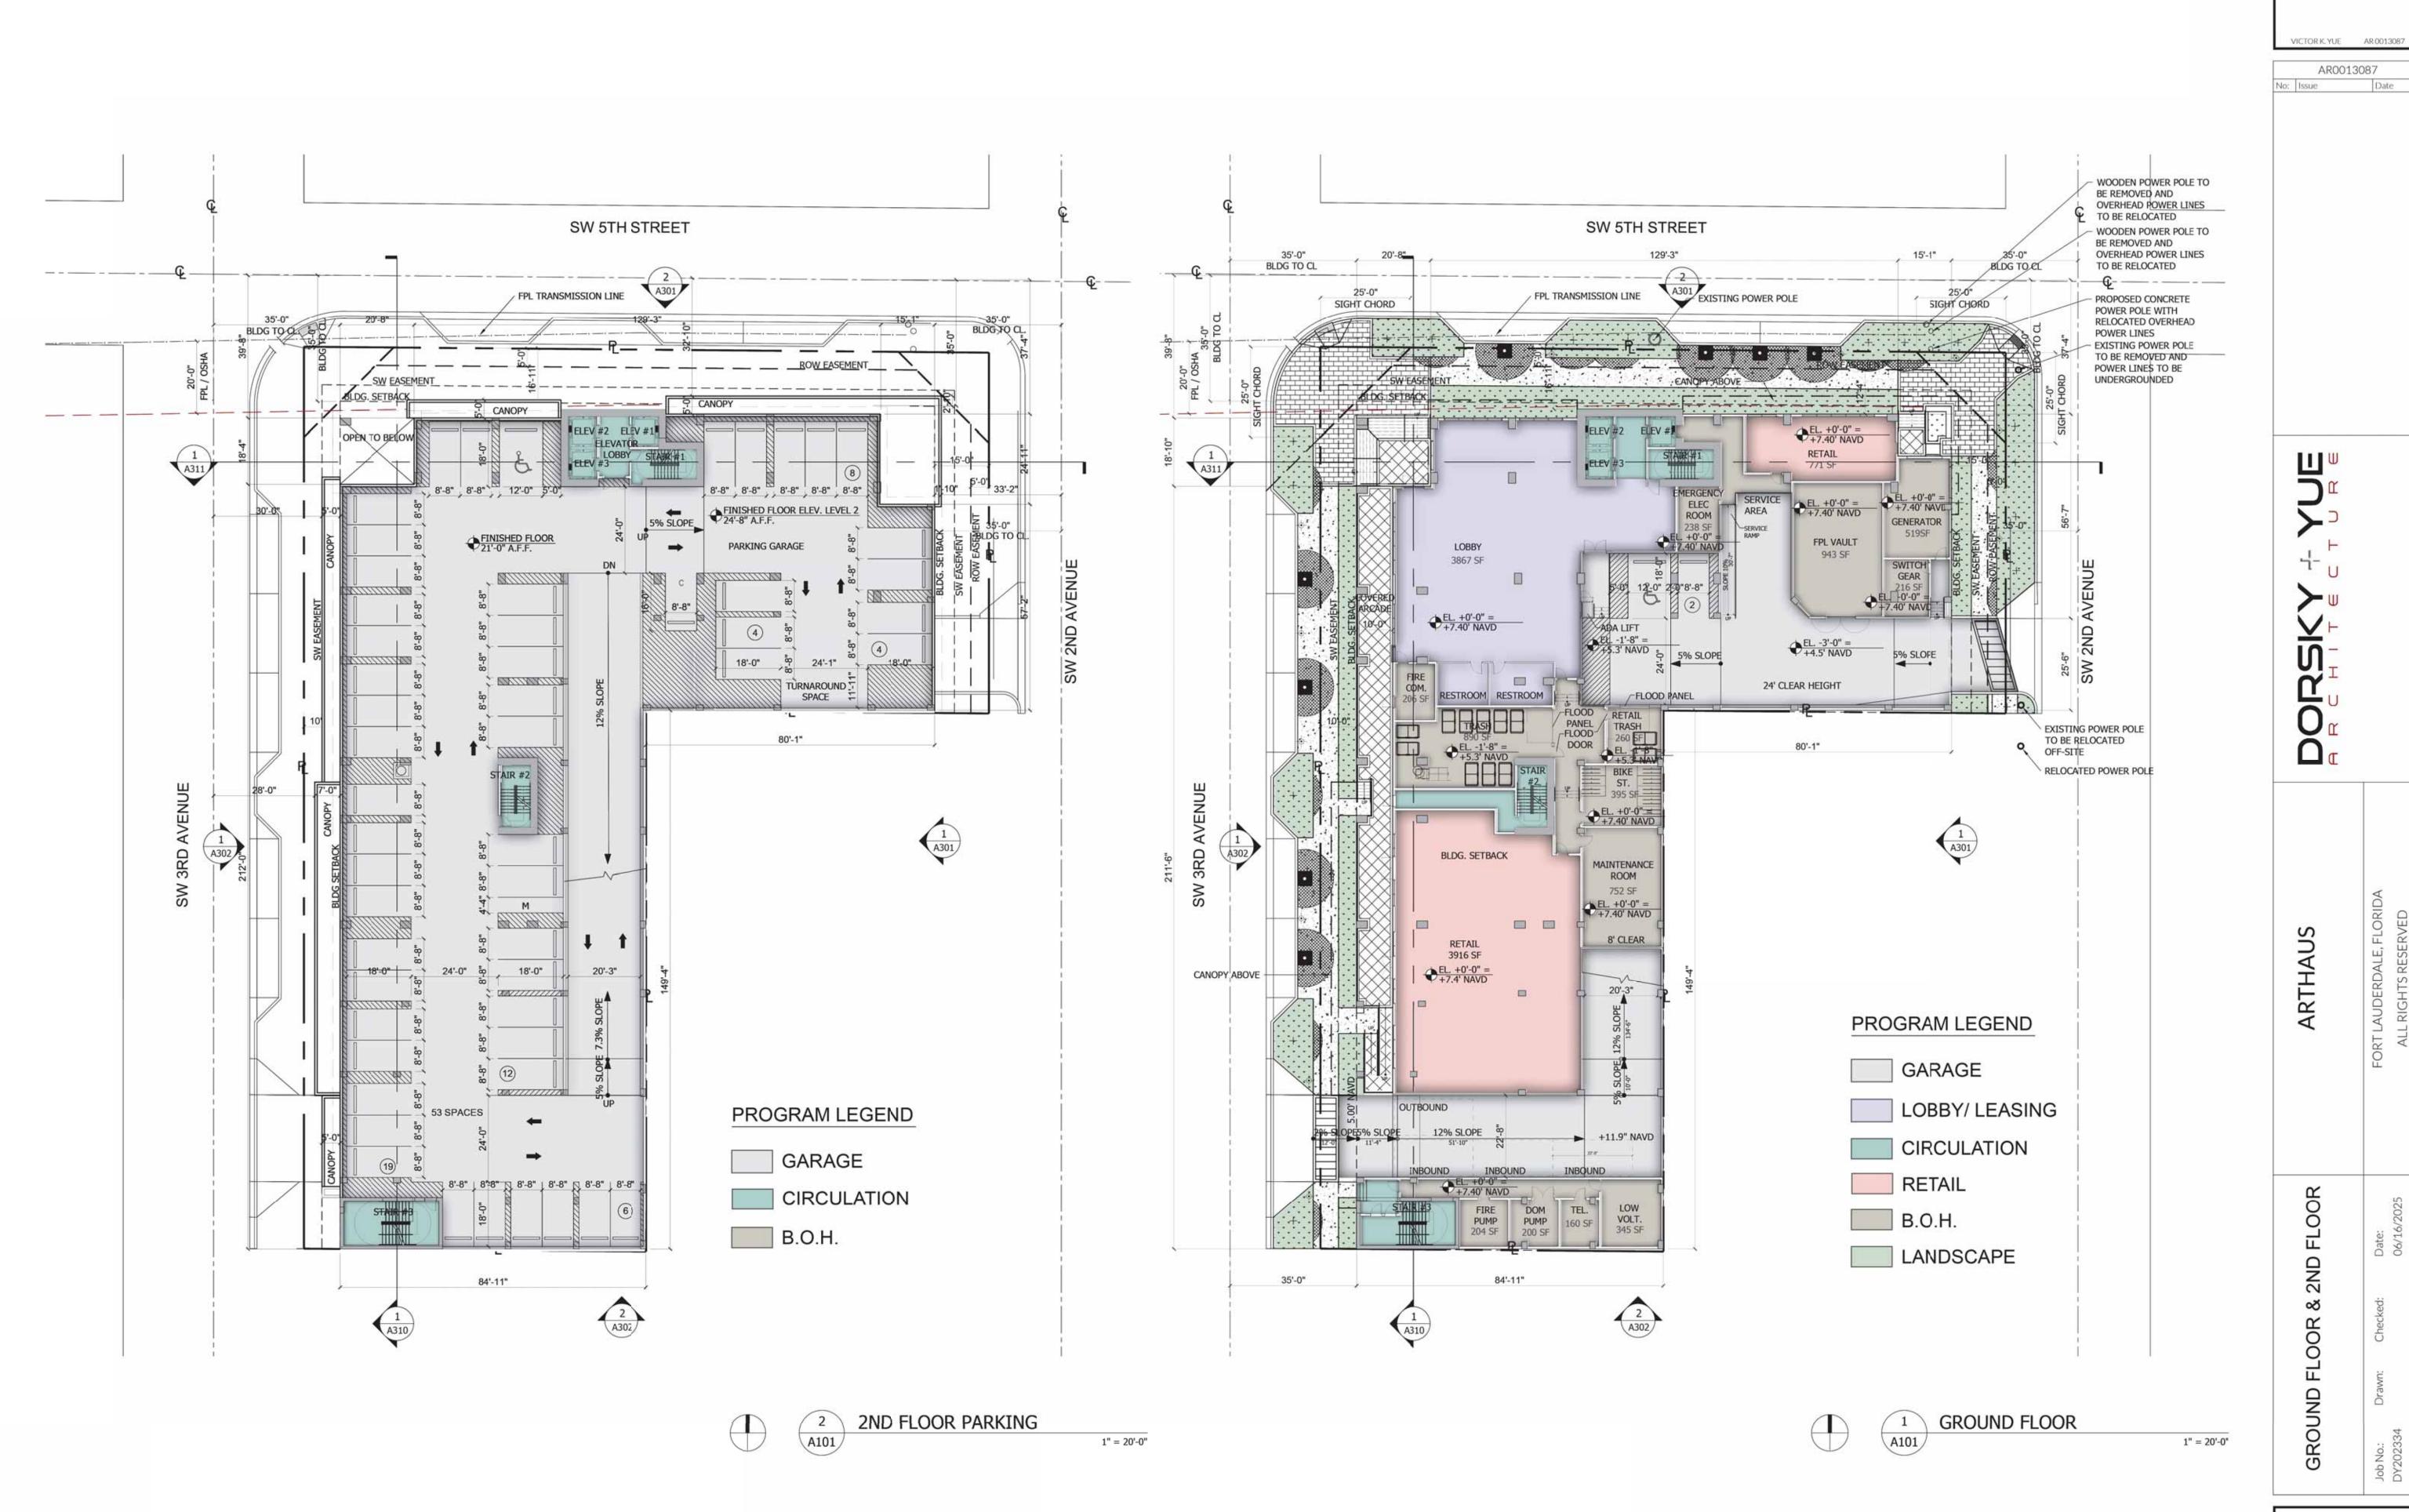

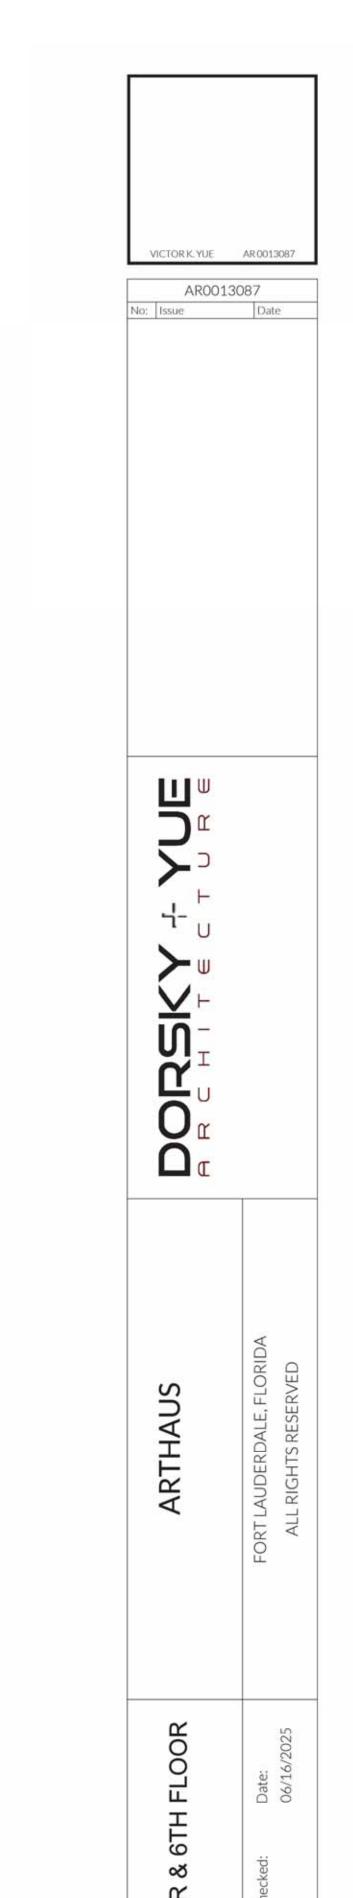

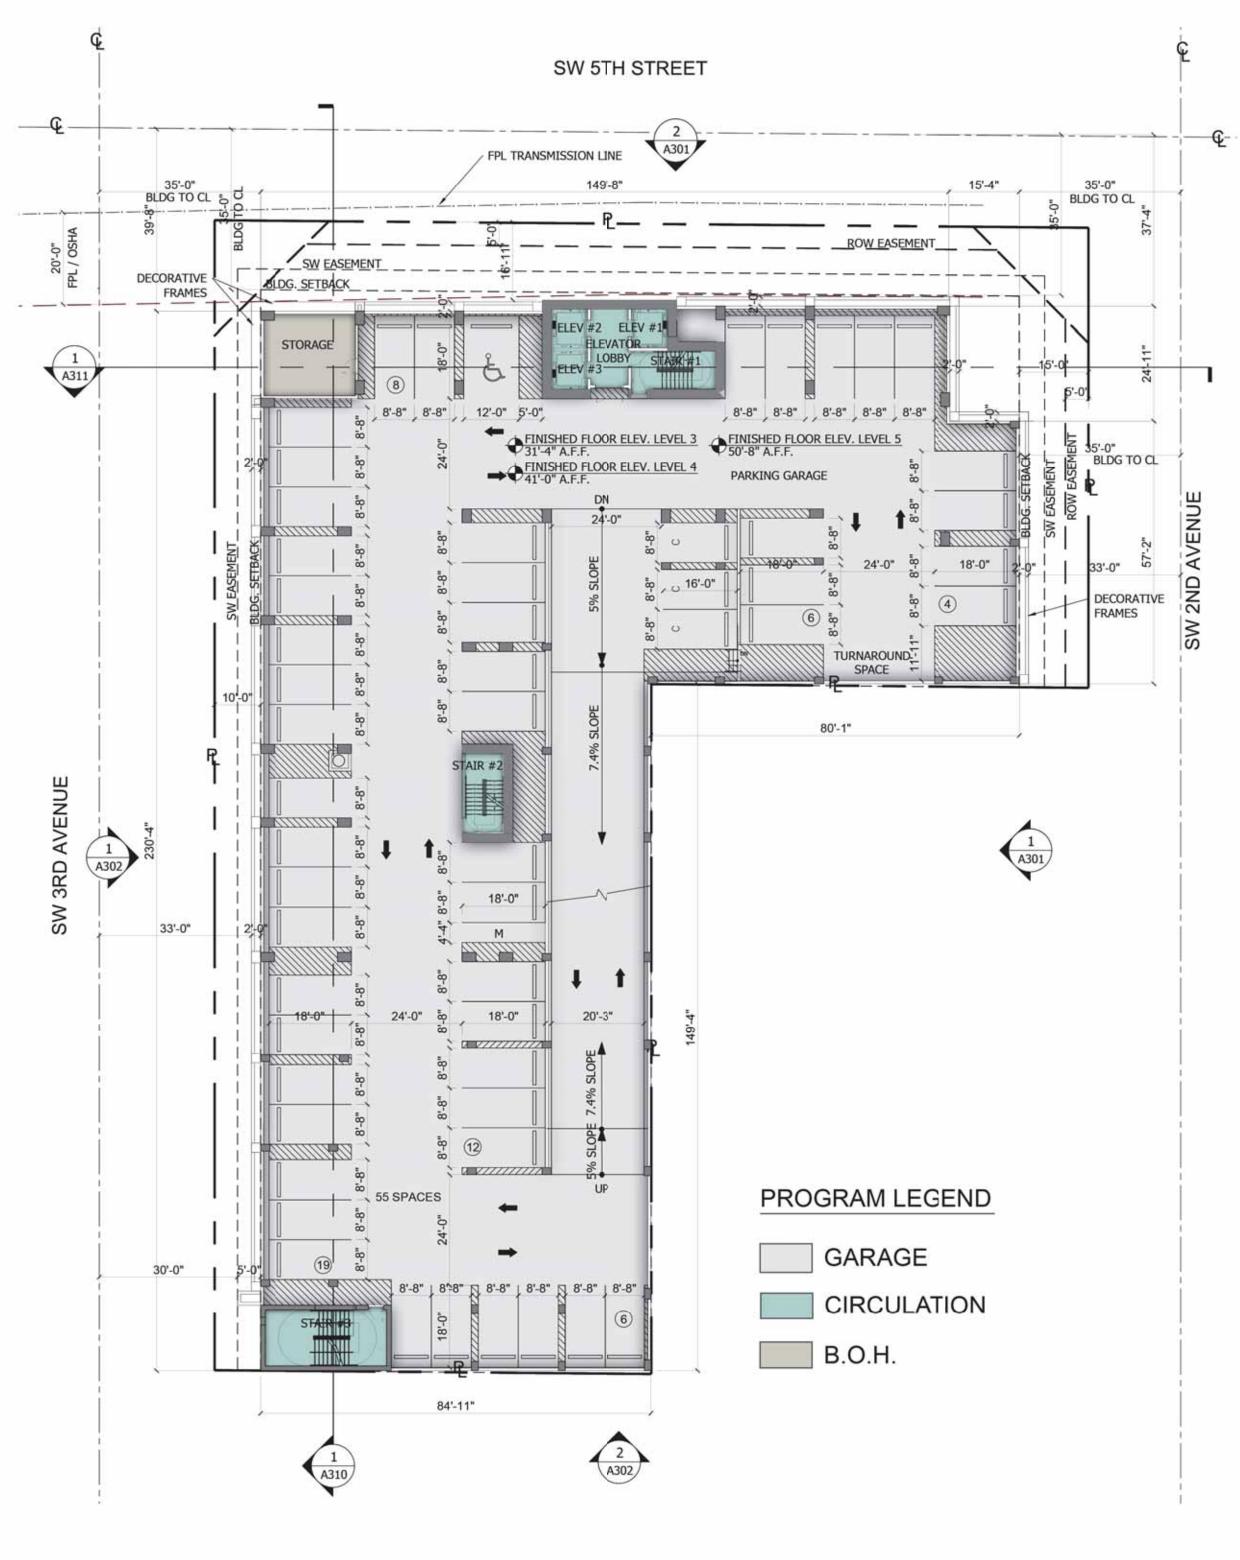

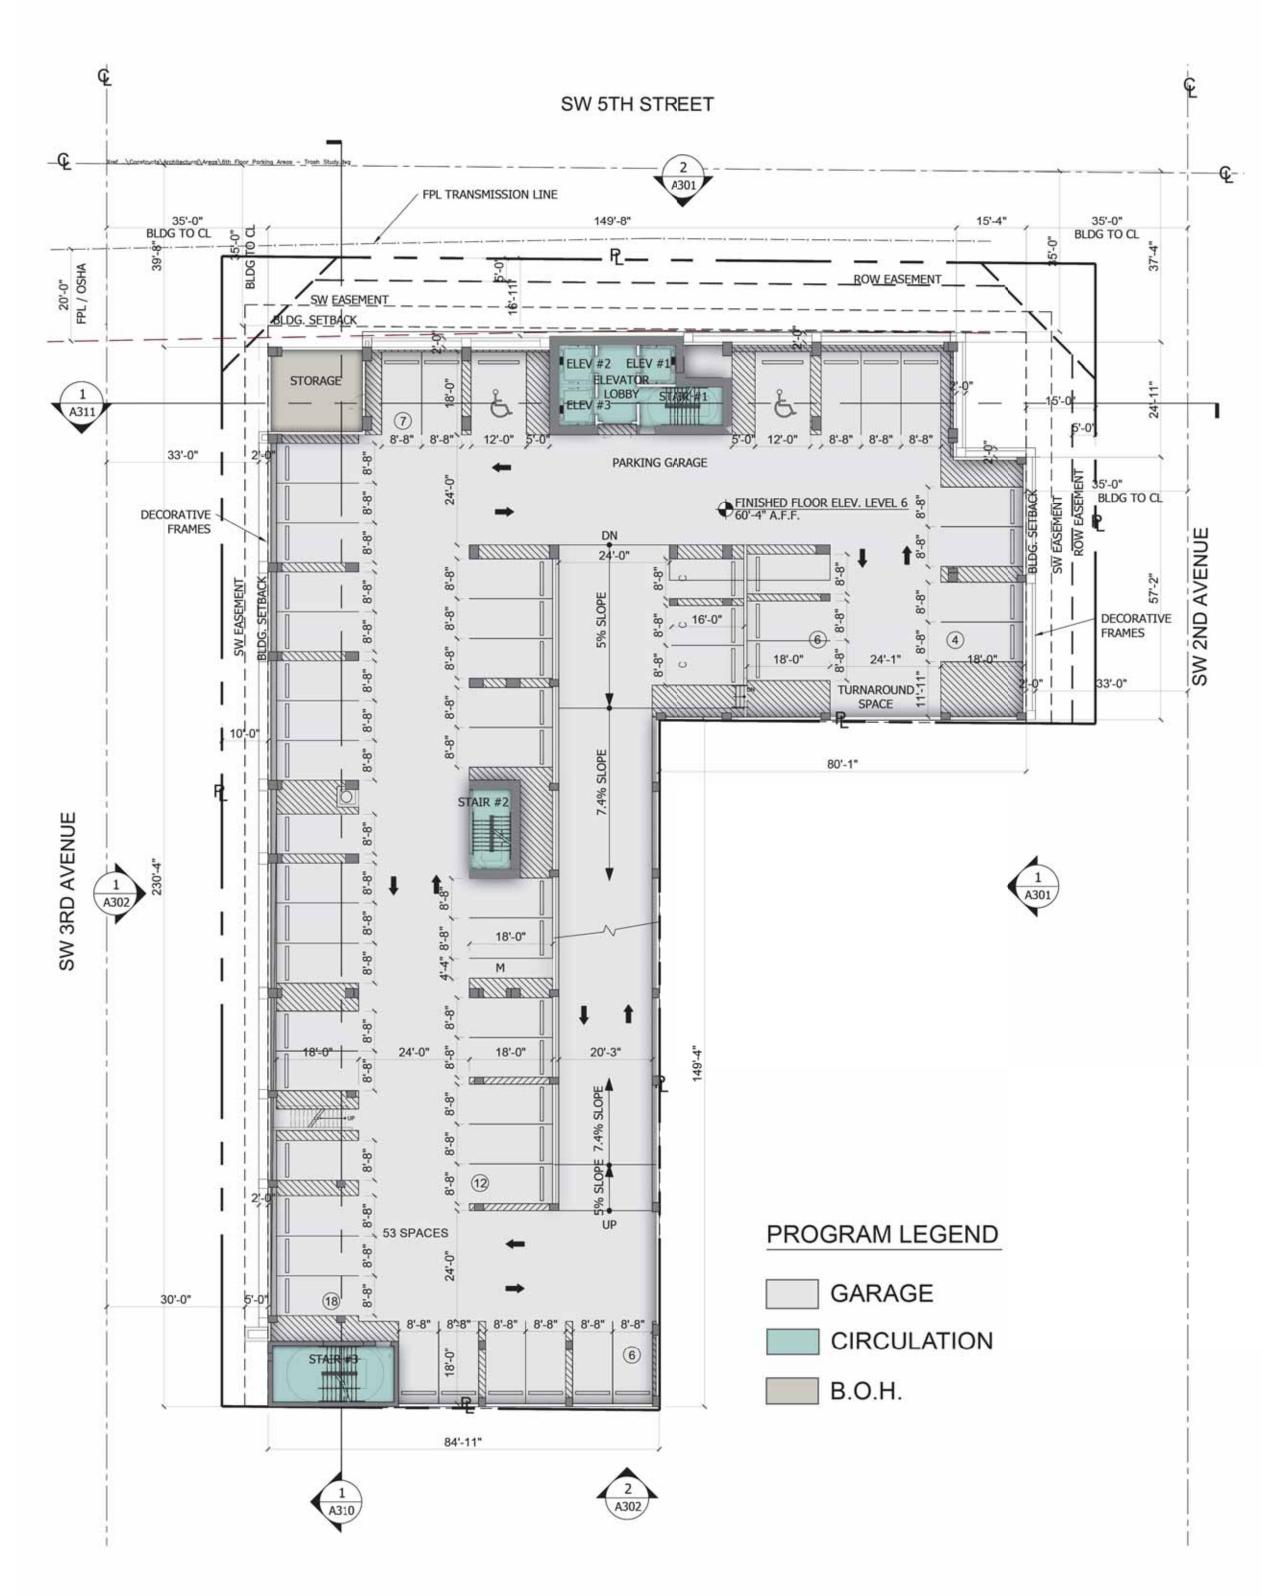


2 6TH FLOOR PARKING 1" = 20'-0"

1 3RD-5TH FLOOR PARKING 1" = 20'

A102

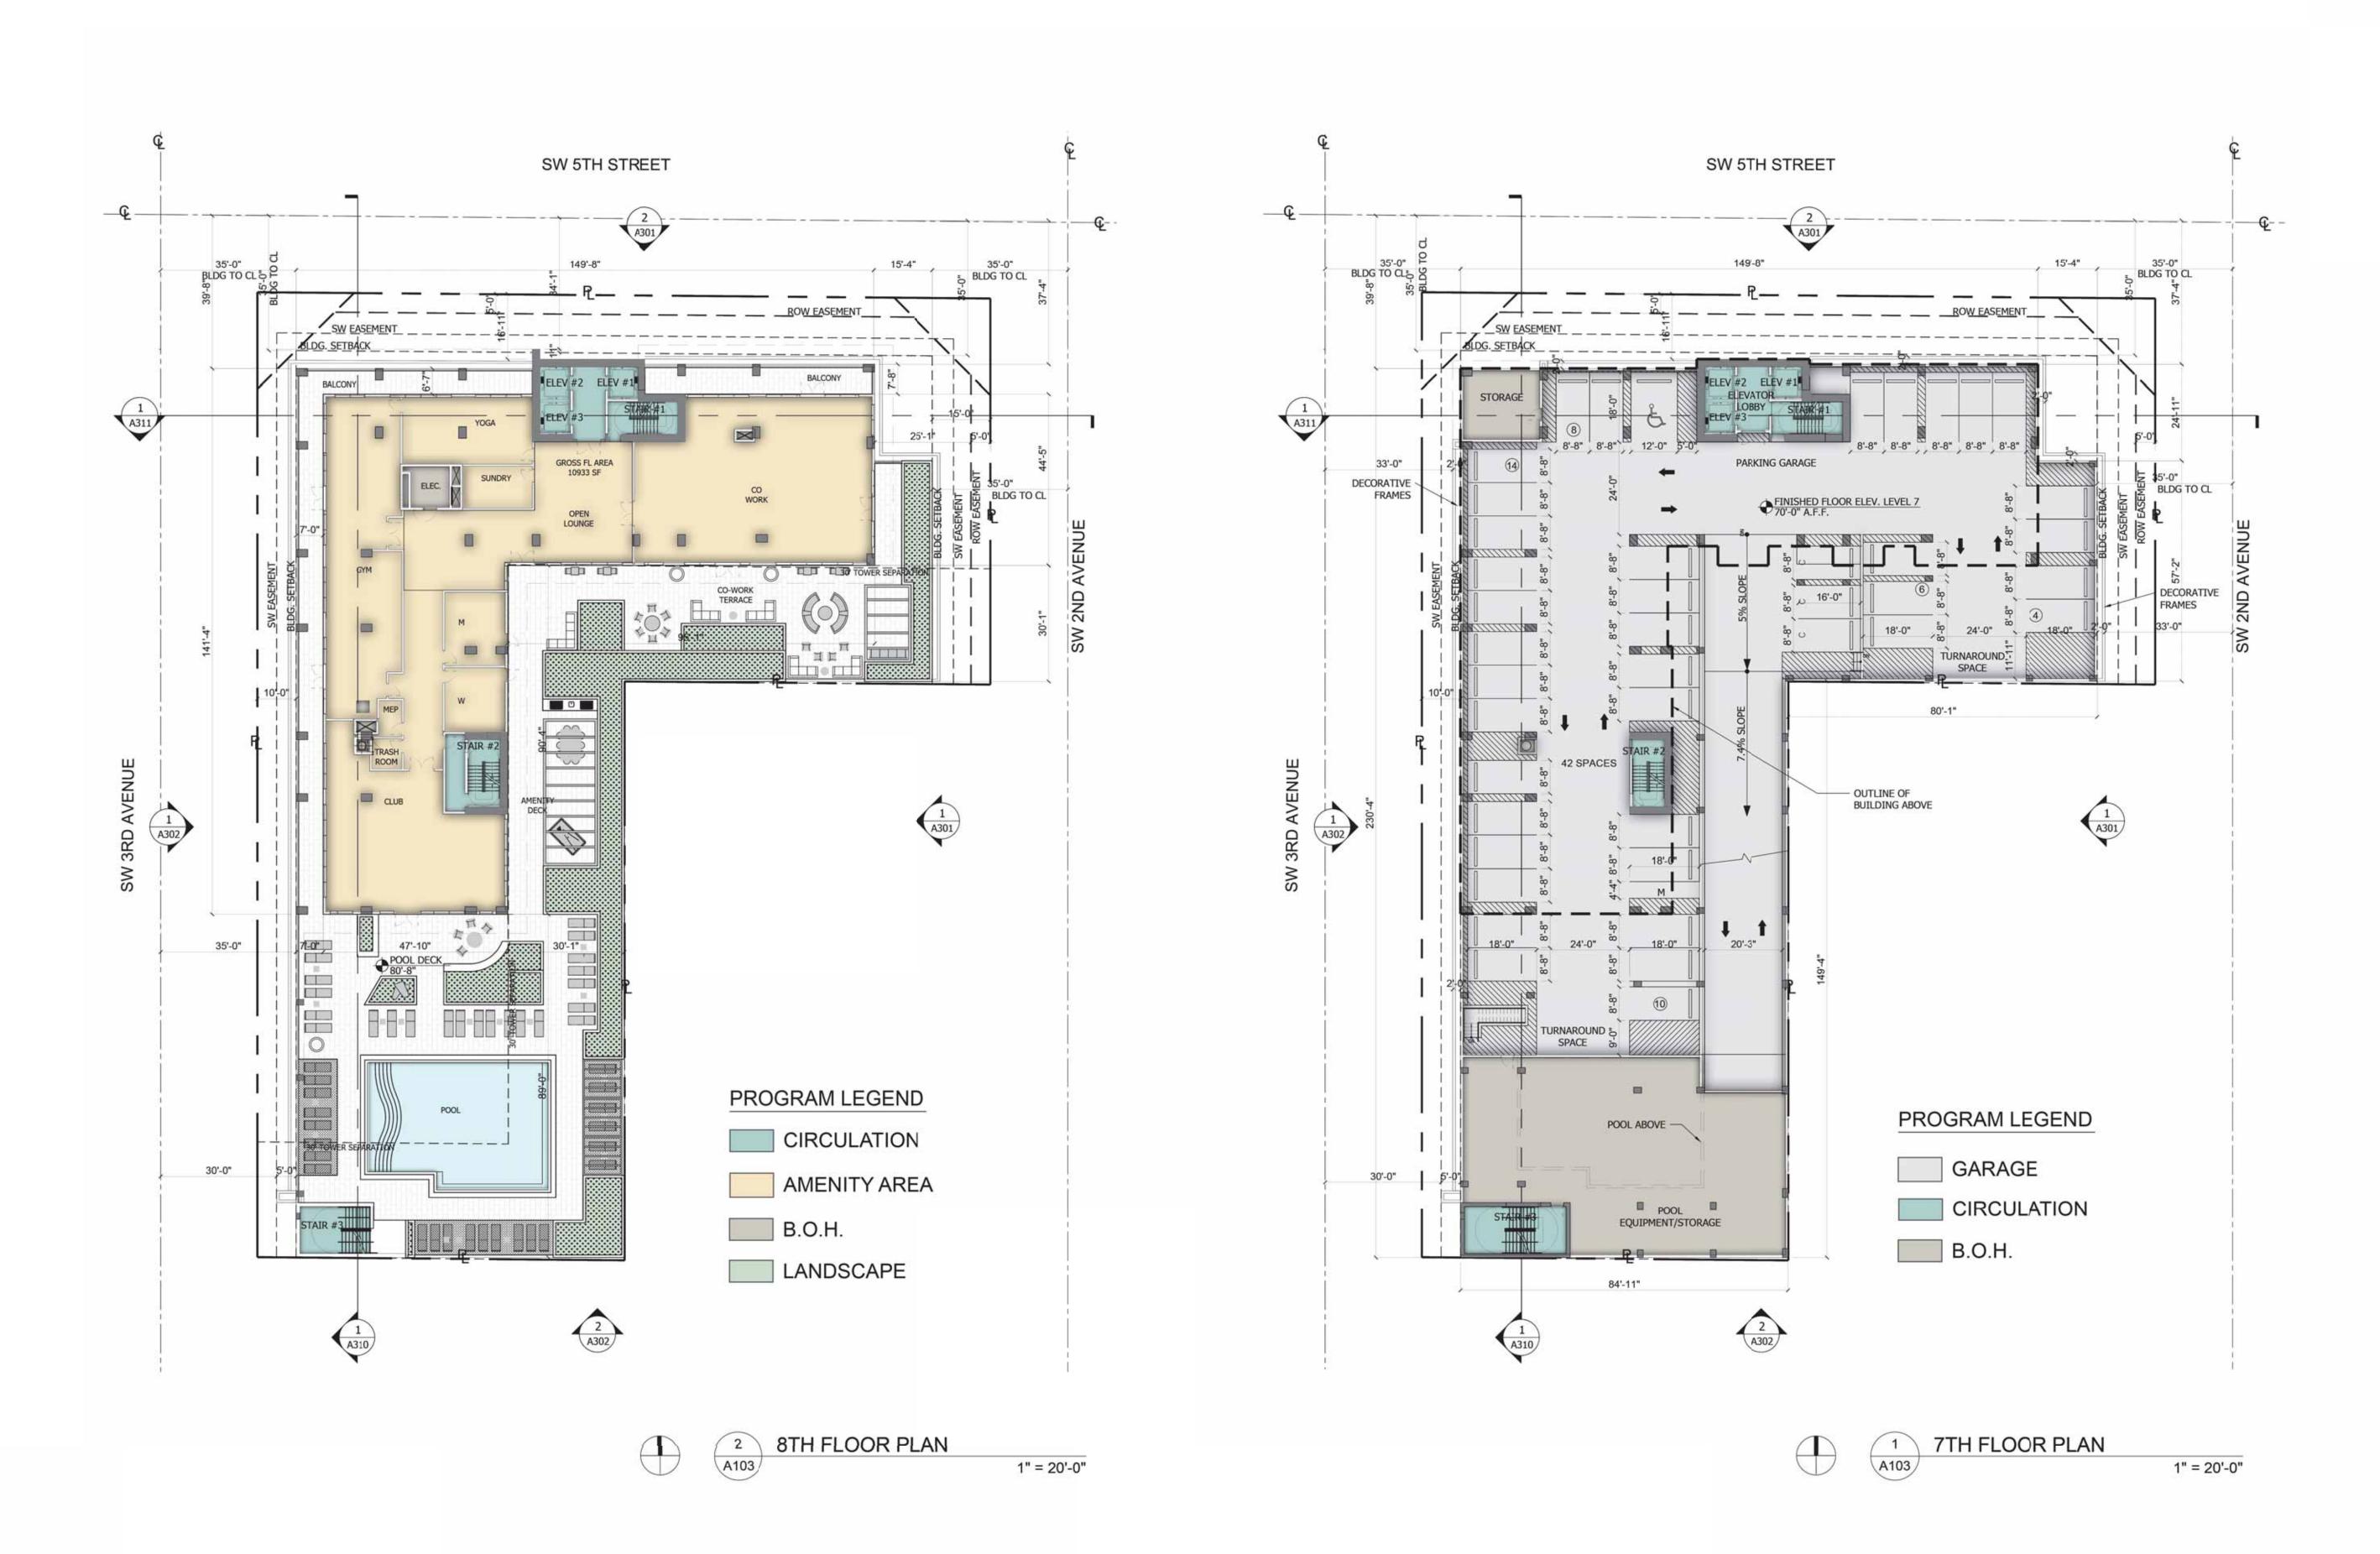3RD-5TH



VICTORIK YUE AR 0013087
AR 0013087


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ARTHAUS

Date: FORT L/


7TH & 8TH FLOOR PLAN



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VICTOR K. YUE AR 0013087

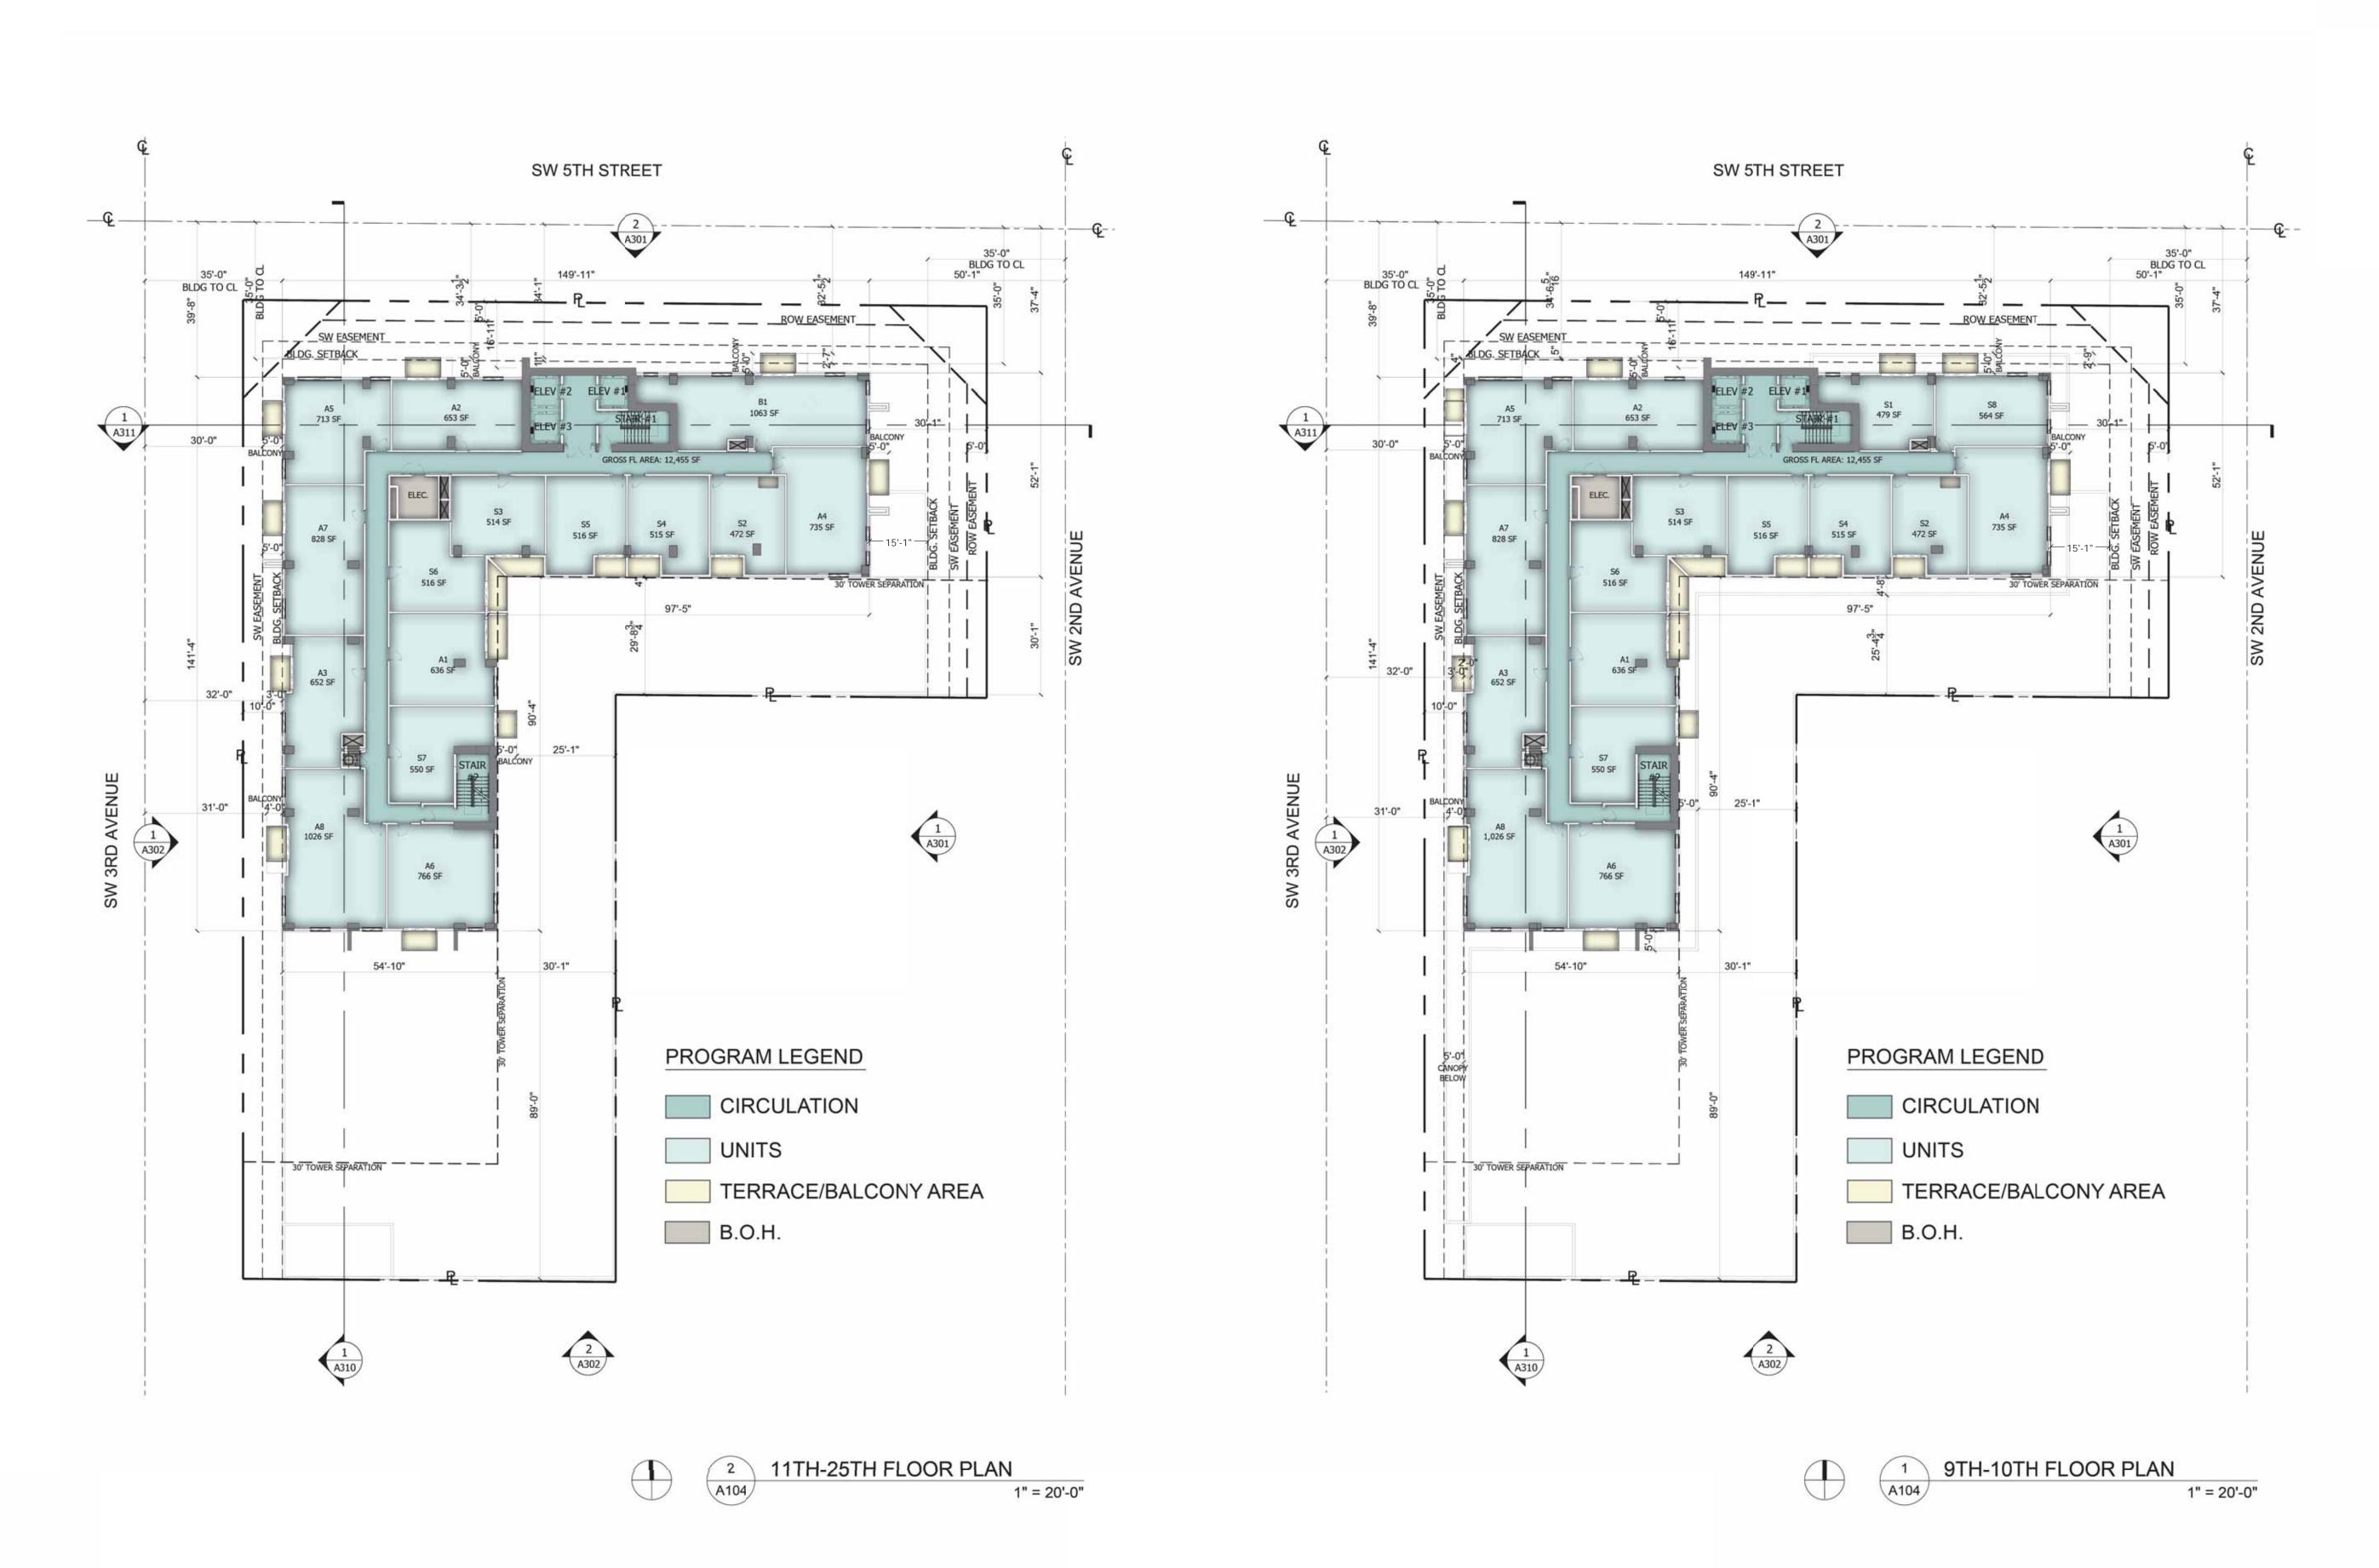N	AF o: Issue	R00130	87 Date	e
	7			
	ARTHAUS		FORT LAUDERDALE, FLORIDA	ALL RIGHTS RESERVED
	9TH-10TH & 11TH-25TH	FLOOR PLAN	Job No.: Drawn: Checked: Date:	DY202334 06/16/2025

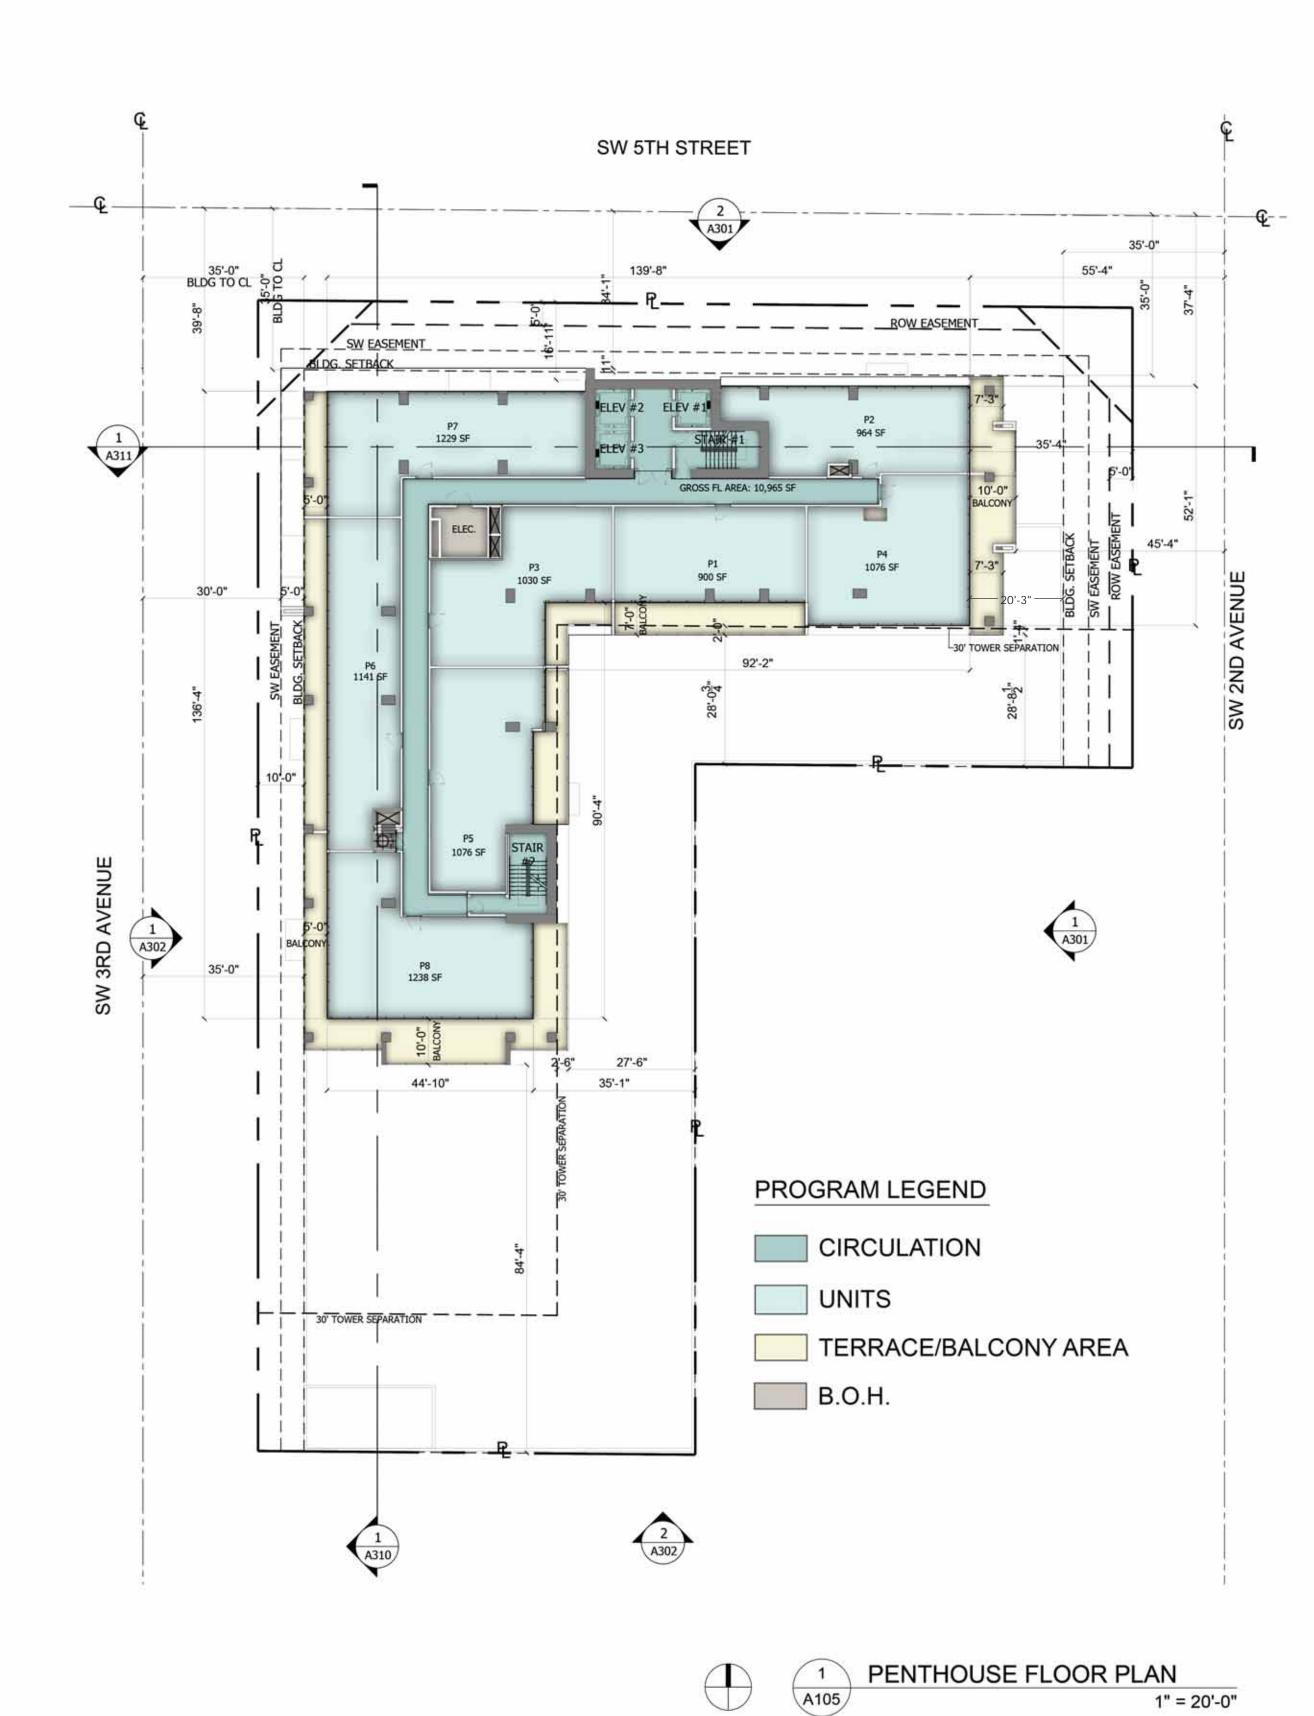

26TH FLOOR PLAN PENTHOUSE
FLOOR PLAN

Sobno: Drawn: Checked: Date: FORT LAUDERDALE, FLORIDA


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PARTHAUS

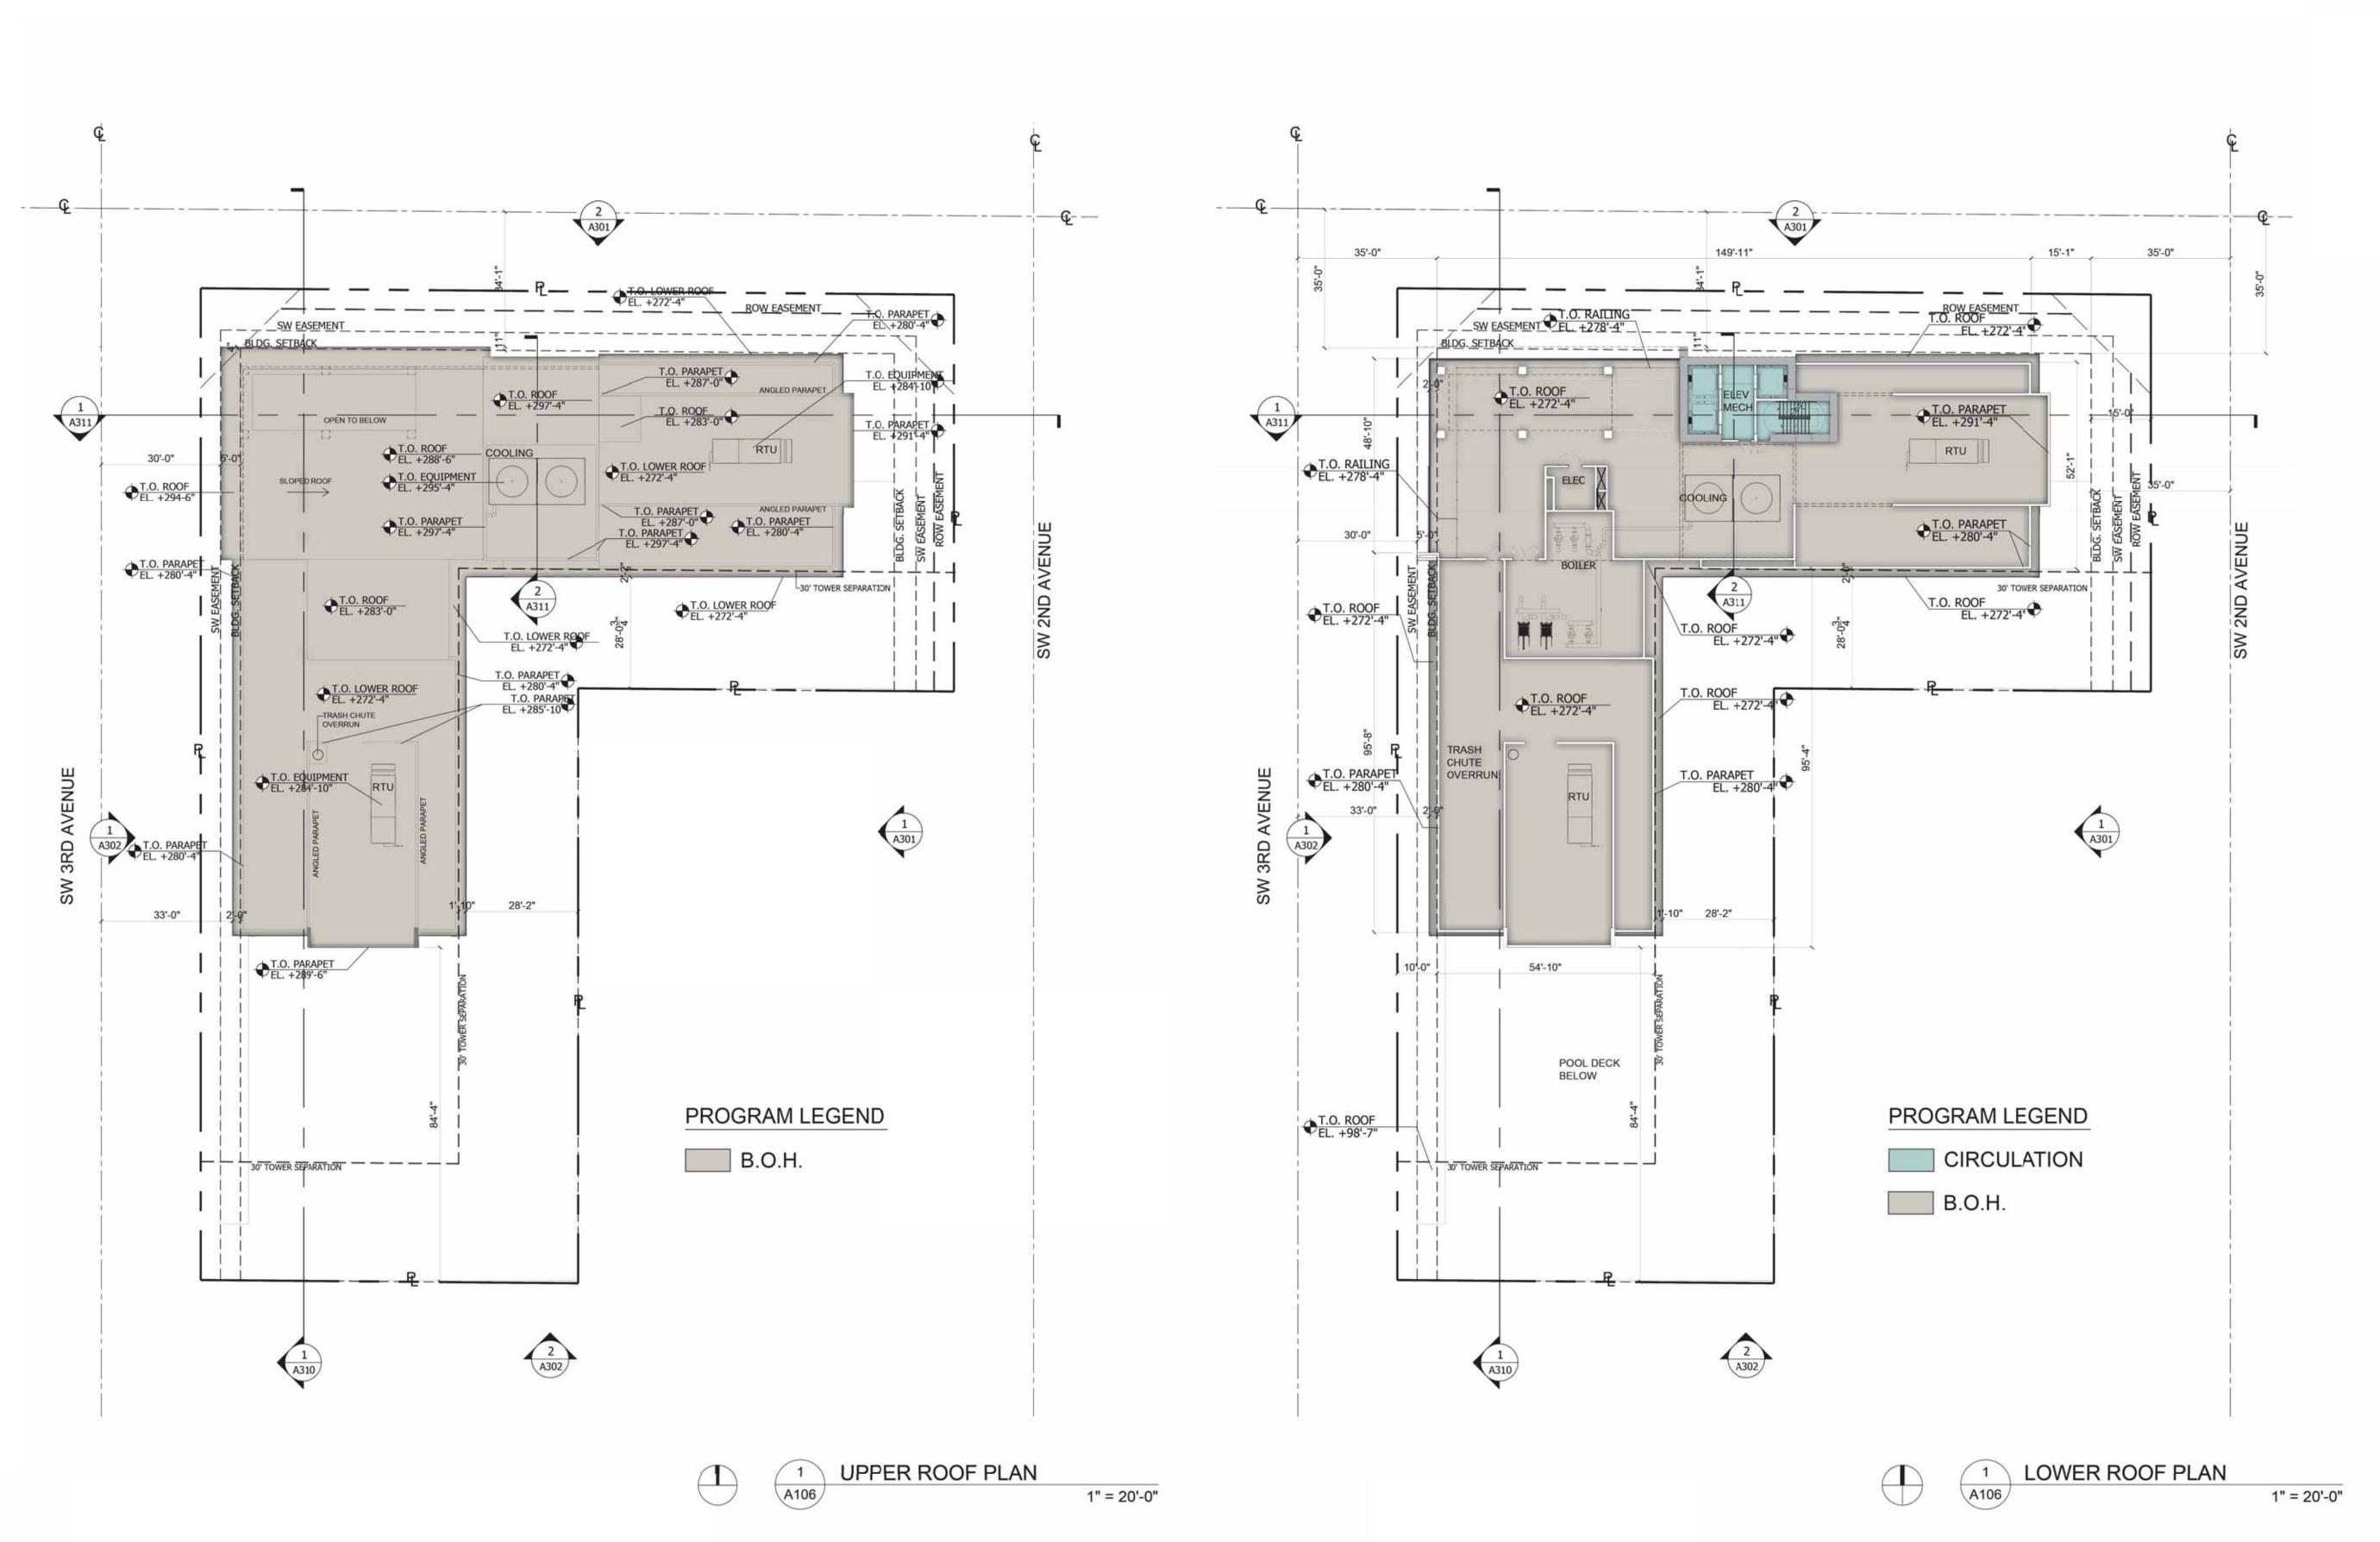PARTHAUS

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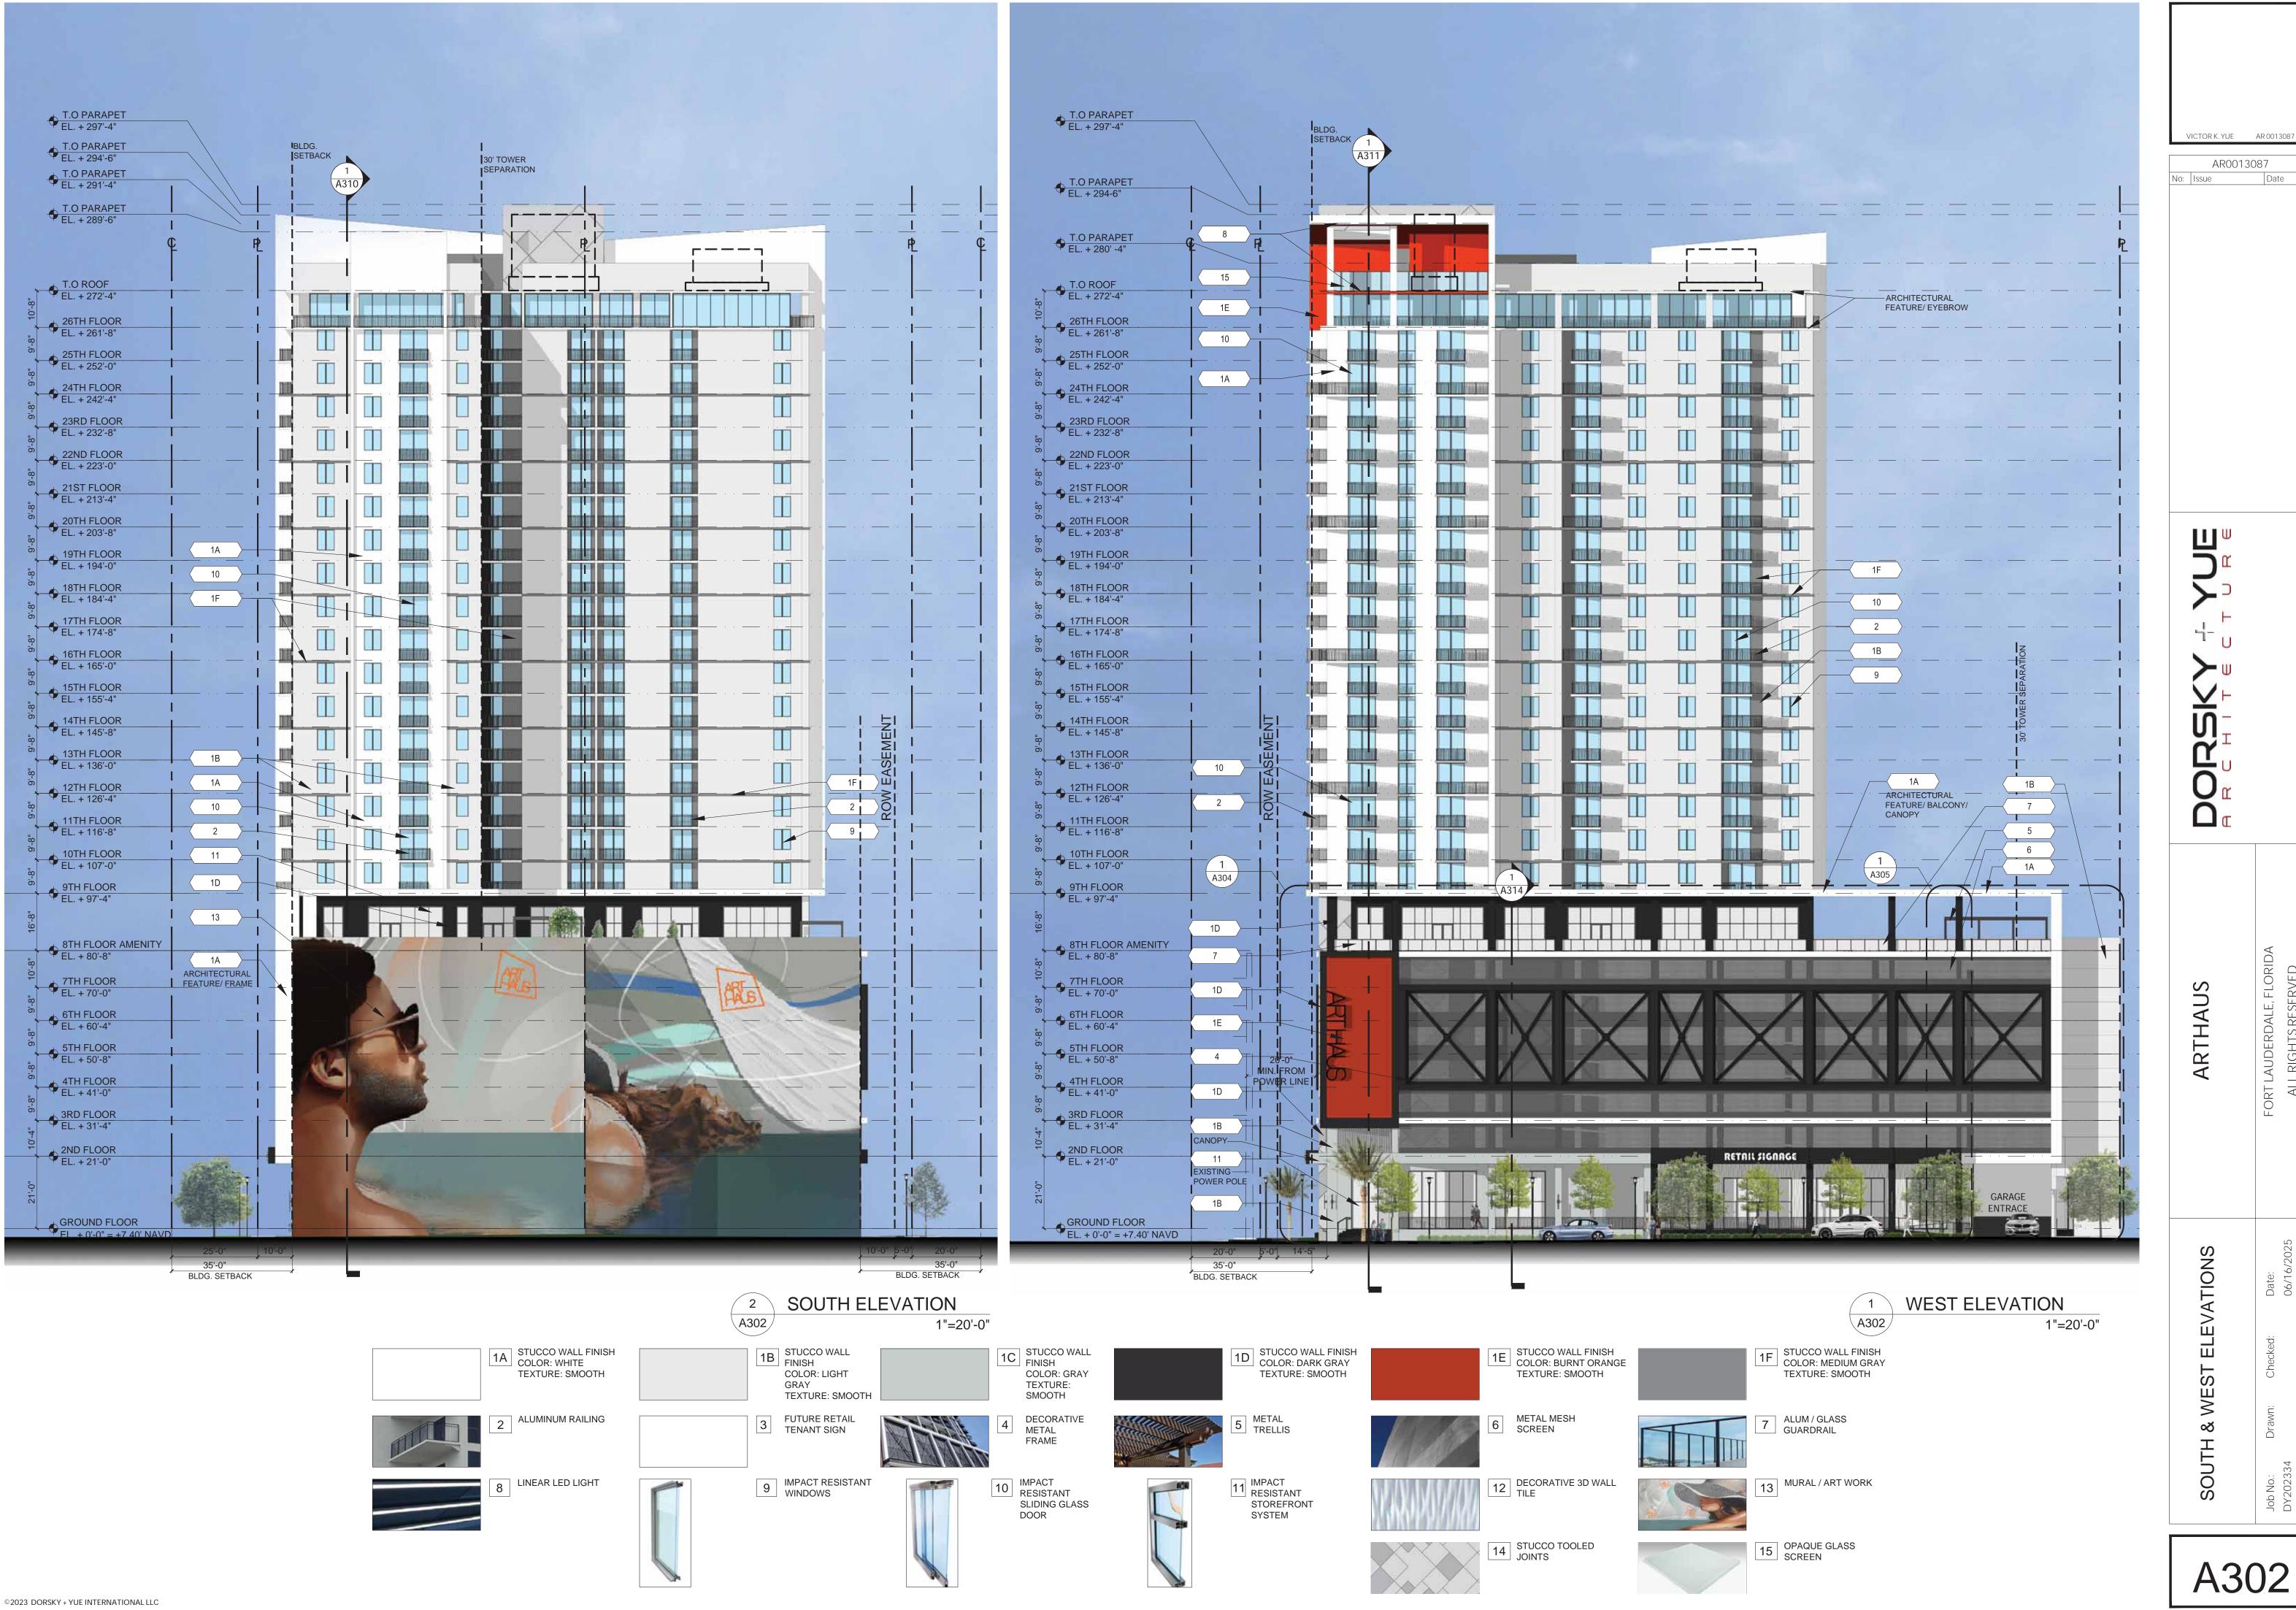
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 П п VAIS TO BE OF THE PROPERTY OF **ARTHAUS** ROOF PLAN LOWER



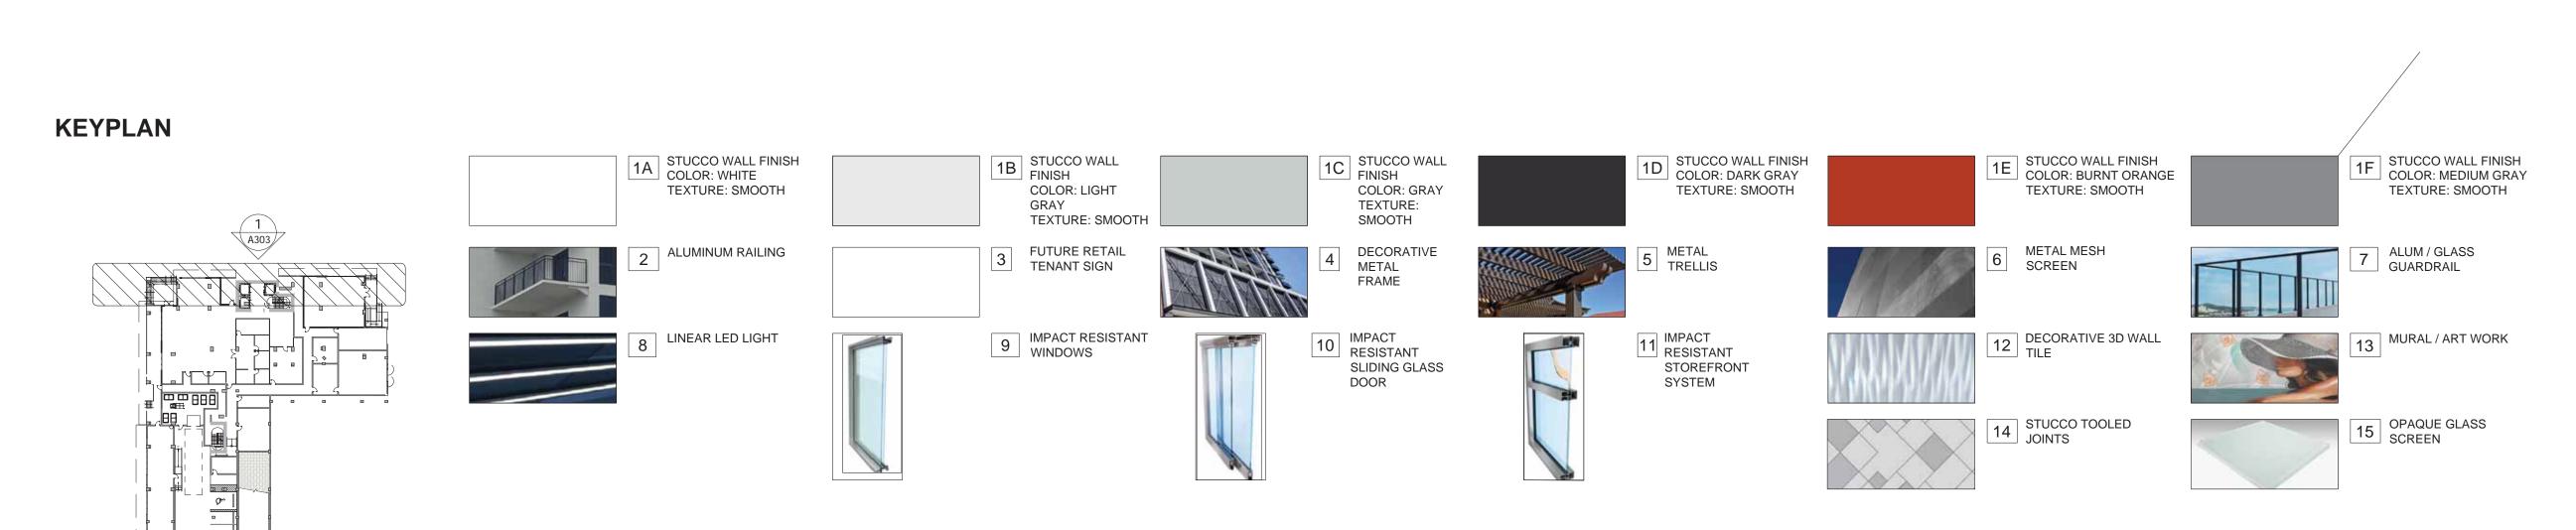
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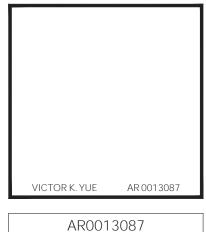


A302

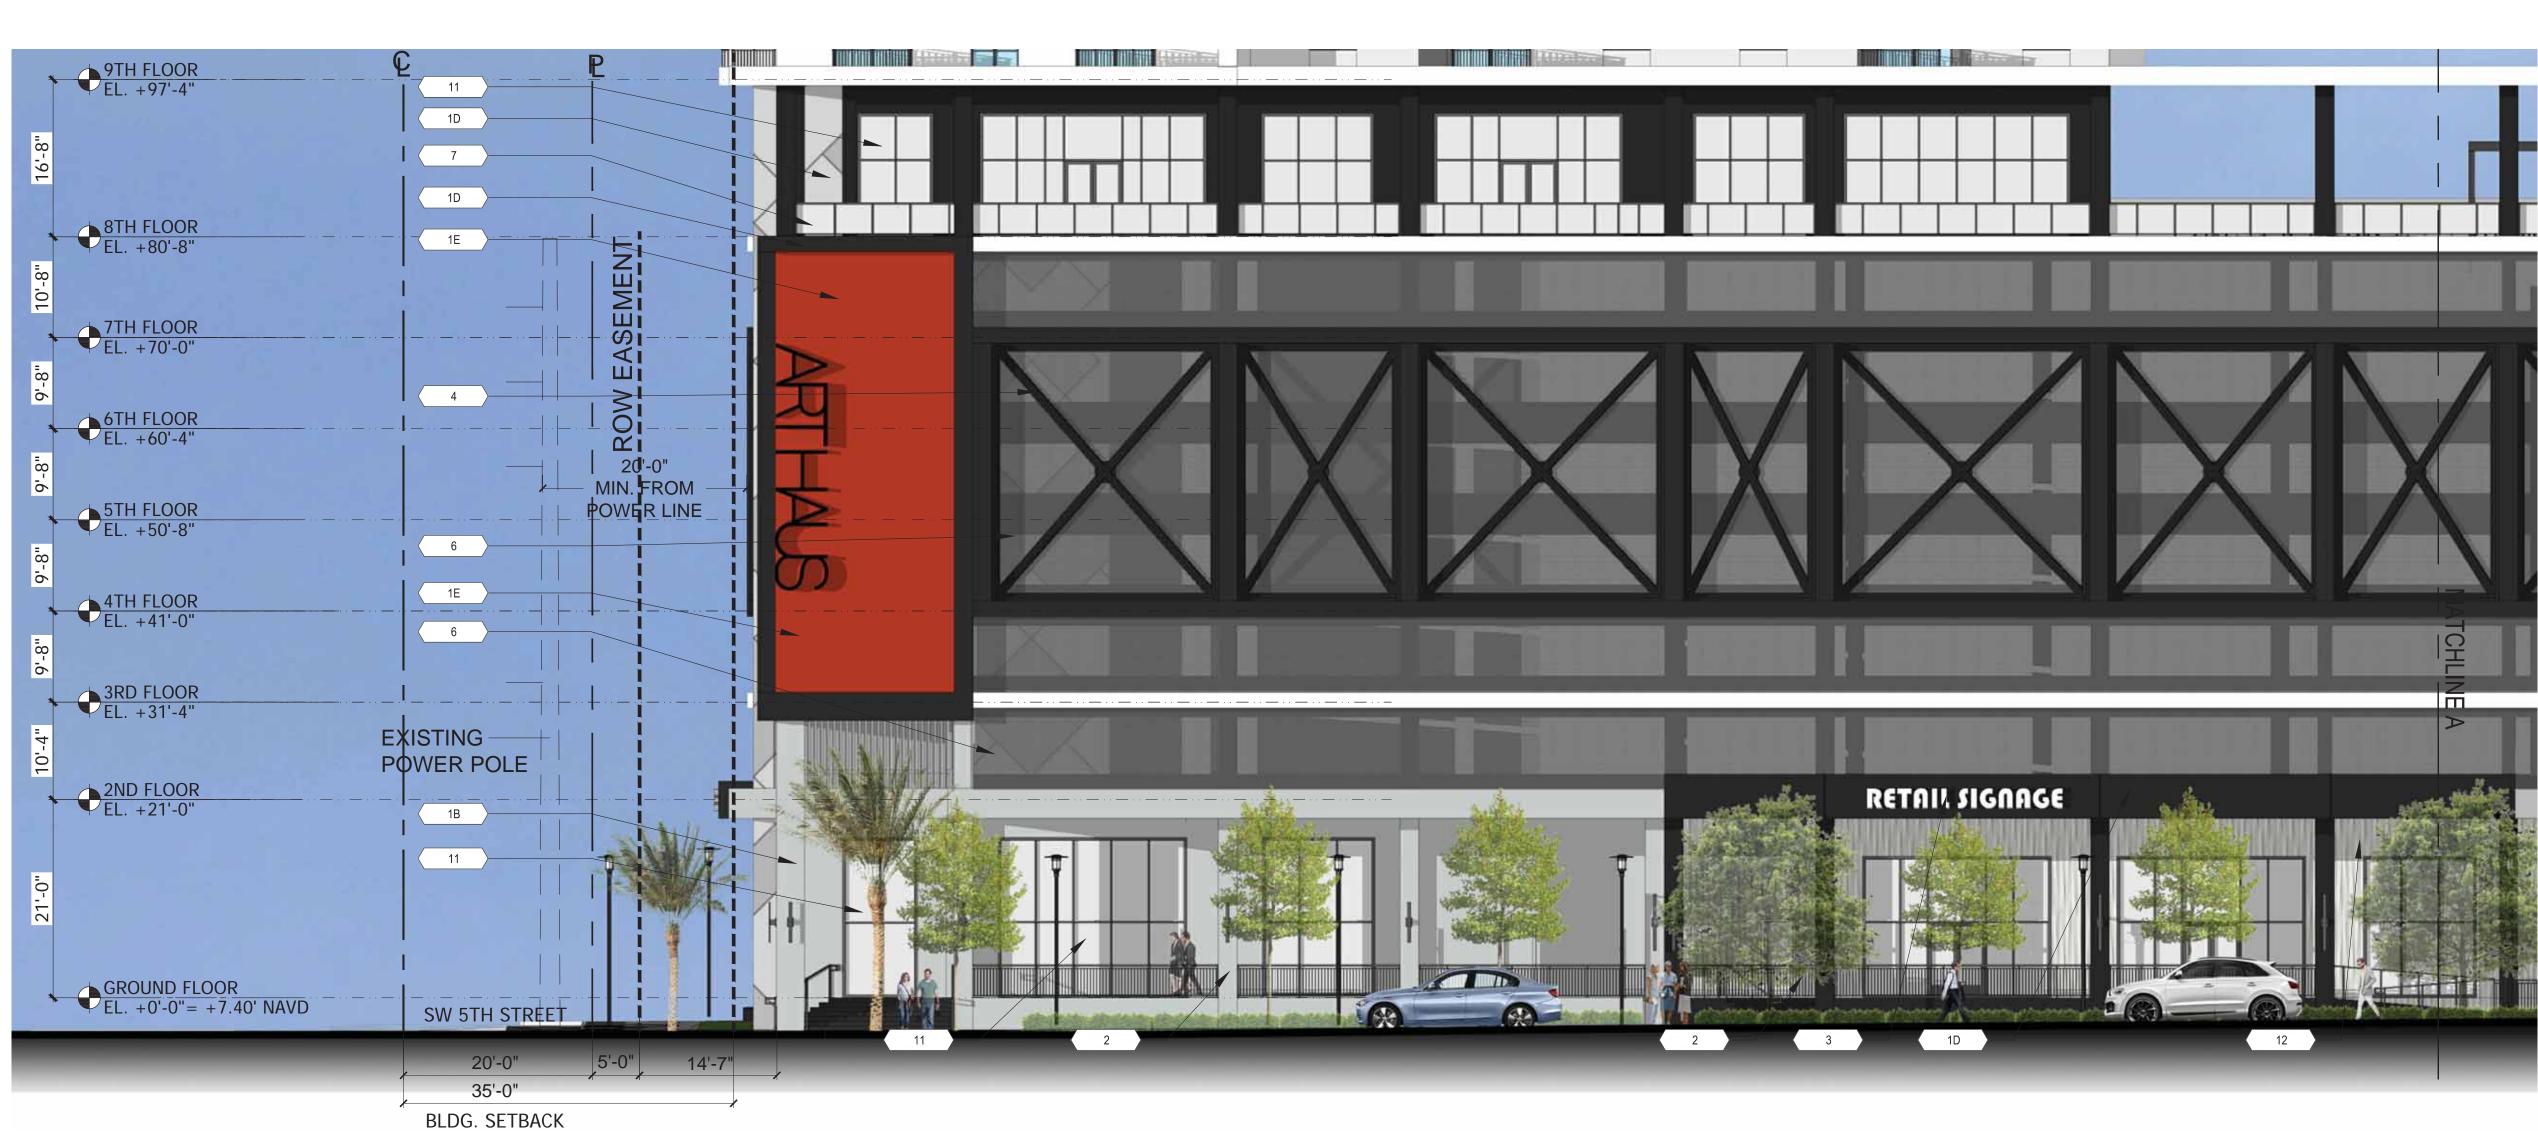
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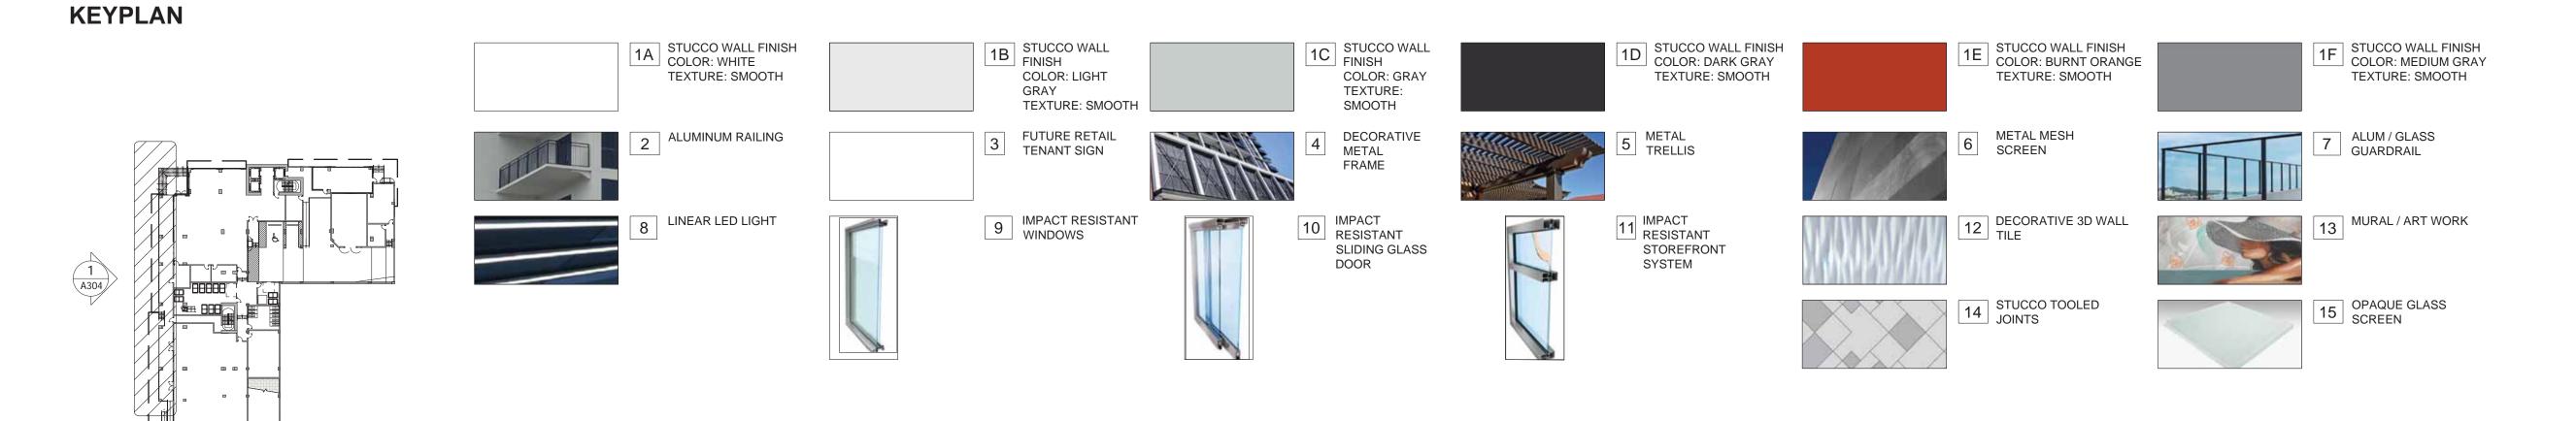




VICTOR K. YUE AROO1 No: Issue	
ARTHAUS	FORT LAUDERDALE, FLORIDA ALL RIGHTS RESERVED
ENLARGED NORTH ELEVATION	Job No.: Drawn: Checked: Date: DY202334 06/16/2025





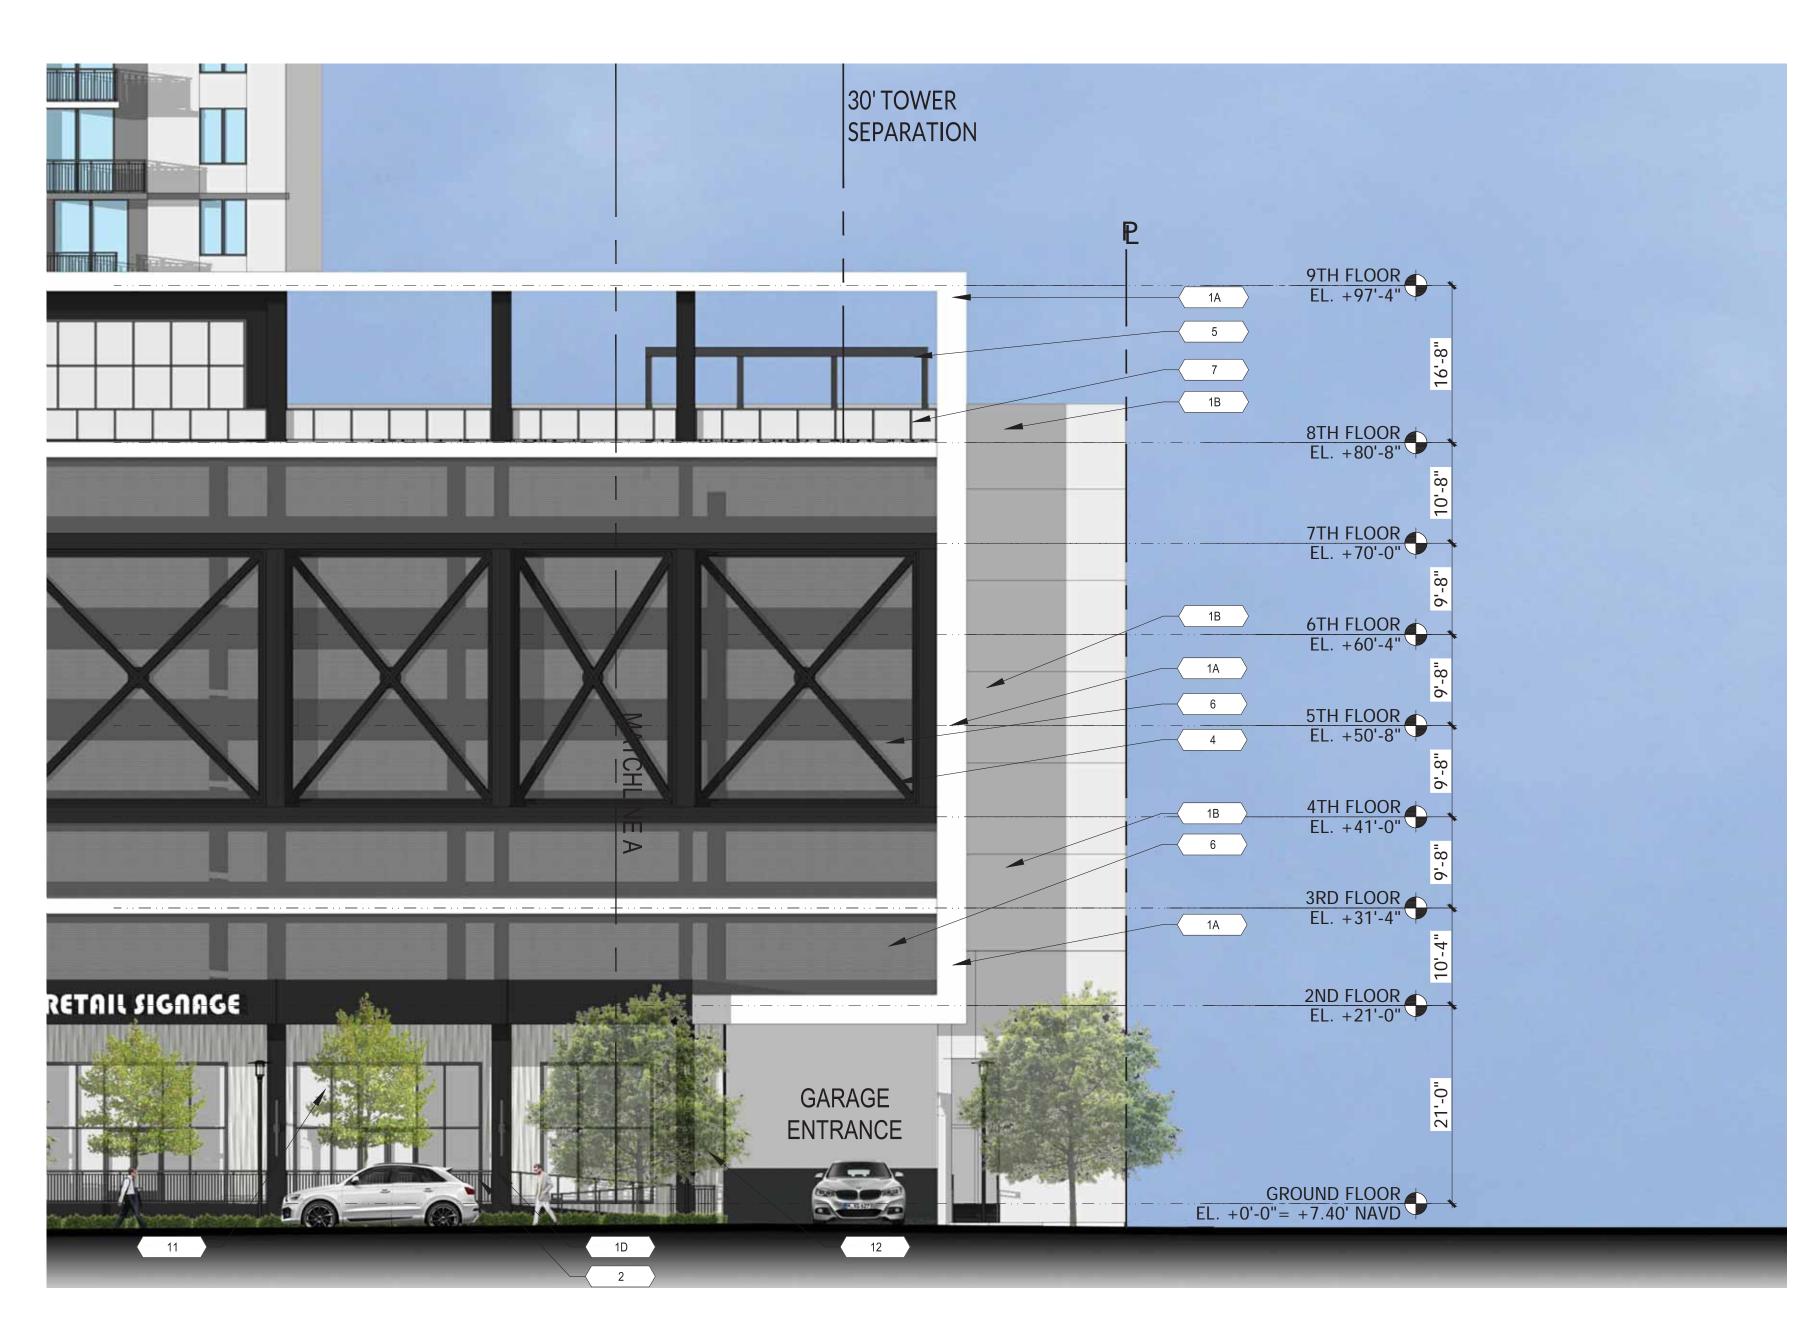


VICTOR K. YUE AR 0013087

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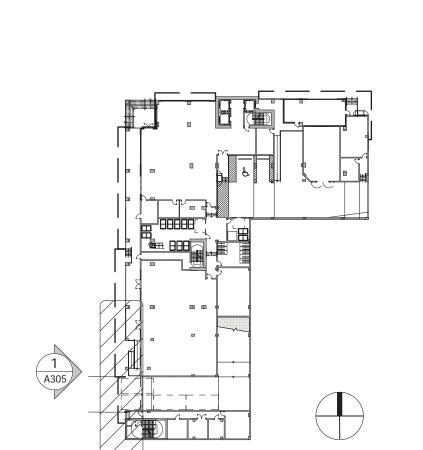
ENLARGED WEST ELEVATION 1


Job No.: Checked: Date:
DY202334 06/16/2025





ENLARGED WEST ELEVATION 2 A305 1"=10'-0"

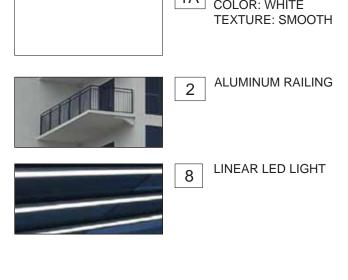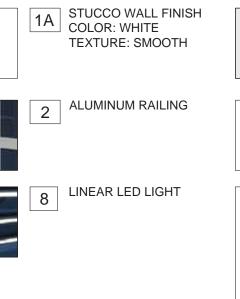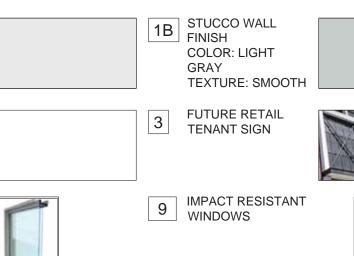KEYPLAN














1C STUCCO WALL FINISH

COLOR: GRAY



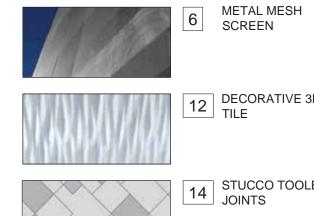1D STUCCO WALL FINISH COLOR: DARK GRAY TEXTURE: SMOOTH











OPAQUE GLASS SCREEN

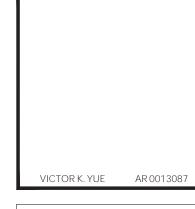


DORSKY + YUE	
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	ENLAR(SED WE	ENLARGED WEST ELEVATION 2	ATION 2	
	Job No.:	Drawn:	Checked:	Date:	FORT
	DY202334			06/16/2025	AL



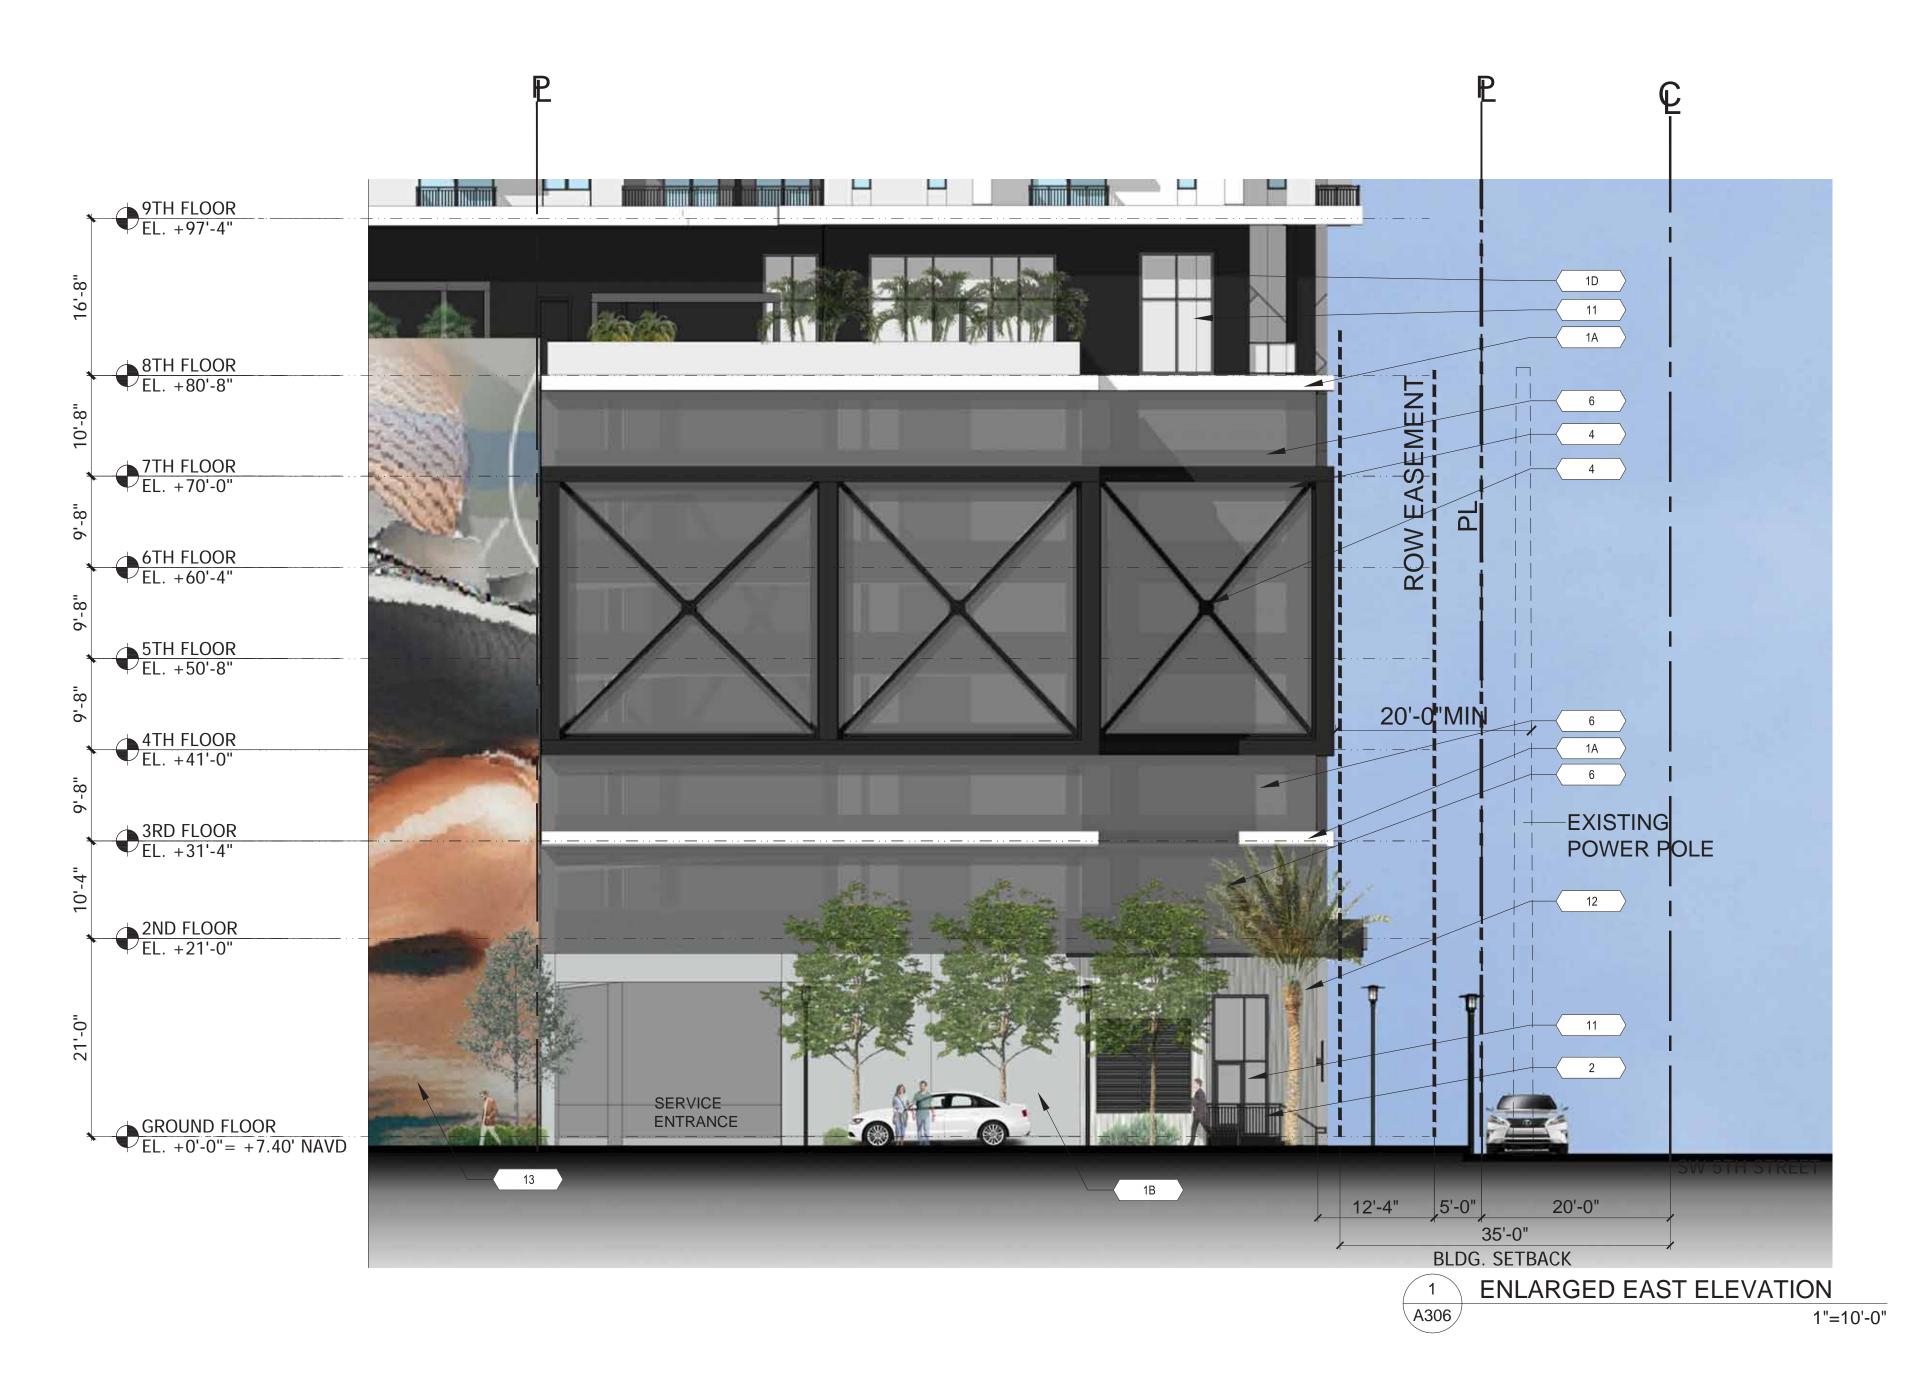


6 METAL MESH SCREEN

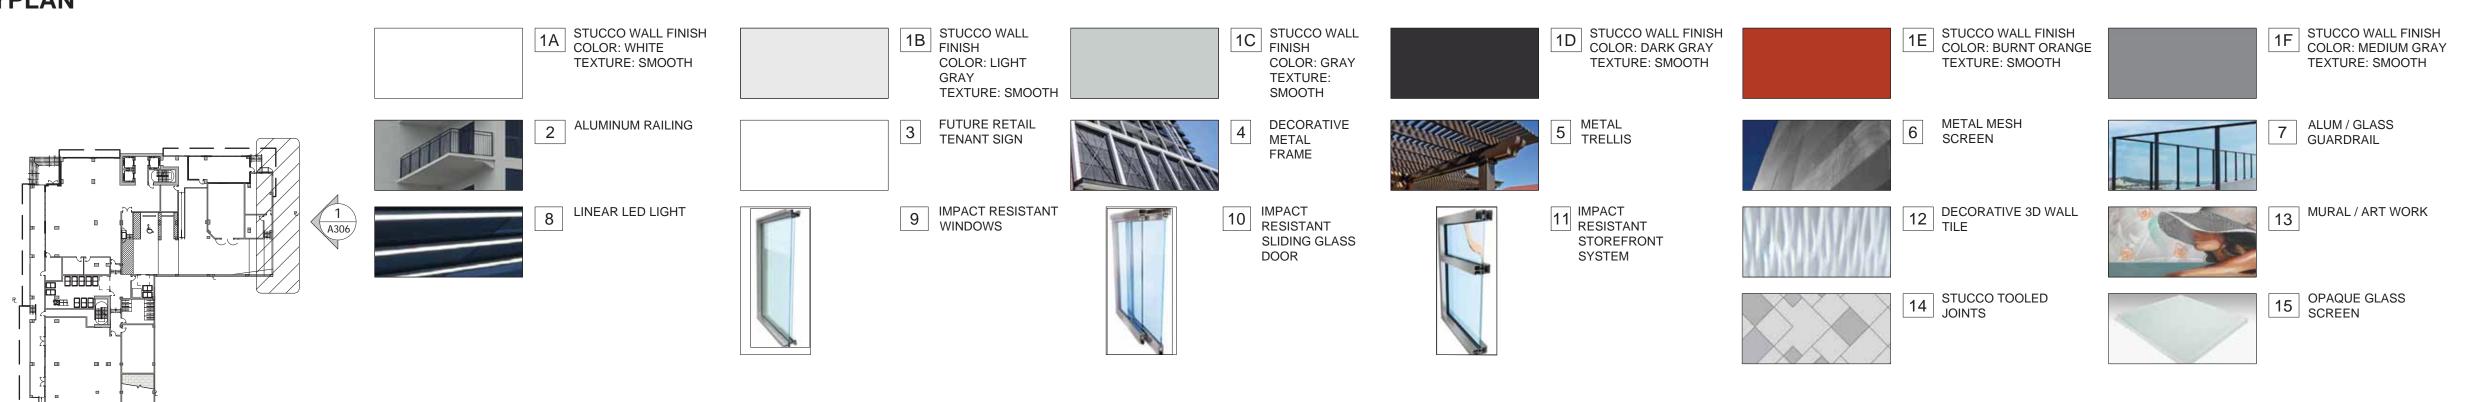

AR0013087 No: Issue Date YOE □ V NSE SING **ARTHAUS** ELEVATION EAST ENLARGED

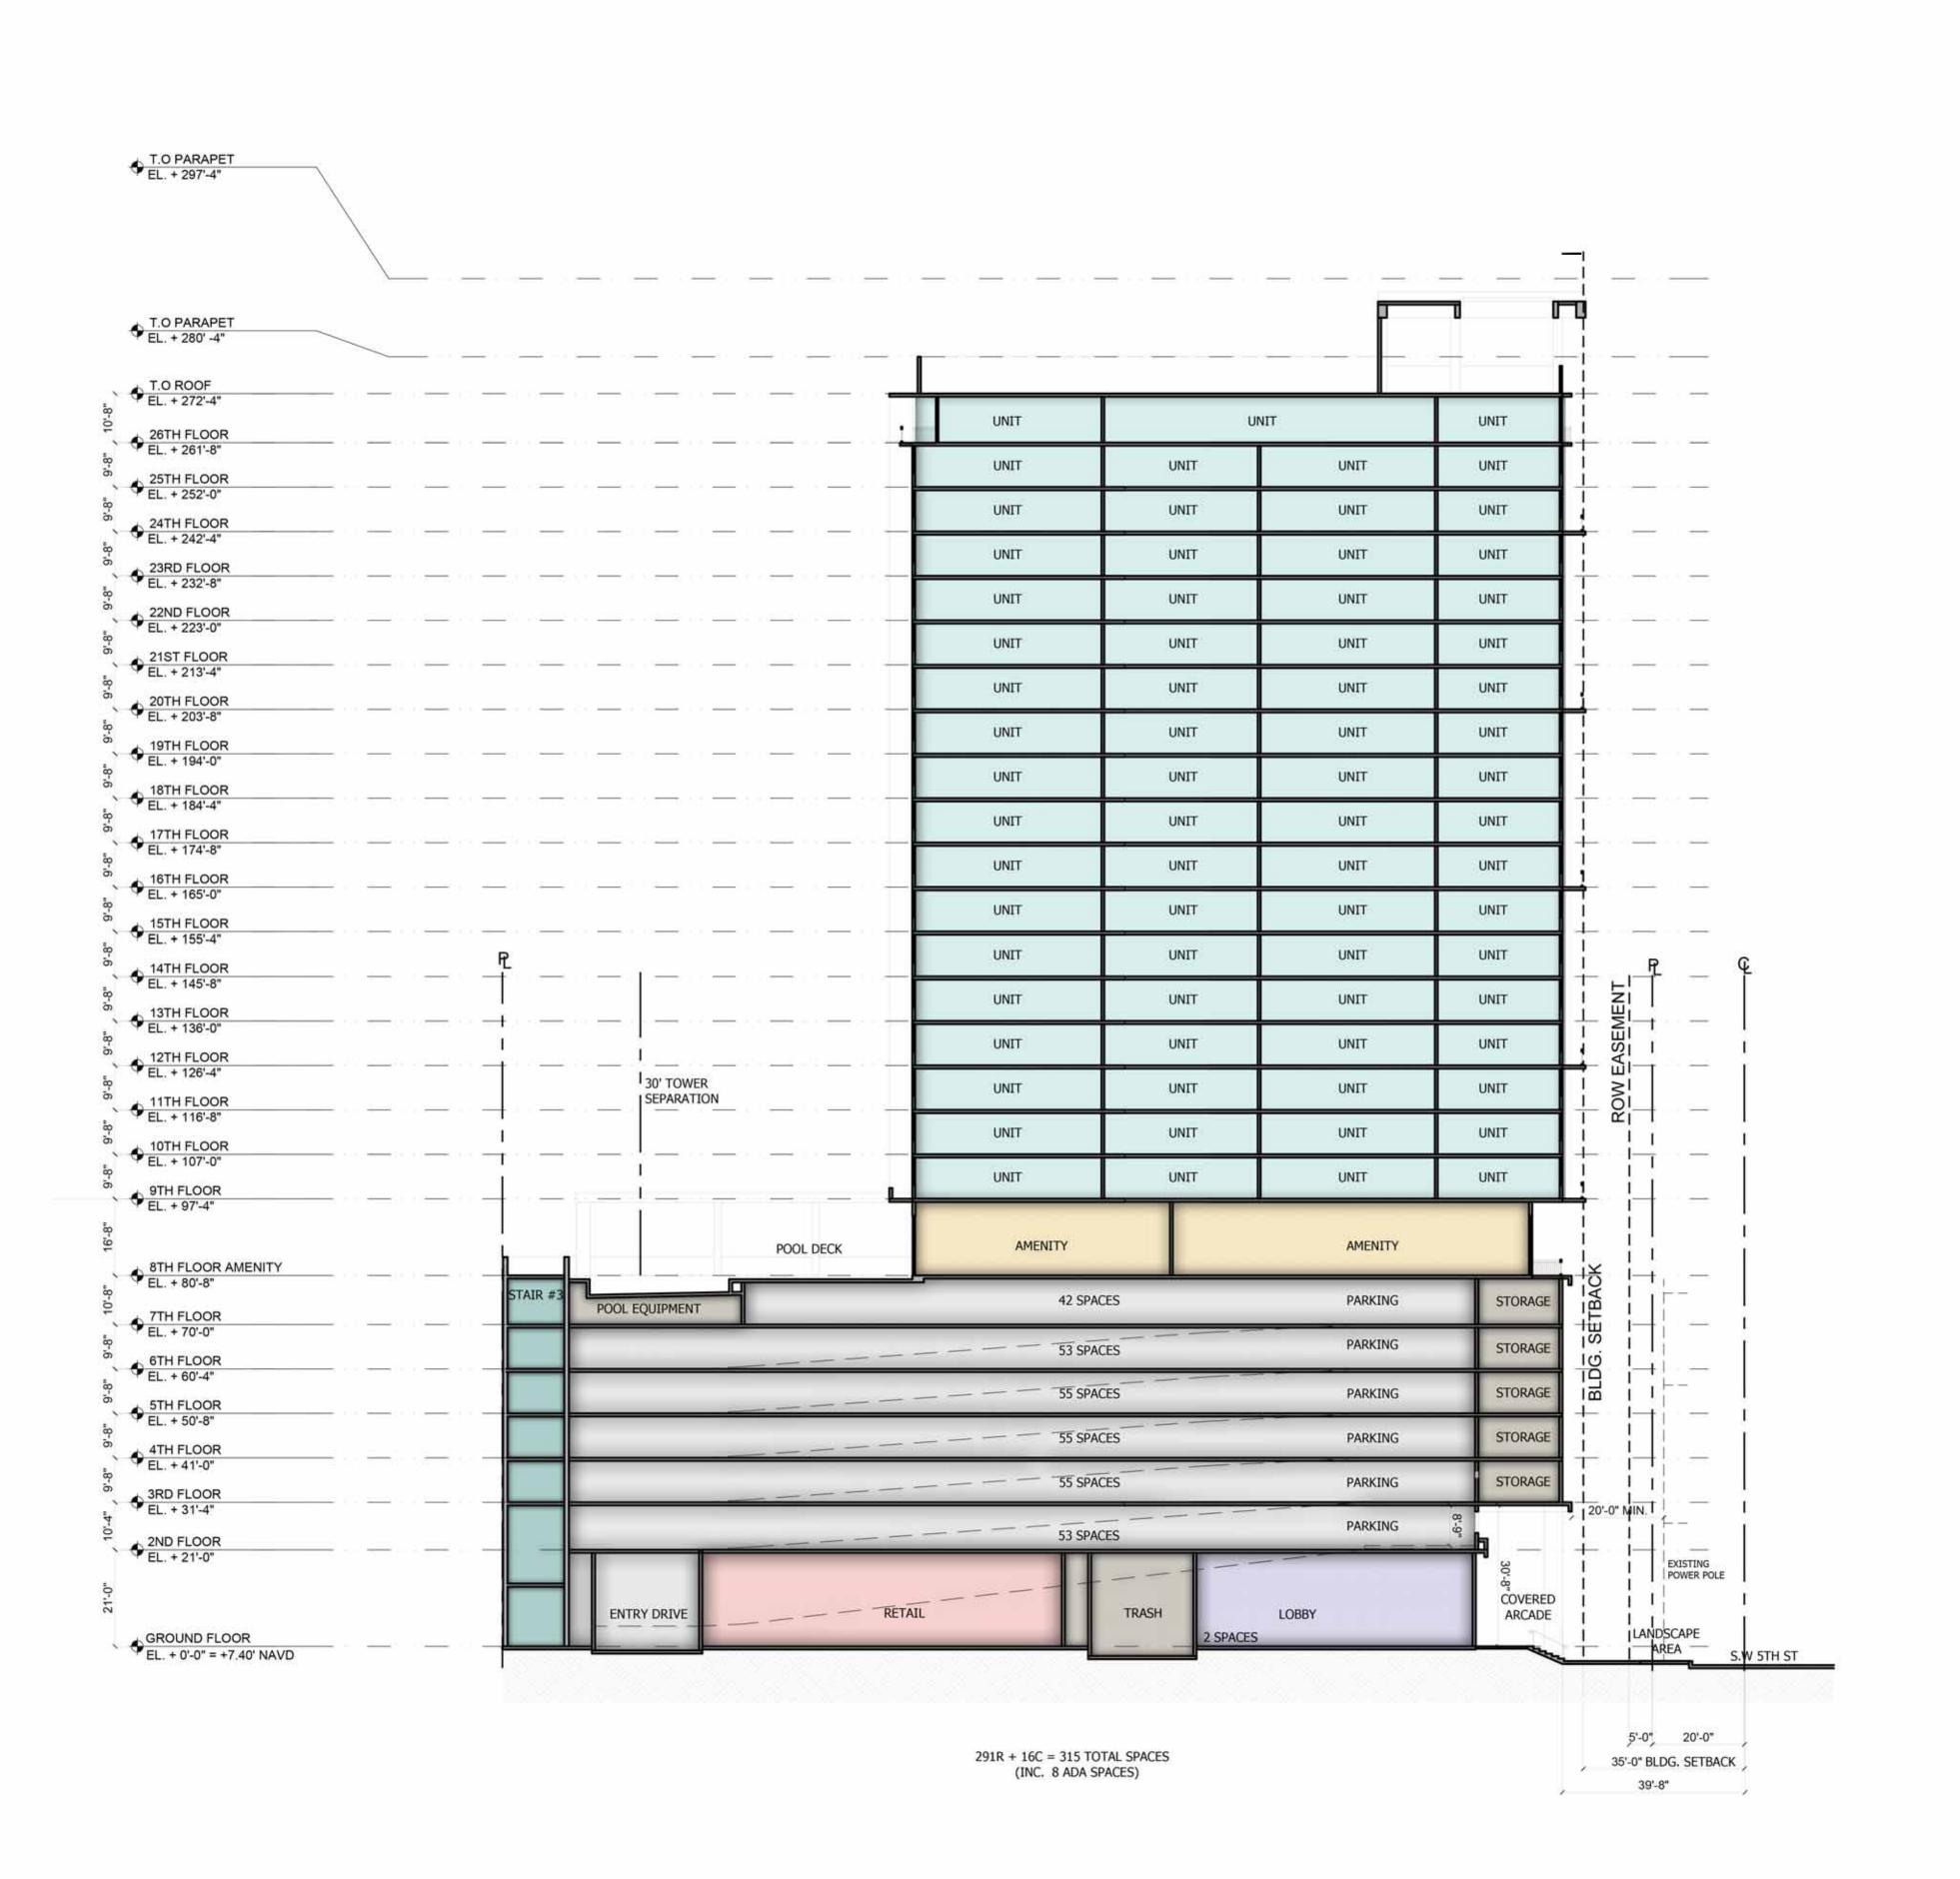VICTOR K. YUE AR 0013087



VICTOR K. YUE AR 0013087

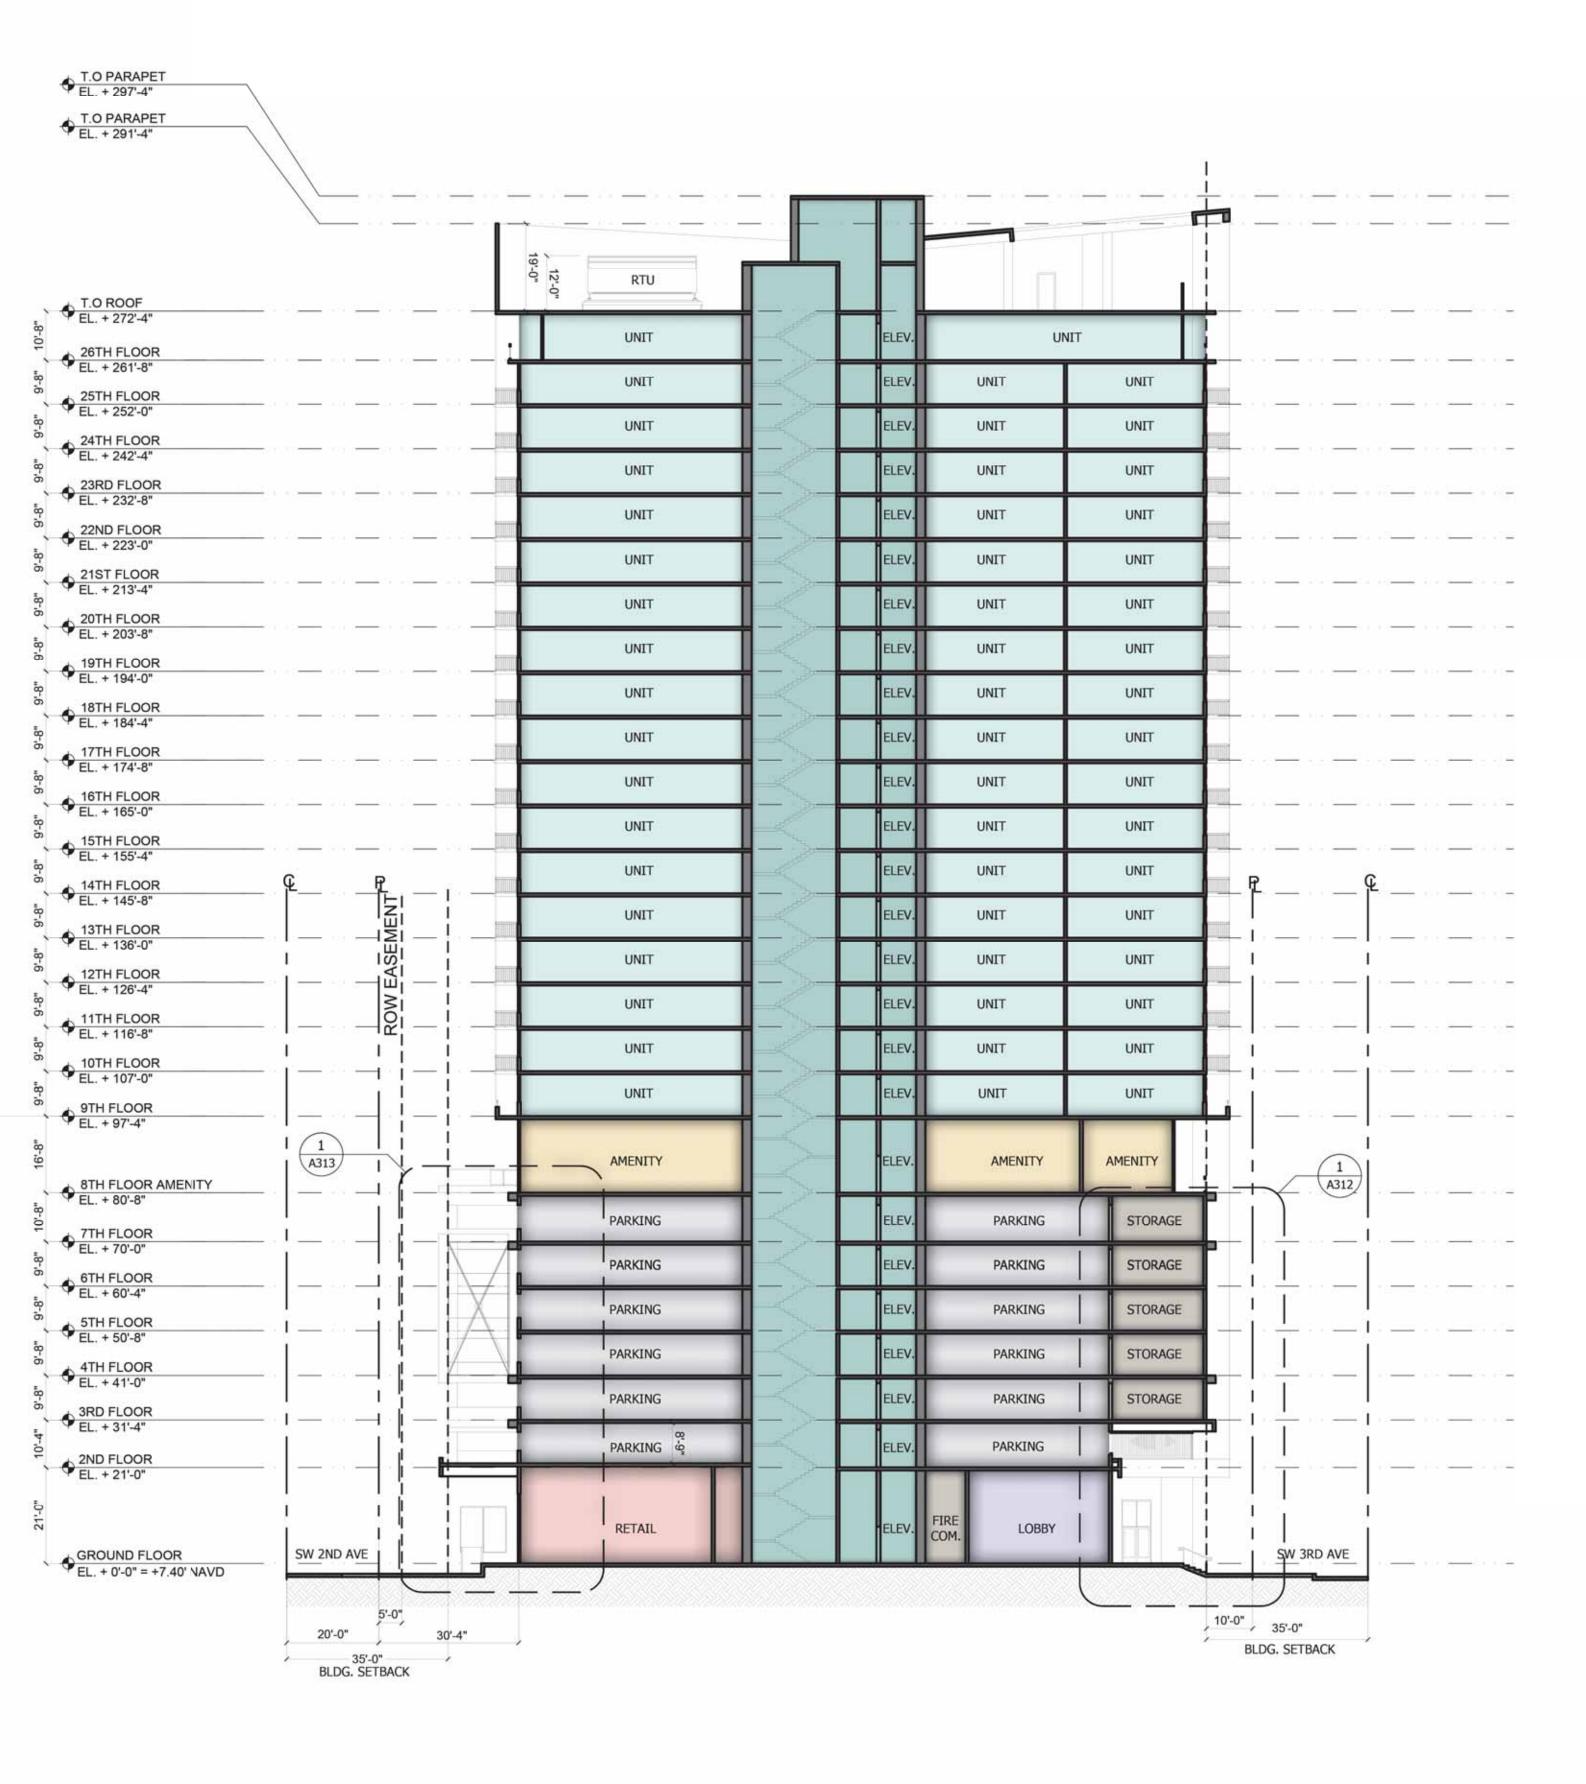
AR0013087 No: Issue Date Y □ u DORSKY FILL FILE **ARTHAUS**

A310


SECTION

1" = 20'-0"

SECTION A



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SECTION B

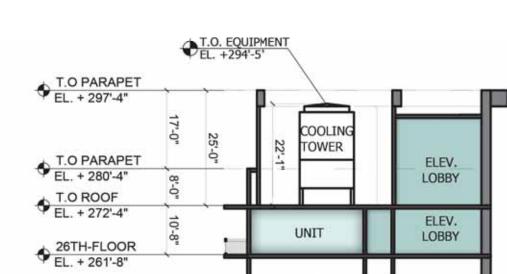1" = 20'-0"

1 A311

2 SECTION ROOF MECH. EQUIPMENT 1" = 20'-0"

DORY + YUE

VICTORIK, YUE AR 0013087

AR0013087

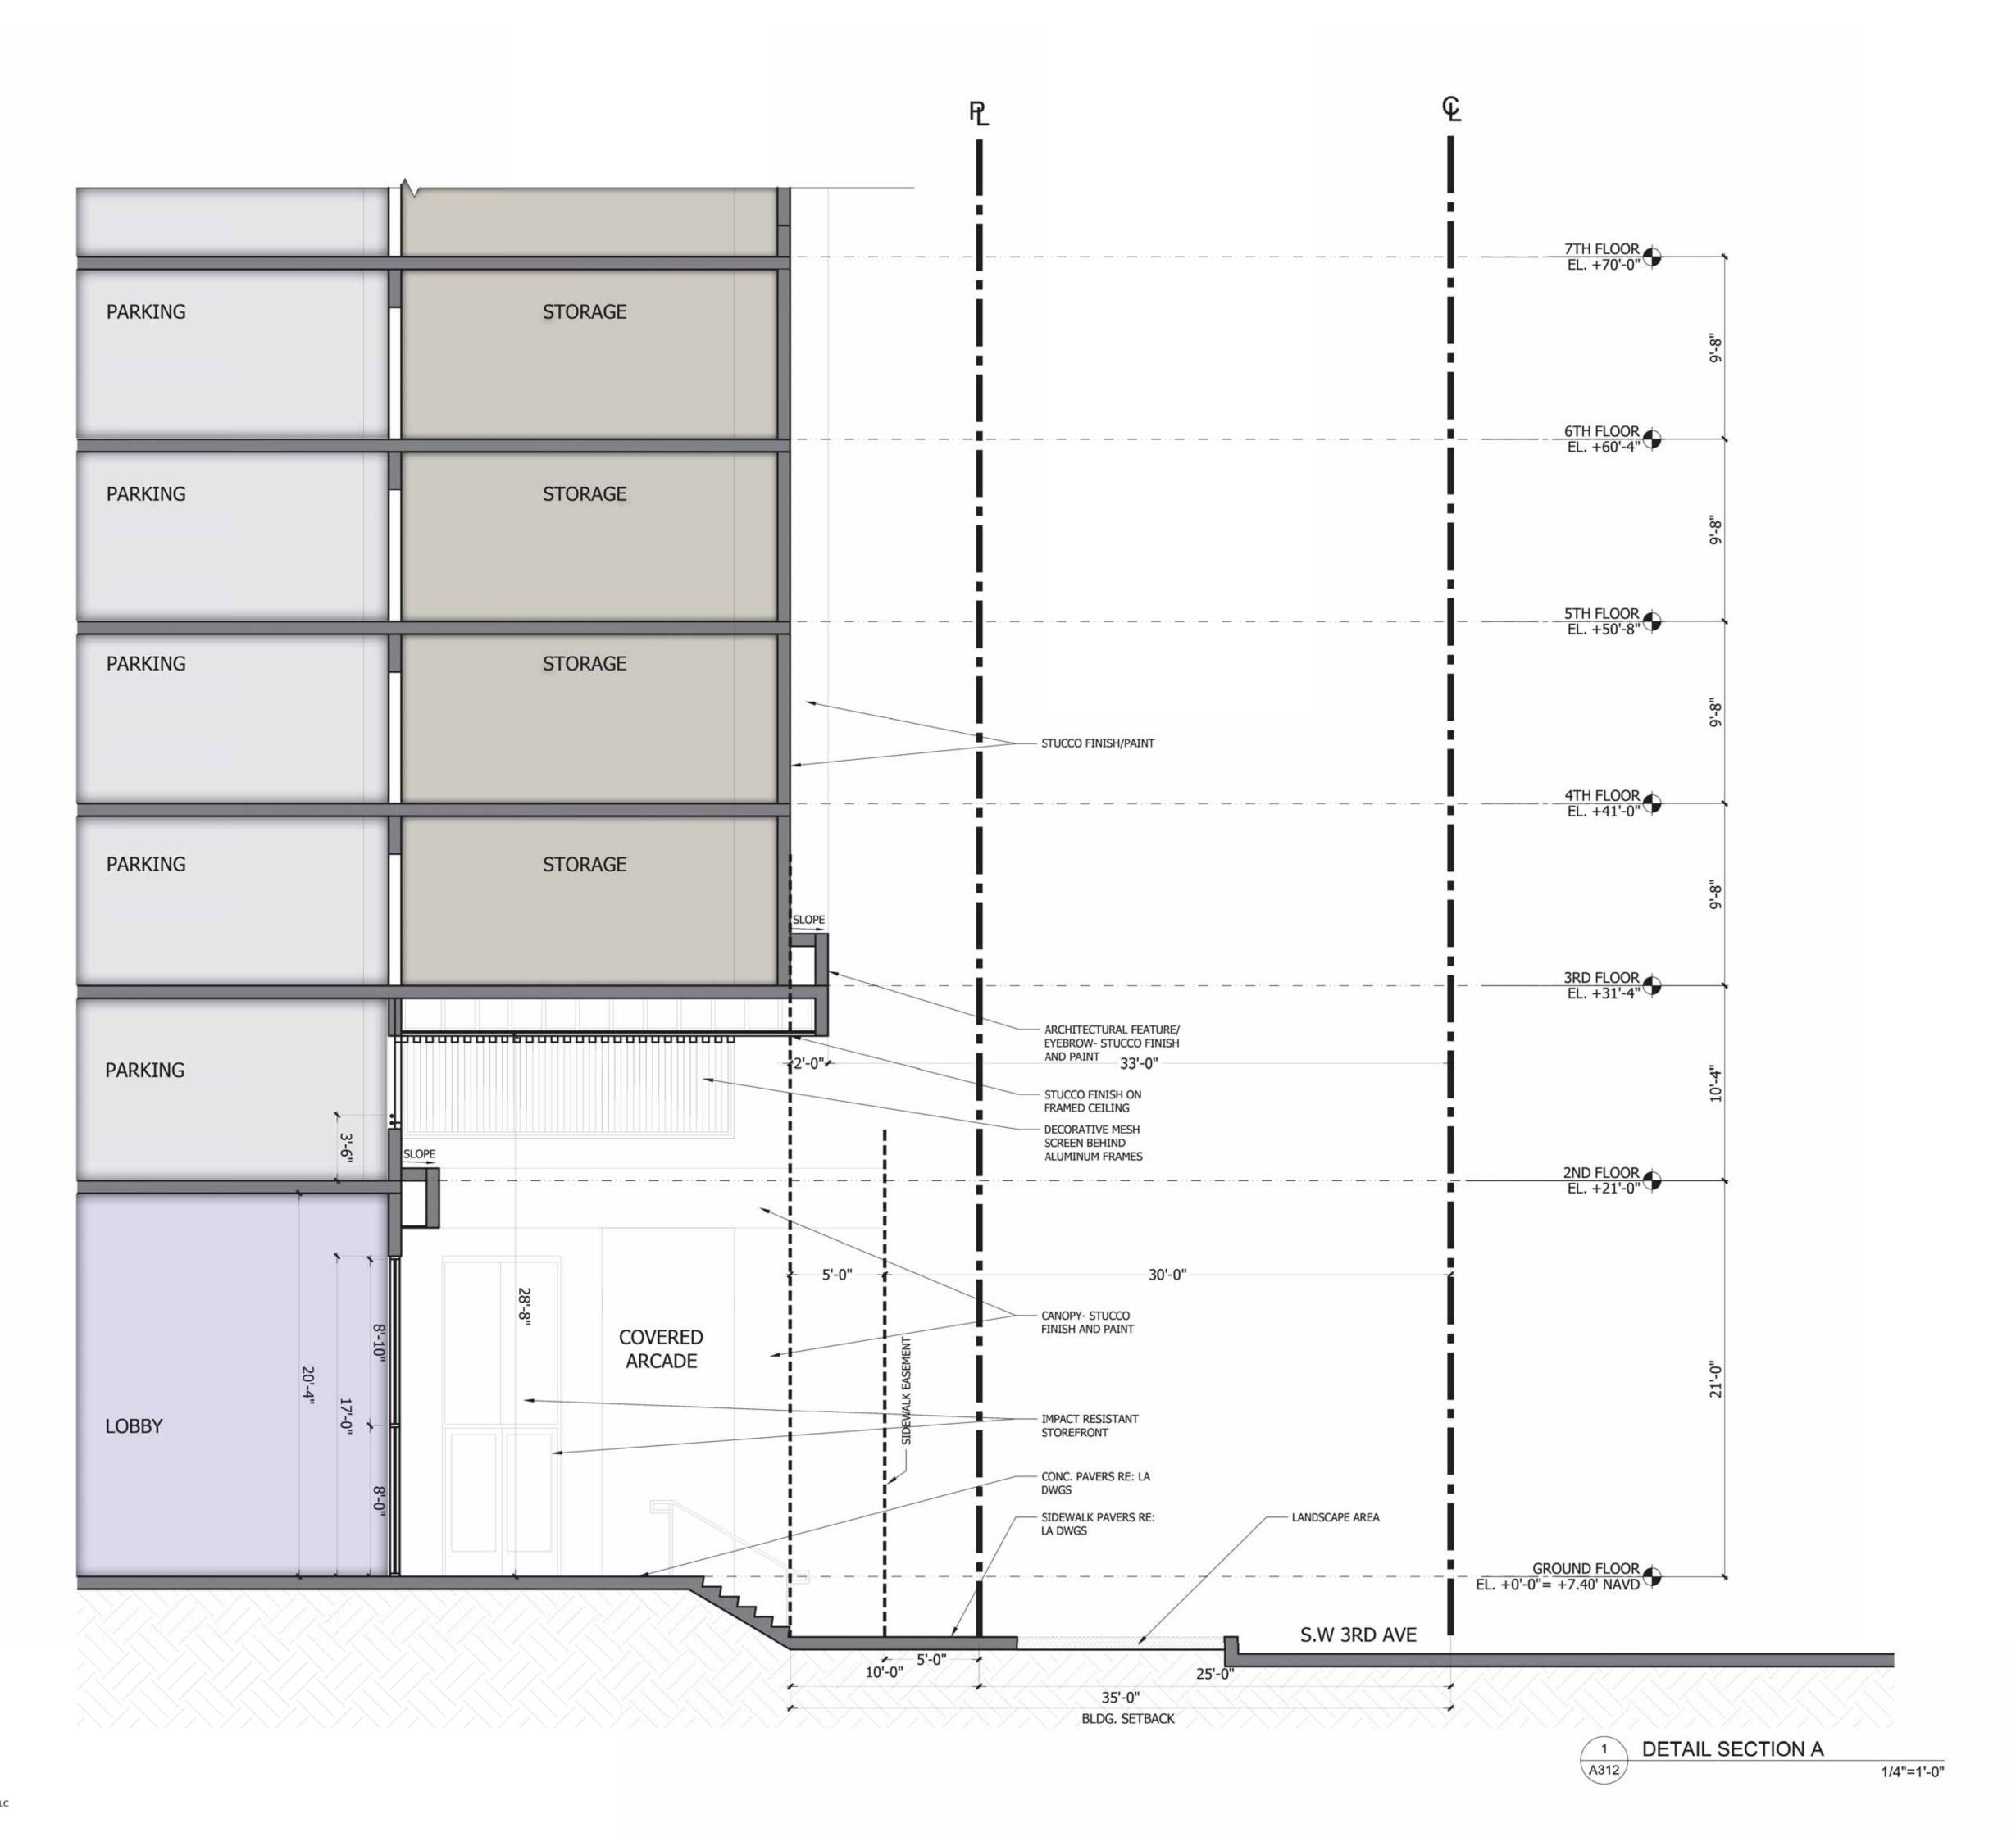
No: Issue

Date

ARTHAUS
FORT LAUDERDALE, FLORIDA
ALL RIGHTS RESERVED

ON B


SECTION B
Job No.: Drawn:



VICTOR K. YUE AR 0013087

Y □ □ VAS TO BE **ARTHAUS**

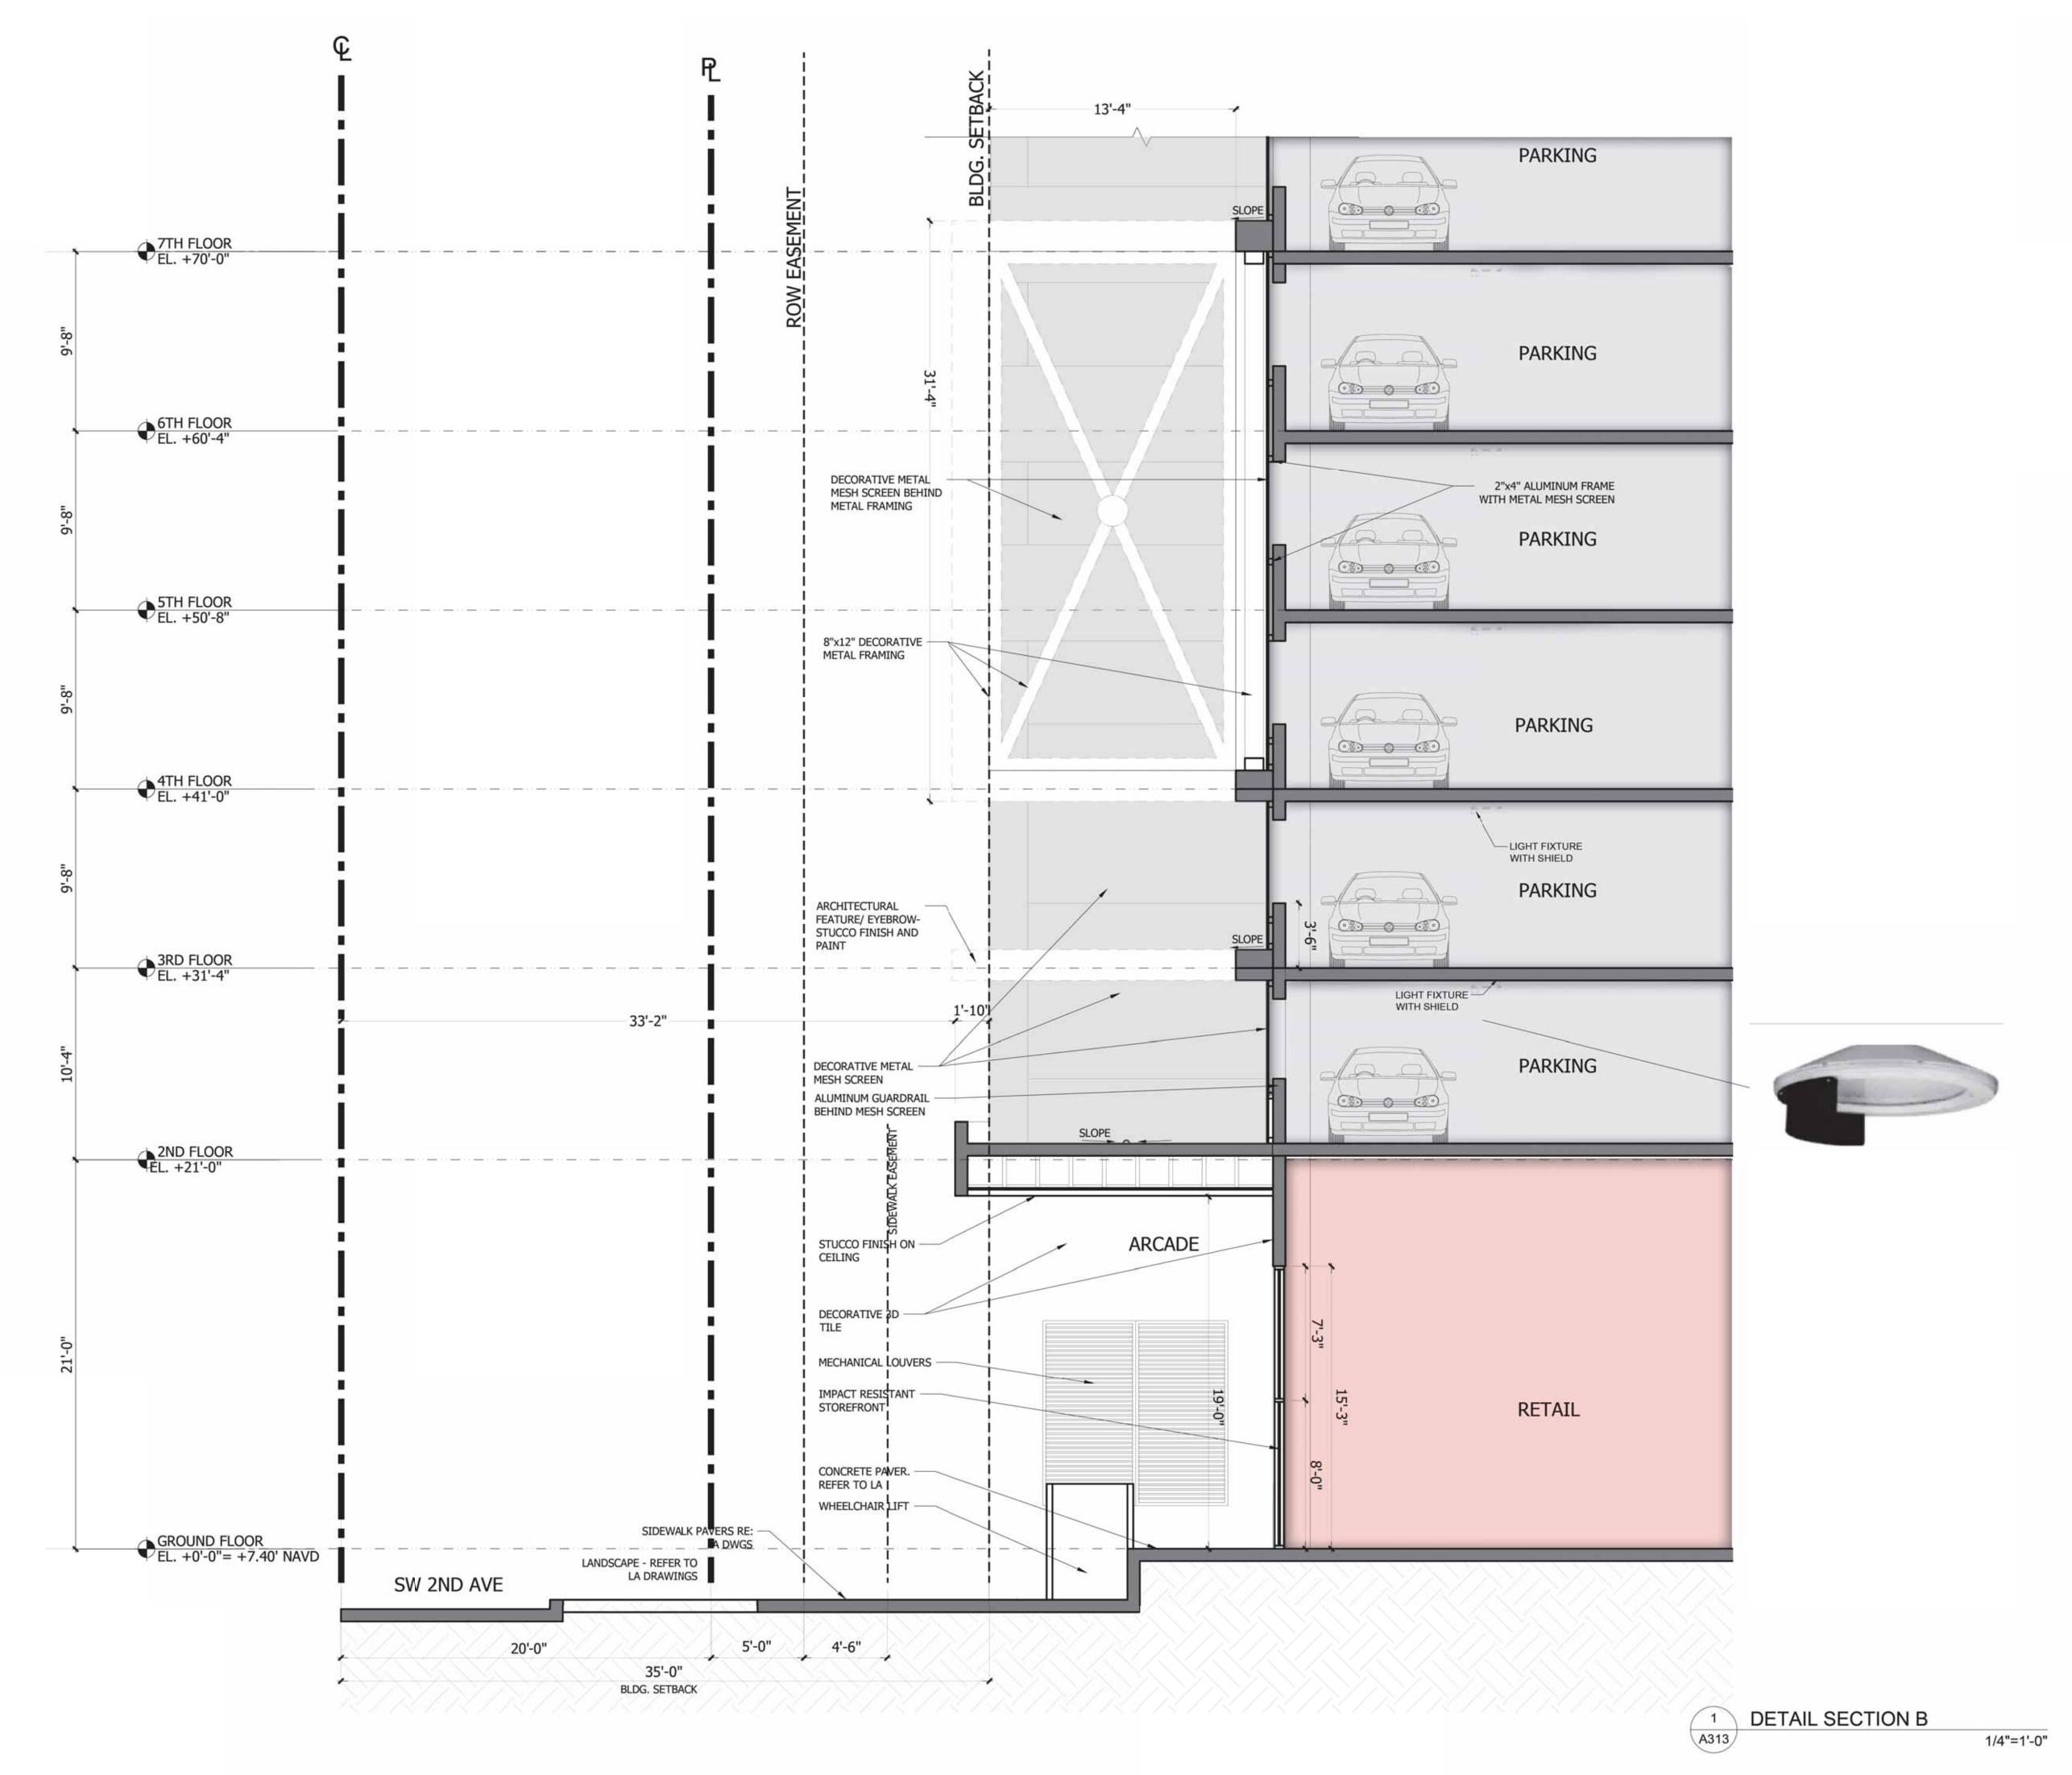DETAIL SECTION A




VICTOR K. YUE AR 0013087


AR0013087 No: Issue Date

ARTHAUS FORT LAUDERDALE, FLORIDA

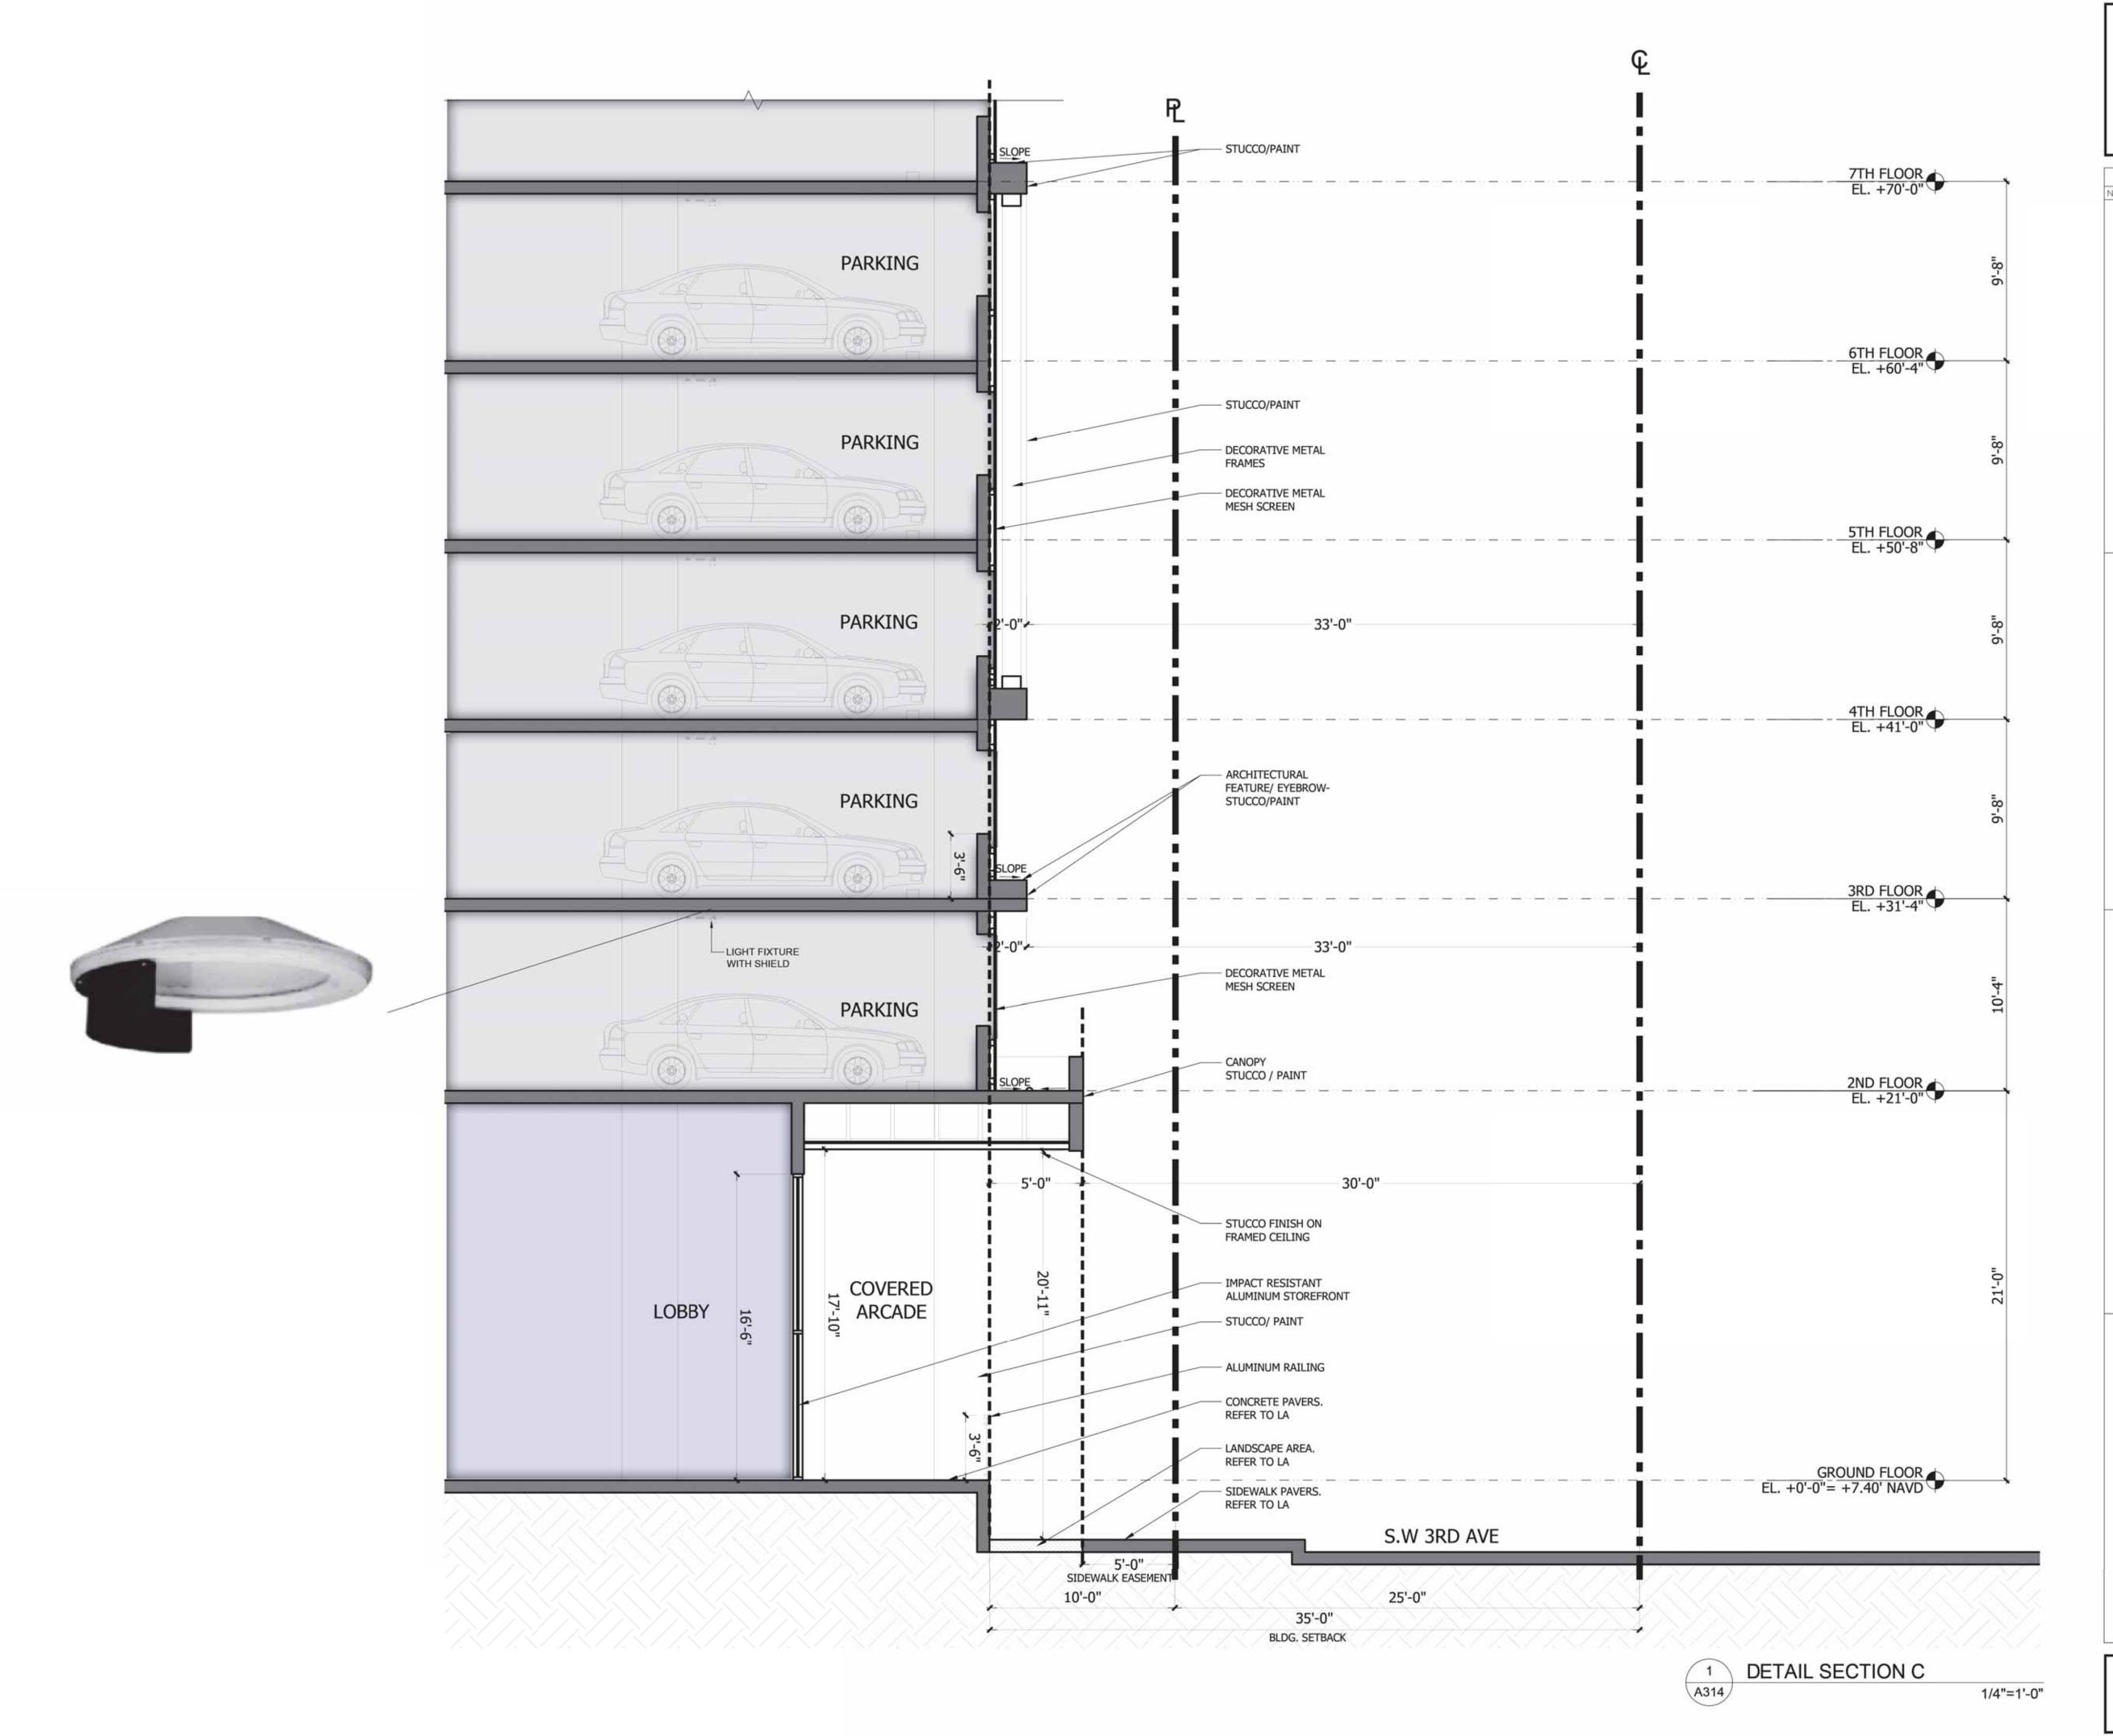DETAIL SECTION B



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DORSKY + YUE INTERNATIONAL ARCHITECTURE

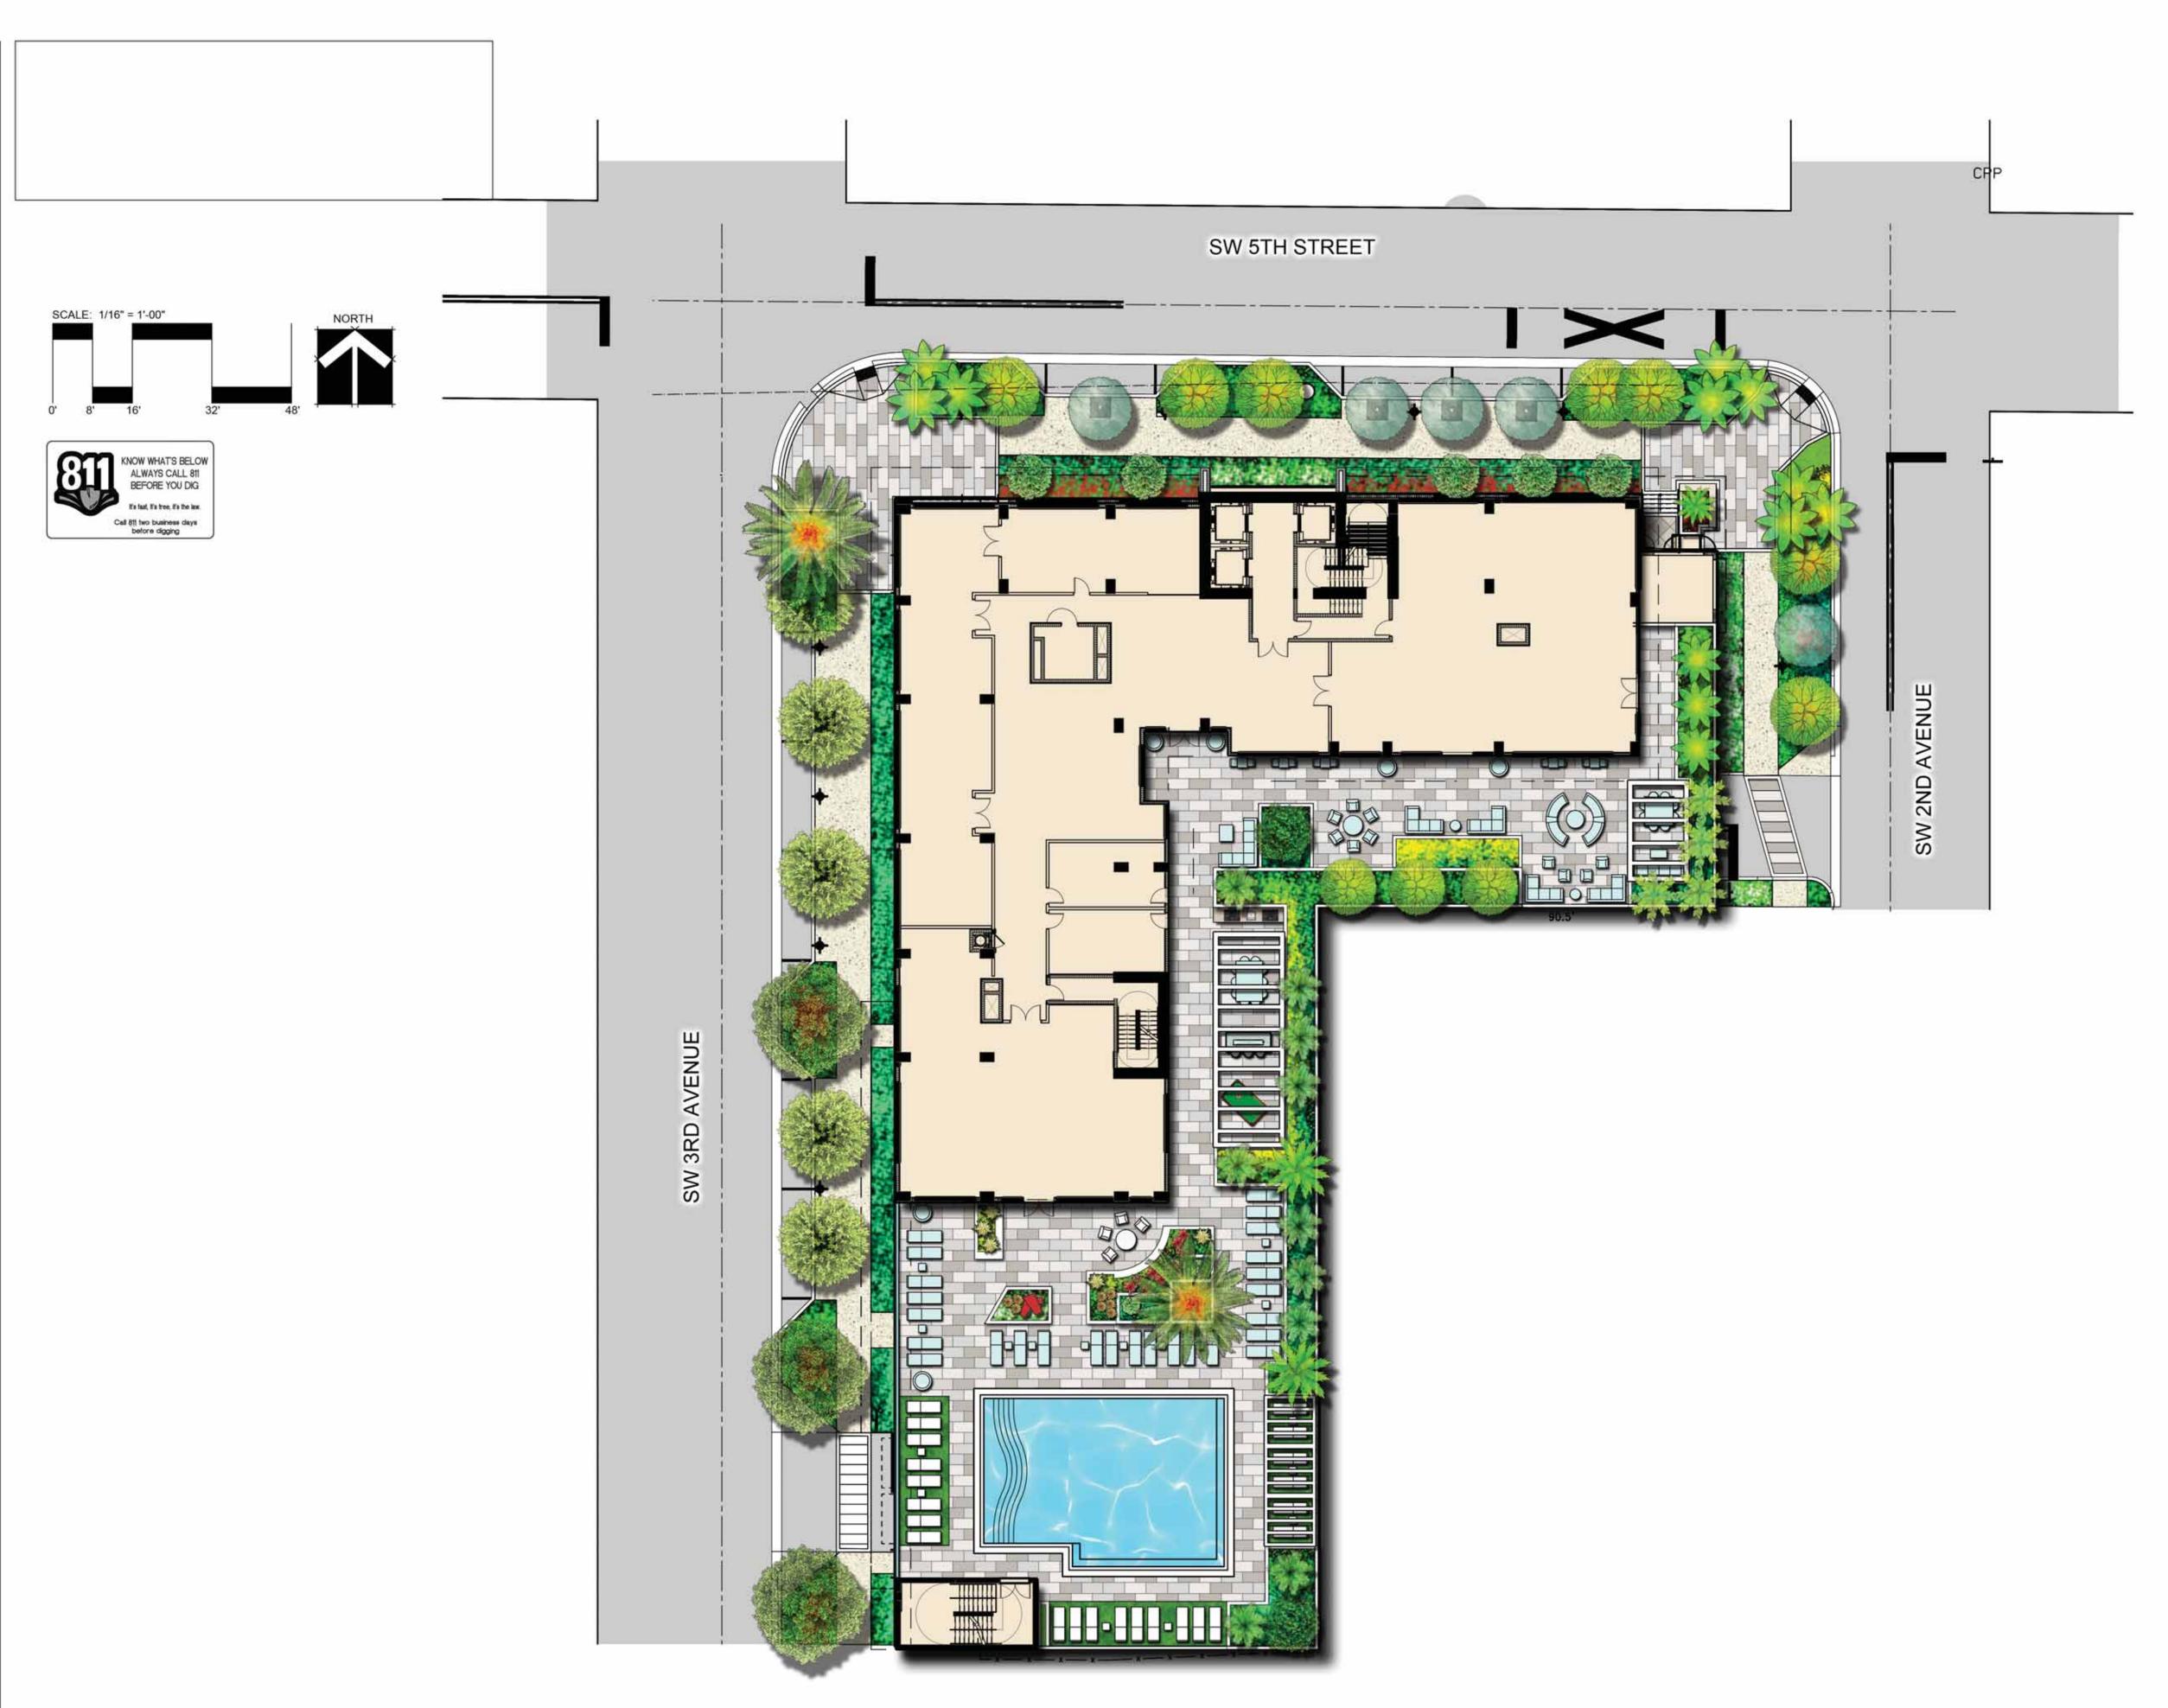ILLUSTRATIVE SITE PLAN **ARTHAUS** FORT LAUDERDALE, FLORIDA 500

Sheet Description

ILLUSTRATIVE SITE PLAN

Release Date 03-22-24

Project Number

Drawing Number

L-000


Sheet 1 OF 1


Existing Tree Survey 3/22/2024


Vetichia arecina	(EY BOTANTICAL NAME	COMMON NAME		O.A. HEIGHT	C.T. HEIGHT	SPREAD	CONDITION	CLASS	TOTAL PALM	TOTAL PALM	MITIGATION	PALM MITIGATION	TREE MITIGATION	DISPOSITION	COMMENTS
Veltchia arecina			(INCHES)	(FEET)	(FEET)	(FEET)	%	%	RELOCATED	REPLACEMENT	INCHES	COST	COST		
Velichia arecina	1 Veitchia arecina	Montgomery Palm	5	26		14	Fair			1					
Mangifera indica Mango 20 50 26 50% 60% 6 3390.00 REMOVE	2 Veitchia arecina	Montgomery Palm	5	26		14	Fair			1					
Lagerostroemia indica Crape Myrtle 5 12 7 52% 60% 2 88MOVE	3 Veitchia arecina	Montgomery Palm	5	26		14	Fair			1					
Cocos nuclfera Coconut Palm 8	4 Mangifera indica	Mango	20	50		26	50%	60%			6		\$390.00	REMOVE	
Sabal Palmetto Sabal Palm 20 16 13 Fair 1	5 Lagerostroemia indica	Crape Myrtle	5	12		7	52%	60%			2			REMOVE	
Cocos nuclfera	6 Cocos nucifera	Coconut Palm	8	40	31	16	Fair					\$930		REMOVE	
Cocos nuclfera	7 Sabal Palmetto	Sabal Palm	20	16		13	Fair			1				REMOVE	
Cocos nucifera Coconut Palm 11 20 6 14 Good S180 REMOVE	8 Cocos nucifera	Coconut Palm	8	38	30	16	Fair					\$900		REMOVE	
Bursera simaruba Gumbo Limbo 18 20 19 67% 100% 13 \$845.00 REMOVE SEE ARBORIST REI Bursera simaruba Gumbo Limbo 12 20 14 47% 100% 6 \$399.00 REMOVE Bursera simaruba Gumbo Limbo 12 20 14 47% 100% 6 \$399.00 REMOVE Bursera simaruba Gumbo Limbo 10 40 16 37% REMOVE Bursera simaruba Gumbo Limbo 8 30 18 70% 100% 6 \$399.00 REMOVE Bursera simaruba Gumbo Limbo 8 30 18 70% 100% 6 \$399.00 REMOVE Bursera simaruba Gumbo Limbo 8 30 18 70% 100% 6 \$399.00 REMOVE Bursera simaruba Gumbo Limbo 8 30 14 Fair 1 REMOVE Christmas Palm 3 20 14 Fair 1 REMOVE Cuercus laurifolia Laureal Oak 26 50 30 60% 60% 10 \$650.00 REMOVE Cuercus laurifolia Laureal Oak 15 50 30 54% 60% 5 \$325.00 REMOVE Cuercus laurifolia Laureal Oak 15 50 30 54% 60% 5 \$325.00 REMOVE Cuercus laurifolia Laureal Oak 15 50 30 54% 60% 5 \$325.00 REMOVE Cuercus laurifolia Cursel saurifolia Cursel saurifolia	9 Cocos nucifera	Coconut Palm	8	38	30	16	Fair					\$900		REMOVE	
Bursera simaruba Gumbo Limbo 12 20 14 47% 100% 6 \$390.00 REMOVE	10 Cocos nucifera	Coconut Palm	11	20	6	14	Good					\$180		REMOVE	
Quercus laurifolia Laureal Oak 23 50 27 55% 60% 8 \$520.00 REMOVE SEE ARBORIST REI Thuja occidentalis Arborvitae 10 40 40 16 37%	11 Bursera simaruba	Gumbo Limbo	18	20		19	67%	100%			13		\$845.00	REMOVE	SEE ARBORIST REPORT
Thuja occidentalis	12 Bursera simaruba	Gumbo Limbo	12	20		14	47%	100%			6		\$390.00	REMOVE	
Bursera simaruba Gumbo Limbo 8 30 18 70% 100% 6 \$390.00 REMOVE	13 Quercus laurifolia	Laureal Oak	23	50		27	55%	60%			8		\$520.00	REMOVE	SEE ARBORIST REPORT
Delonix regia Royal Poinciana 17 40 42 62% 80% 9 \$585.00 REMOVE	14 Thuja occidentalis	Arborvitae	10	40		16	37%							REMOVE	CONDITION RATING F - 0%
Adonidia merrillii Christmas Palm 3 20 14 Fair 1 1 REMOVE Quercus laurifolia Laureal Oak 26 50 30 60% 60% 10 \$650.00 REMOVE SEE ARBORIST REI Quercus laurifolia Laureal Oak 15 50 30 54% 60% 5 \$325.00 REMOVE Adonidia merrillii Christmas Palm 4 20 14 Fair 1 REMOVE Sabal Palmetto Sabala Palmetto Sabala Palmetto Sabala Palmetto Sabala Palmetto 16 27 13 Fair 1 REMOVE Syagrus romanzoffiana Quen Palm 7 32 16 Fair 1 REMOVE REMOVE Bursera simaruba Gumbo Limbo 7 18 16 47% 100% 4 \$260.00 REMOVE Bursera simaruba Gumbo Limbo 10 19 20 46% 100% 5 \$325.00 REMOVE	15 Bursera simaruba	Gumbo Limbo	8	30		18	70%	100%			6		\$390.00	REMOVE	
Quercus laurifolia Laureal Oak 26 50 30 60% 60% 10 \$650.00 REMOVE	16 Delonix regia	Royal Poinciana	17	40		42	62%	80%			9		\$585.00	REMOVE	
Quercus laurifolia Laureal Oak 15 50 30 54% 60% 5 \$325.00 REMOVE Adonidia merrillii Christmas Palm 4 20 14 Fair 1 REMOVE Sabal Palmetto Sabal Palm 16 27 13 Fair 1 REMOVE Syagrus romanzoffiana Queen Palm 7 32 16 Fair 1 REMOVE Bursera simaruba Gumbo Limbo 7 18 16 47% 100% 4 \$260.00 REMOVE Bursera simaruba Gumbo Limbo 10 19 20 46% 100% 5 \$325.00 REMOVE Bursera simaruba Gumbo Limbo 10 19 20 46% 100% 5 \$325.00 REMOVE Quercus virginiana Live Oak 8 30 20 50% 100% 4 \$260.00 REMOVE Cocos nucifera Coconut Palm 8 40 30 16	17 Adonidia merrillii	Christmas Palm	3	20		14	Fair			1				REMOVE	
Adonidia merrillii Christmas Palm 4 20 14 Fair 1 REMOVE Sabal Palmetto Sabal Palm 16 27 13 Fair 1 REMOVE Syagrus romanzoffiana Queen Palm 7 32 16 Fair 1 REMOVE Bursera simaruba Gumbo Limbo 7 18 16 47% 100% 4 \$260.00 REMOVE Bursera simaruba Gumbo Limbo 10 19 20 46% 100% 5 \$325.00 REMOVE Quercus virginiana Live Oak 8 30 20 50% 100% 4 \$260.00 REMOVE Cocos nucifera Coconut Palm 8 40 30 16 Fair \$900 REMOVE Cocos nucifera Coconut Palm 8 40 30 16 Fair \$900 REMOVE Cocos nucifera Coconut Palm 6 30 20 16 Fair \$600 R	18 Quercus laurifolia	Laureal Oak	26	50		30	60%	60%			10		\$650.00	REMOVE	SEE ARBORIST REPORT
Sabal Palmetto Sabal Palm 16 27 13 Fair 1 REMOVE Syagrus romanzoffiana Queen Palm 7 32 16 Fair 1 REMOVE Bursera simaruba Gumbo Limbo 7 18 16 47% 100% 4 \$260.00 REMOVE Bursera simaruba Gumbo Limbo 10 19 20 46% 100% 5 \$325.00 REMOVE Quercus virginiana Live Oak 8 30 20 50% 100% 4 \$260.00 REMOVE Cocos nucifera Coconut Palm 8 40 30 16 Fair \$900 REMOVE Cocos nucifera Coconut Palm 8 40 30 16 Fair \$900 REMOVE Cocos nucifera Coconut Palm 6 30 20 16 Fair \$600 REMOVE Ficus lyrata Fiddle leaf 14 40 26 48% 60% 5	19 Quercus laurifolia	Laureal Oak	15	50		30	54%	60%			5		\$325.00	REMOVE	
Syagrus romanzoffiana Queen Palm 7 32 16 Fair 1 REMOVE Bursera simaruba Gumbo Limbo 7 18 16 47% 100% 4 \$260.00 REMOVE Bursera simaruba Gumbo Limbo 10 19 20 46% 100% 5 \$325.00 REMOVE Quercus virginiana Live Oak 8 30 20 50% 100% 4 \$260.00 REMOVE Cocos nucifera Coconut Palm 8 40 30 16 Fair \$900 REMOVE Cocos nucifera Coconut Palm 8 40 30 16 Fair \$900 REMOVE Cocos nucifera Coconut Palm 6 30 20 16 Fair \$600 REMOVE Ficus lyrata Fiddle leaf 14 40 26 48% 60% 5 \$325.00 REMOVE Mangifera indica Mango 20 50 27 53%	20 Adonidia merrillii	Christmas Palm	4	20		14	Fair			1				REMOVE	
Bursera simaruba Gumbo Limbo 7 18 16 47% 100% 4 \$260.00 REMOVE Bursera simaruba Gumbo Limbo 10 19 20 46% 100% 5 \$325.00 REMOVE Quercus virginiana Live Oak 8 30 20 50% 100% 4 \$260.00 REMOVE Cocos nucifera Coconut Palm 8 40 30 16 Fair \$900 REMOVE Cocos nucifera Coconut Palm 8 40 30 16 Fair \$900 REMOVE Cocos nucifera Coconut Palm 8 40 30 16 Fair \$900 REMOVE Ficus lyrata Fiddle leaf 14 40 26 48% 60% 5 \$325.00 REMOVE Mangifera indica Mango 20 50 27 53% 60% 7 \$455.00 REMOVE	21 Sabal Palmetto	Sabal Palm	16	27		13	Fair			1				REMOVE	
Bursera simaruba Gumbo Limbo 10 19 20 46% 100% 5 \$325.00 REMOVE Quercus virginiana Live Oak 8 30 20 50% 100% 4 \$260.00 REMOVE Cocos nucifera Coconut Palm 8 40 30 16 Fair \$900 REMOVE Cocos nucifera Coconut Palm 8 40 30 16 Fair \$900 REMOVE Cocos nucifera Coconut Palm 6 30 20 16 Fair \$600 REMOVE Ficus lyrata Fiddle leaf 14 40 26 48% 60% 5 \$325.00 REMOVE Mangifera indica Mango 20 50 27 53% 60% 7 \$455.00 REMOVE	22 Syagrus romanzoffiana	Queen Palm	7	32		16	Fair			1				REMOVE	
Quercus virginiana Live Oak 8 30 20 50% 100% 4 \$260.00 REMOVE Cocos nucifera Coconut Palm 8 40 30 16 Fair \$900 REMOVE Cocos nucifera Coconut Palm 8 40 30 16 Fair \$900 REMOVE Cocos nucifera Coconut Palm 6 30 20 16 Fair \$600 REMOVE Ficus lyrata Fiddle leaf 14 40 26 48% 60% 5 \$325.00 REMOVE Mangifera indica Mango 20 50 27 53% 60% 7 \$455.00 REMOVE	23 Bursera simaruba	Gumbo Limbo	7	18		16	47%	100%			4		\$260.00	REMOVE	
Cocos nucifera Coconut Palm 8 40 30 16 Fair \$900 REMOVE Cocos nucifera Coconut Palm 8 40 30 16 Fair \$900 REMOVE Cocos nucifera Coconut Palm 6 30 20 16 Fair \$600 REMOVE Ficus lyrata Fiddle leaf 14 40 26 48% 60% 5 \$325.00 REMOVE Mangifera indica Mango 20 50 27 53% 60% 7 \$455.00 REMOVE	24 Bursera simaruba	Gumbo Limbo	10	19		20	46%	100%			5		\$325.00	REMOVE	
Cocos nucifera Coconut Palm 8 40 30 16 Fair \$900 REMOVE Cocos nucifera Coconut Palm 6 30 20 16 Fair \$600 REMOVE Ficus lyrata Fiddle leaf 14 40 26 48% 60% 5 \$325.00 REMOVE Mangifera indica Mango 20 50 27 53% 60% 7 \$455.00 REMOVE	25 Quercus virginiana	Live Oak	8	30		20	50%	100%			4		\$260.00	REMOVE	
Cocos nucifera Coconut Palm 6 30 20 16 Fair \$600 REMOVE Ficus lyrata Fiddle leaf 14 40 26 48% 60% 5 \$325.00 REMOVE Mangifera indica Mango 20 50 27 53% 60% 7 \$455.00 REMOVE	26 Cocos nucifera	Coconut Palm	8	40	30	16	Fair					\$900		REMOVE	
Ficus lyrata Fiddle leaf 14 40 26 48% 60% 5 \$325.00 REMOVE Mangifera indica Mango 20 50 27 53% 60% 7 \$455.00 REMOVE	27 Cocos nucifera	Coconut Palm	8	40	30	16	Fair					\$900		REMOVE	
Mangifera indica Mango 20 50 27 53% 60% 7 \$455.00 REMOVE	28 Cocos nucifera	Coconut Palm	6	30	20	16	Fair					\$600		REMOVE	
Mangifera indica Mango 20 50 27 53% 60% 7 \$455.00 REMOVE	35 Ficus lyrata	Fiddle leaf	14	40		26	48%	60%			5		\$325.00	REMOVE	
	36 Mangifera indica	Mango	20	50		27	53%	60%			7		\$455.00	REMOVE	
	38 Mangifera indica	Mango	20	50		27	50%	60%			6		\$390.00	REMOVE	

ARTHAUS TREE MITIGATION CALCULATIONS			
	REQUIRED	PROVIDED	REMAINING
1. INCHES REQUIRED TO BE MITIGATED.	96	80	10
2. C.T. REQUIRED FOR COCONUTS & ROYAL PALMS TO BE MITIGATED	177	14	16:
3. PALMS TO BE MITIGATED ON SITE AT 1:1 REPLACEMENT	8	8	

TOTAL TO BE DESPOSITED INTO TREE TRUST FUND			
	REQUIRED	COST	TOTAL
1. CALIPER INCHES NOT MITIGATED ON SITE	16	\$65.00	\$1,040.00
2. C.T. NOT MITIGATED ON SITE	163	\$30.00	\$4,890.0
3. PALMS NOT MITIGATED ON SITE	0	\$180.00	\$0.00
		TOTAL	\$5,930.00

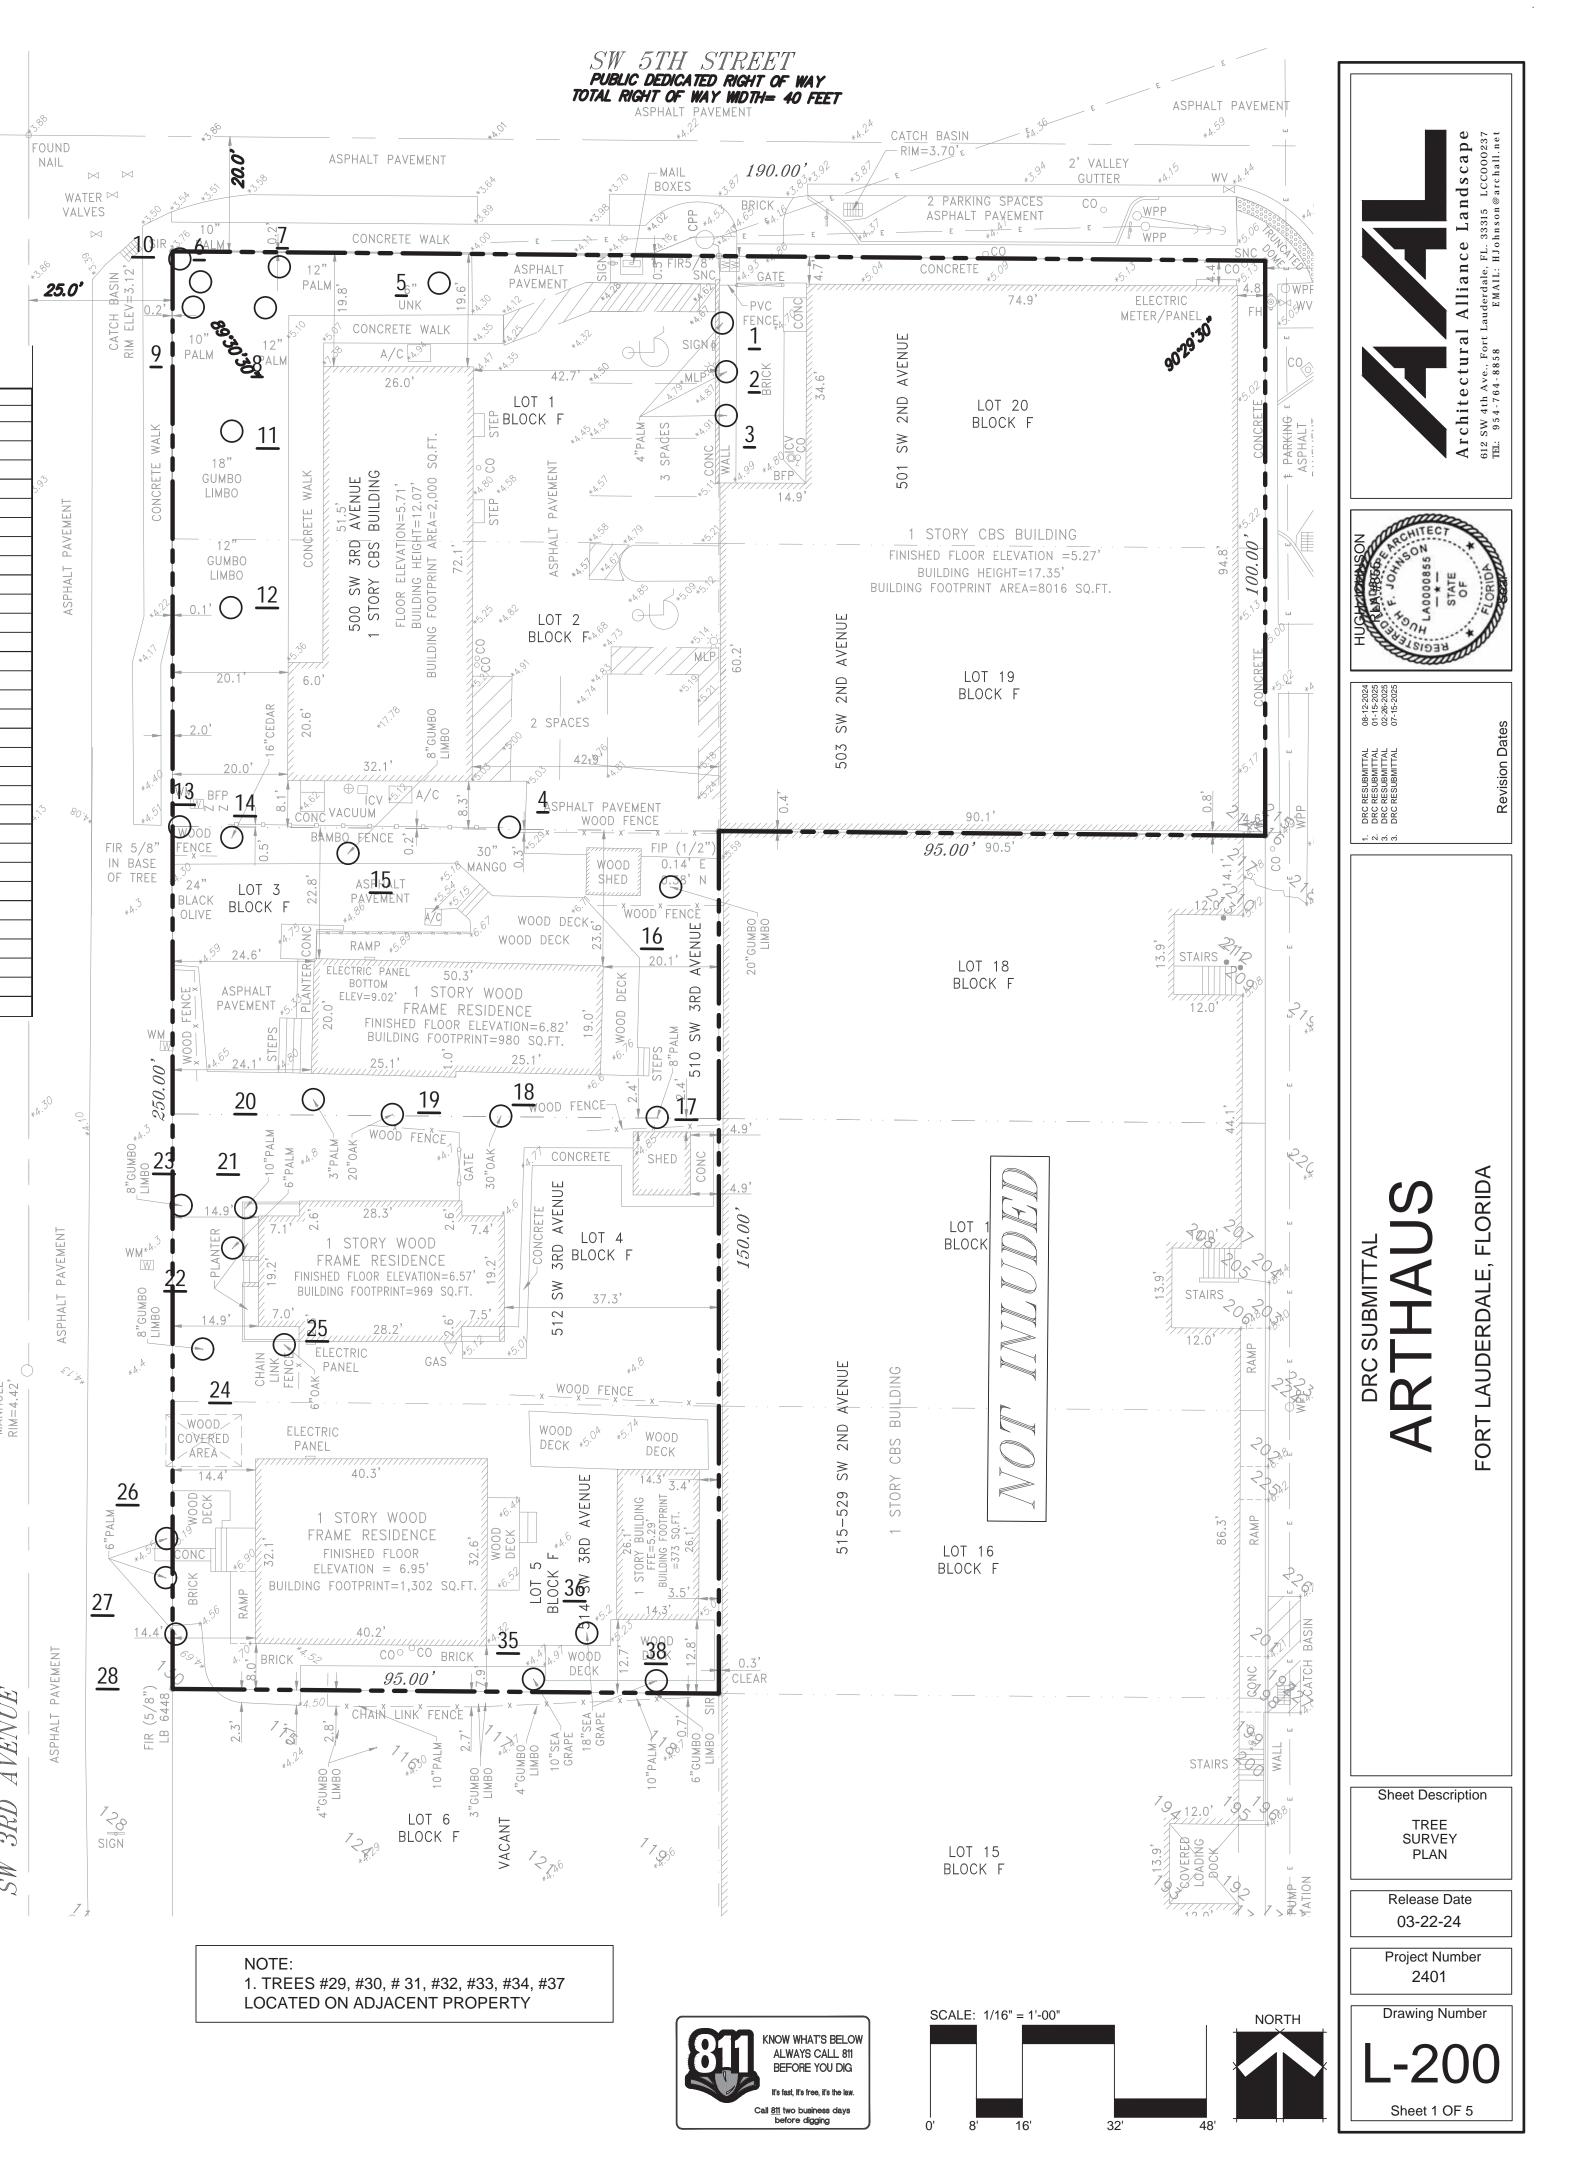

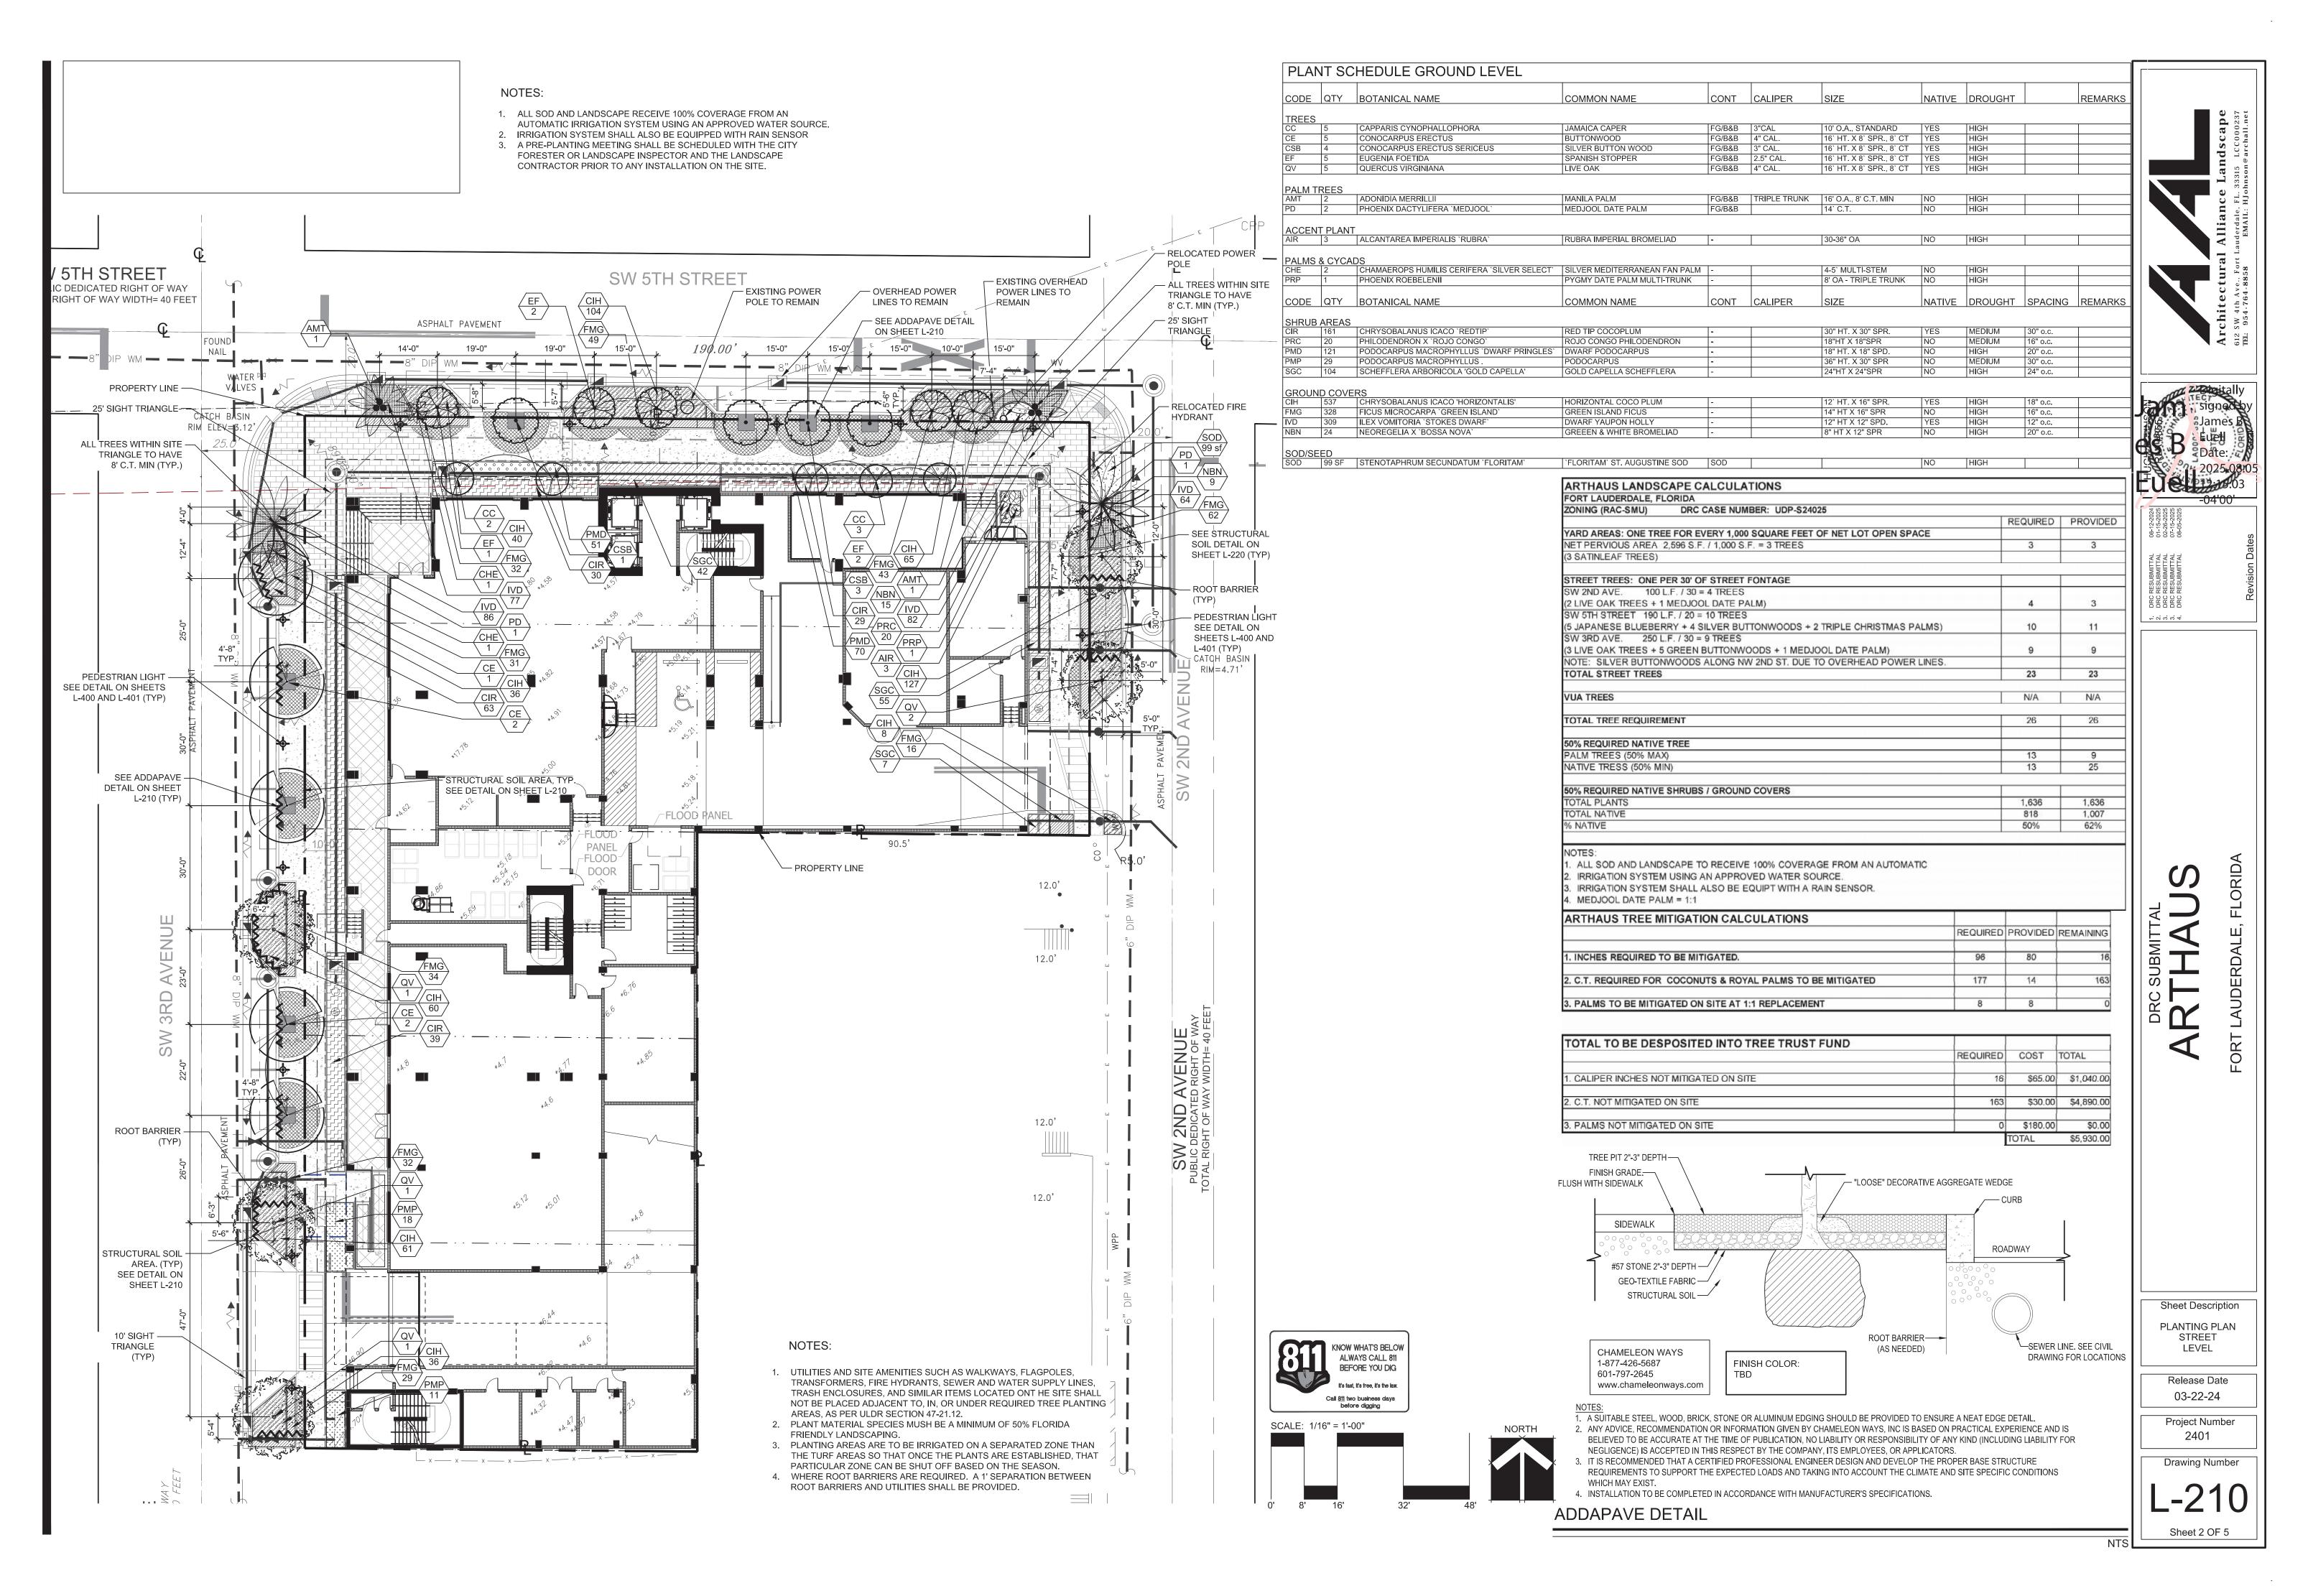

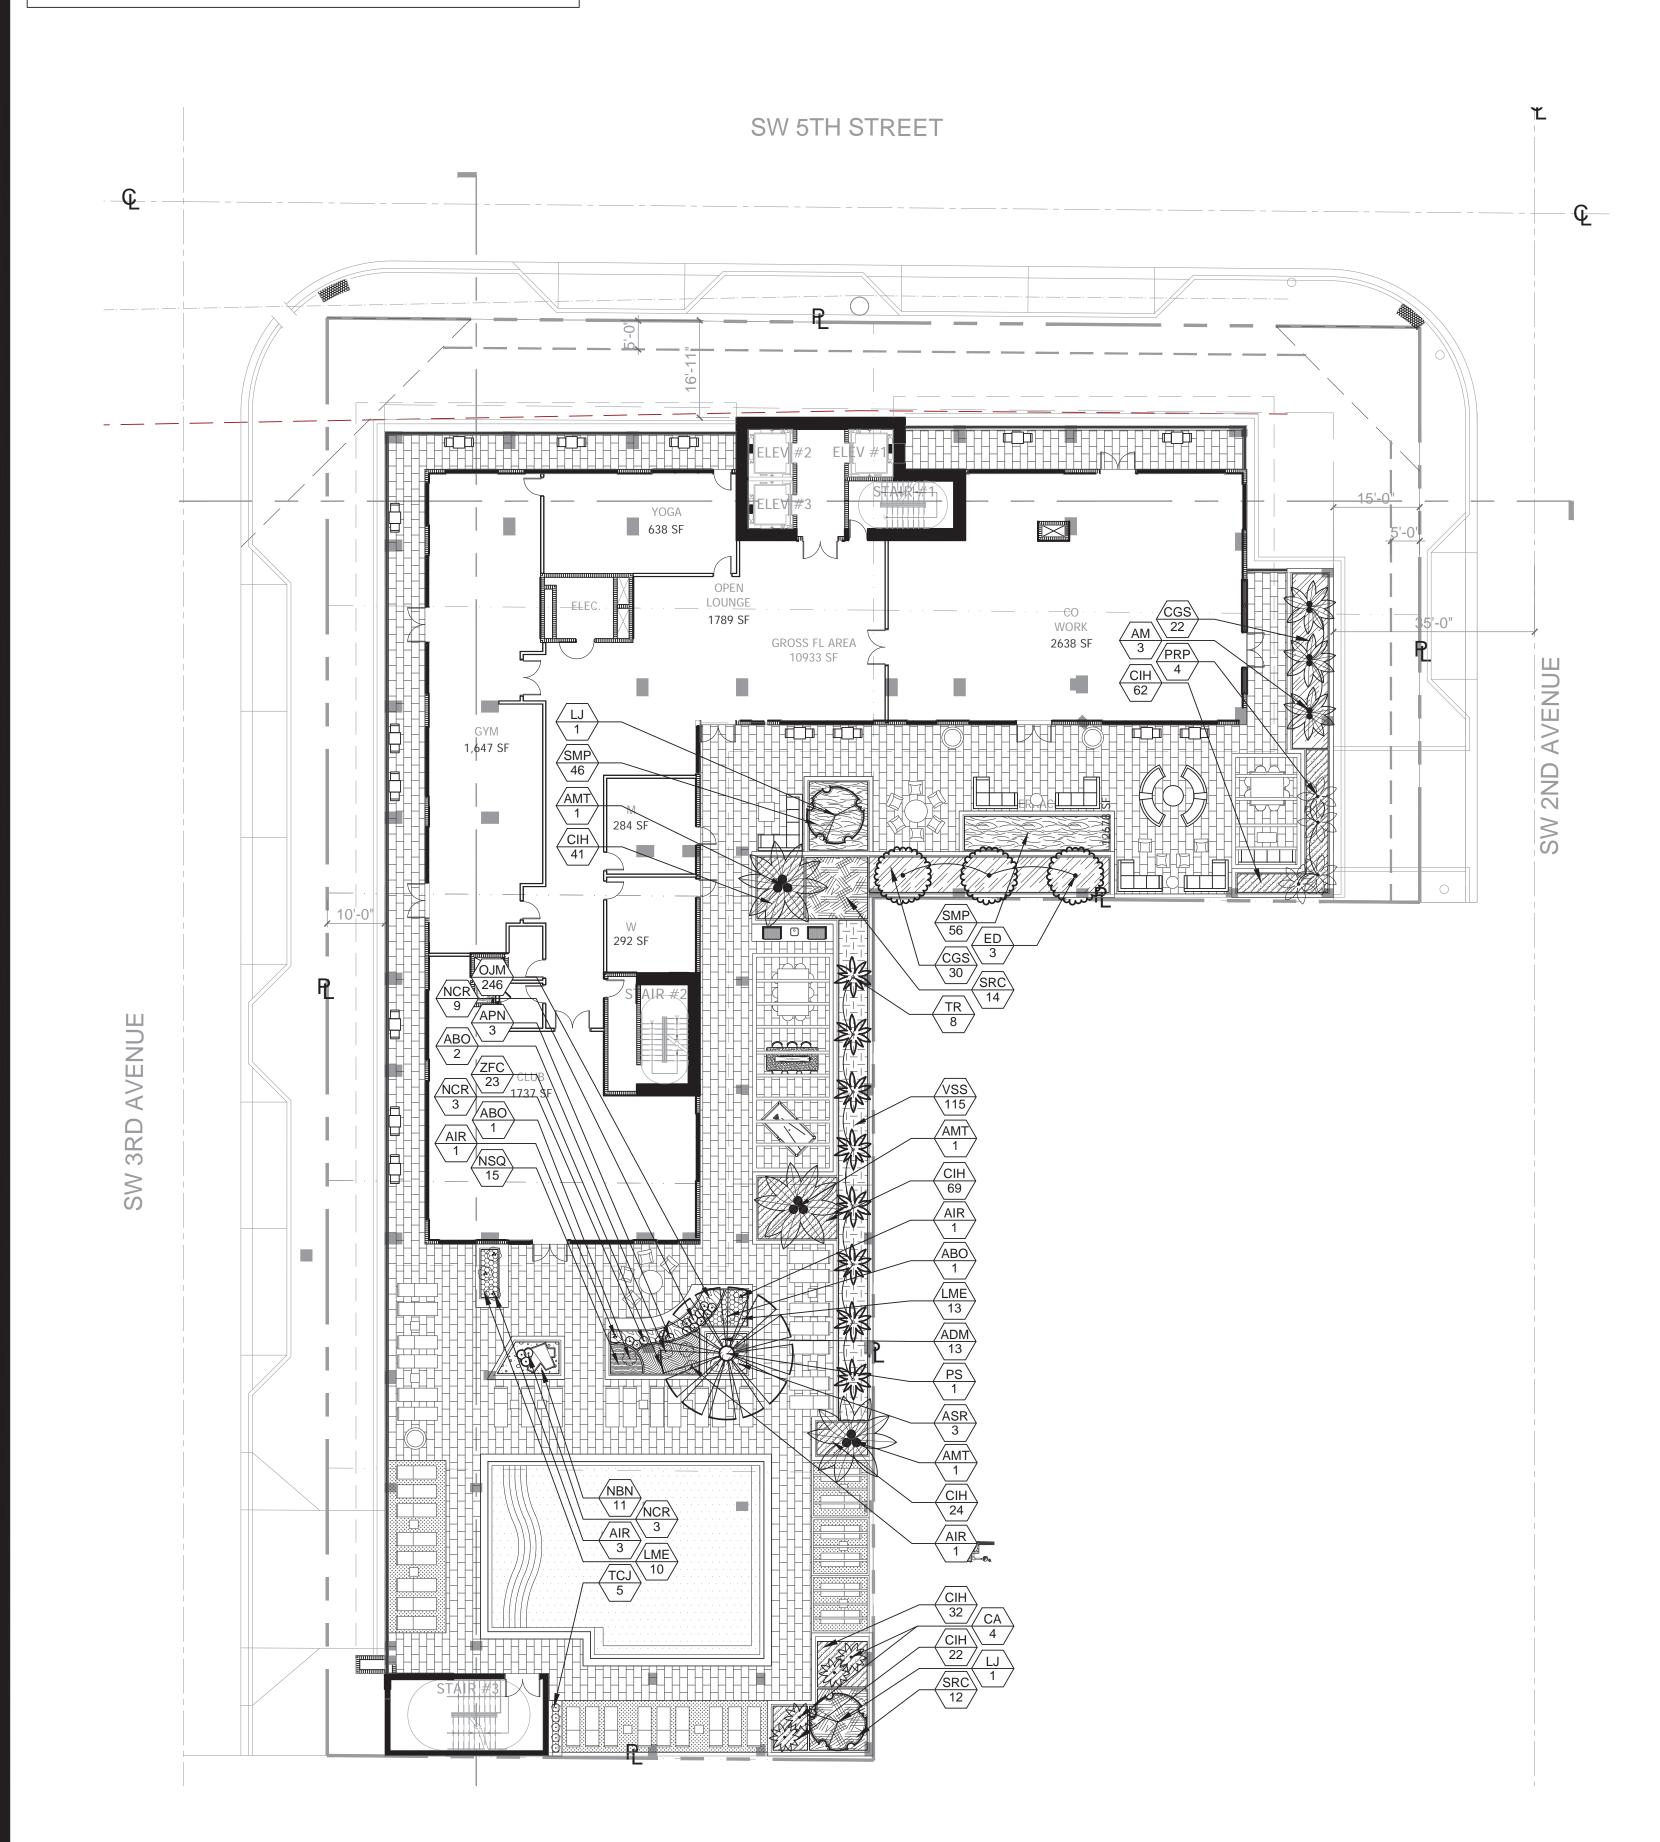


PLA	NT S	CHEDULE AMENITY LEVEL		_						
ODE	QTY	BOTANICAL NAME	COMMON NAME	CONT	CALIPER	SIZE	NATIVE	DROUGHT		REMAR
REES										
	3	ELAEOCARPUS DECIPIENS	JAPANESE BLUEBERRY TREE	FG/B&B	3" CAL.	12' O.A.	NO	HIGH		1
<u>-</u> 	2	LIGUSTRUM JAPONICUM	TREE LIGUSTRUM	FG/B&B	MULTI STEM	10` HT. X 8` SPR., 4"-5" CAL.	NO	MEDIUM	+	+
						,				
ALM ⁻	TREES									
/	3	ADONIDIA MERRILLII	MANILA PALM	FG/B&B	DOUBLES	5` GW., SPECIMEN	NO	HIGH		
ЛT	3	ADONIDIA MERRILLII	MANILA PALM	FG/B&B	TRIPLE TRUNK	16' O.A., 8' C.T. MIN	NO	HIGH		
١	4	COCCOTHRINAX ALTA	SILVER THATCH PALM	FG/B&B		4` OA	YES	HIGH		
3	1	PHOENIX SYLVESTRIS	WILD DATE PALM	FG/B&B		8' CT. NUT INC., FL FANCY	NO	HIGH		
2	8	THRINAX RADIATA	FLORIDA THATCH PALM	FG/B&B	SPECIMENS	6` OA, SINGLE TRUNK	YES	HIGH		
HRUE										
ВО	4	AECHMEA BLANCHETIANA	`BURNT ORANGE` BROMELIAD	-		30" OA	NO	MEDIUM		
CJ	5	TRACHELOSPERMUM JASMINOIDES `CONFEDERATE`	CONFEDERATE JASMINE	3 GAL		5` RUNNERS	NO	HIGH		ON GRID
CCEN	IT PLAN	IT								
PN	3	AECHMEA X 'PINOT NOIR'	PINOT NOIR BROMELIAD	-		20" HT	NO	HIGH		
R	6	ALCANTAREA IMPERIALIS `RUBRA`	RUBRA IMPERIAL BROMELIAD	-		30-36" OA	NO	HIGH		
SR	3	ANDROPOLIS SKINERII RED TIP BROMELIAD	RED ANDROPOLIS	-		24-28" OA	NO	HIGH		
CR	15	NEOMARICA CAERULEA 'REGINA'	REGINA WALKING IRIS	-		20" HT	NO	MEDIUM		
ΛΙ Ι .ΛΙ C	& CYC	ADS.								
RP	4	PHOENIX ROEBELENII	PYGMY DATE PALM MULTI-TRUNK	-		8' OA - TRIPLE TRUNK	NO	HIGH	Т	$\overline{}$
										+
ODE	QTY	BOTANICAL NAME	COMMON NAME	CONT	CALIPER	SIZE	NATIVE	DROUGHT	SPACING	REMAR
<u> </u>	1 ~	DO 17 H WO I LE TY HIVE	TO THE THE THE	100	JOYNEN EIN	0.22	110/1111/2	<u> Bittoooiii</u>	10.71010	11 (21)
HRUE	AREAS									
GS	52	CLUSIA GUTTIFERA	SMALL-LEAF CLUSIA	-		48" HT. X 36" SPR.	YES	HIGH	36" o.c.	1
ЛР	102	SABAL MINOR	DWARF PALMETTO	-		16" HT X 16" SPR	YES	HIGH	20" o.c.	
RC	26	SERENOA REPENS 'CINEREA'	SILVER SAW PALMETTO	-		24" HT X 24" SPR	YES	HIGH	36" o.c.	
SS	115	VIBURNUM SUSPENSUM	SANDANKWA VIBURNUM	-		20" HT. X 20" SPR.	NO	MEDIUM	24" o.c.	
ROU	ND COV									
DM	13	ASPARAGUS DENSIFLORUS `MYERS`	MYERS ASPARAGUS	-		18"HT X 18"SPR @	NO	MEDIUM	24" o.c.	
1	250	CHRYSOBALANUS ICACO 'HORIZONTALIS'	HORIZONTAL COCO PLUM	-		12` HT. X 16" SPR.	YES	HIGH	18" o.c.	
ΙE	23	LIRIOPE MUSCARI `EVERGREEN GIANT`	EVERGREEN GIANT LILYTURF	-		18" HT. X 18" SPD.	NO	HIGH	20" o.c.	
3N	11	NEOREGELIA X `BOSSA NOVA`	GREEEN & WHITE BROMELIAD	-		8" HT X 12" SPR	NO	HIGH	20" o.c.	
SQ	15	NEOREGELIA X `TEQUILA`	TEQUILA BROMELIAD	-		12" HT. X 12" SPR.	NO	HIGH	16" o.c.	
IM	246	OPHIOPOGON JAPONICUS	MONDO GRASS	-		4" HT.	NO	MEDIUM	6" o.c.	
) COVERS								


NOTES:

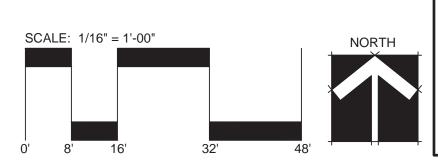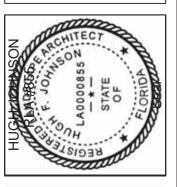- 1. ALL SOD AND LANDSCAPE RECEIVE 100% COVERAGE FROM AN AUTOMATIC IRRIGATION SYSTEM USING AN APPROVED WATER SOURCE.
- 2. IRRIGATION SYSTEM SHALL ALSO BE EQUIPPED WITH RAIN SENSOR
- 3. A PRE-PLANTING MEETING SHALL BE SCHEDULED WITH THE CITY FORESTER OR LANDSCAPE INSPECTOR AND THE LANDSCAPE CONTRACTOR PRIOR TO ANY INSTALLATION ON THE SITE.









DRC RESUBMITTAL 08-12-2024
DRC RESUBMITTAL 07-15-2025
DRC RESUBMITTAL 07-15-2025

3. DRC RES

RHAUS

Sheet Description
PLANTING PLAN
POOL DECK
LEVEL

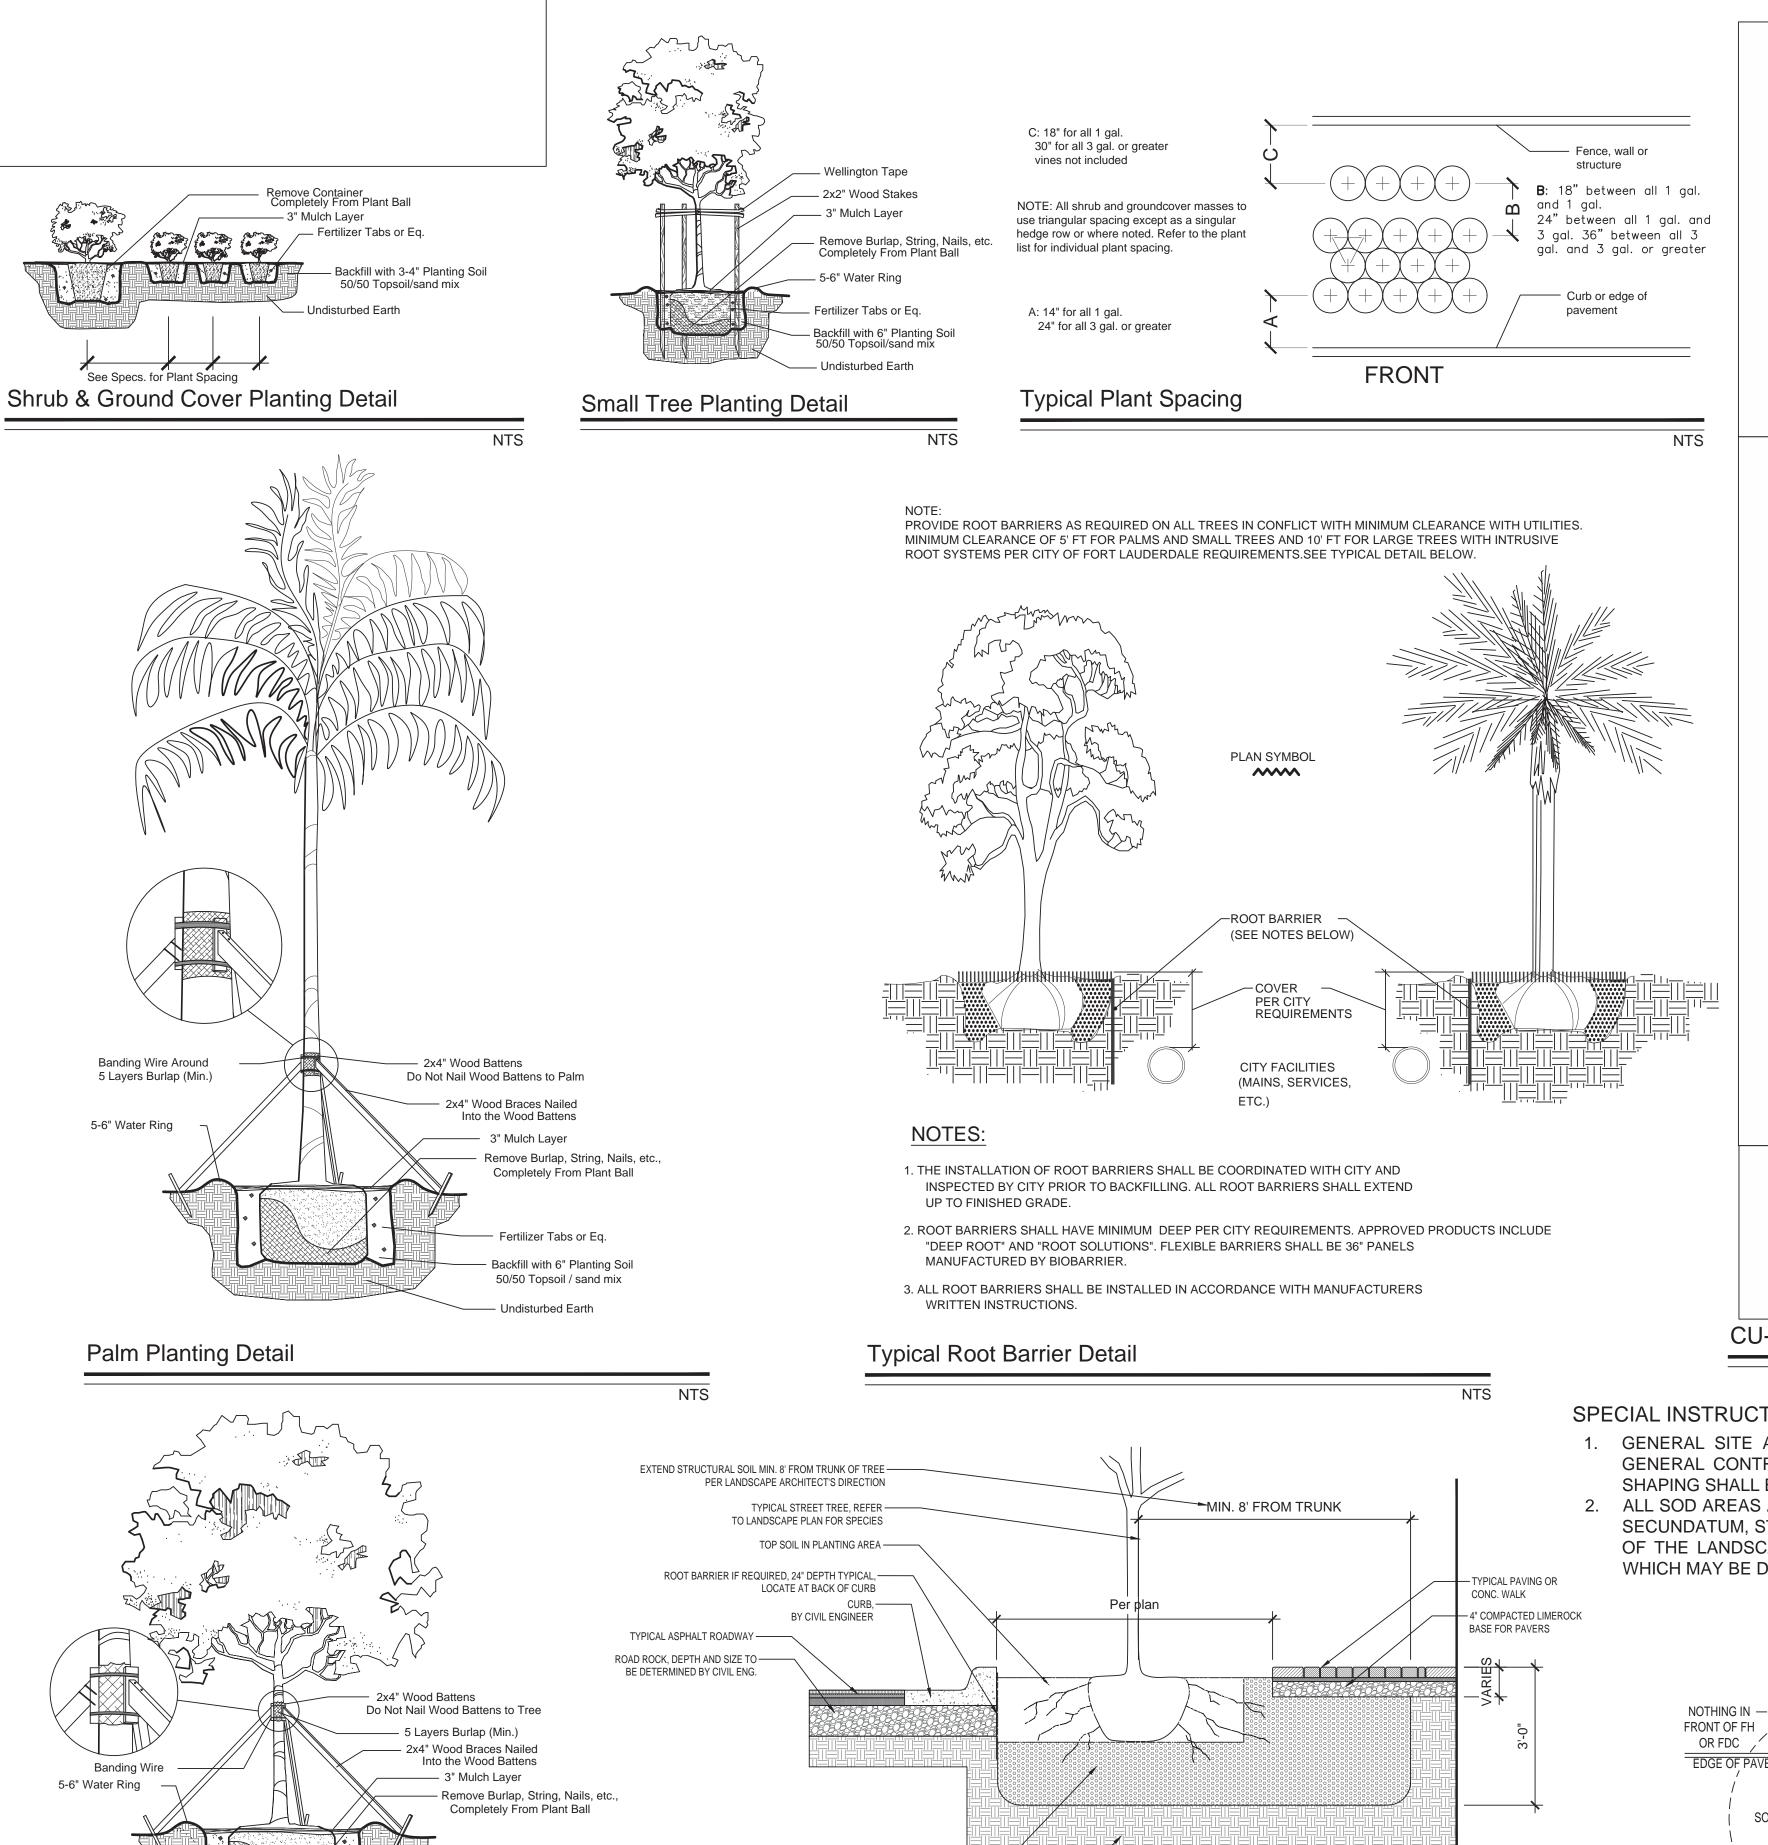
Release Date 03-22-24

Project Number 2401

Drawing Number

L-211

Shoot 3 OF 5



CU-STRUCTURAL SOIL, REFER TO SPECIFICATION -

MANUFACTURER'S INSTRUCTIONS.

PREPARED COMPACTED SUBGRADE, -

CU-STRUCTURAL SOIL DETAIL

REFER TO CIVIL ENGINEER'S DRAWINGS

ON THIS SHEET, EXTEND TO A DEPTH OF 36". INSTALL PER

Fertilizer Tabs or Eq.

Backfill with 6" Planting Soil

50/50 Topsoil / sand mix

Undisturbed Earth

Large Tree Planting Detail

CU-STRUCTURAL SOIL® SPECIFICATIONS PART 2 - MATERIALS

2.1 CLAY LOAM

A. Soil shall be a "loam" with a minimum clay content of 20% or a "clay loam" based on the "USDA classification system" as determined by mechanical analysis (ASTM D-422) and it shall be of uniform composition, without admixture of subsoil. It shall be free of stones, lumps, plants and their roots, debris and other extraneous matter. It shall not contain toxic substances harmful to plant growth. Clay loam shall contain not less than 2% or more than 5% organic matter as determined by the loss on ignition of oven-dried samples. Test samples shall be oven-dried to a constant weight at a temperature of 230 degrees F., plus or minus 9

B. Mechanical analysis for the loam or clay loam shall be as follows:

% of Total Weight less than 5% 20-45% 20-50% 20-40%

- C. Chemical analysis: Meet, or be amended to meet the following criteria:
- pH between 5.5 to 6.5
- 2. Percent organic matter 2% 5% by dry weight
- Adequate nutrient levels
- 4. Soluble salt less than 1.0 mmho/cm
- 5. Cation Exchange Capacity (CEC) greater than 10 Carbon/Nitrogen ratio less than 33:1
- D. Loam or clay loam shall not come from USDA classified prime farmland.

2.2 FERTILIZER (if needed)

2.3 SULFUR (if needed)

A. Should nutrient analysis suggest that the loam or clay loam need additional nutrients, it shall be amended by Amereq's licensed producer.

- A. Sulfur shall be a commercial granular, 96% pure sulfur, with material and analysis appearing on the labeled container.
- B. Sulfur used to lower pH shall be a ferrous sulfate formulation.
- C. Application rates shall be dependent on soil test results.

2.4 LIME (if needed)

 Agricultural lime containing a minimum of 85% carbonates. B. Application rates shall be dependent on soil test results.

- 2.5 CRUSHED STONE
- A. The size of the crushed stone shall be 0.75 inches to 1.5 inches allowing for up to 10% being greater than 1.5 inches, and up to 10% less than 0.75 inches.
- B. Acceptable aggregate dimensions will not exceed 2.5:1.0 for any two dimensions.
- C. Minimum 90% with two or more fractured faces.
- D. Results of Aggregate Soundness Loss test shall not exceed 18%.
- E. Losses from LA Abrasion tests shall not exceed 40%.

A. Hydrogel shall be a coated potassium propenoate-propenamide copolymer (Gelscape® Hydrogel Tackifier) as manufactured by Amereq, Inc. 800-832-8788.

2.7 WATER

A. The installing contractor shall be responsible to furnish his own supply of water (if needed) free of impurities, to the site.

2.8 CU-STRUCTURAL SOIL*

A. A uniformly blended urban tree mixture of crushed stone, clay loam and Gelscape Hydrogel Tackifier, as produced by an Amereq-licensed company, mixed in the following proportion:

> Unit of Weight 100 units dry weight specified crushed Stone 20-25 units (to achieve minimum CBR of 50) specified clay loam Gelscape® Hydrogel Tackifier 0.035 units dry weight ASTM D698/AASHTO T-99 optimum moisture

CU-STRUCTURAL SOIL SPECIFICATIONS

SPECIAL INSTRUCTIONS:

- 1. GENERAL SITE AND BERM GRADING TO +/- 1 INCH (1") SHALL BE PROVIDED BY THE GENERAL CONTRACTOR. ALL FINISHED SITE GRADING AND FINAL DECORATIVE BERM
- 2. ALL SOD AREAS AS INDICATED ON THE PLANTING PLAN SHALL RECEIVE STENOTAPHRUM SECUNDATUM, ST. AUGUSTINE 'PALMETTO' SOLID SOD. IT SHALL BE THE RESPONSIBILITY OF THE LANDSCAPE CONTRACTOR TO INCLUDE IN THE BID, THE REPAIR OF ANY SOD

- SHAPING SHALL BE PROVIDED BY THE LANDSCAPE CONTRACTOR.
- WHICH MAY BE DAMAGED FROM THE LANDSCAPE INSTALLATION OPERATIONS.

FRONT OF FH OR FDC EDGE OF PAVEMEN 7'-6"R SOD only FIRE HYDRANT CLEAR ZONE

TREE LOCATIONS TO BE COORDINATED IN FIELD AS TO NOT FALL IN CONFLICT WITH FH., FDC.'s, BFP's AND TRANSFORMERS

FIRE HYDRANT CLEAR ZONE DETAIL

NOTES:

- 1. ALL SOD AND LANDSCAPE RECEIVE 100% COVERAGE FROM AN AUTOMATIC IRRIGATION SYSTEM USING AN APPROVED WATER SOURCE.
- 2. IRRIGATION SYSTEM SHALL ALSO BE EQUIPPED WITH RAIN SENSOR 3. A PRE-PLANTING MEETING SHALL BE SCHEDULED WITH THE CITY FORESTER

OR LANDSCAPE INSPECTOR AND THE LANDSCAPE CONTRACTOR PRIOR TO ANY INSTALLATION ON THE SITE.

GENERAL PLANTING REQUIREMENTS

All sizes shown for plant material on the plans are to be considered Minimum. All plant material must meet or exceed these minimum requirements for both height and spread. Any other requirements for specific shape or effect as noted on the plan(s) will also be required for final acceptance.

All plant material furnished by the landscape contractor shall be Florida #1 or better as established by "Grades and Standards for Florida Nursery Plants" and "Grades and Standards for Florida Nursery Trees". All material shall be installed as per CSI specifications.

All plant material as included herein shall be warrantied by the landscape contractor for a minimum period as follows: All trees and palms for 12 months, all shrubs, vines, groundcovers and miscellaneous planting materials for 90 days, and all lawn areas for 60 days after final acceptance by the owner or owner's representative.

All plant material shall be planted in planting soil that is delivered to the site in a clean loose and friable condition. All soil shall have a well drained characteristic. Soil must be free of all rocks, sticks, and objectionable material including weeds and weed seeds as per CSI specifications.

Twelve inches (12") of planting soil 50/50 sand/topsoil mix is required around and beneath the root ball of all trees and palms, and 1 cubic yard per 50 bedding or groundcover plants.

All landscape areas shall be covered with Eucalyptus or sterilized seed free Melaleuca mulch to a minimum depth of three inches (3") of cover when settled. A four-inch clear space must be left for air between plant bases and the mulch. Cypress bark mulch shall not be used.

All plant material shall be thoroughly watered in at the time of planting; no dry planting permitted. All plant materials shall be planted such that the top of the plant ball is flush with the surrounding grade.

All landscape and lawn areas shall be irrigated by a fully automatic sprinkler system adjusted to provide 100% coverage of all landscape areas. All heads shall be adjusted to 100% overlap as per manufacturers specifications and performance standards utilizing a rust free water source. Each system shall be installed with a rain sensor.

It is the sole responsibility of the landscape contractor to insure that all new plantings receive adequate water during the installation and during all plant warranty periods. Deep watering of all new trees and palms and any supplemental watering that may be required to augment natural rainfall and site irrigation is mandatory to insure proper plant development and shall be provided as a part of this contract.

All plant material shall be installed with fertilizer, which shall be State approved as a complete fertilizer containing the required minimum of trace elements in addition to N-P-K, of which 50% of the nitrogen shall be derived from an organic source as per CSI specifications.

Contractors are responsible for coordinating with the owners and appropriate public agencies to assist in locating and verifying all underground utilities prior to excavation.

All ideas, designs and plans indicated or represented by this drawing are owned by and are the exclusive property of AAL.

The plan takes precedence over the plant list.

Sheet Description LANDSCAPE **DETAILS & NOTES**

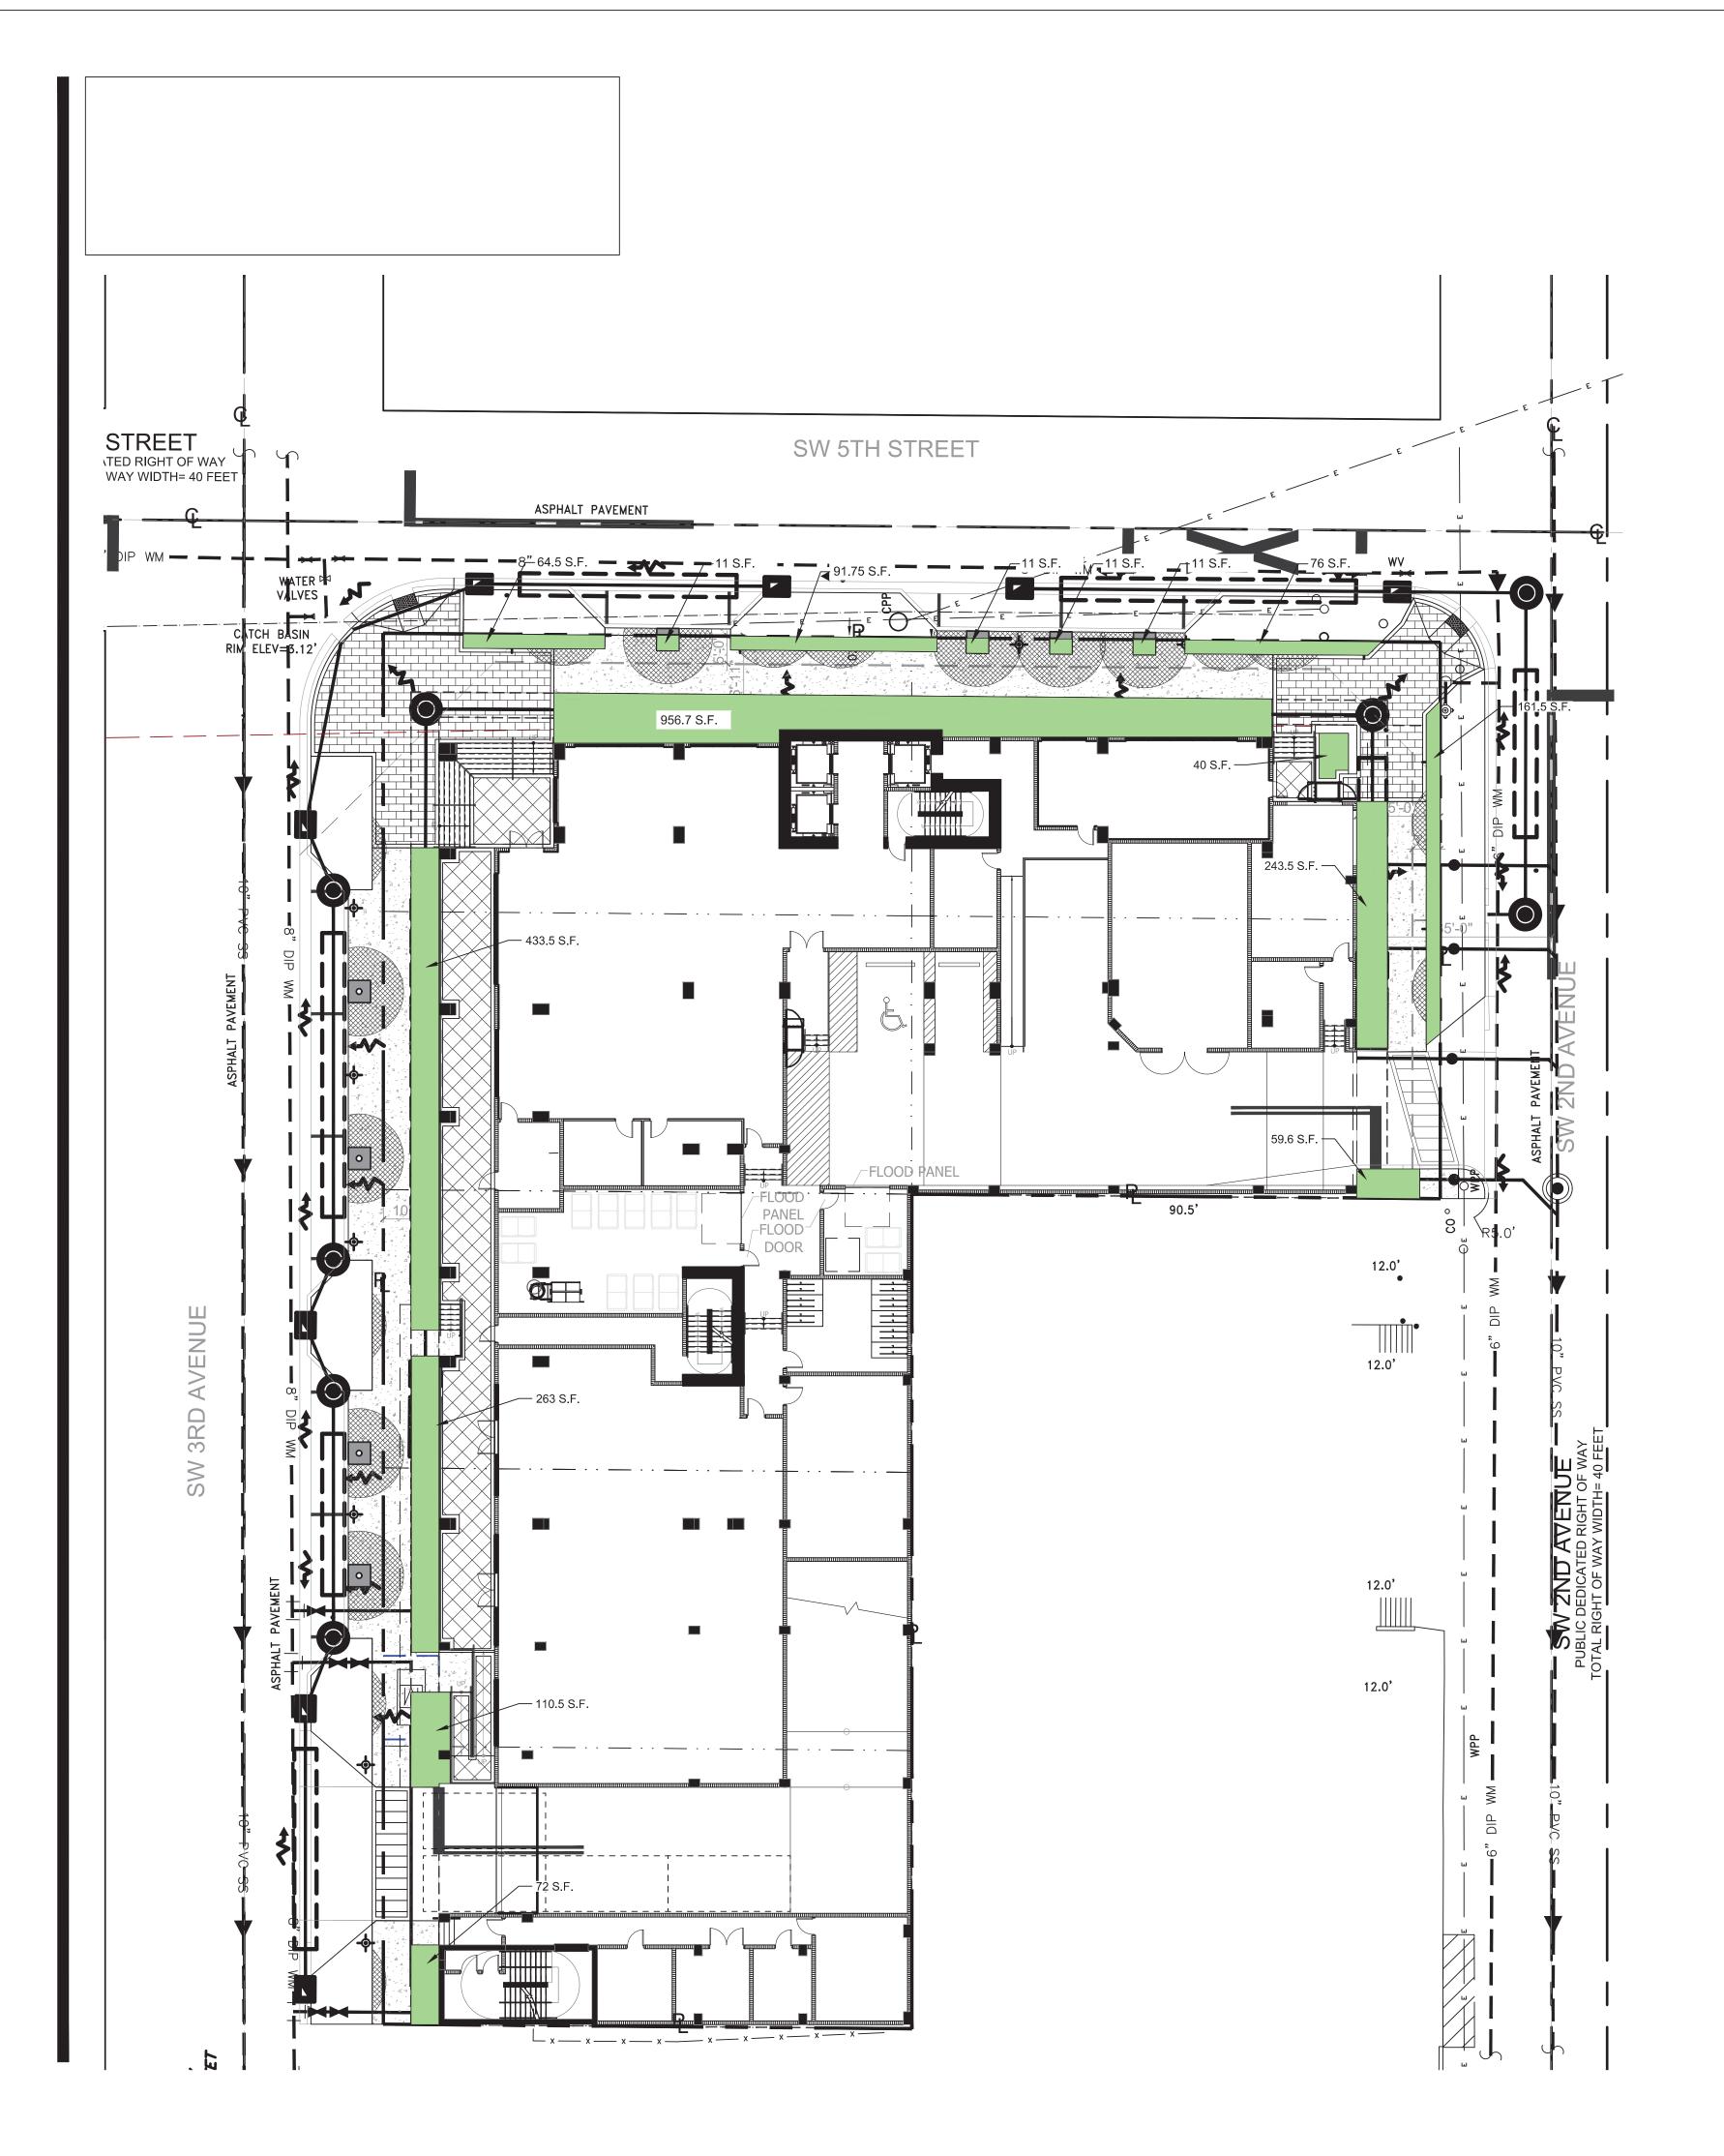
> Release Date 03-22-24

> > **Project Number** 2401

Drawing Number

Sheet 4 OF 5

CAM #25-0848 Exhibit 3 Page 37 of 48



1. TOTAL PERVIOUS AREA EQUALS: 2,614.4 S.F.

2. SEE CIVIL ENGINEER'S PLANS SHEET X4 FOR OPEN SPACE CALCULATIONS

DRC RESUBMITTAL DRC RESUBMITTAL DRC RESUBMITTAL DRC RESUBMITTAL DRC RESUBMITTAL

Sheet Description

STREET LEVEL PERVIOUS AREA

PLAN

Release Date

Project Number

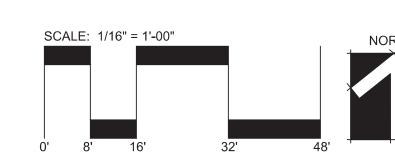
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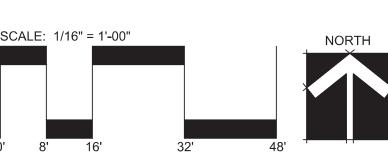
03-22-24


NOTES:

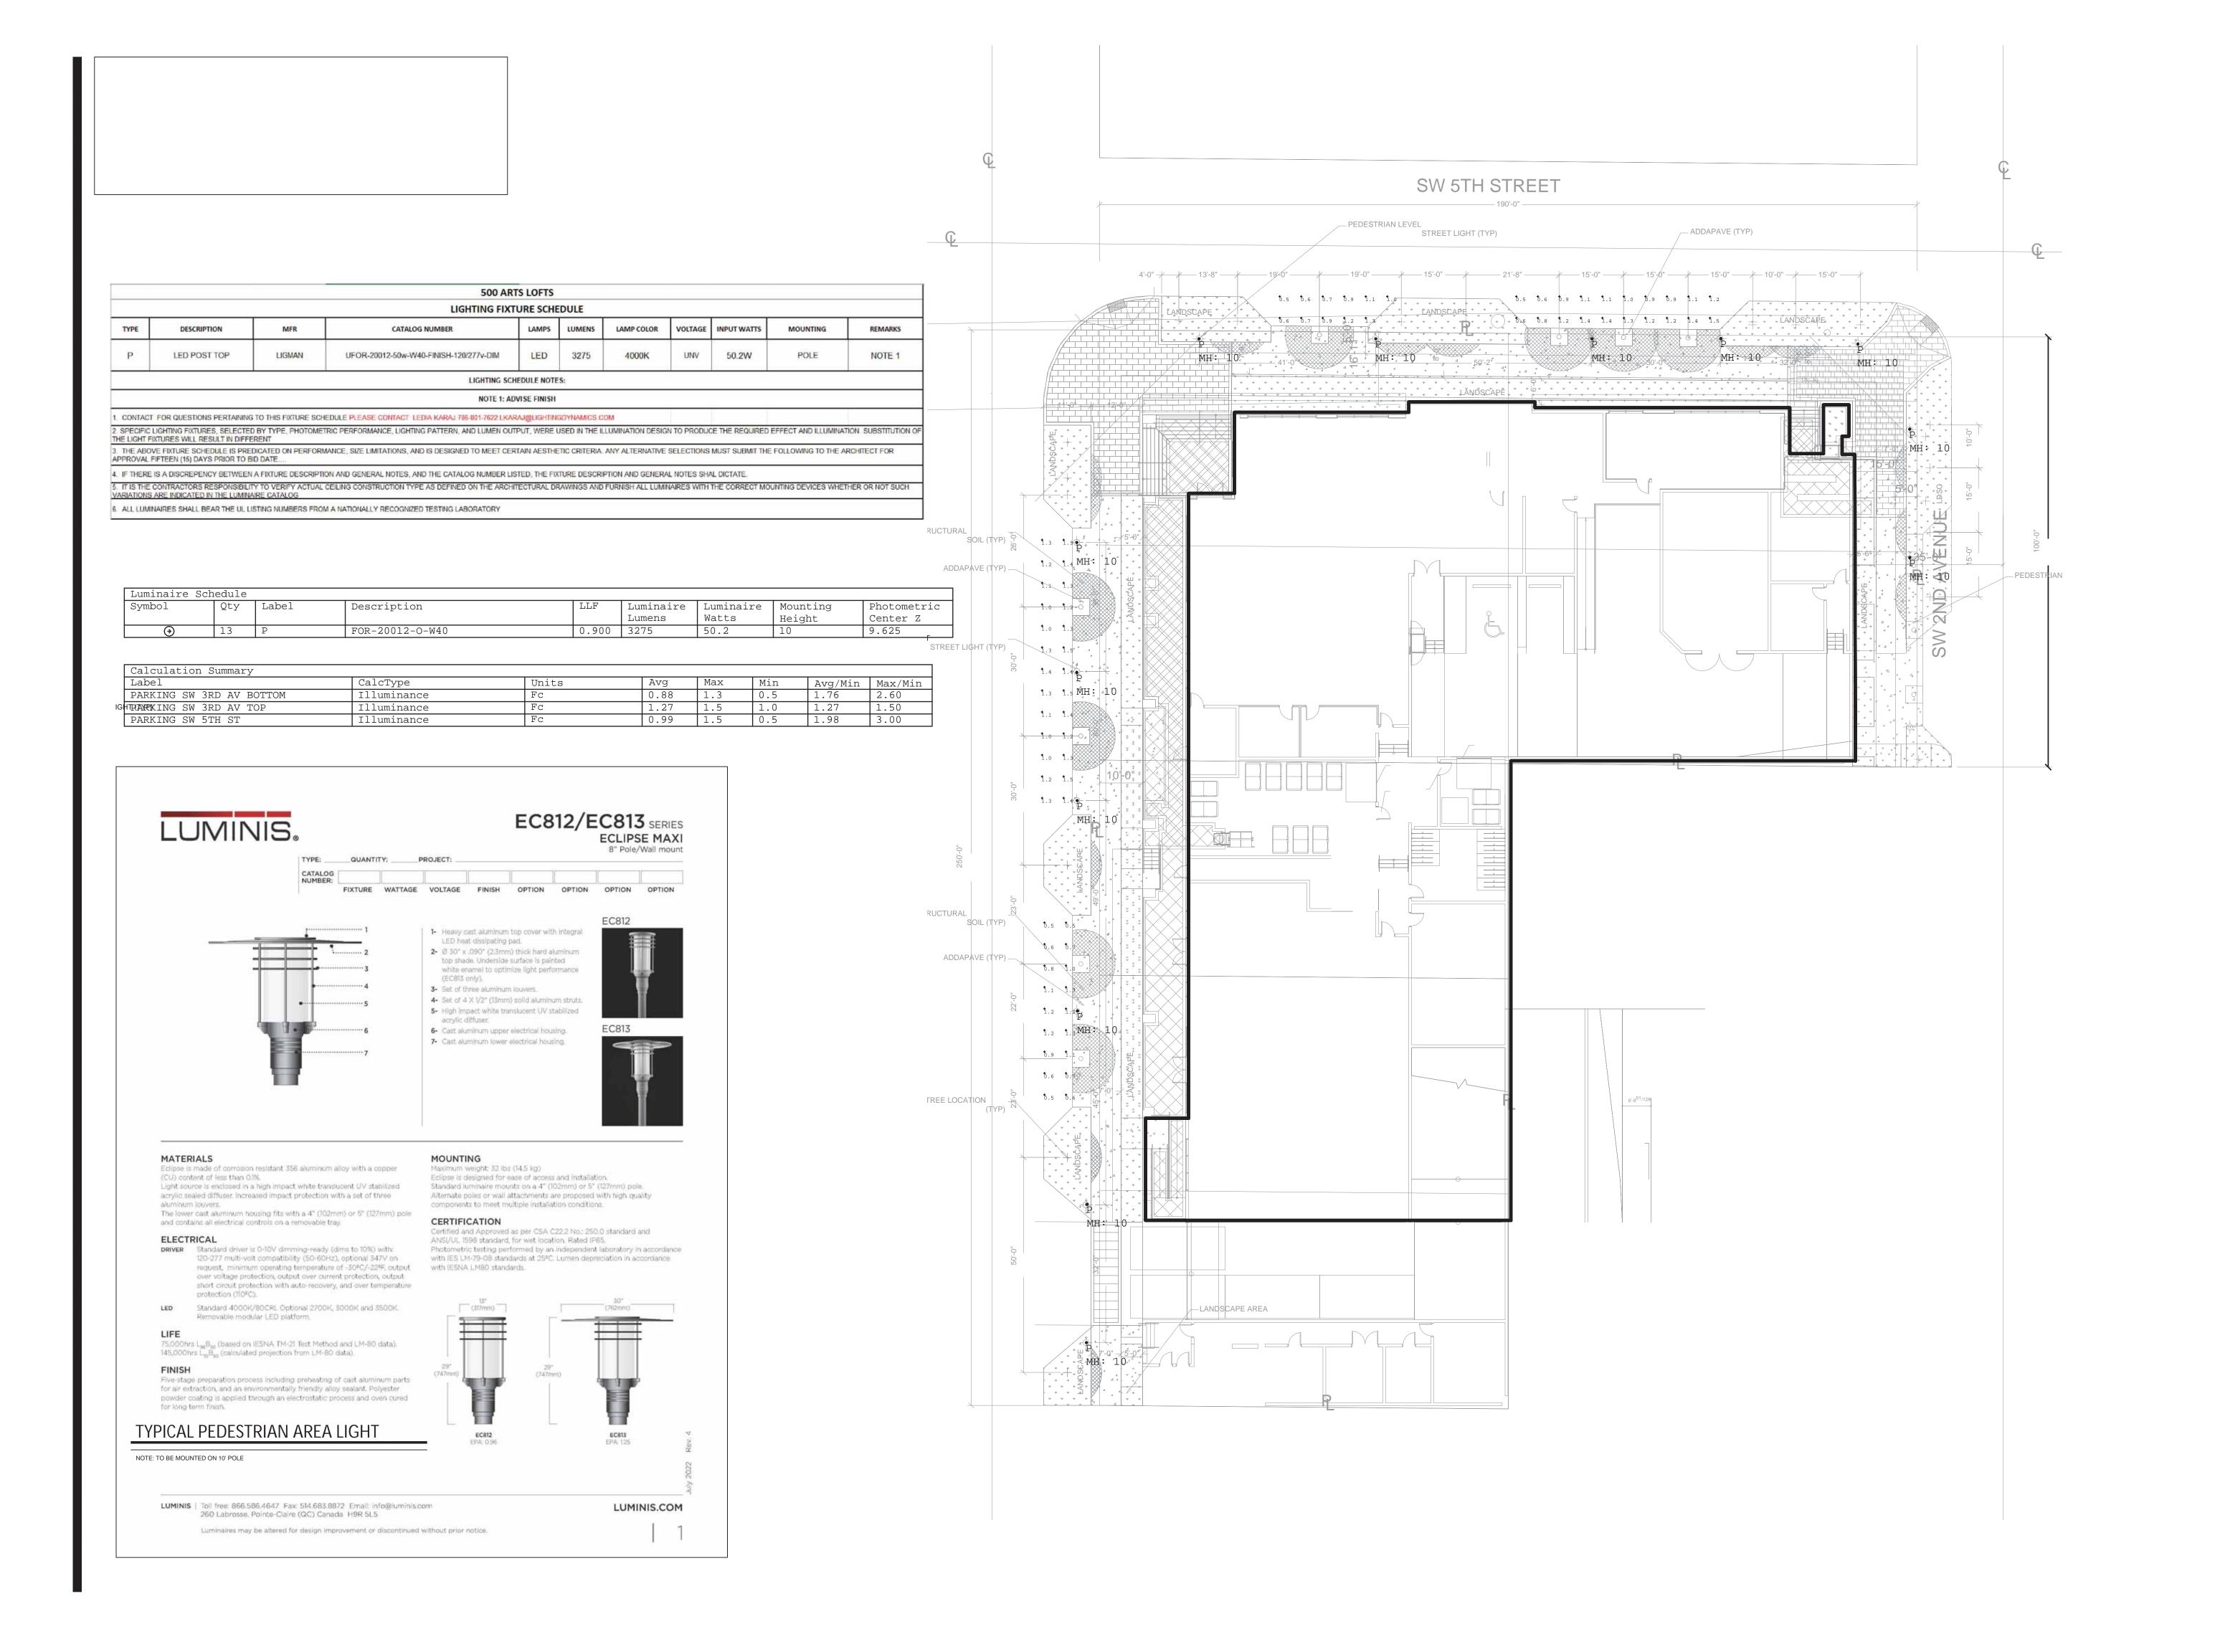- 1. ALL SOD AND LANDSCAPE RECEIVE 100% COVERAGE FROM AN AUTOMATIC IRRIGATION SYSTEM USING AN APPROVED WATER SOURCE.
- 2. IRRIGATION SYSTEM SHALL ALSO BE EQUIPPED WITH RAIN SENSOR
- A PRE-PLANTING MEETING SHALL BE SCHEDULED WITH THE CITY FORESTER OR LANDSCAPE INSPECTOR AND THE LANDSCAPE CONTRACTOR PRIOR TO ANY INSTALLATION ON THE SITE.










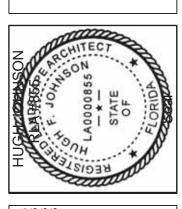Architectural Alliance Landscape 612 SW 4th Ave., Fort Lauderdale, FL. 33315 LCC000237 TEL: 954-764-8858 EMAIL: HJohnson@archall.net



1. DRC RESUBMITTAL 08-12-2024 2. DRC RESUBMITTAL 01-15-2025 3. DRC RESUBMITTAL 02-26-2025 4. DRC RESUBMITTAL 07-16-2025

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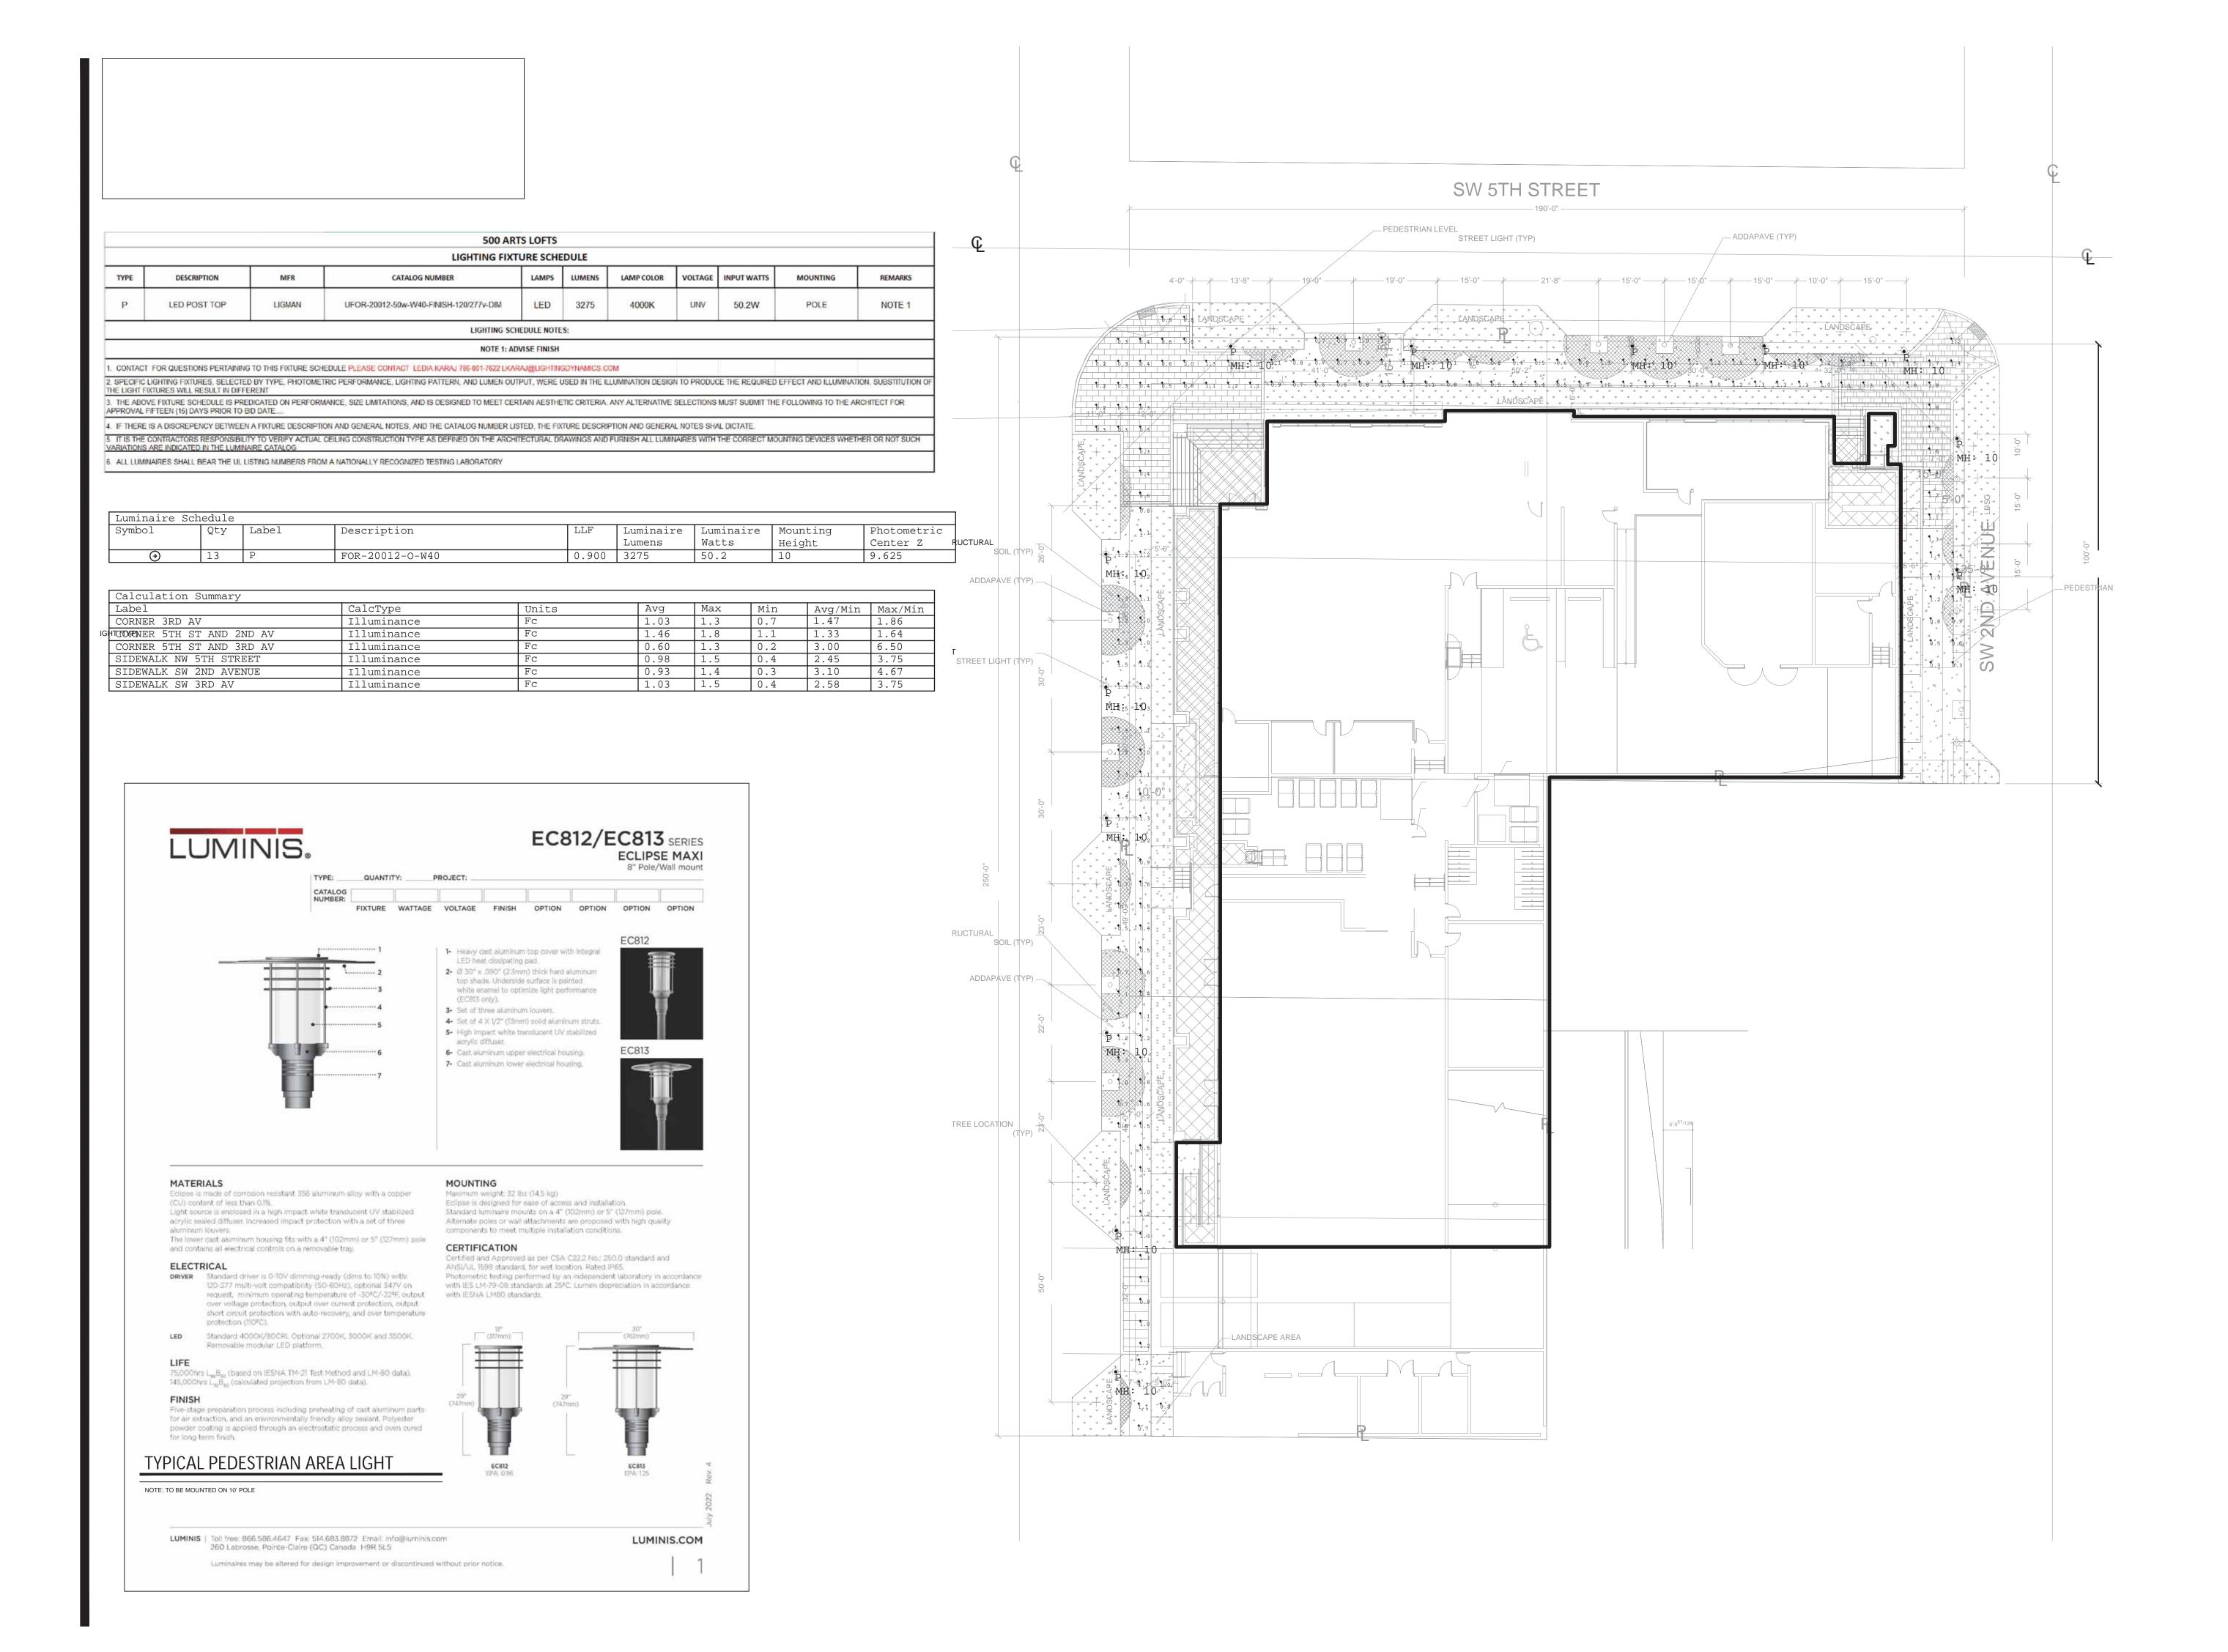
Sheet Description
STREET LEVEL
PARKING
PHOTOMETRICS PLAN


Release Date 03-22-24

Project Number 2401

Drawing Number

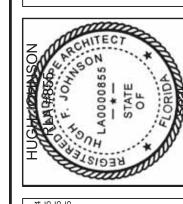Sheet 1 OF 2





02-07-07-

Sheet Description STREET LEVEL SIDEWALK PHOTOMETRICS PLAN

> Release Date 03-22-24

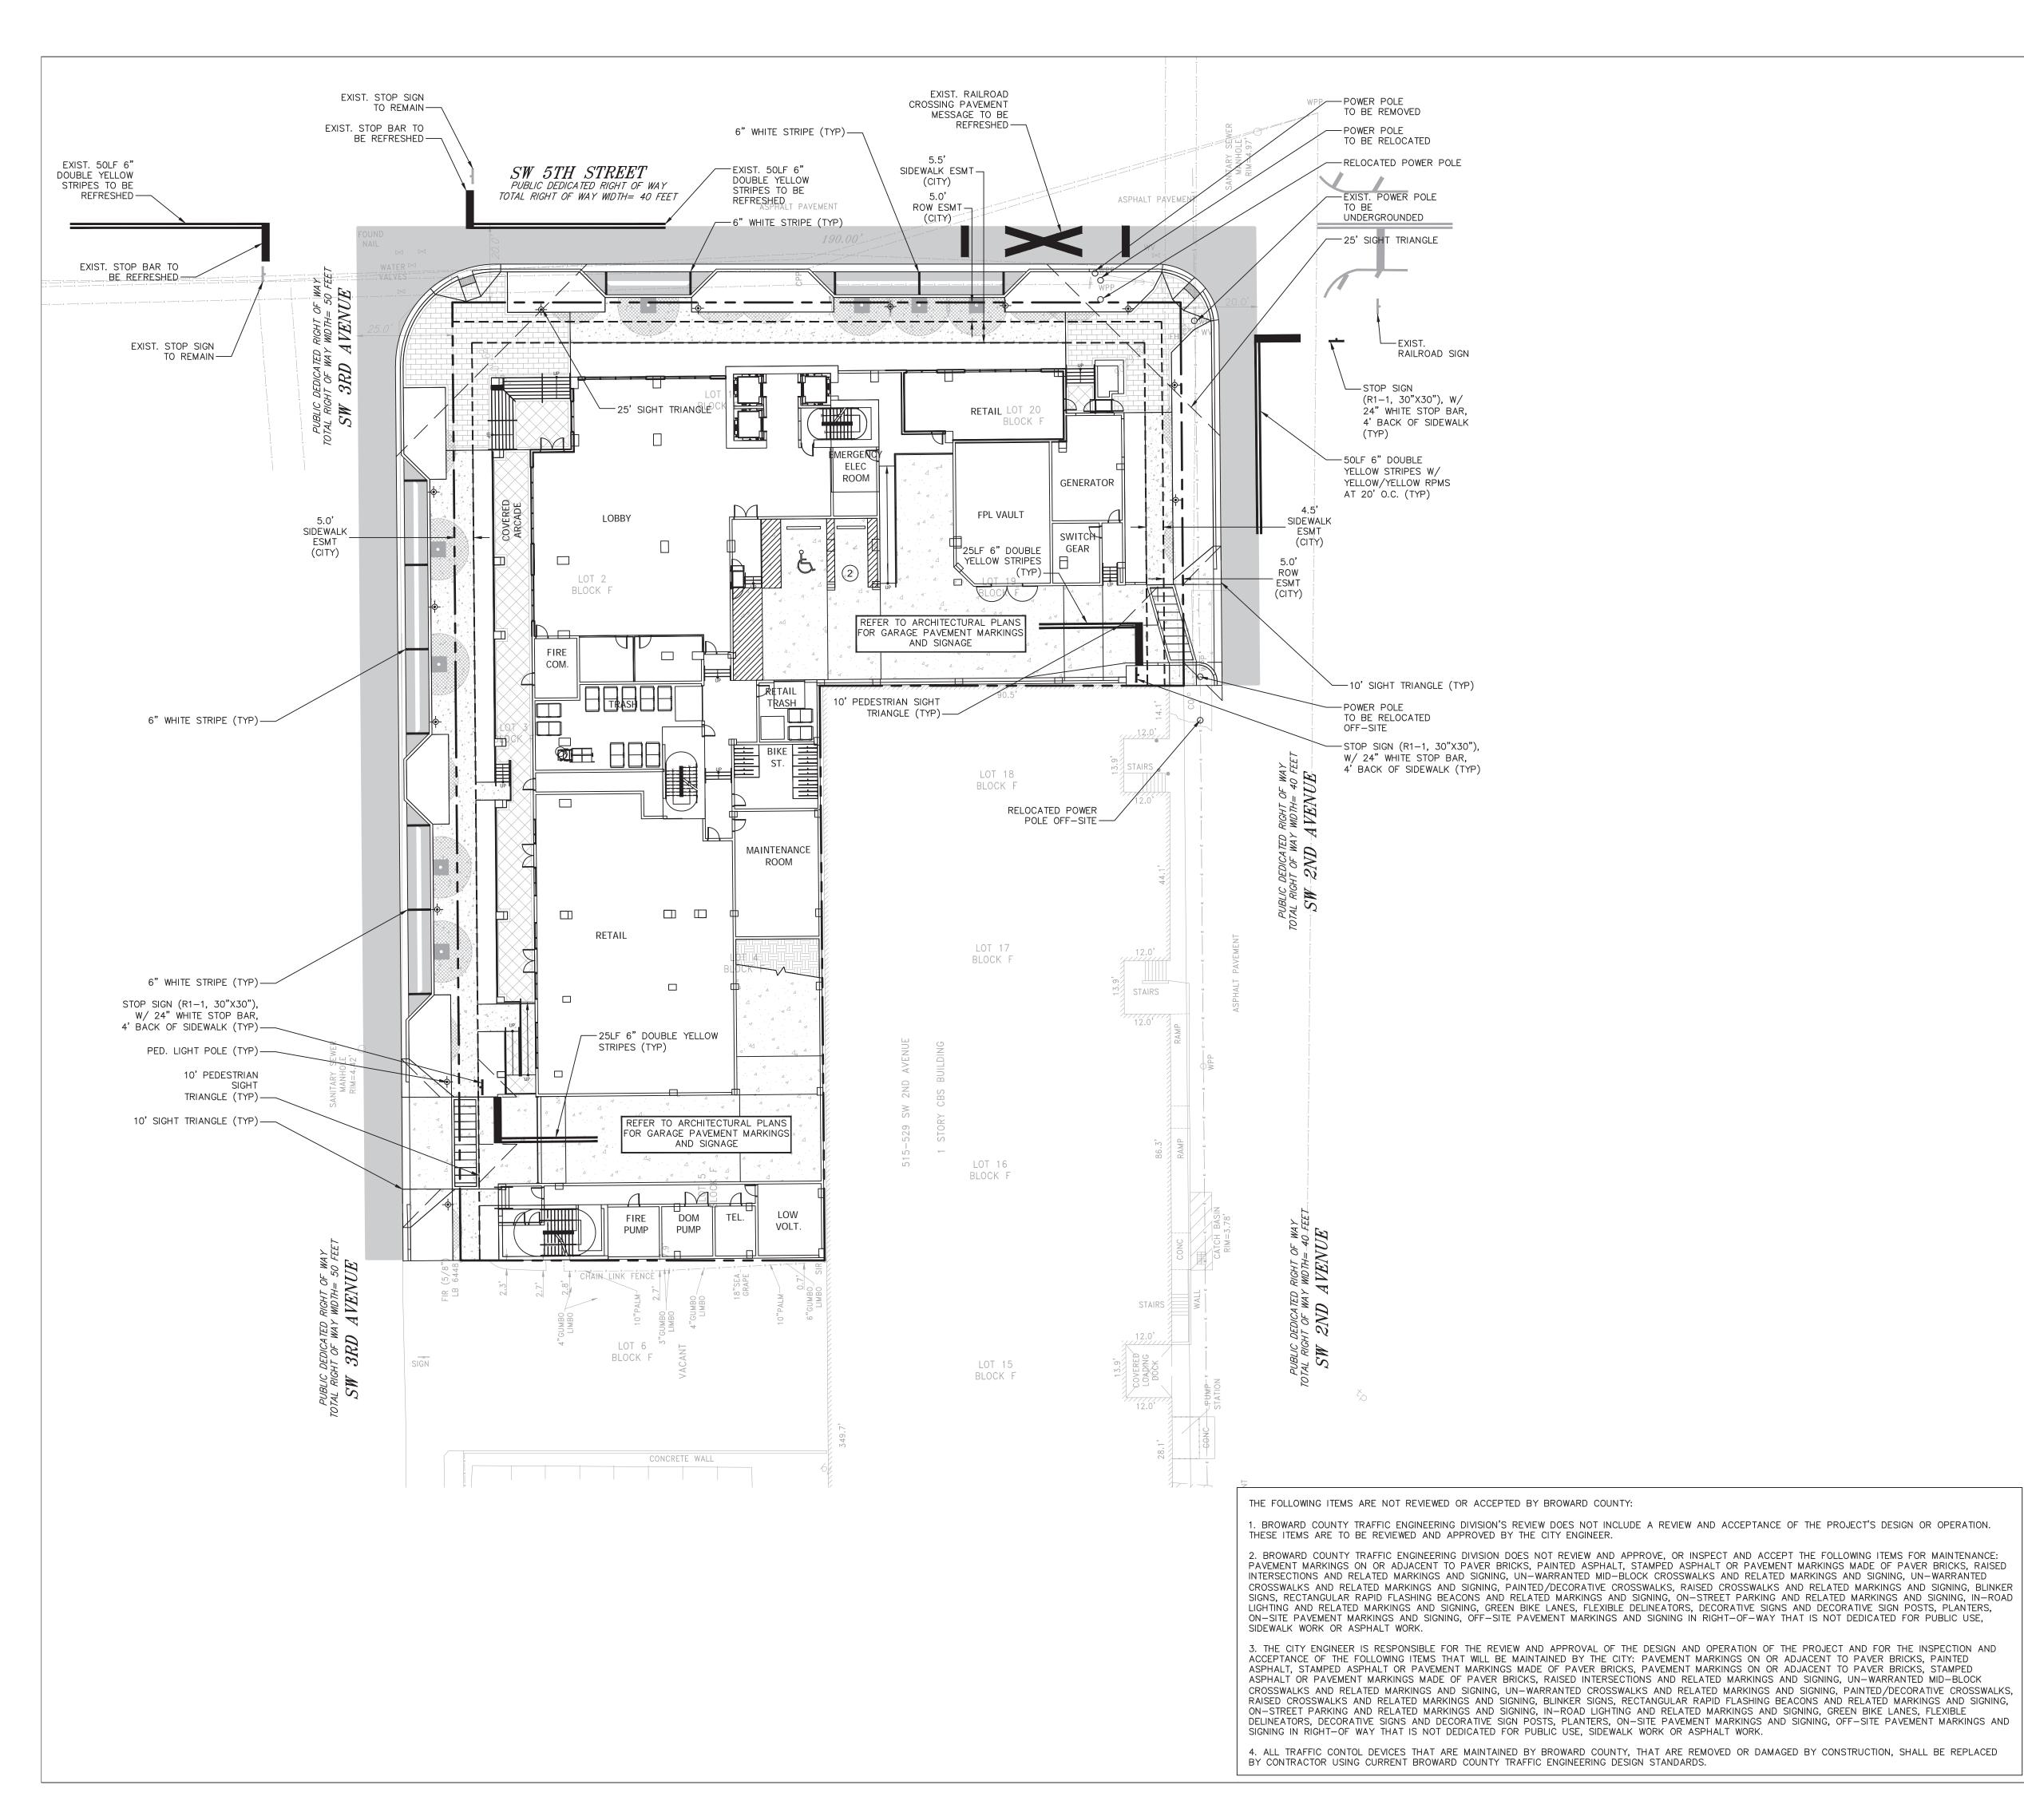
Project Number 2401

Drawing Number

Sheet 2 OF 2

Page 40 of 48

CAM #25-0848 Exhibit 3





LOCATION MAP

LEGEND:

0.00 PROPOSED ELEVATION (NAVD)

⊕5.32 EXISTING ELEVATION (NAVD) PROPOSED CATCH BASIN

PROPOSED PLUG TEE

REDUCED PRESSURE

PROPOSED MANHOLE

-FM - SANITARY FORCE MAIN

SIAMESE CONNECTION

FIRE HYDRANT

--W-- EXIST. WATER MAIN

CLEANOUT

- W - WATER MAIN

VALVE

EDGE OF PROPOSED PAVEMENT WATER METER (ASPHALT) DOUBLE DETECTOR CHECK W/ WAFER DIRECTION OF SURFACE DRAINAGE CHECK VALVE ON DOWNSTREAM SIDE SAMPLE POINT

BACKFLOW PREVENTOR

DIRECTIONAL FLOW ARROW AND GRAVITY SEWER EXIST. UTILITY LINE TO BE ABANDONED IN PLACE

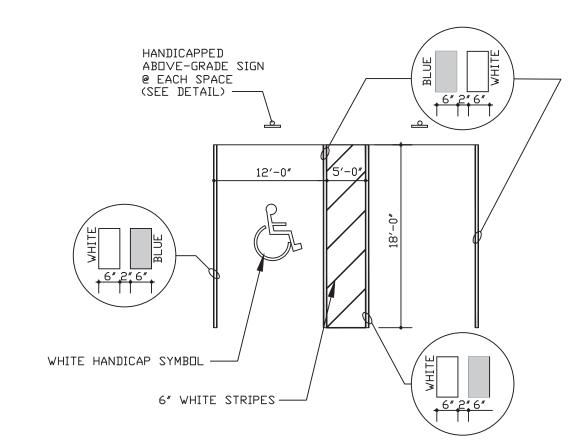
SIGNAGE AND MARKING NOTES:

1. ALL SIGNAGE AND PAVEMENT MARKINGS SHALL CONFORM TO THE MANUAL OF UNIFORM TRAFFIC CONTROL DEVICES, (MUTCD) AND B.C.T.E.D. STANDARDS (CURRENT EDITION).


2. ALL PAVEMENT MARKING AND SIGNAGE DAMAGED DURING CONSTRUCTION, SHALL BE RESTORED TO BROWARD COUNTY TRAFFIC ENGINEERING STANDARD (CURRENT EDITION).

3. REMOVAL OF PAVEMENT MARKINGS SHALL BE BY SAND OR HYDROBLASTING AS REQUIRED BY B.C.T.E.D.

4. ALL PAVEMENT MARKINGS ON ASPHALT SHALL BE THERMOPLASTIC WITH THE EXCEPTION OF PARKING STALL STRIPING WHICH SHALL BE REGULAR PAINT.



TYPICAL HANDICAP PARKING LAYOUT

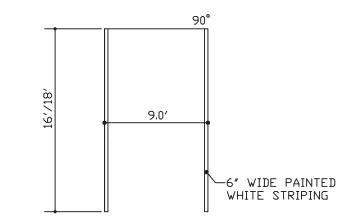

TYPICAL PARKING LAYOUT

CALL 48 HOURS BEFORE YOU DIG IN FLORIDA

سر!IT'S THE LAW SUNSHINE STATE ONE CALL OF FLORIDA, INC. VERTICAL DATUM CONVERSION GRADING SHOWN UTILIZES N.A.V.D. 88

N.A.V.D. 88 = N.G.V.D. 29 - 1.5' N.G.V.D. 29 = N.A.V.D. 88 + 1.5'

MARKING SE PLAN EMENT N SIGNAGE $\geq \infty$


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Phase: **PERMIT** DOCUMENTS

1"=20' | 08/05/25 Plot Date 23-1783.00 08/05/2 Drawn by Appr. by



SIDEWALK

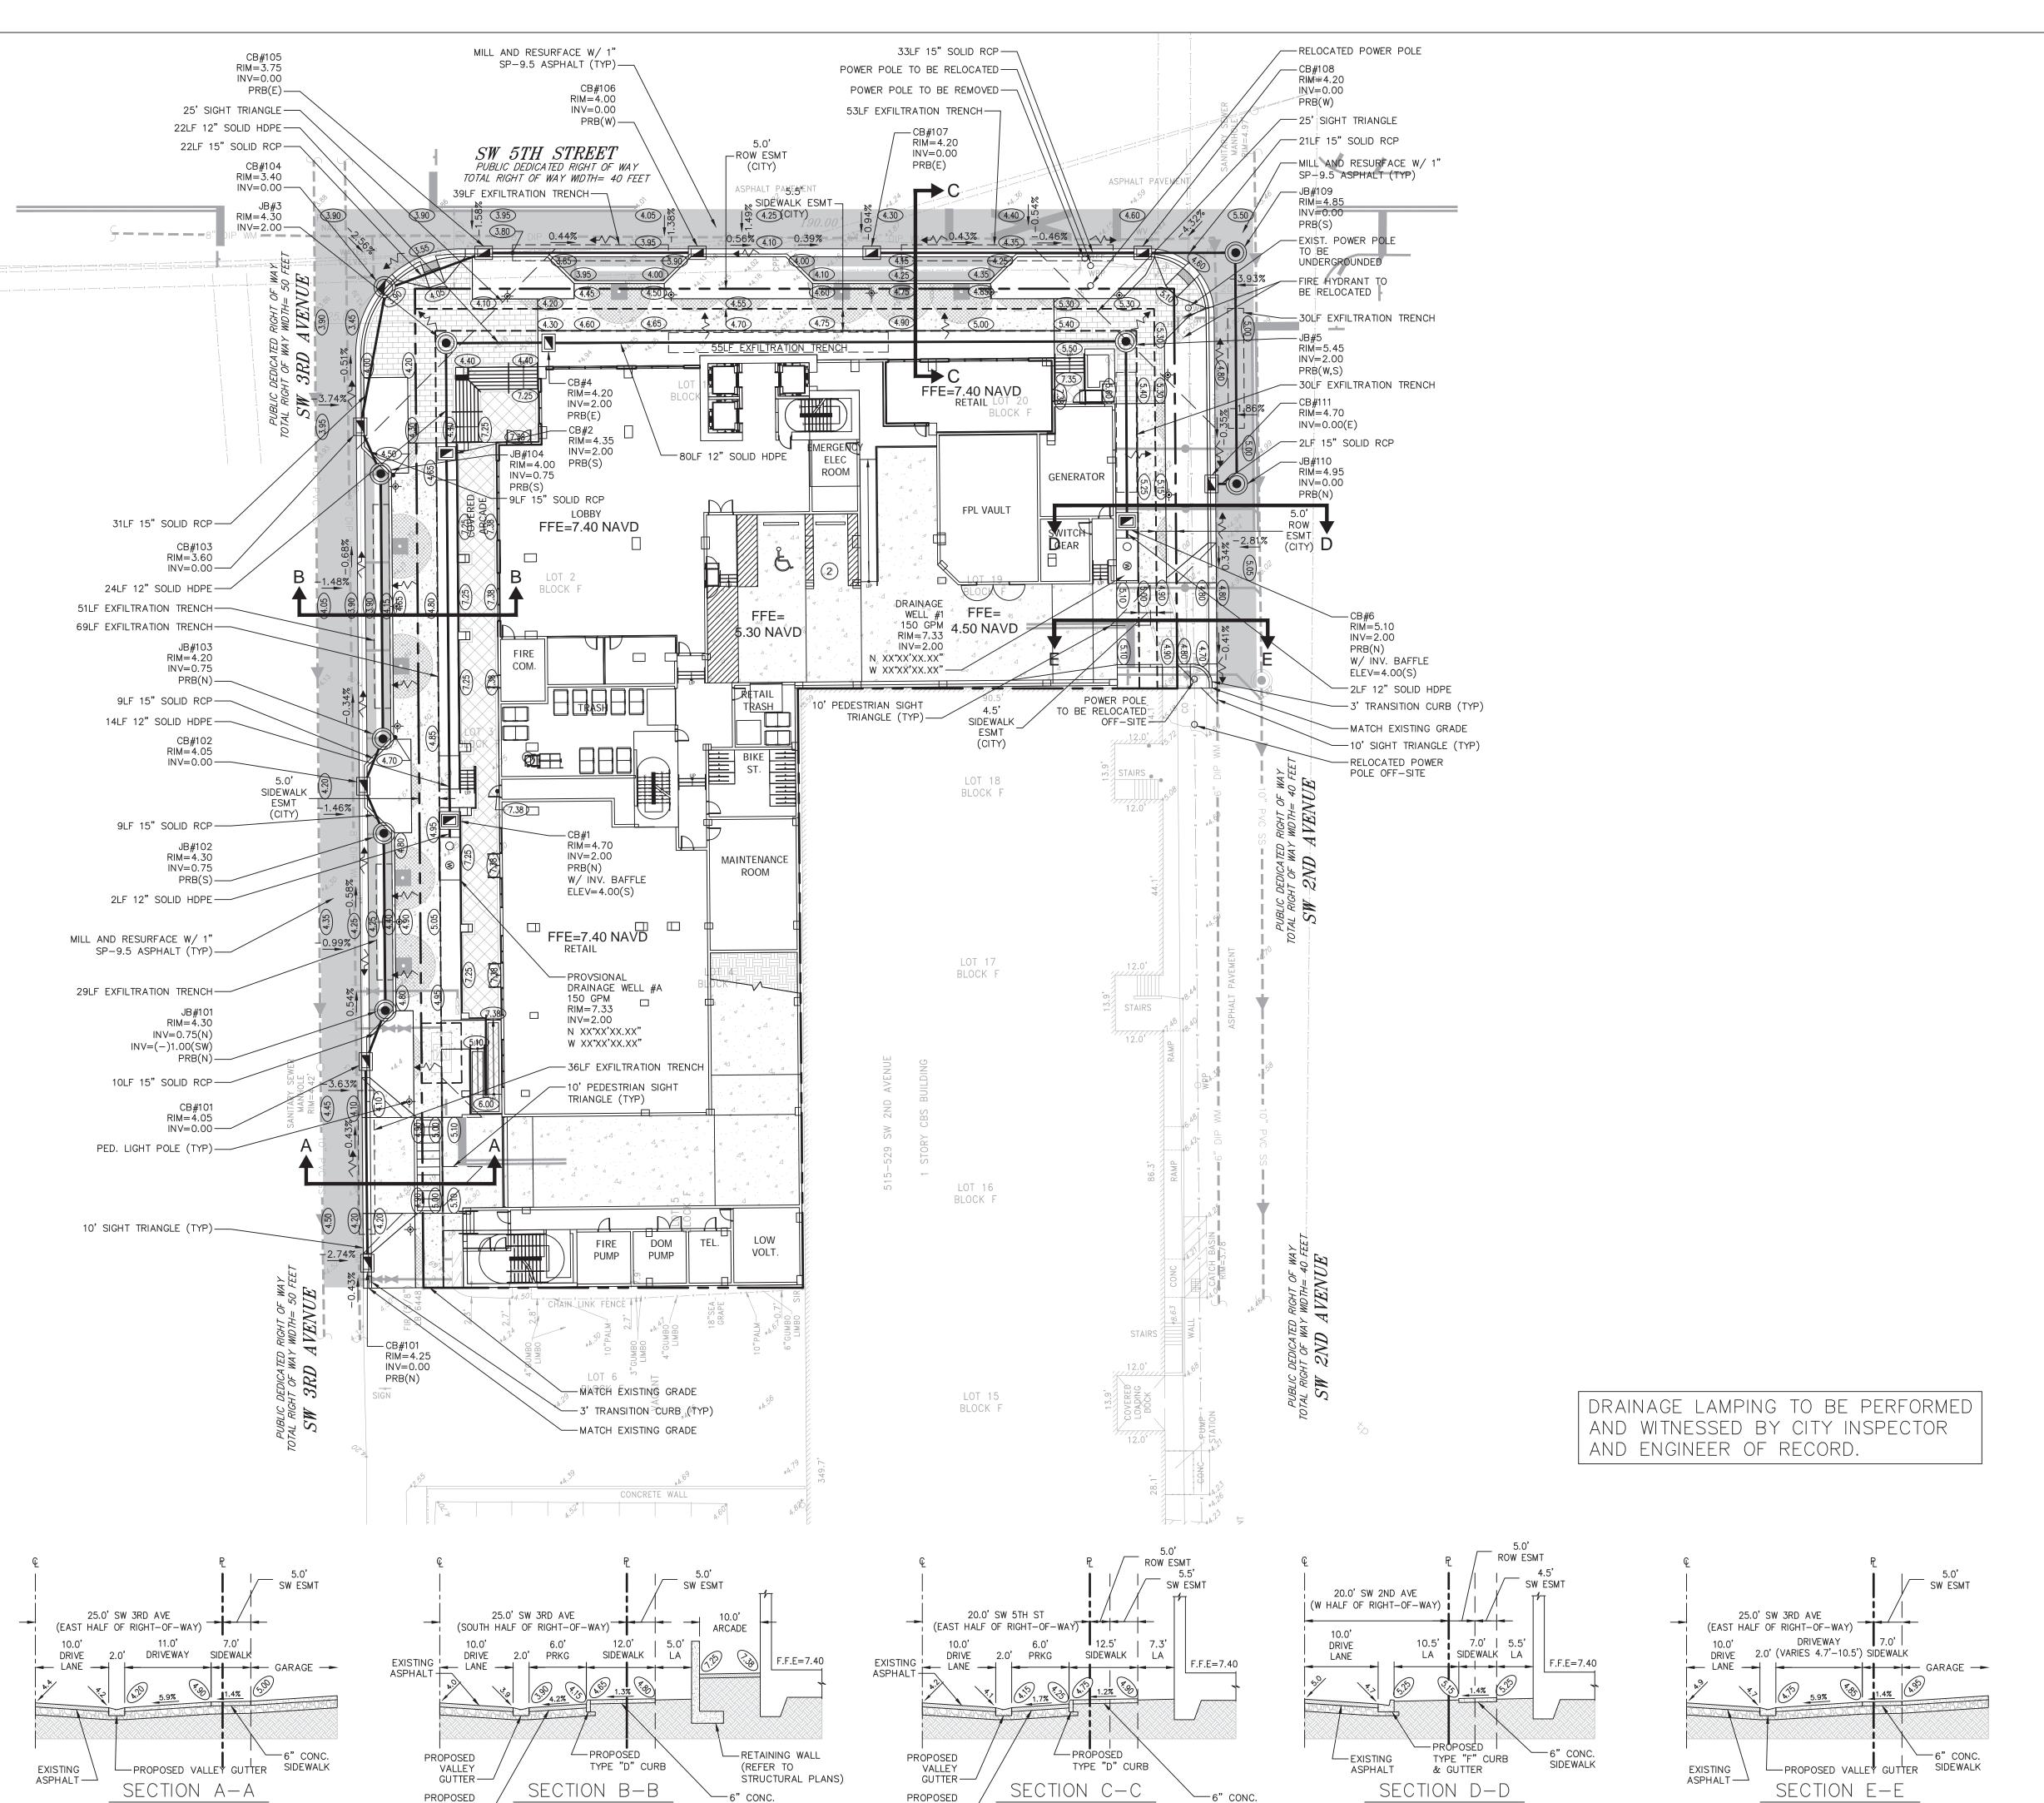SIDEWALK



LOCATION MAP

LEGEND:

PROPOSED ELEVATION (NAVD)

 EXISTING ELEVATION (NAVD)

 PROPOSED CATCH BASIN

PROPOSED CATCH BASIN

[PROPOSED PLUG

TEE

WATER METER

DOUBLE DETECTOR CHECK W/ WAFER CHECK VALVE ON DOWNSTREAM SIDE

NM REDUCED PRESSURE

RACKELOW PREVENTOR

BROWARD COUNTY FUTURE 100 YEAR

3 DAY CONTOUR= ELEV. (6.0) NAVD

N/I REDUCED PRESSURE
BACKFLOW PREVENTOR

DIRECTIONAL FLOW ARROW
AND GRAVITY SEWER

PROPOSED MANHOLE
- W - WATER MAIN

-FM - SANITARY FORCE MAIN

VALVE

→ FIRE HYDRANT

SIAMESE CONNECTION

SIAMESE CONNECTION
CLEANOUT
EDGE OF PROPOSED PAVEMENT
(ASPHALT)

DIRECTION OF SURFACE DRAINAGE

SAMPLE POINT

EXIST. WATER MAIN

EXIST. UTILITY LINE TO BE ABANDONED IN PLACE

FLOOD ZONE " AE " ELEV (6.0) NAVD
ON FIRM MAP #12011C0369 J, DATED FEBRUARY 31, 2024

DESIGN FLOOD ELEVATION 100 YEAR 3 DAY STORM= ELEV. (7.40) NAVD

AVERAGE WET SEASON WATER LEVEL= ELEV. (3.0) NAVD

GRADING AND DRAINAGE NOTES:

1. ALL CONSTRUCTION SHALL CONFORM TO THE STANDARDS AND SPECIFICATIONS OF THE CITY OF FORT LAUDERDALE.

2. PRIOR TO CONSTRUCTION, THE CONTRACTOR SHALL GIVE TIMELY NOTIFICATION TO ALL UTILITY COMPANIES WITH FACILITIES IN THE AREA.

3. THE CONTRACTOR SHALL TAKE ALL NECESSARY PRECAUTIONS TO SAFEGUARD ALL EXISTING STRUCTURES, UTILITIES, AND SURVEY MARKERS.

4. ALL STORM DRAINAGE LINE FROM THE BLDG SHALL BE LAID @ 1.0% MINIMUM SLOPE UNLESS NOTED OTHERWISE ON PLANS.

5. CLEANOUTS ON STORM DRAINAGE LINES ARE TO BE ADJUSTED TO BE FLUSH W/FINISHED GRADE.

6. CONTRACTOR SHALL PROVIDE FITTINGS (WYES, TEE, REDUCERS, ETC.) AS REQUIRED TO FURNISH A COMPLETE WORKING SYSTEM BASED ON THE LAYOUT SHOWN ON THESE PLANS

COMPLETE WORKING SYSTEM BASED ON THE LAYOUT SHOWN ON THESE PLANS.

7. LANDSCAPED AREAS SHALL BE GRADED TO DRAIN TO THE CATCH BASIN INLETS. FIELD ADJUST GRADING AS REQUIRED.

8. SITE UTILITY CONTRACTOR SHALL COORDINATE WITH THE BUILDING PLUMBING CONTRACTOR FOR EXACT LOCATION OF CONNECTION POINTS BETWEEN THE BUILDING AND SITE WATER, SEWER AND DRAINAGE LINES (VERTICALLY AND HORIZONTALLY).

9. RECTANGULAR CATCH BASIN AND YARD DRAIN GRATES SHALL BE INSTALLED SUCH THAT THE LONG AXIS OF GRATE PARALLELS THE CLOSEST ADJACENT WALK, BLDG., DRIVE WAY, PROPERTY LINE, OR

10. COORDINATE LOCATION IN FIELD OF ALL CATCH BASINS & YARD DRAINS WITH LANDSCAPE CONTRACTOR TO AVOID CONFLICTS.

11. CENTERLINE OF YARD DRAINS @ BASE OF DOWN SPOUTS MUST ALIGN WITH CENTERLINE OF DOWN SPOUT PRIOR TO FINAL ACCEPTANCE BY OWNER. REFERENCE ARCH. PLANS FOR EXACT LOCATION OF DOWN SPOUTS.

12. SLOPE ON SIDEWALKS SHALL NOT EXCEED 5% SLOPE IN DIRECTION OF TRAVEL OR 2% CROSS SLOPE. NOTIFY ENGINEER PRIOR TO CONSTRUCTION OF ANY GRADING THAT DOES NOT COMPLY WITH THIS REQUIREMENT.

13. SLOPE IN HANDICAP PARKING AND ACCESS AISLES SHALL NOT EXCEED 2% CROSS SLOPE. NOTIFY

ENGINEER PRIOR TO CONSTRUCTION OF ANY GRADING THAT DOES NOT COMPLY WITH THIS REQUIREMENT.

14. SLOPE IN CROSSWALKS SHALL NOT EXCEED 2% CROSS SLOPE. NOTIFY ENGINEER PRIOR TO CONSTRUCTION OF ANY GRADING THAT DOES NOT COMPLY WITH THIS REQUIREMENT.15. SURVEY INFORMATION BASED ON SURVEY PROVIDED BY COUSINS SURVEYORS & ASSOCIATES, INC.

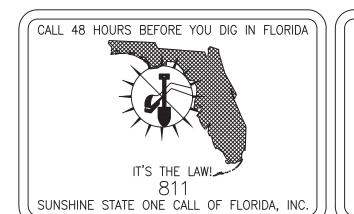
DATED JULY 11TH, 2022.

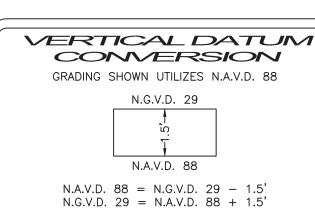
16. ELEVATIONS SHOWN ARE NAVD88.

17. FINAL RIM ELEVATIONS SHALL BE FIELD ADJUSTED TO MATCH SLOPE OF PROPOSED PAVEMENT.

*18. FINAL RIM ELEVATIONS FOR THE DRAINAGE STRUCTURES WITHIN THE GARAGE TO BE BASED ON ARCHITECT'S GRADING PLAN.

20. ASPHALT PAVEMENT RESTORATION ON CITY RIGHT-OF-WAY MUST BE PERFORMED BY A LICENSED ENGINEERING CONTRACTOR OR PAVING CONTRACTOR IN BROWARD COUNTY.






ENGINEERING.

241 COMMERCIAL BLVD., LAUDERDALE—BY—THE—SEA, FL 33308
PHONE: (954) 522—1004 | WWW.FLYNNENGINEERING.COM
FR# 6578


CONCEPTUAL
PAVING, GRADING, &
DRAINAGE PLAN

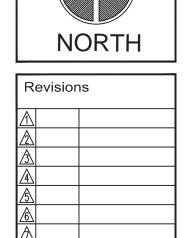500 SW 2ND AVENUE T LAUDERDALE, FLORIDA 33301




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LOCATION MAP

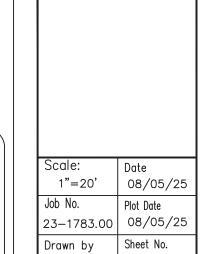LEGEND:

(0.00) PROPOSED ELEVATION (NAVD) ± 5.32 EXISTING ELEVATION (NAVD)

PROPOSED CATCH BASIN PROPOSED PLUG

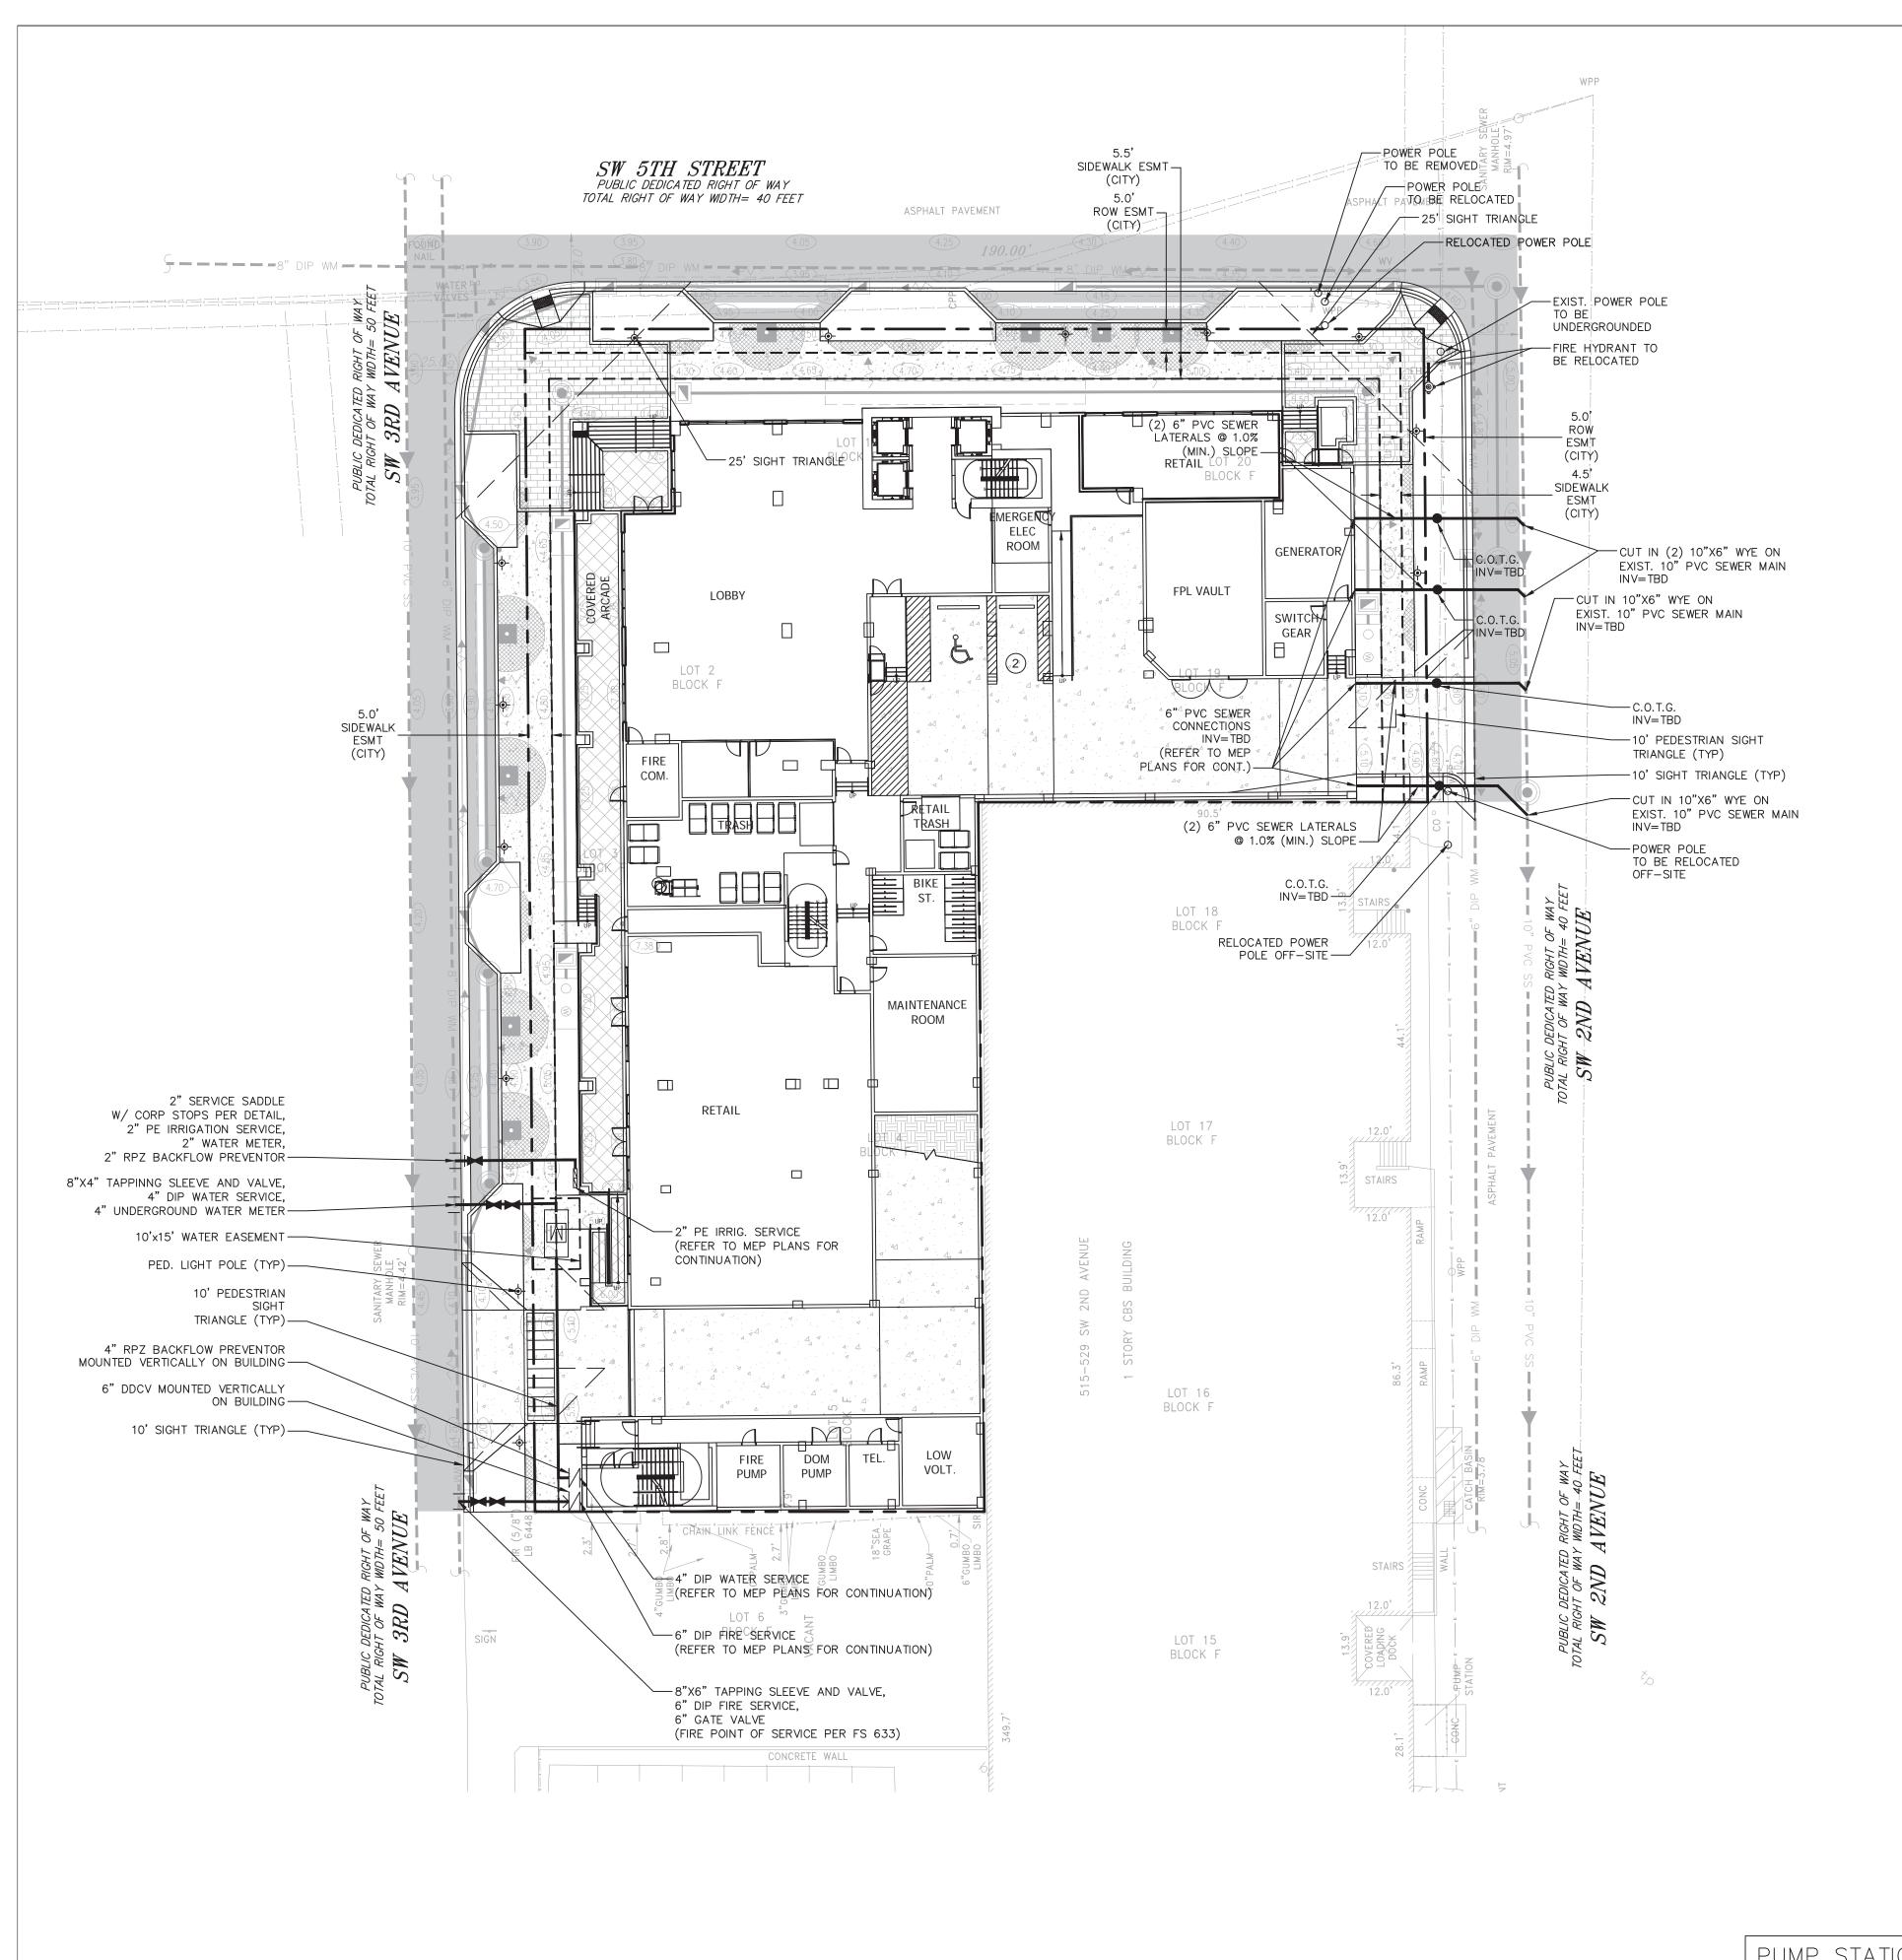TEE WATER METER

REDUCED PRESSURE BACKFLOW PREVENTOR

DOUBLE DETECTOR CHECK W/ WAFER CHECK VALVE ON DOWNSTREAM SIDE DIRECTIONAL FLOW ARROW AND GRAVITY SEWER

PROPOSED MANHOLE - W - WATER MAIN

-FM - SANITARY FORCE MAIN FIRE HYDRANT

SIAMESE CONNECTION CLEANOUT EDGE OF PROPOSED PAVEMENT (ASPHALT) DIRECTION OF SURFACE DRAINAGE

SAMPLE POINT --W-- EXIST. WATER MAIN EXIST. UTILITY LINE TO BE ABANDONED IN PLACE

WATER AND SEWER NOTES:

1.CONTRACTOR SHALL PROVIDE FITTINGS (WYES, TEE, REDUCERS, ETC.) AS REQUIRED TO FURNISH A COMPLETE WORKING SYSTEM BASED ON THE LAYOUT SHOWN ON THESE PLANS.

ANY EASEMENTS WITH THE CITY. CONTRACTOR'S SURVEYOR MUST COORDINATE WITH THE CITY AND PROVIDE ALL NECESSARY EASEMENT DOCUMENTATION TO THE OWNER. THE OWNER MUST THEN PROVIDE ALL RECORDED UTILITY EASEMENT DOCUMENTS TO THE CITY PRIOR TO FINAL ACCEPTANCE. 3. CONTRACTOR IS RESPONSIBLE TO COORDINATE WITH THE CITY UTILITY DEPT. ANY WATER MAIN

2. CONTRACTOR SHALL PROVIDE ANY EASEMENT DOCUMENTATION AROUND MH'S, BACKFLOW

PREVENTORS, MAINLINES, METERS, ETC. AS REQUIRED BY THE CITY SO THAT THE OWNER MAY RECORD

CONNECTIONS. UTILITY CONNECTIONS AND SCHEDULE MUST BE APPROVED BY THE CITY PRIOR TO IMPLEMENTATION. THE CONTRACTOR IS REQUIRED TO PAY FOR ALL COSTS ASSOCIATED WITH THIS WORK REGARDLESS OF WHETHER OR NOT THE UTILITY OR THE CONTRACTOR PERFORMS THE WORK.

4. SITE UTILITY CONTRACTOR SHALL COORDINATE WITH THE BUILDING PLUMBING CONTRACTOR FOR EXACT LOCATION OF CONNECTION POINTS BETWEEN THE BUILDING AND SITE WATER, SEWER AND DRAINAGE LINES (VERTICALLY AND HORIZONTALLY).

5. W.M./S.S. MAINS TO BE LOCATED 5' CLEAR OF ALL OBSTRUCTIONS, POLES, BOXES, CULVERTS, ETC.

W.M./S.S. MAINS MUST BE LOCATED 5' FROM TREES. F.H.'S MUST HAVE A 7.5' CLEAR RADIUS FROM ALL OBSTRUCTIONS.

6. PRESSURE TESTING AND CERTIFICATION SHALL FOLLOW THE FDEP, CITY OF FORT LAUDERDALE PUBLIC WORKS DEPARTMENT, AND FLYNN ENGINEERING SERVICES STANDARDS.

7. 18" VERTICAL CLEARANCE PREFERRED FOR ALL UTILITY CROSSINGS. MINIMUM OF 12" REQUIRED FOR WM-WM CROSSING AND WM-FM CROSSING. CONTRACTOR SHALL CALL 811 AND LOCATE UTILITY CROSSINGS PRIOR TO CONSTRUCTION AND NOTIFY ENGINEER OF ANY DISCREPANCIES. ALL SANITARY SEWER LATERALS SHALL CROSS UNDER WATER MAINS WHERE ABLE. IF THE WATER MAIN MUST CROSS BELOW THE SEWER, A MINIMUM OF 12' SEPARATION SHALL BE PROVIDED. A 20 FOOT SECTION OF DUCTILE IRON PIPE WATER MAIN CENTERED CROSSING IS REQUIRED IF LESS THAN 18" VERTICAL SEPARATION OCCURS BETWEEN SEWER AND WATER MAIN.

8. ALL UNDERGROUND UTILITIES TO BE REMOVED SHALL BE CAPPED OFF AT THE POINT NEAREST TO THE UTILITIES OR DRAINAGE LINES THAT WILL REMAIN IN SERVICE. NOTIFY THE ENGINEER OF RECORD BEFORE REMOVING ANY UTILITIES THAT ARE CURRENTLY IN SERVICE. THE CONTRACTOR SHALL NOT REMOVE ANY UTILITY SERVICE TO ANY EXISTING BUILDING THAT WILL REMAIN AND SHALL DIG UP AND COMPLETELY REMOVE AND/OR ABANDON ANY UTILITY SERVICE THAT IS NO LONGER REQUIRED. THE CONTRACTOR SHALL INFORM AND CONSULT THE ENGINEER OF RECORD PRIOR TO REMOVING ANY LINES.

9. CONTRACTOR SHALL VERIFY EXISTING WATER MAIN LOCATION AND ELEVATION AND NOTIFY THE ENGINEER OF ANY DIFFERENCE FROM THE DESIGN PRIOR TO CONSTRUCTION AND/OR EXCAVATION. 10. CLEANOUTS AND MANHOLES ON SANITARY LINES ARE TO BE ADJUSTED TO BE FLUSH WITH FINISHED

11. PROPOSED FIRE LINES (I.E. MAINS, SERVICES, SIAMESE CONNECTION LINES, ETC.) TO BE INSTALLED BY A STATE LICENSED FIRE LINE CONTRACTOR PER F.S. 633.

12. FIRE LINES TO BE INSPECTED BY A CERTIFIED FIRE LINE INSPECTOR.

13. STATE LICENSED FIRE LINE CONTRACTOR, UPON COMPLETION OF REQUIRED TESTING, SHALL ISSUE A "LICENSED UNDERGROUND TEST CERTIFICATE" PRIOR TO ACCEPTANCE FOR PLACING FIRE LINE INTO

14. CORING INTO EXISTING MANHOLE MAY RESULT IN COMPLETE RECONSTRUCTION OF EXISTING MANHOLE AT CONTRACTOR'S EXPENSE IF MANHOLE IS IN A DETERIORATED CONDITION.

*15. ON-SITE MANHOLES TO HAVE STANDARD SANITARY SEWER USF 420 COVER.

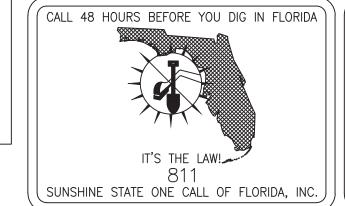
16. THE MINIMUM COVER DEPTHS FOR PVC AND DIP SEWER MAINS AR RESPECTIVELY 36 INCHES AND 30

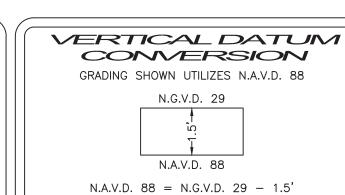
17. EXFILTRATION TESTING AND LAMPING OF THE GRAVITY SEWER SHALL BE COORDINATED BY THE CONTRACTOR PRIOR TO THE COMPLETION OF THE PROJECT.

18. ALL WATER AND SEWER WORK IN THE PUBLIC RIGHT-OF-WAY, PRIVATE THOROUGHFARES OR UTILITY EASEMENT MUST BE PERFORMED BY A LICENSED ENGINEERING CONTRACTOR OR CERTIFIED UNDERGROUND UTILITY AND EXCAVATION CONTRACTOR IN BROWARD COUNTY.

19. FINAL SEWER MANHOLE RIM ELEVATIONS SHALL BE ADJUSTED TO MATCH FINAL PAVEMENT ELEVATIONS AND MATCH PAVEMENT SLOPE AS APPLICABLE.

PUMP STATION START UP, EXFILTRATION TESTING, LAMPING, AND VIDEO SURVEY OF SANITARY SEWER TO BE PERFORMED AND WITNESSED BY CITY INSPECTOR. PRESSURE TESTING AND CANNON FLUSH OF WATER MAIN TO BE PERFORMED AND WITNESSED BY CITY INSPECTOR.





N.G.V.D. 29 = N.A.V.D. 88 + 1.5'



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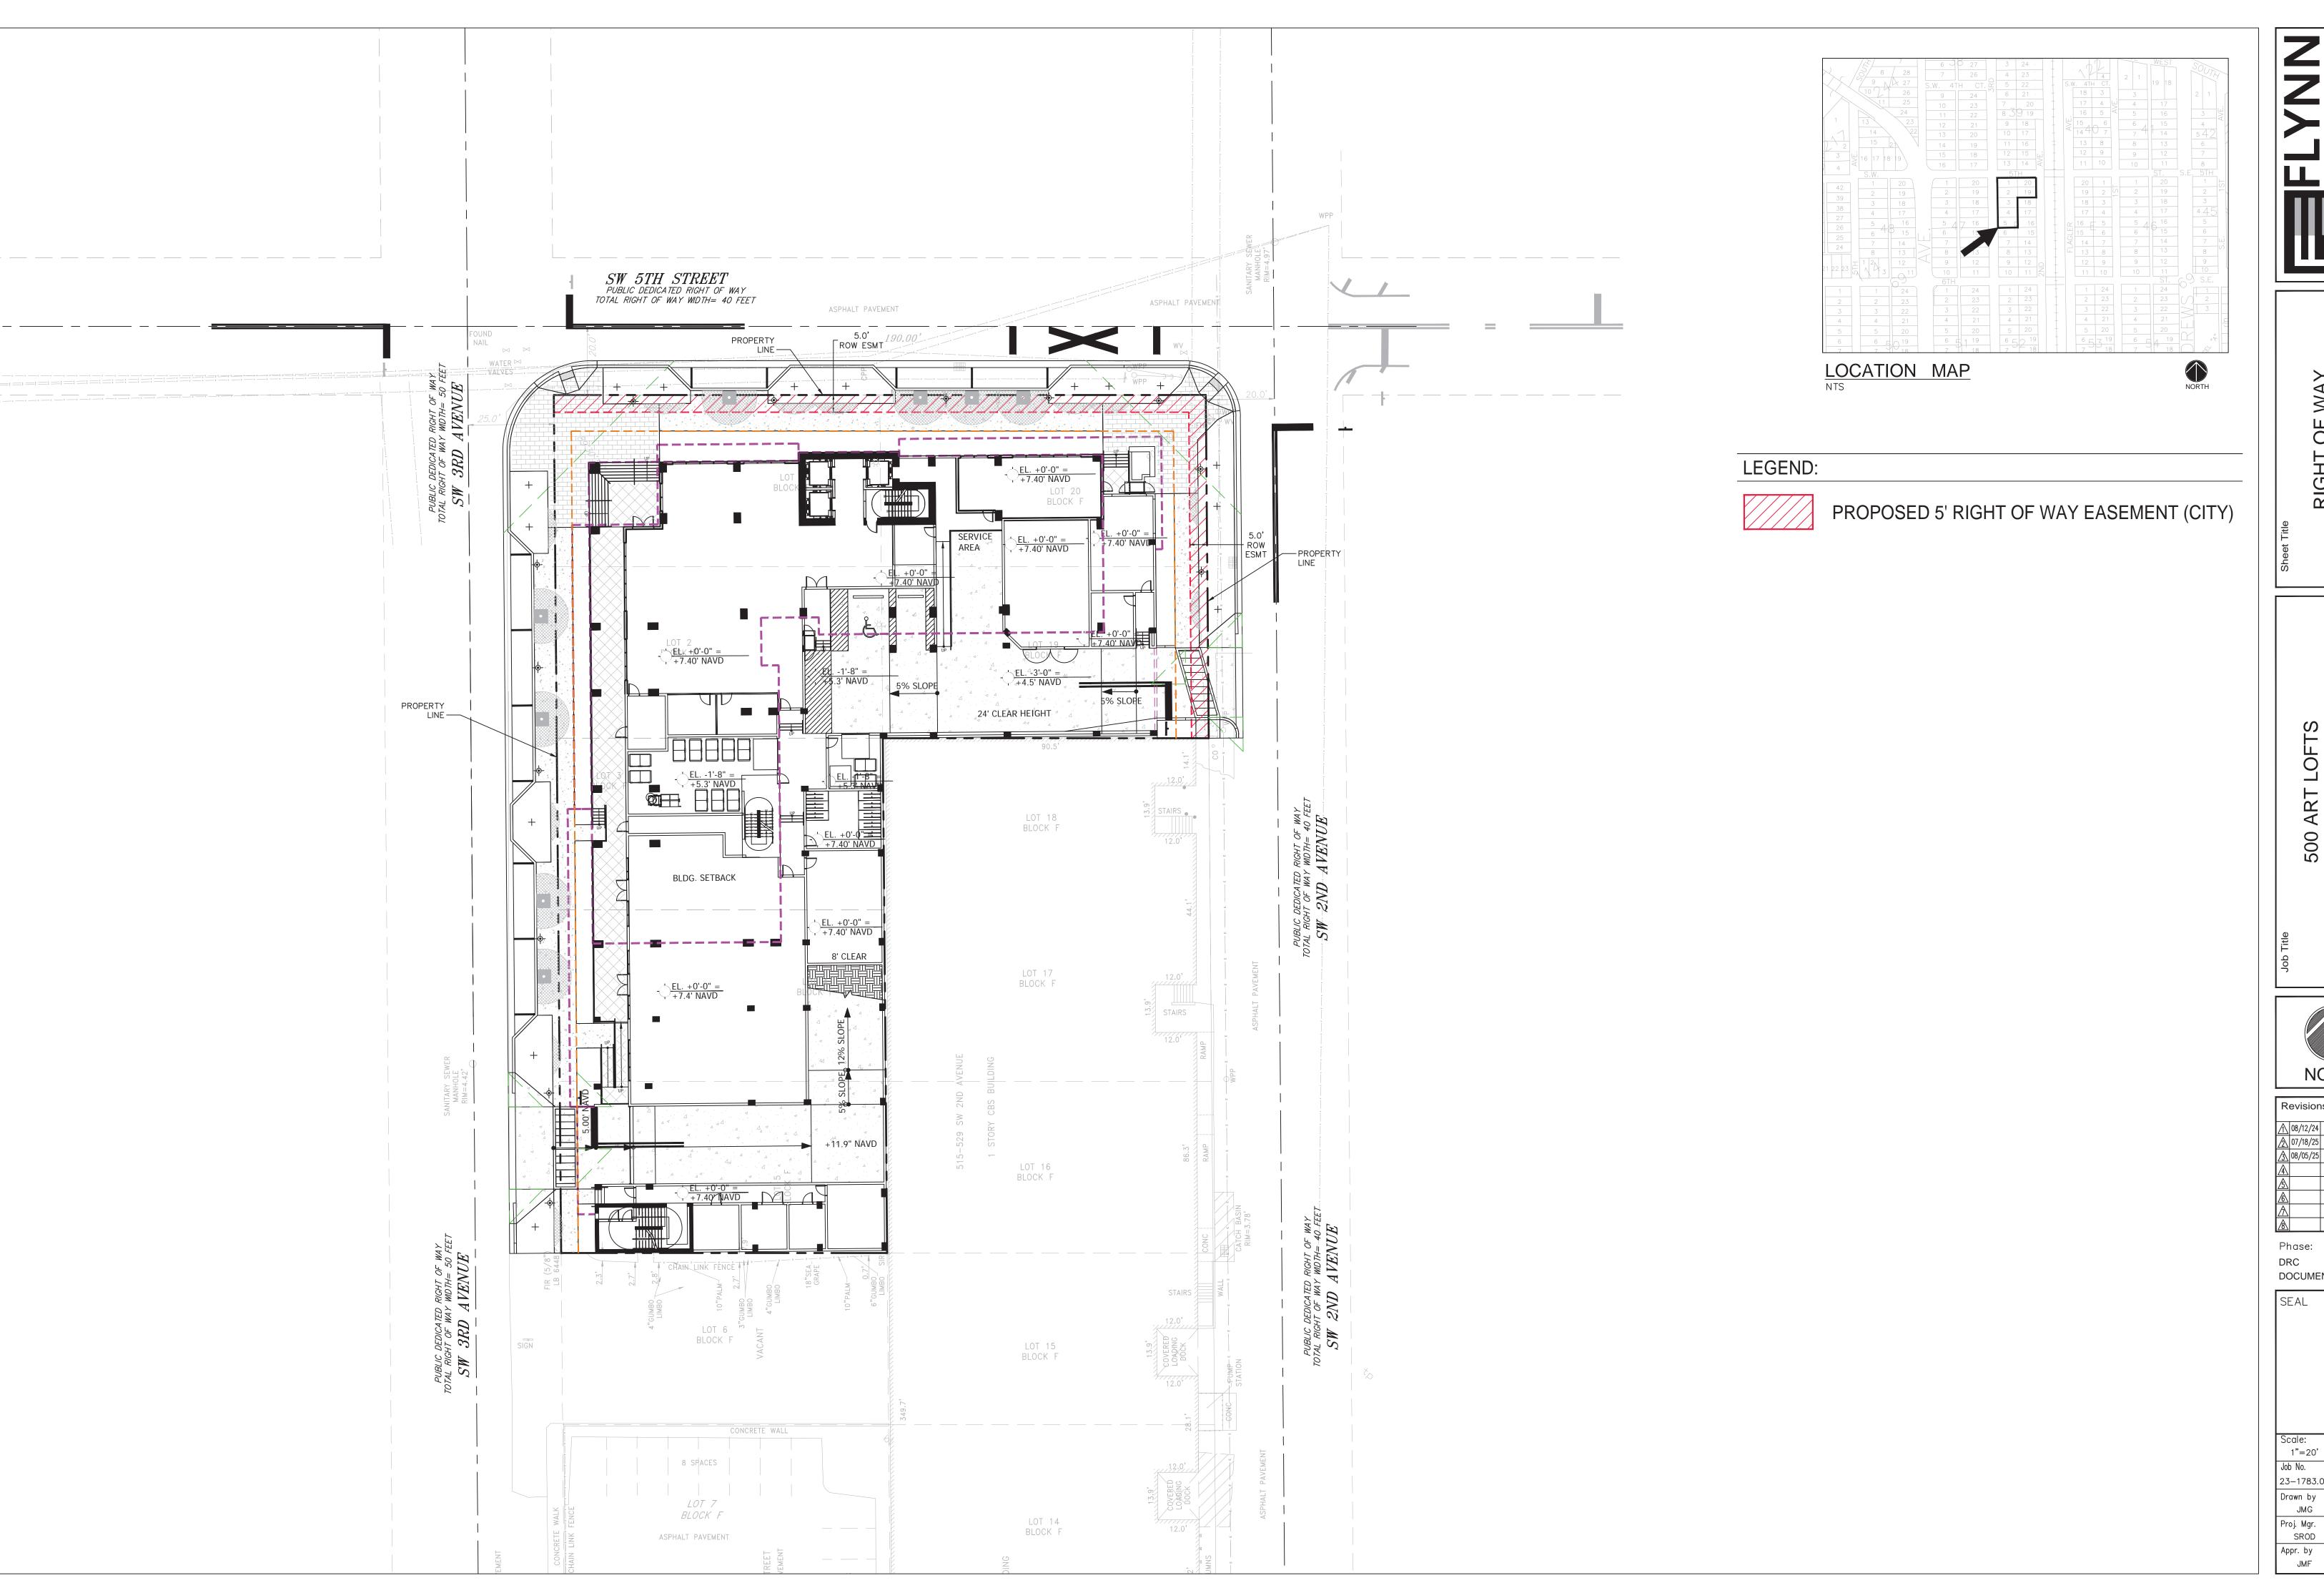


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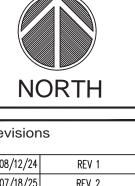
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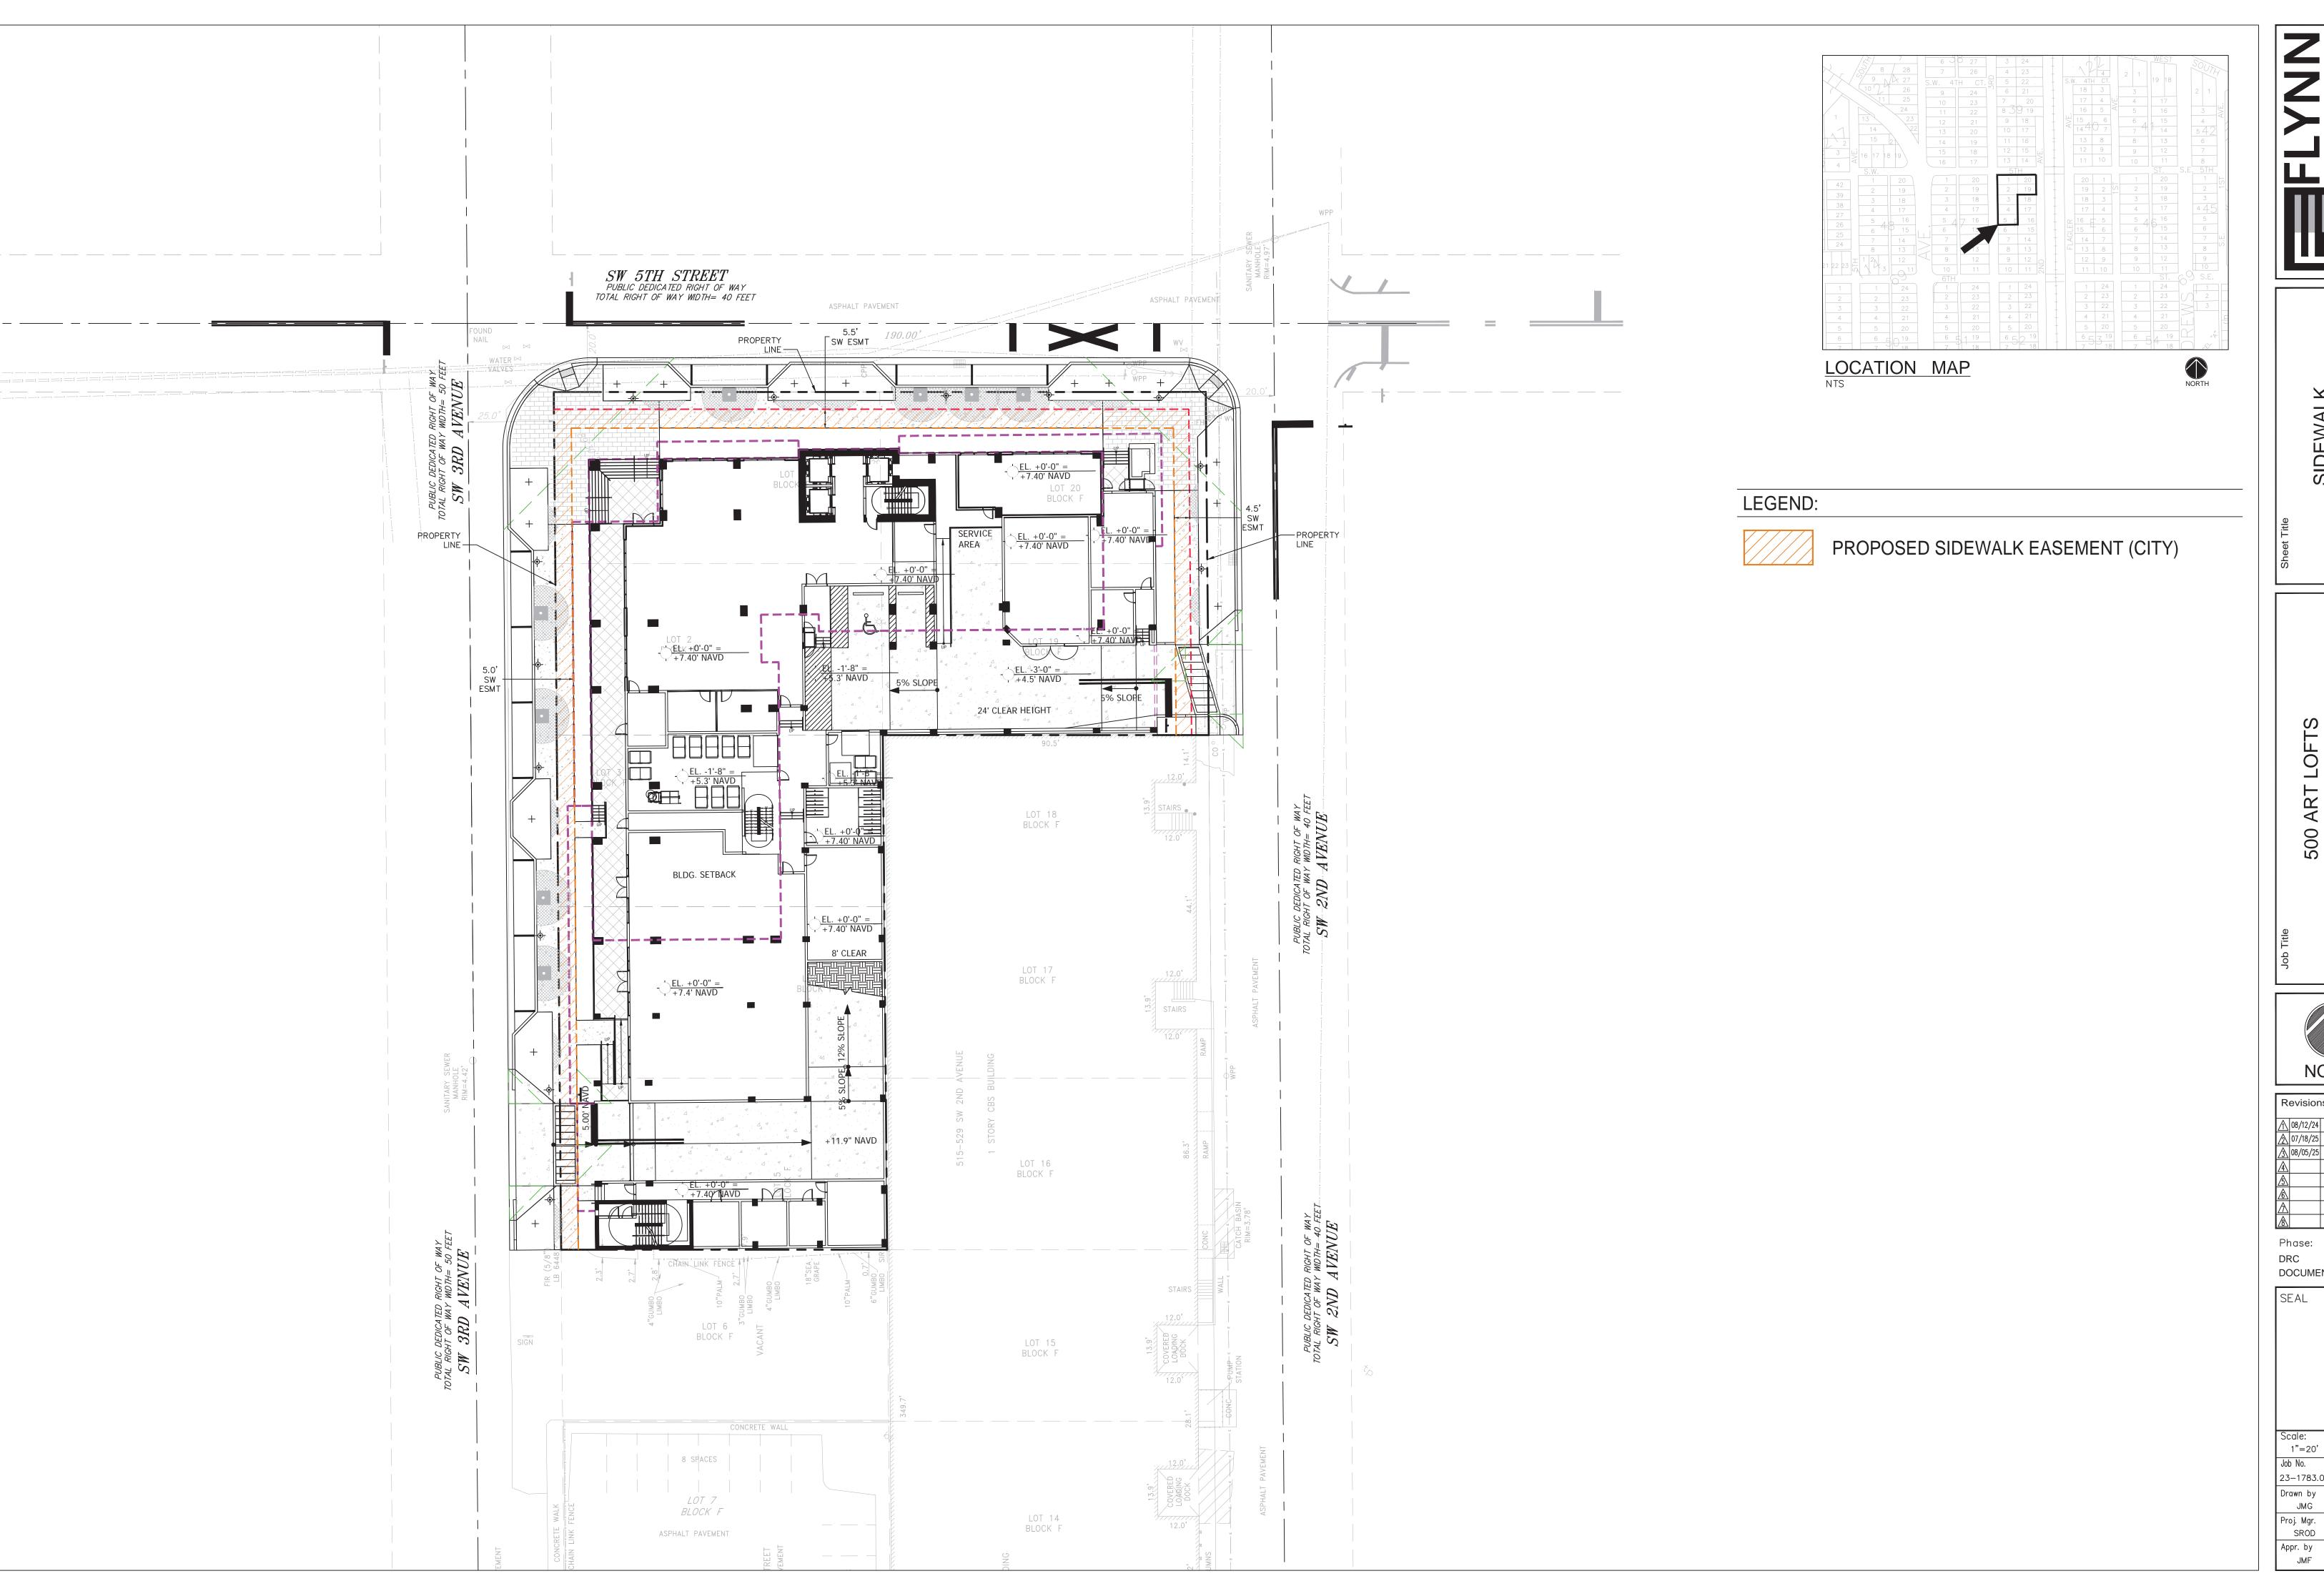
RIGHT OF WAY EASEMENT EXHIBIT



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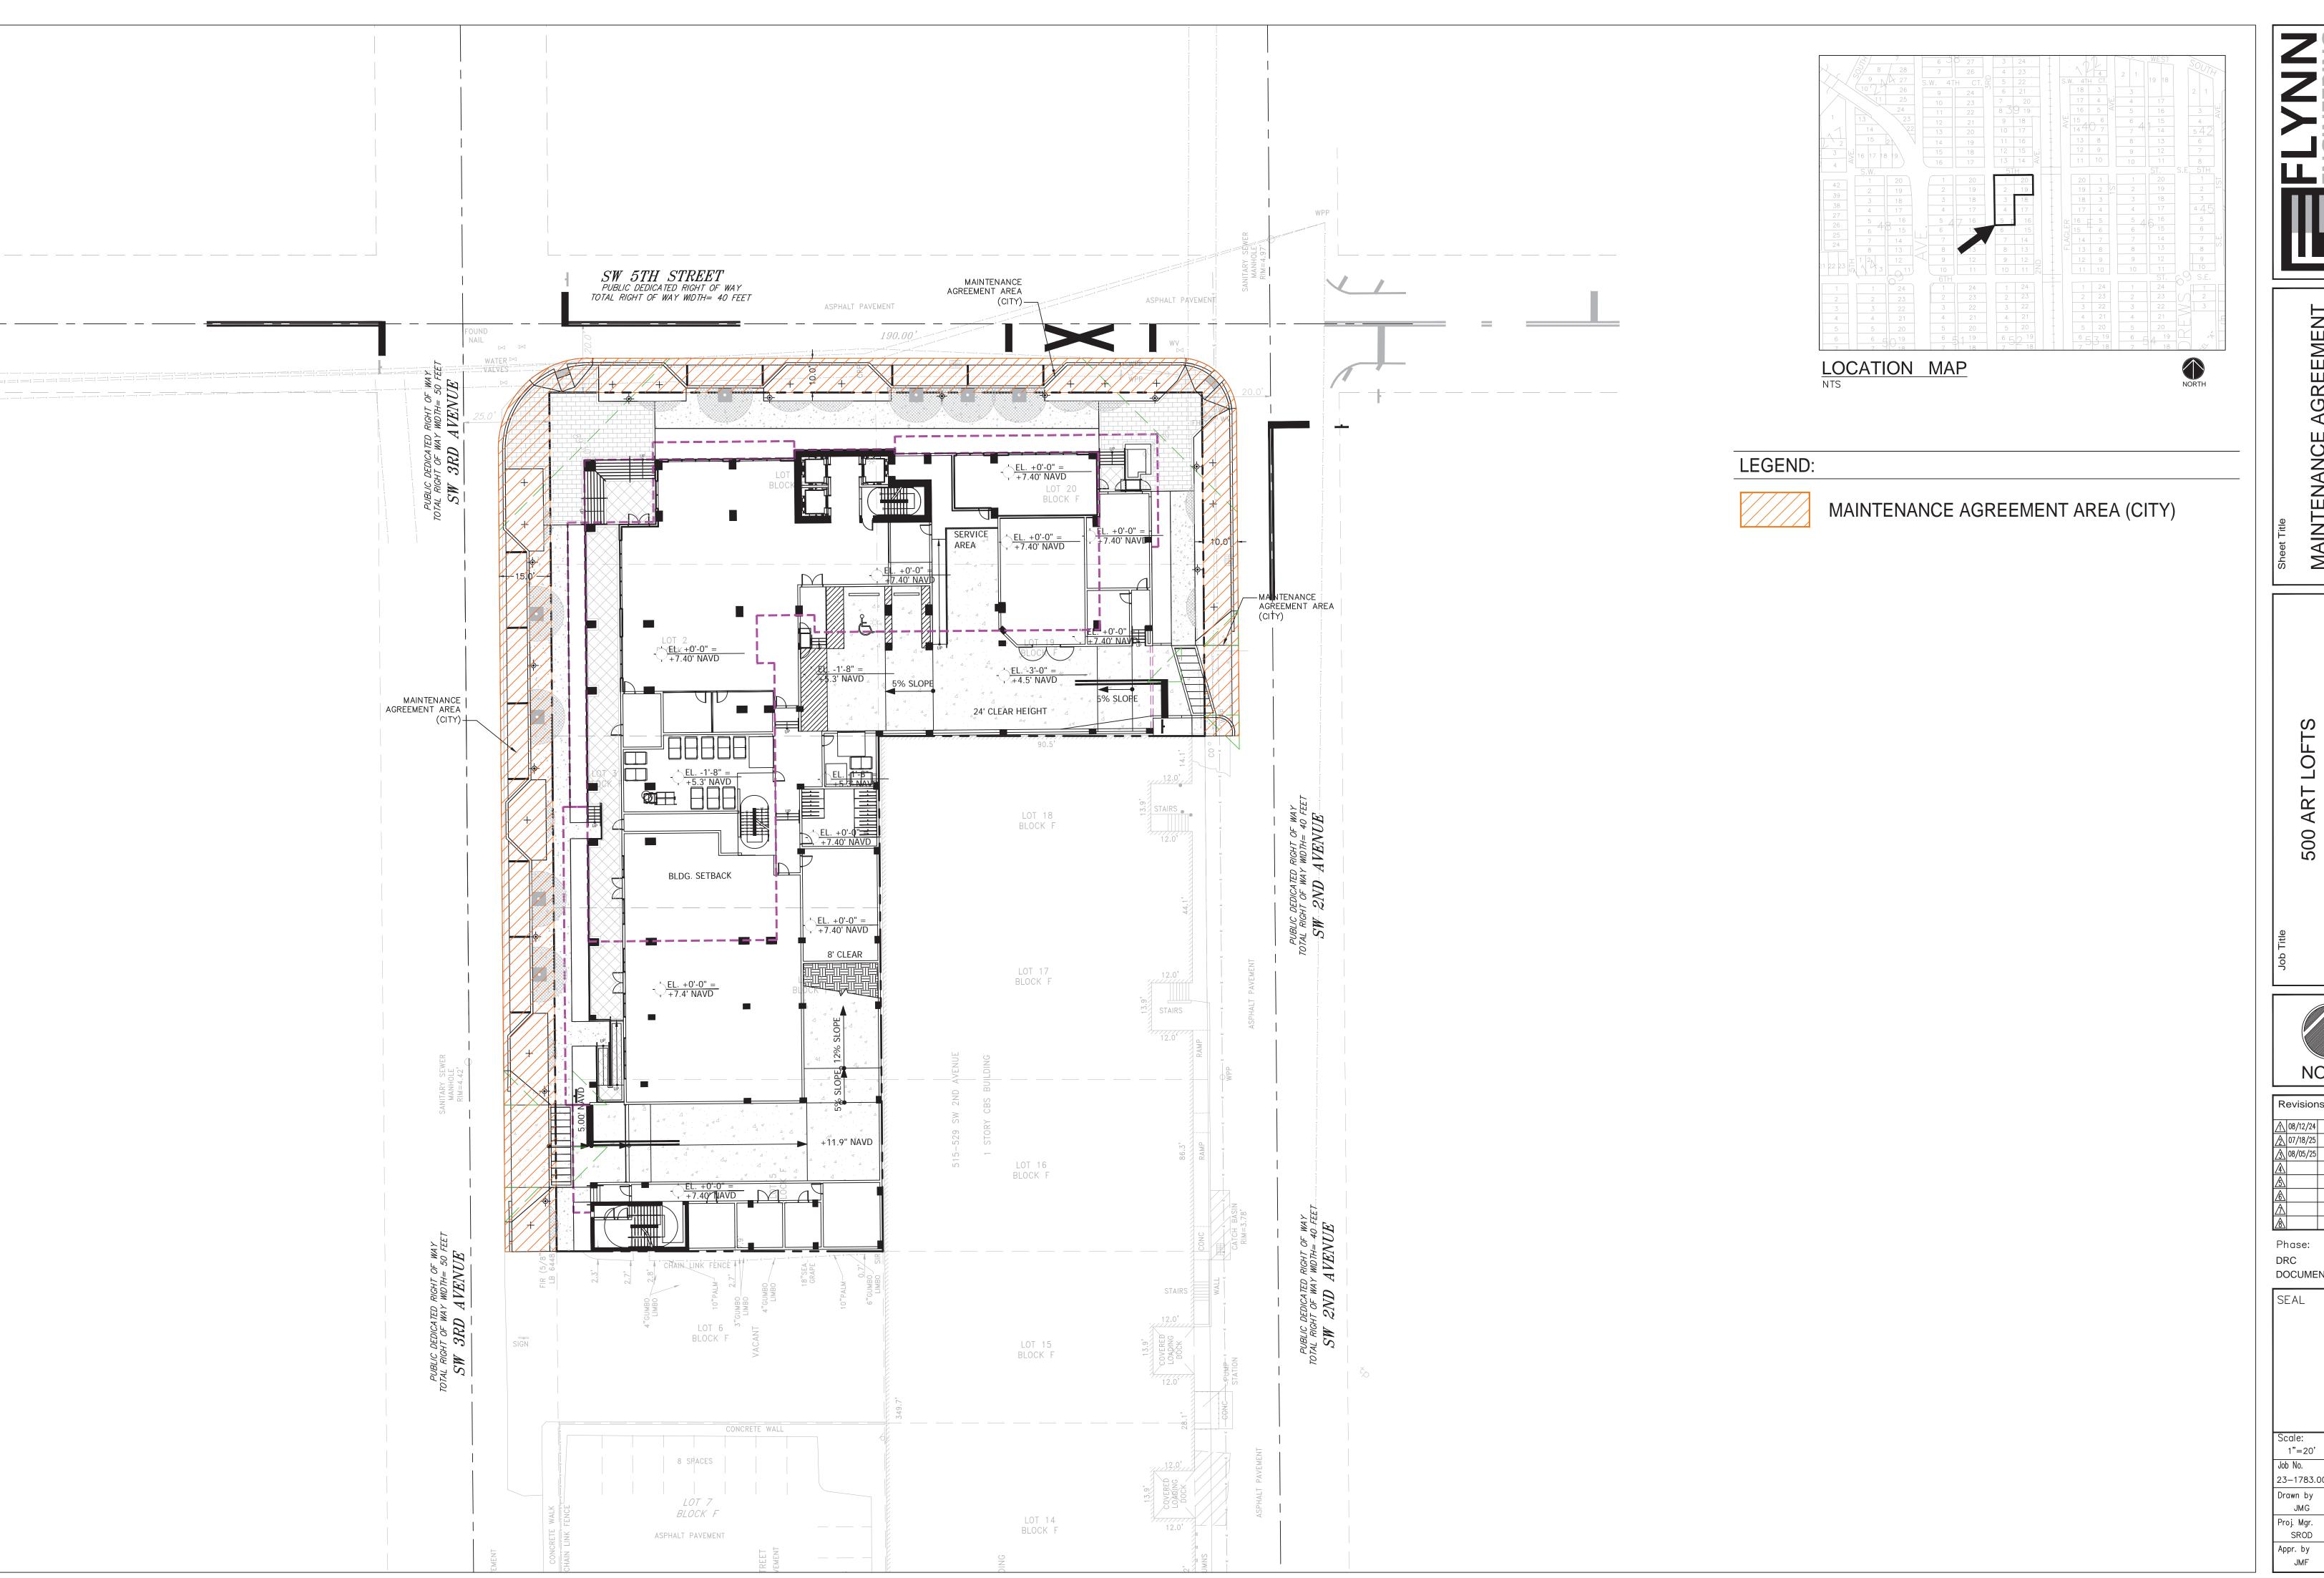
SIDEWALK EASEMENT EXHIBIT



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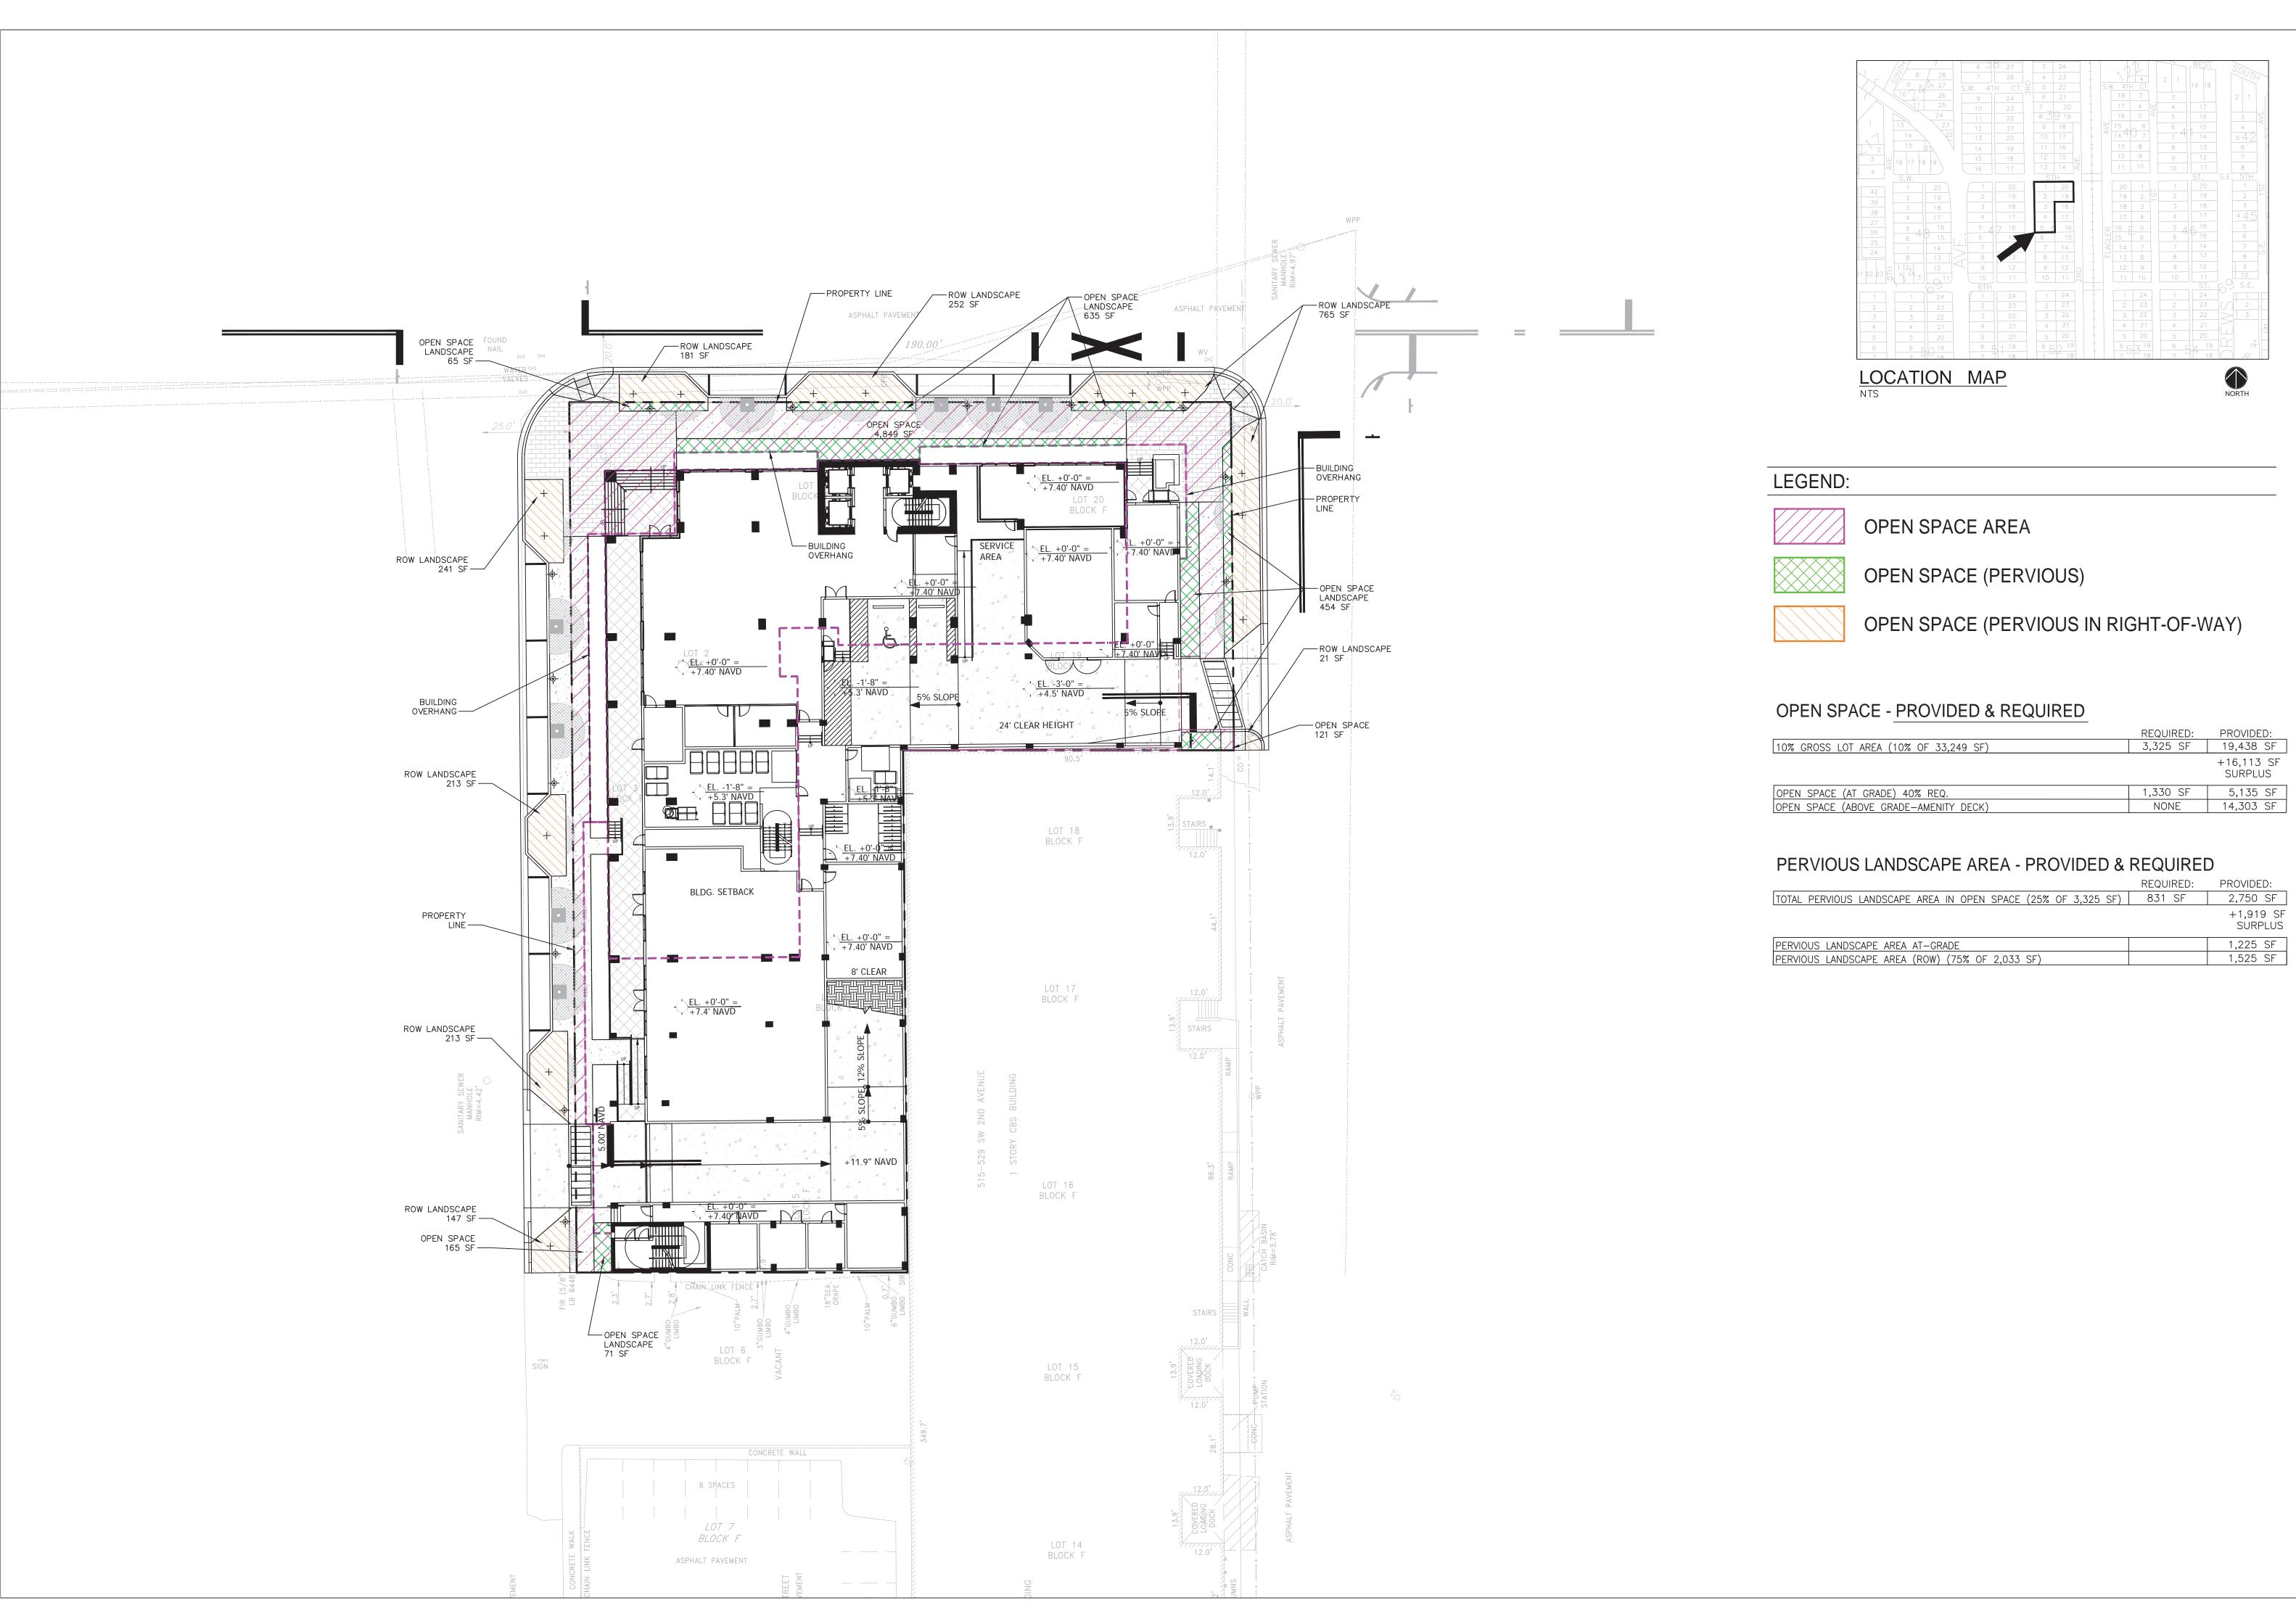


MAINTENANCE AGREEMEN⁻ EXHIBIT

Revisions ↑ 08/12/24 REV 1 ↑ 07/18/25 REV 2 ↑ 08/05/25 REV 3

Phase: DRC DOCUMENTS


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OPEN SPACE EXHIBIT


500 ART LOFTS
500 SW 2ND AVENUE
ORT LAUDERDALE, FLORIDA 33301



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RUCK CIRCULATION EXHIBIT
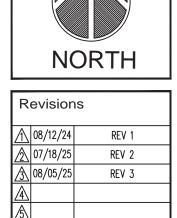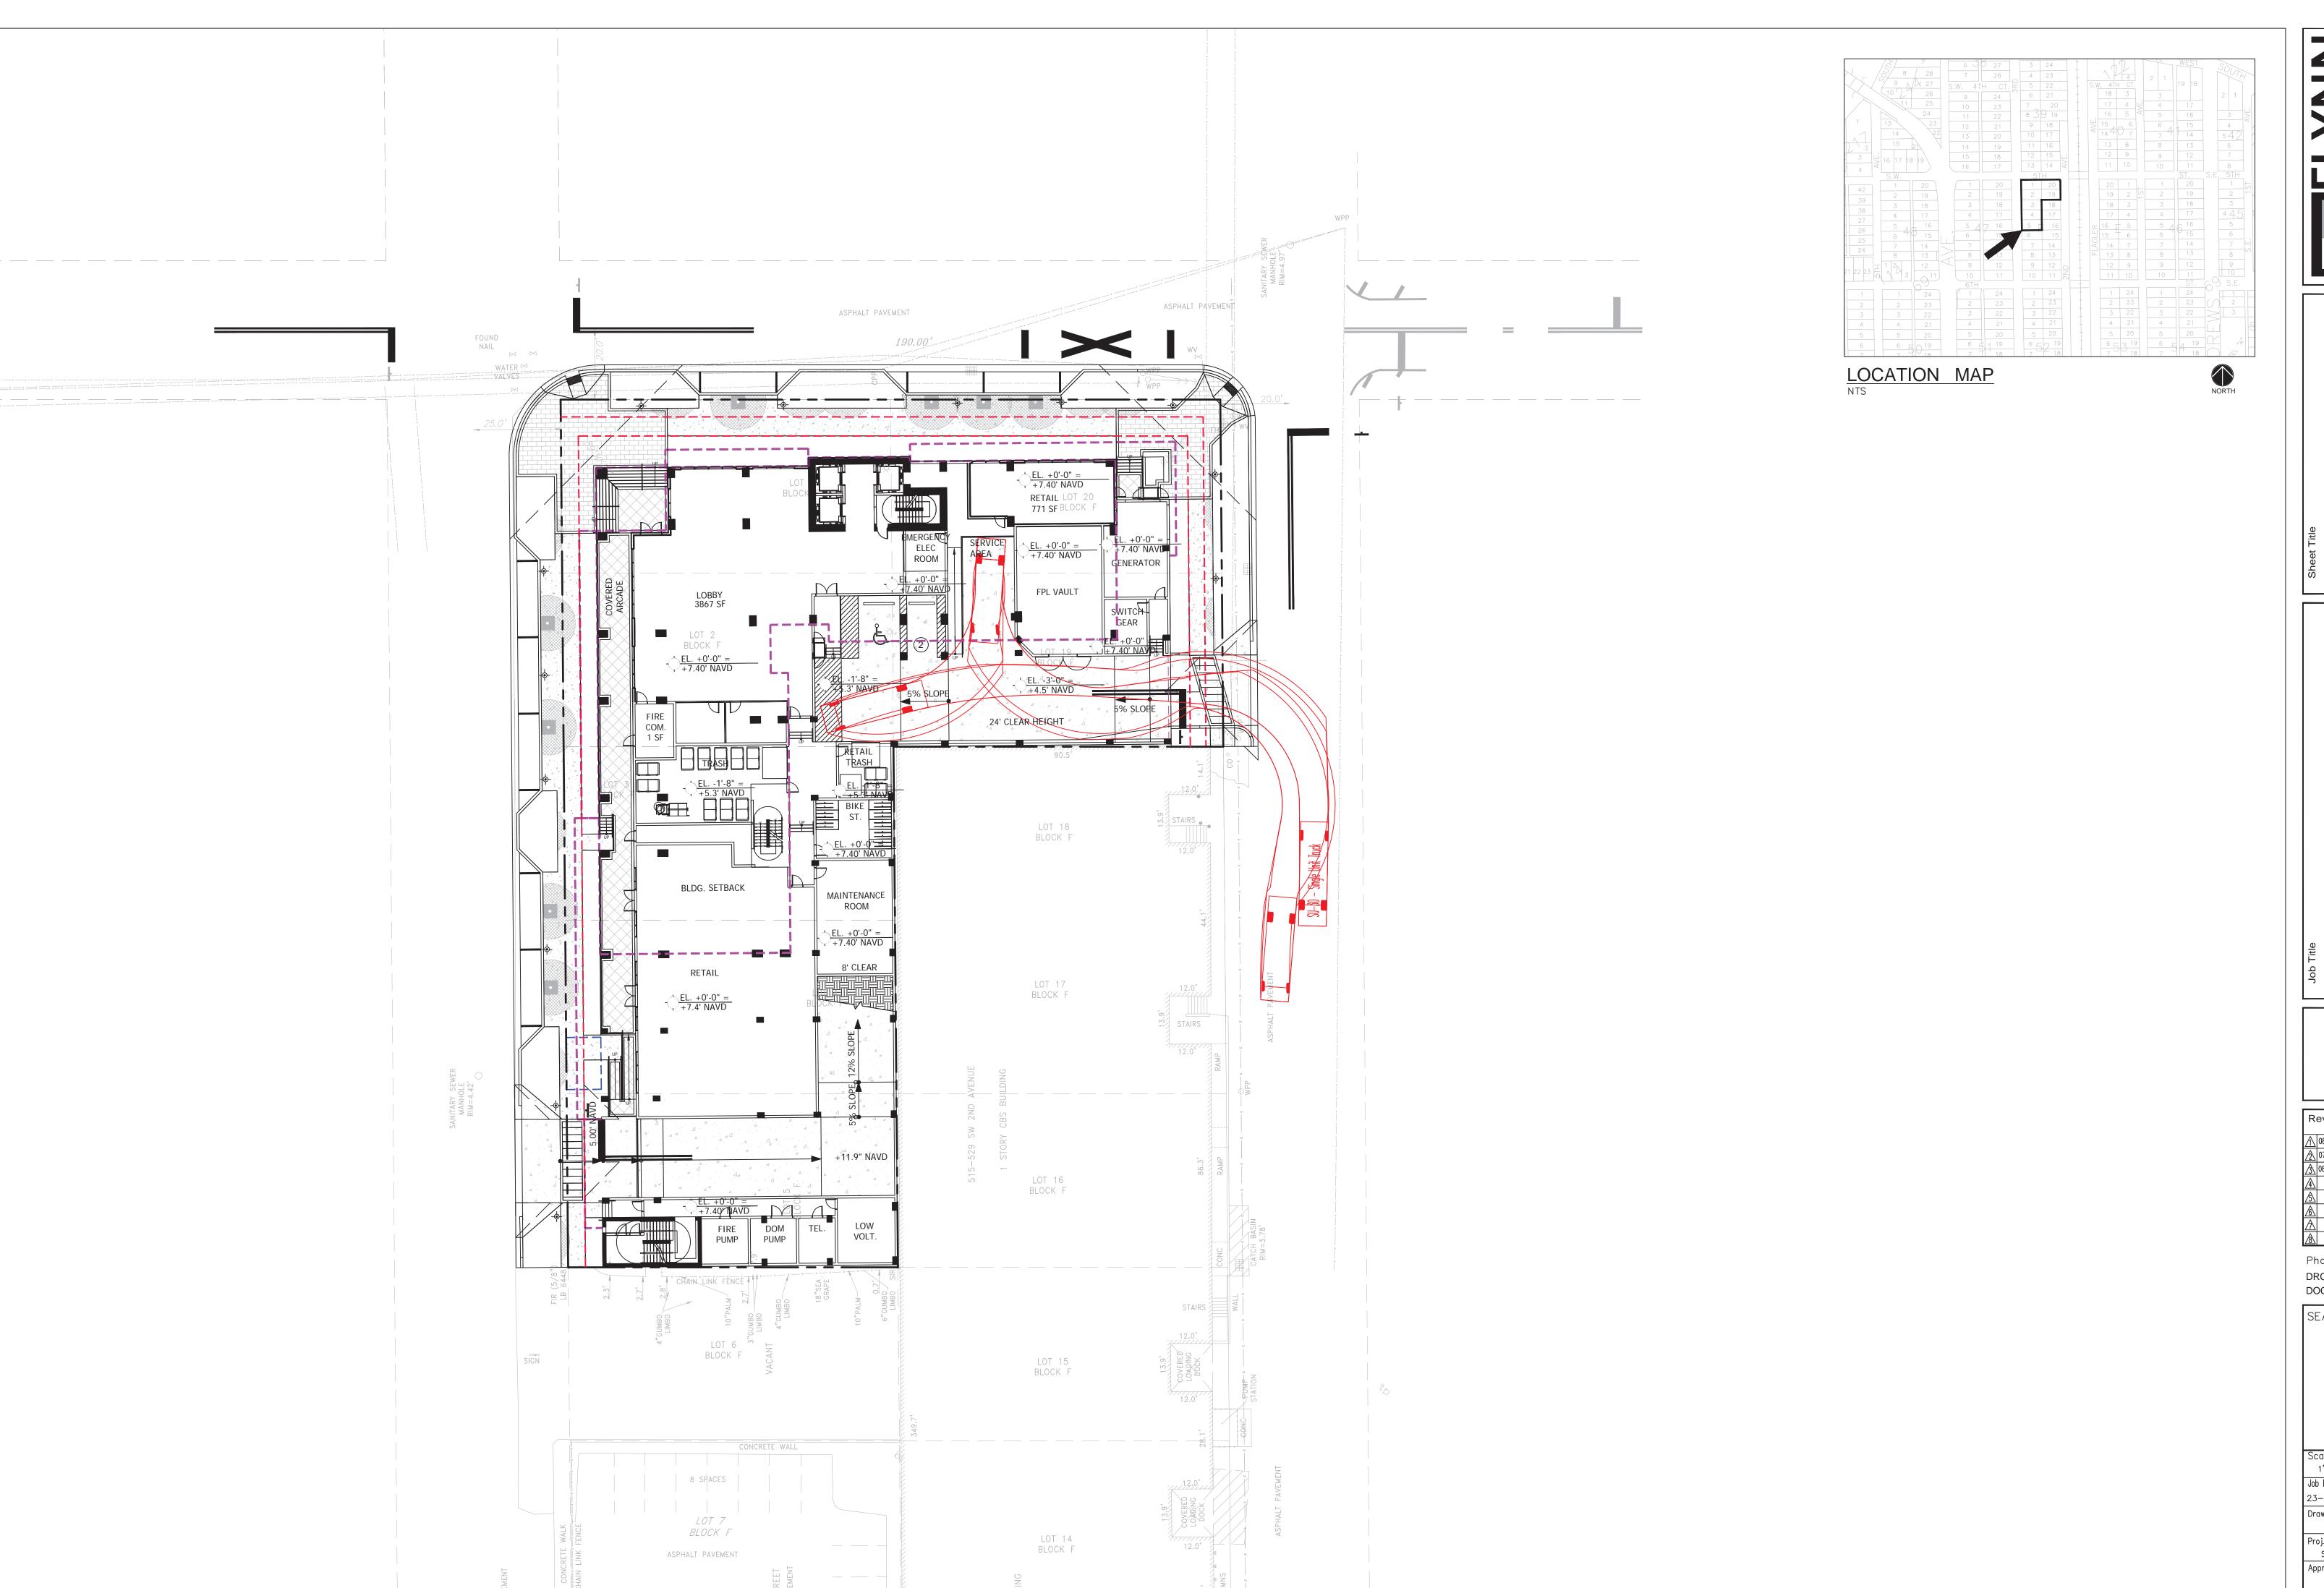
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